

**MONTGOMERY COUNTY HISTORIC PRESERVATION COMMISSION**  
**STAFF REPORT**

|                     |   |                       |              |
|---------------------|---|-----------------------|--------------|
| <b>Address:</b>     | 36 Philadelphia Ave., Takoma Park                                     | <b>Meeting Date:</b>  | 7/27/2016    |
| <b>Resource:</b>    | New Construction on Contributing Lot<br>Takoma Park Historic District | <b>Report Date:</b>   | 7/20/2016    |
| <b>Applicant:</b>   | Wesley Reppert<br>(Rita Kader, Architect)                             | <b>Public Notice:</b> | 7/13/2016    |
| <b>Review:</b>      | HAWP  | <b>Tax Credit:</b>    | N/A          |
| <b>Case Number:</b> | 37/03-16DD  | <b>Staff:</b>         | Michael Kyne |
| <b>PROPOSAL:</b>    | Infill construction   |                       |              |

---

**STAFF RECOMMENDATION:**

Staff recommends that the Historic Preservation Commission approve with conditions the HAWP application.

1. The applicants shall work with HPC staff to determine an appropriate treatment for the proposed chimney and front porch piers.
2. Details will be submitted for the proposed chimney and front porch piers, with final review and approval delegated to staff.
3. Additional details for all proposed windows will be submitted, with final review and approval delegated to staff.

**ARCHITECTURAL DESCRIPTION**

**SIGNIFICANCE:** New Construction on Contributing Lot within the Takoma Park Historic District

**PROPOSAL:**

The applicant proposes to construct a 1 ½-story house on the empty Contributing lot.

**APPLICABLE GUIDELINES**

When reviewing alterations and new construction within the Takoma Park Historic District several documents are to be utilized as guidelines to assist the Commission in developing their decision. These documents include the historic preservation review guidelines in the approved and adopted amendment for the *Takoma Park Historic District (Guidelines)*, *Montgomery County Code Chapter 24A (Chapter 24A)*, and the *Secretary of the Interior's Standards for Rehabilitation (Standards)*. The pertinent information in these documents is outlined below.

***Takoma Park Historic District Guidelines***

There are two very general, broad planning and design concepts which apply to all categories. These are:

- The design review emphasis will be restricted to changes that are all visible from the public right-of-way, irrespective of landscaping or vegetation (it is expected that the majority of new additions will be reviewed for their impact on the overall district), and
- The importance of assuring that additions and other changes to existing structures act to reinforce and continue existing streetscape, landscape, and building patterns rather than to impair the character of the historic district.

### **New Construction**

The goal of new construction within both residential and commercial historic districts is to be sympathetic to the traditional street and building patterns in that district, while allowing for creative new building designs. In addition to the approach of recalling earlier architectural styles in new buildings, it is appropriate for new structures to reflect and represent the period in which they are built. It is not the intention of these guidelines to inhibit or exclude creative design solutions that may be developed for new buildings in the Takoma Park district. Unique designs which may not adhere strictly to traditional neighborhood practices, but which are sensitive to and compatible with the fabric of the community should be approved.

### ***Residential Areas***

In Takoma Park, there are a number of elements which define the streetscape and building patterns. New construction should consider some of these elements, such as:

- Rhythm of houses along the street, including patterns of height, massing, side and front setbacks, and roof pitch.
- Patterns of open space/landscaping and building coverage, including ample front and back yards, spacing between houses, preservation of important mature trees, etc.
- Principal building facades oriented to the street.
- Covered porches on the front or main façade.
- Patterns of openings in facades, especially doors and windows, which provide a sense of residential scale and rhythm along the street.
- Building and roofing materials.
- High Degree of building craftsmanship, as expressed in detailing and use of materials.
- Use of decorative stone retaining walls (where required by topographic changes) and occasionally fences to define a sidewalk line and separate yards from street.
- Sidewalks and planting strips along the street.
- Orientation of driveways and parking areas to the rear and sides of buildings.
- Use of outbuildings (e.g. detached garages).
- Extensive landscaping, including mature trees and flowering plants.

### ***Sec. 24A-8. Same-Criteria for issuance.***

- (a) The commission shall instruct the director to deny a permit if it finds, based on the evidence and information presented to or before the commission that the alteration for which the permit is sought would be inappropriate, inconsistent with or detrimental to the preservation, enhancement or ultimate protection of the historic site or historic resource within an historic district, and to the purposes of this chapter.

- (b) The commission shall instruct the director to issue a permit, or issue a permit subject to such conditions as are found to be necessary to insure conformity with the purposes and requirements of this chapter, if it finds that:
- (1) The proposal will not substantially alter the exterior features of an historic site or historic resource within an historic district; or
  - (2) The proposal is compatible in character and nature with the historical, archeological, architectural or cultural features of the historic site or the historic district in which an historic resource is located and would not be detrimental thereto or to the achievement of the purposes of this chapter; or
  - (3) The proposal would enhance or aid in the protection, preservation and public or private utilization of the historic site or historic resource located within an historic district in a manner compatible with the historical, archeological, architectural or cultural value of the historic site or historic district in which an historic resource is located; or
  - (4) The proposal is necessary in order that unsafe conditions or health hazards be remedied; or
  - (5) The proposal is necessary in order that the owner of the subject property not be deprived of reasonable use of the property or suffer undue hardship; [emphasis added] or
  - (6) In balancing the interests of the public in preserving the historic site or historic resource located within an historic district, with the interests of the public from the use and benefit of the alternative proposal, the general public welfare is better served by granting the permit.
- (c) It is not the intent of this chapter to limit new construction, alteration or repairs to any 1 period or architectural style.
- (d) In the case of an application for work on an historic resource located within an historic district, the commission shall be lenient in its judgment of plans for structures of little historical or design significance or for plans involving new construction, unless such plans would seriously impair the historic or architectural value of surrounding historic resources or would impair the character of the historic district. (*Ord No. 9-4, § 1; Ord No. 11-59.*)

#### *Secretary of Interior's Standards for Rehabilitation*

The Secretary of the Interior defines rehabilitation as “the act or process of making possible a compatible use for a property through repair, alterations, and additions while preserving those portions or features, which convey its historical, cultural, or architectural values.” Standards 2, 9, and 10 most directly apply to the application before the commission:

#2. The historic character of a property shall be retained and preserved. The removal of historic materials or alteration of features and spaces that characterize a property shall be avoided.

#9. New additions, exterior alterations, or related new construction shall not destroy historic materials that characterize the property. The new work shall be differentiated from the old and shall be compatible with the massing, size, scale, and architectural features to protect the historic integrity of the property and its environment.

#10. New additions and adjacent or related new construction shall be undertaken in such a manner that if removed in the future, the essential form and integrity of the historic property and its environment would be unimpaired.

## **STAFF DISCUSSION**

The applicant proposes to construct a 1 ½-story house on the empty Contributing lot. The Contributing Resource that was formerly on the lot was a c. 1925 Dutch Colonial-style house. The former house was condemned by the State of Maryland, who ordered the City of Takoma Park to demolish the house. The house was demolished with approval from the HPC in 2012.

The proposed new house is sympathetic to the character of the surrounding streetscape and the historic district. The house is designed in the Bungalow-Craftsman style, which is common in the Takoma Park Historic District, with examples in the immediate vicinity of the subject property.

The proposed new house is appropriate in both scale and massing, and the setback of the house is consistent with the existing houses on Philadelphia Avenue. The front of the proposed new house is oriented toward Philadelphia Avenue and there will be a full-width covered porch on its façade.

The proposed new house was designed with a high-degree of craftsmanship and, generally, will be constructed from materials that the Commission routinely approves as appropriate and compatible for new construction. Specifically, the house will have Hardie Plank siding, Hardie Shingle siding, and architectural asphalt shingles.

The applicant proposes a natural stone veneer on the chimney and front porch piers. In the past, the Commission has been reluctant to approve stone veneer that is highly-visible from the public right-of-way, as the proposed will be. Staff suggests that brick would be a more appropriate treatment, and recommends the following conditions of approval: 1) The applicants shall work with HPC staff to determine an appropriate treatment for the proposed chimney and front porch piers; and 2) Details will be submitted for the proposed chimney and front porch piers, with final review and approval delegated to staff.

According to the submitted information, some of the proposed windows will have a prairie grille pattern. Per the Commission's typical requirement, the proposed windows should have permanently affixed 7/8" profile muntins with spacer bars. Staff recommends the following (third) condition of approval: 3) Additional details for all proposed windows will be submitted, with final review and approval delegated to staff.

A new flagstone walkway will lead from the proposed new house to Philadelphia Avenue. Front walkways that lead to the street are another common feature along Philadelphia Avenue. A set of flagstone steps will lead from the front porch to the driveway at the left side of the property. The driveway is existing and is a remnant of the former house.

The applicant has stated that no trees will be removed to accommodate the proposed project.

Staff finds that the proposed new house is consistent with the *Guidelines* and *Standards*, with a high-degree of craftsmanship that is sympathetic to the style, scale, and massing of the resources within the Takoma Park Historic District.

## **STAFF RECOMMENDATION:**

Staff recommends that the Commission **approve with the conditions specified on Circle 1** the HAWP application under the Criteria for Issuance in Chapter 24A-8(b), (1), (2) & (d) having found that the proposal is consistent with the *Takoma Park Historic District Guidelines*, and therefore will not substantially alter

the exterior features of the historic resource and is compatible in character with the district and the purposes of Chapter 24A;

and with the *Secretary of the Interior's Standards for Rehabilitation*;

and with the general condition that the applicant shall present the **3 permit sets of drawings, if applicable, to Historic Preservation Commission (HPC) staff for review and stamping** prior to submission for the Montgomery County Department of Permitting Services (DPS) building permits;

and with the general condition that final project design details, not specifically delineated by the Commission, shall be approved by HPC staff or brought back to the Commission as a revised HAWP application at staff's discretion;

and with the general condition that the applicant shall notify the Historic Preservation Staff if they propose to make **any alterations** to the approved plans. Once the work is completed the applicant will contact the staff person assigned to this application at 301-563-3400 or [michael.kyne@montgomeryplanning.org](mailto:michael.kyne@montgomeryplanning.org) to schedule a follow-up site visit.



## HISTORIC PRESERVATION COMMISSION

301/563-3400

**APPLICATION FOR  
HISTORIC AREA WORK PERMIT**

Contact Email: permits@manionandassociates.com

Contact Person: Tiffany Marion

Daytime Phone No.: 3012297000 ext 301

Tax Account No.: 01064644

Name of Property Owner: Wesley Reppert

Daytime Phone No.: 2028129240

Address: 1300 Eye Street NW, Suite 400, Washington, DC 20005

Street Number

City

State

Zip Code

Company:

Phone No.:

Contractor Registration No.:

Agent for Owner: Rita Kader

Daytime Phone No.: 2404497394

**EXISTING BUILDINGS**

House Number: 36

Street: Philadelphia Ave

Town/City: Takoma Park

Nearest Cross Street: 36

Lot: 18 Back: 3 Subdivision: Hill-Crest

Lot: 50763 Back: 191 Permit:

**PAST AND PRESENT USES**

## 1A. CHECK ALL APPLICABLE

- Construct     Extend     Alter/Renovate  
 Move     Install     Wheel/Rail  
 Revision     Repair     Revocable

## CHECK ALL APPLICABLE

- AC     SHB     Room Addition     Porch     Deck     Shed  
 Solar     Fireplace     Woodburning Stove     Single Family  
 Fence/Wall (complete Section 4)     Other \_\_\_\_\_

1B. Construction cost estimator: \$ 328 000.00

1C. If this is a revision of a previously approved active permit, see Permit # \_\_\_\_\_

762165

**PAST AND PRESENT SEWAGE CONNECTIONS**2A. Type of sewage disposal:  WSSC     Septic     Other: \_\_\_\_\_2B. Type of water supply:  WSSC     Well     Other: \_\_\_\_\_**PAST AND PRESENT FENCE/RETAINING WALLS**

3A. Height: feet: inches: \_\_\_\_\_

3B. Indicate whether the fence or retaining wall is to be constructed on one of the following locations:

- On party line/property line     Entirely on land of owner     On public right of way/assessment

I hereby certify that I have the authority to make the foregoing application, that the application is correct, and that the construction will comply with plans approved by all agencies listed and I hereby acknowledge and accept this to be a condition for the issuance of this permit.

Signature of owner or authorized agent

Date

Approved: \_\_\_\_\_ For Chairperson, Historic Preservation Commission

Disapproved: \_\_\_\_\_ Signature: \_\_\_\_\_ Date: \_\_\_\_\_


Application/Permit No.: \_\_\_\_\_ Date Filed: \_\_\_\_\_ Date Issued: \_\_\_\_\_

(01/6/21/98)

**SEE REVERSE SIDE FOR INSTRUCTIONS**

# Repper Residence

36 Philadelphia Ave  
Takoma Park, MD 20912

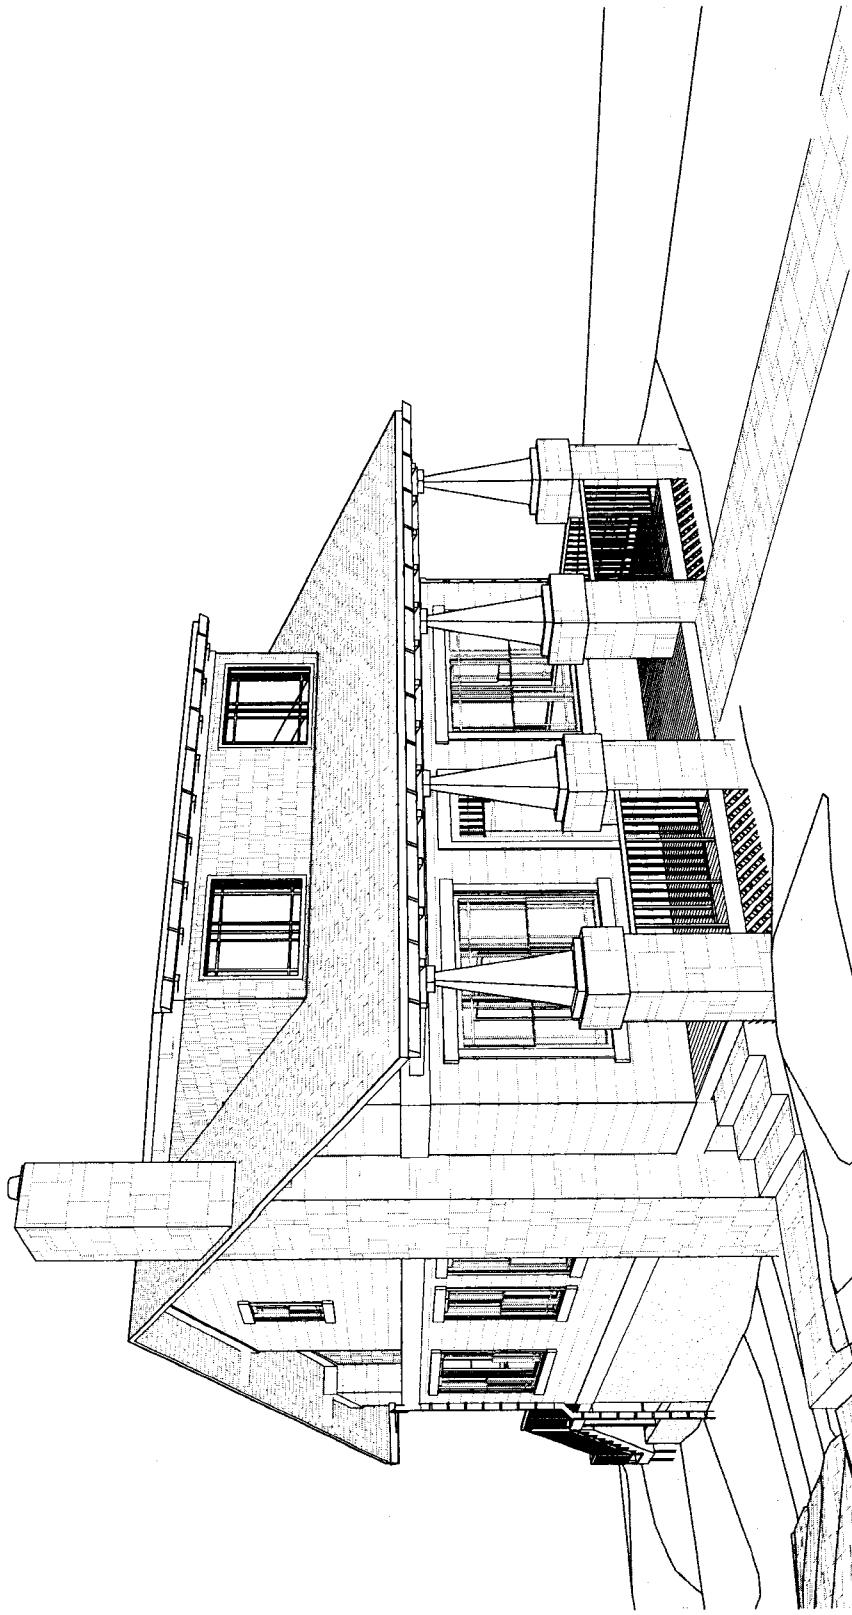

Front View

SCALE: 1:80.91

3  
A1


**NOT FOR CONSTRUCTION**

MANION + ASSOCIATES ARCHITECTS, P.C.  
Repper Residence  
36 Philadelphia Ave  
Takoma Park, MD 20912  
7307 McGaughy Blvd, Ste. 216, Bethesda, Maryland 20816  
T: 301.229.7000 F: 301.229.7171 www.manionandassociates.com  
DRAWN BY: Rebekca Leal  
DRAFT DATE: 28/06/2016  
COPYRIGHT © 2016 ALL RIGHTS RESERVED  
CoverSheet

NOT FOR CONSTRUCTION

Site Plan

SCALE: 3/32" = 1'-0"

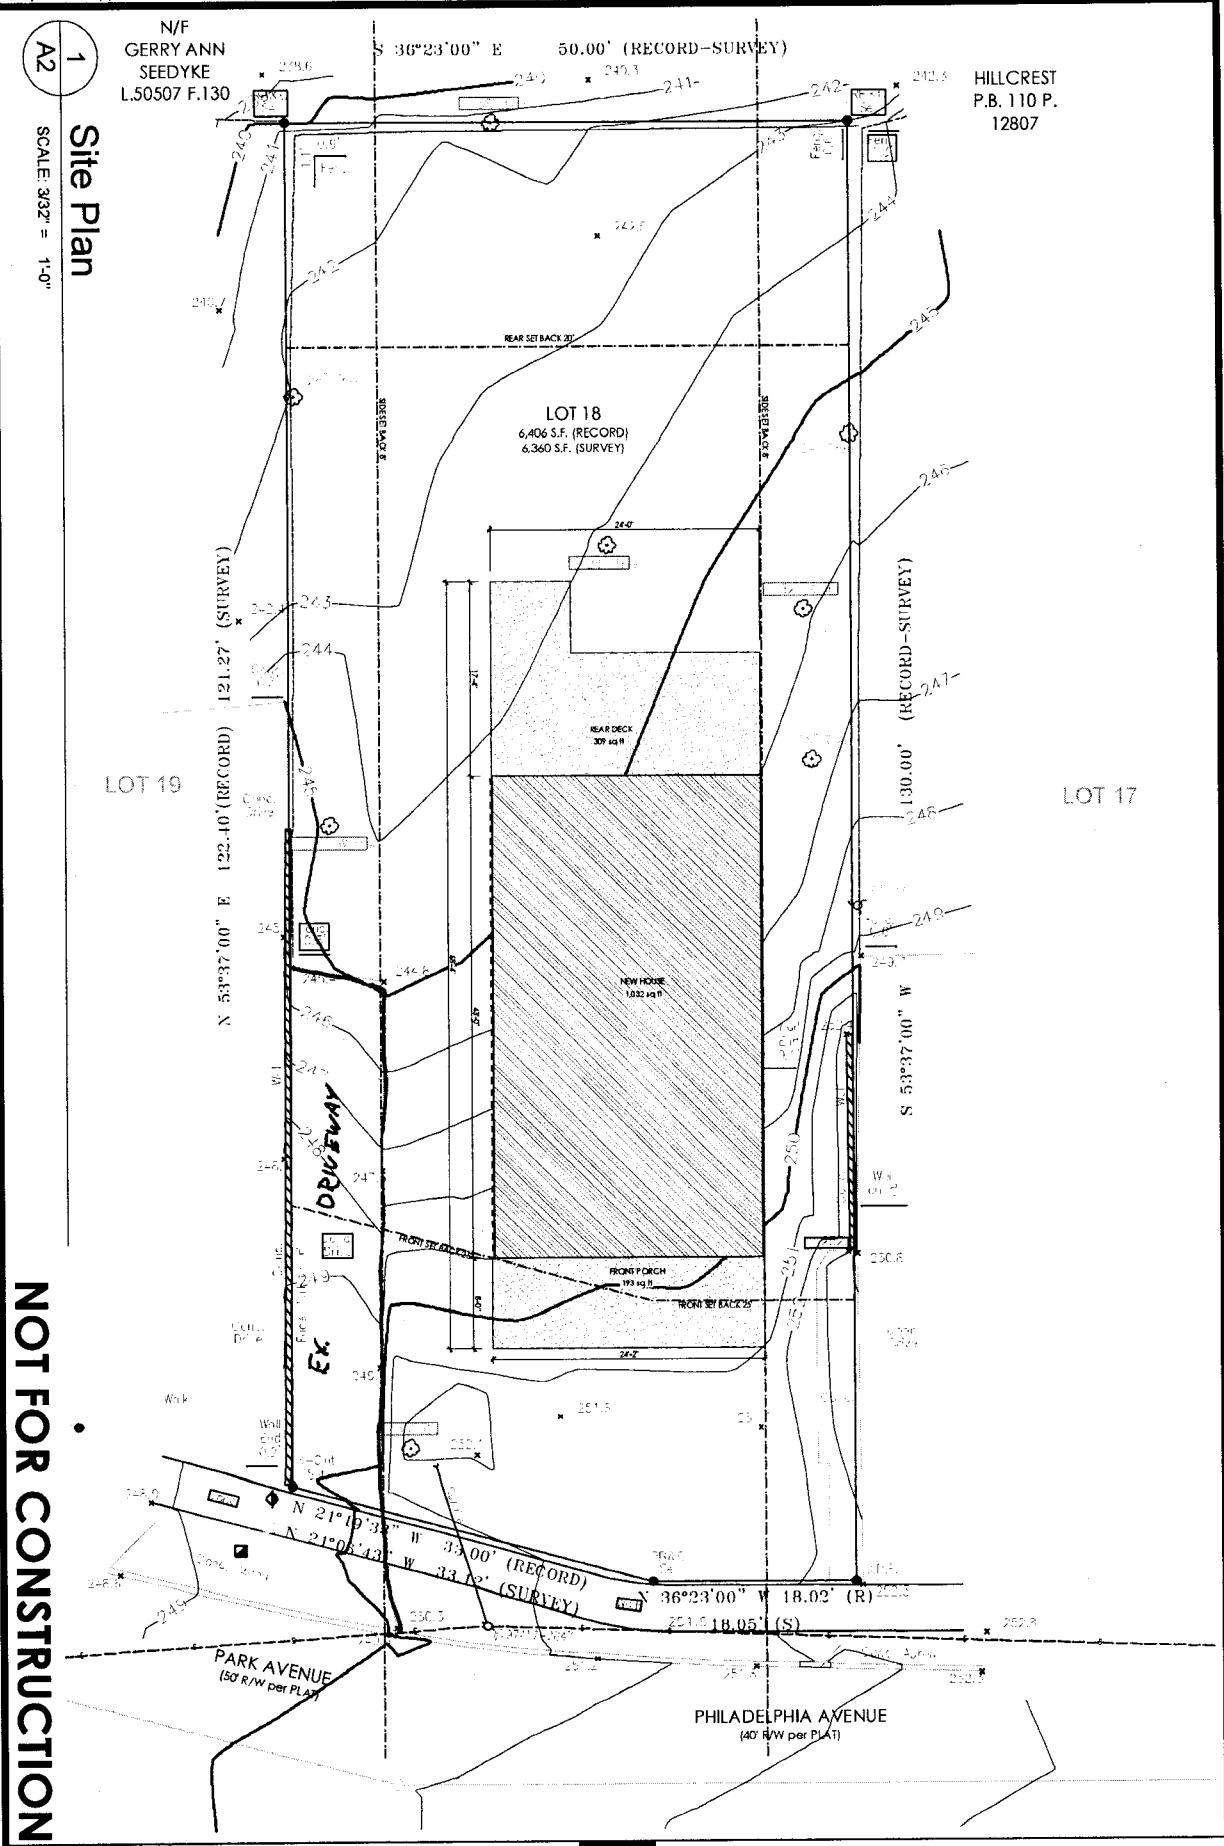


# NOT FOR CONSTRUCTION

## Basement Floor

SCALE: 3'16" = 1'-0"

1  
A3

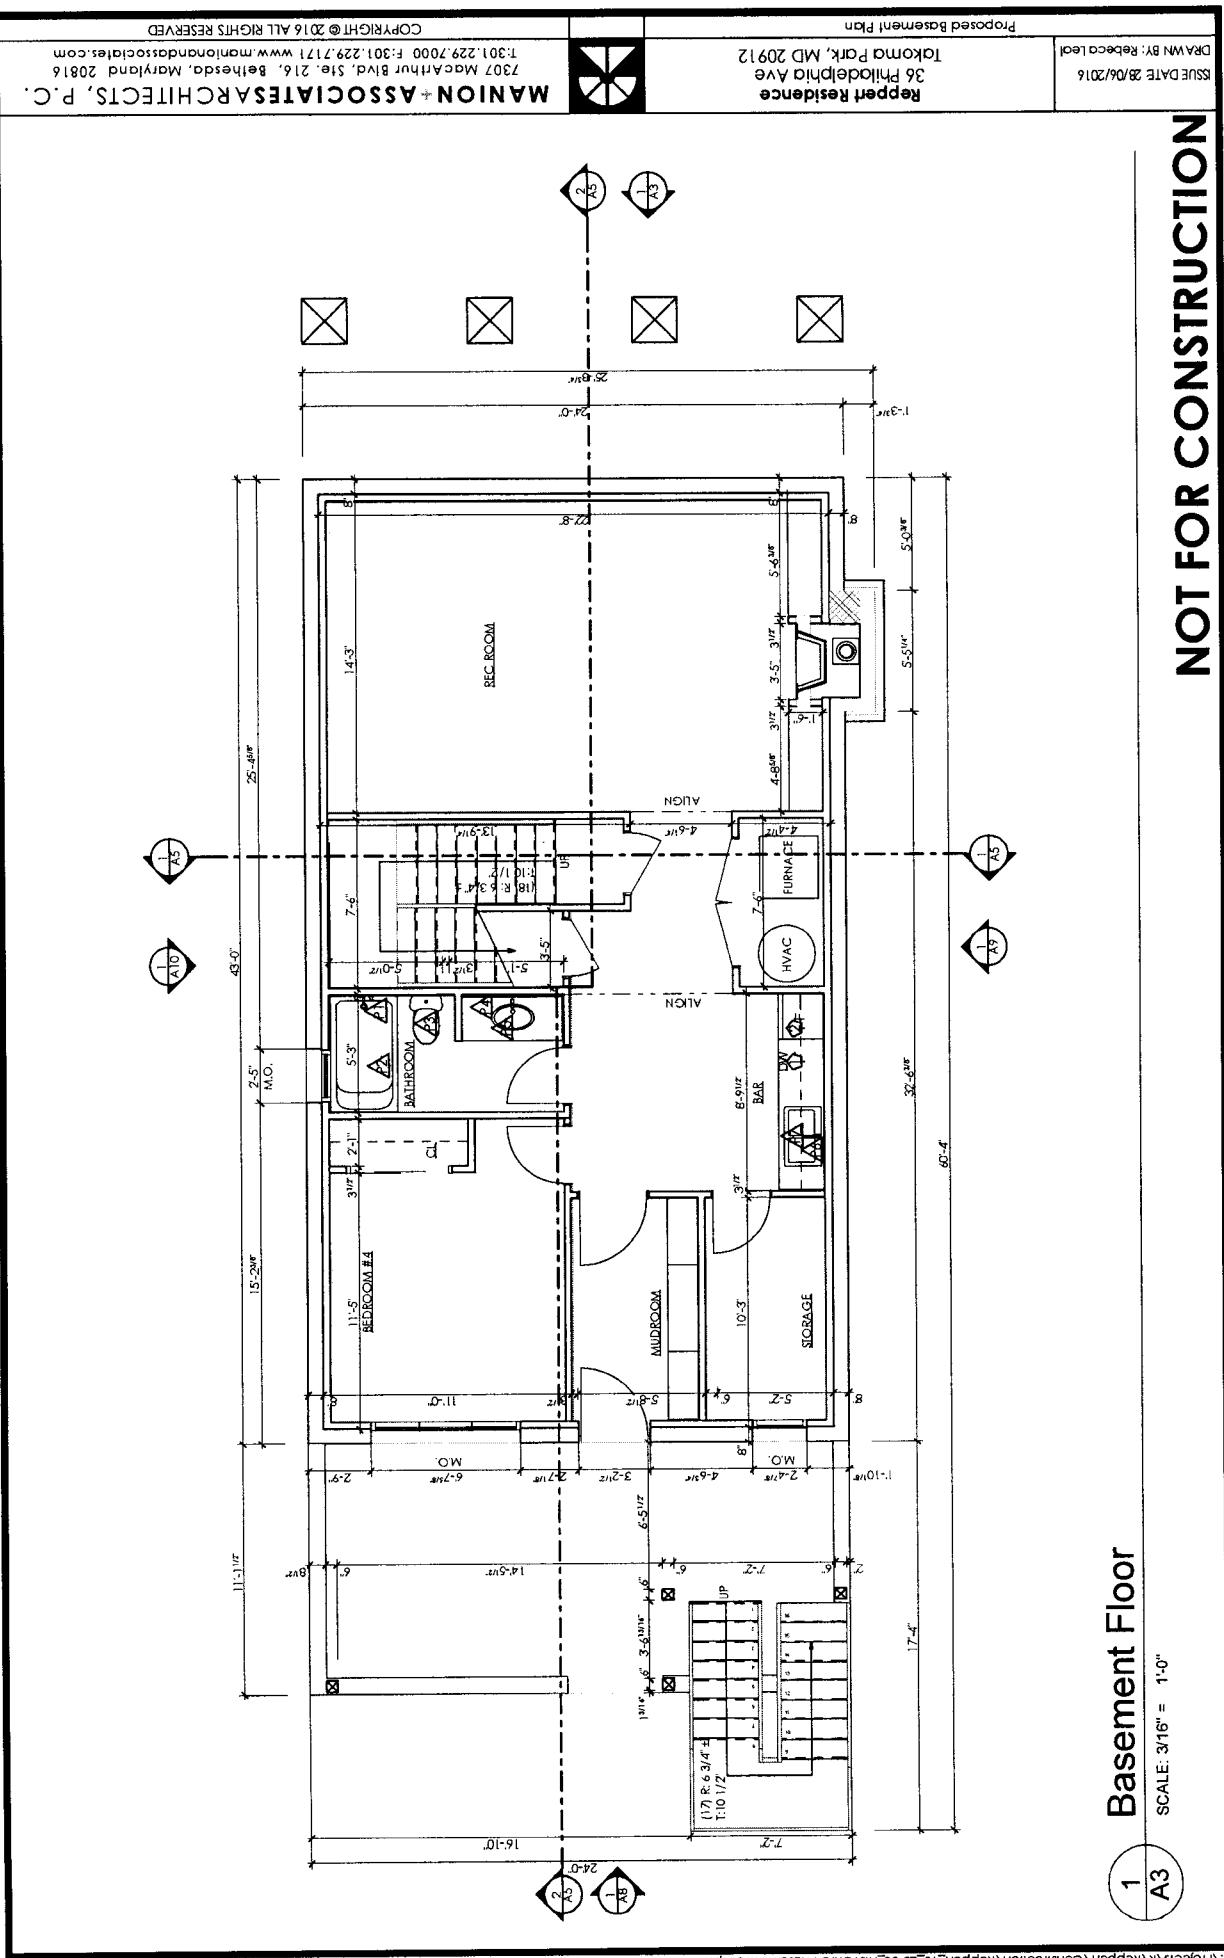


# NOT FOR CONSTRUCTION

## Proposed First Floor

SCALE: 3/16" = 1'-0"


1  
A4

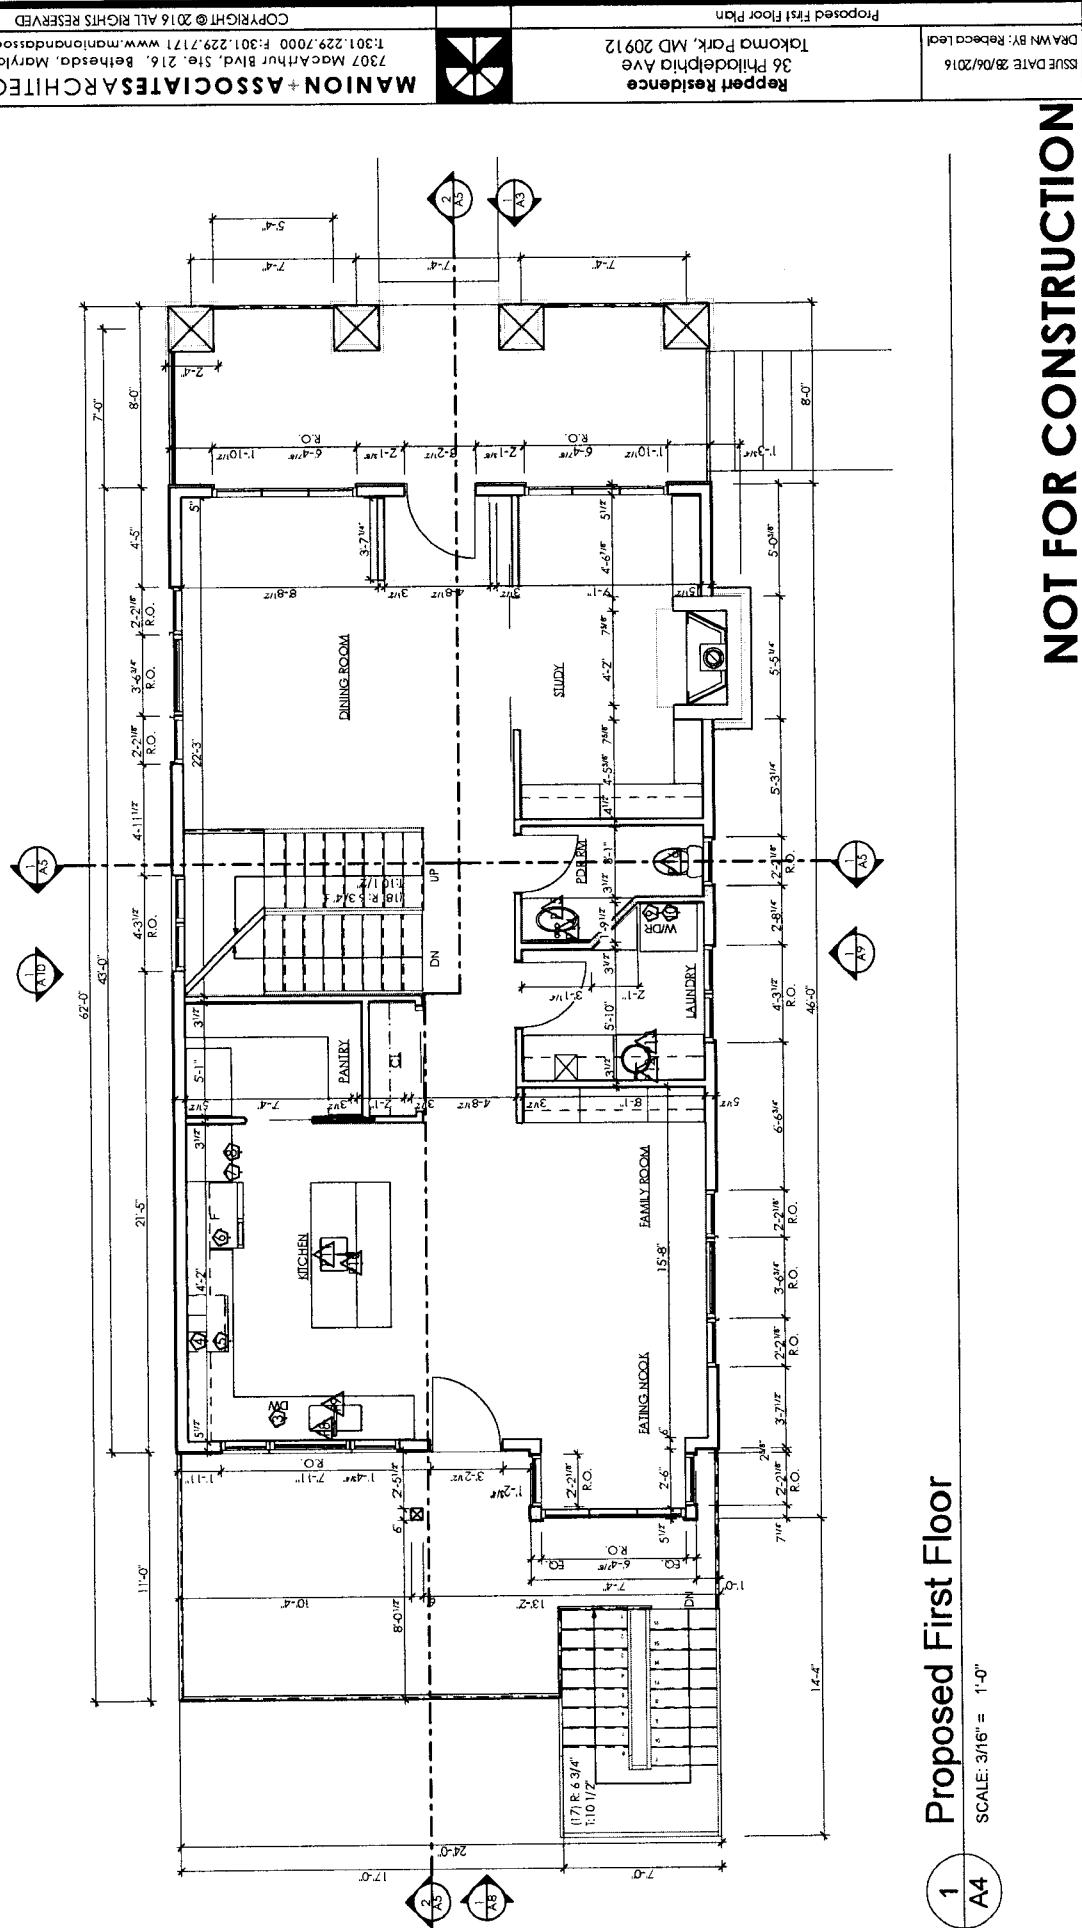

# NOT FOR CONSTRUCTION

1  
A5

Proposed Second Floor Plan  
Scale: 3'16" = 1'-0"

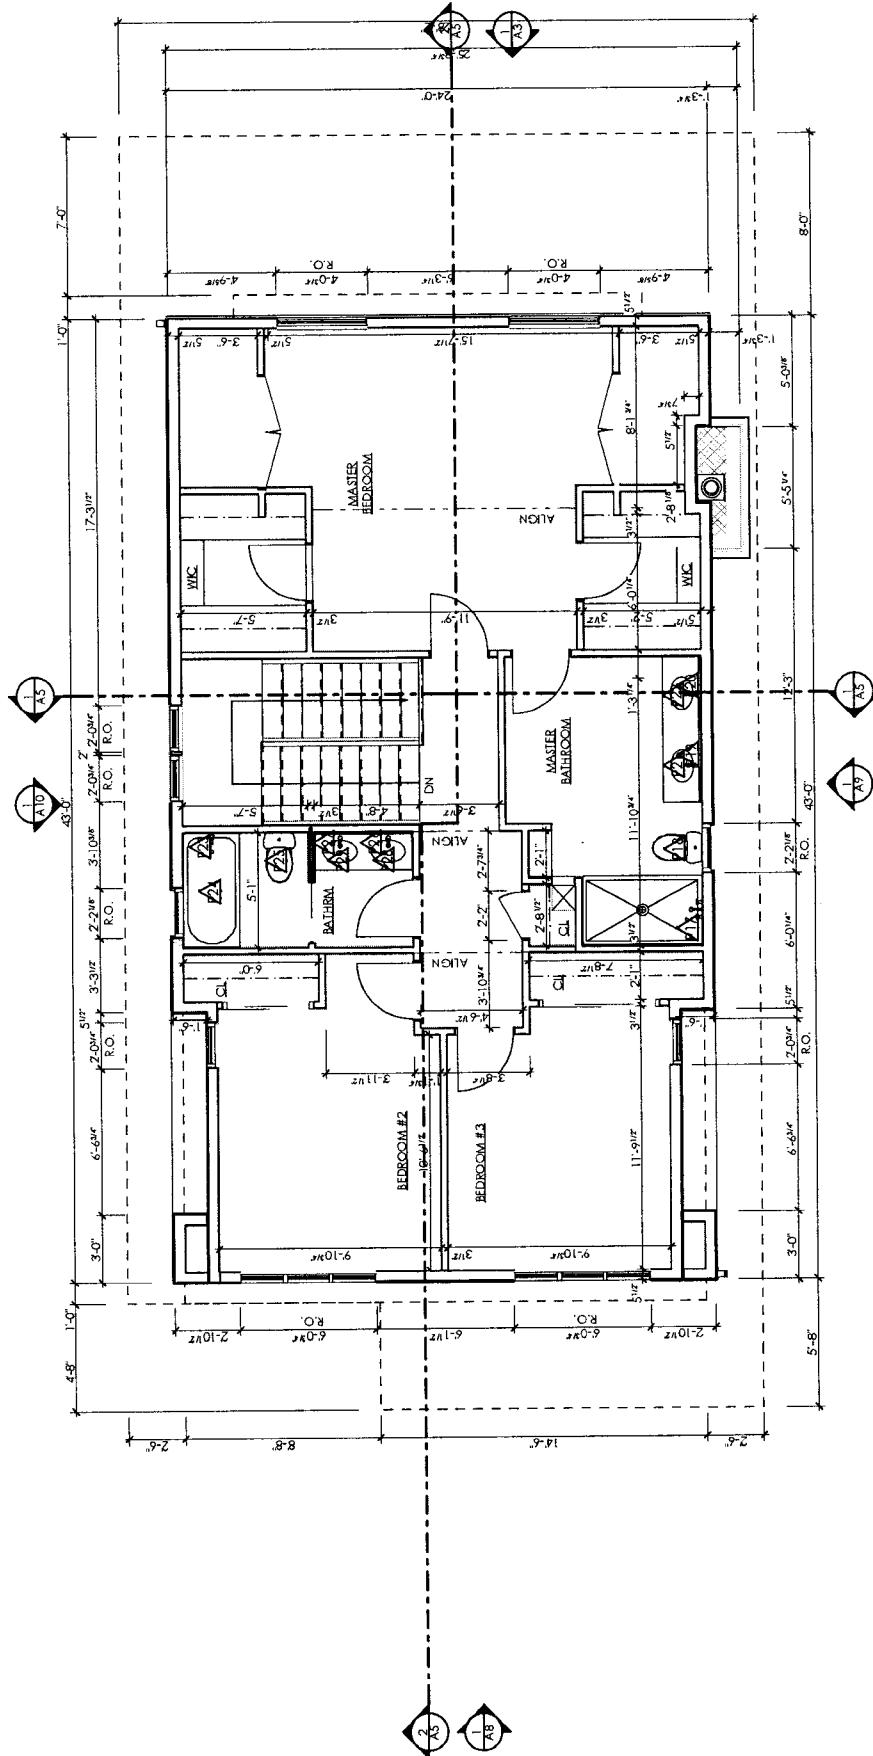


|   |  |                                      |
|---|--|--------------------------------------|
| MANION + ASSOCIATES ARCHITECTS, P.C.                        | Repper Residence                                       | Proposed Second Floor Plan           |
| T301, 229, 2000 F: 301.229.7171 WWW.MANIONANDASSOCIATES.COM | 7307 MacArthur Blvd, Ste 216, Bethesda, Maryland 20816 | COPYRIGHT © 2016 ALL RIGHTS RESERVED |
| ISSUE DATE 28/06/2016                                       | DRAWN BY: Rebbeck Laili                                | J36 Phillips Park, MD 20912          |

ISSUE DATE  
DRAWN BY

Root

SCALE: 3'16" = 1'-0"

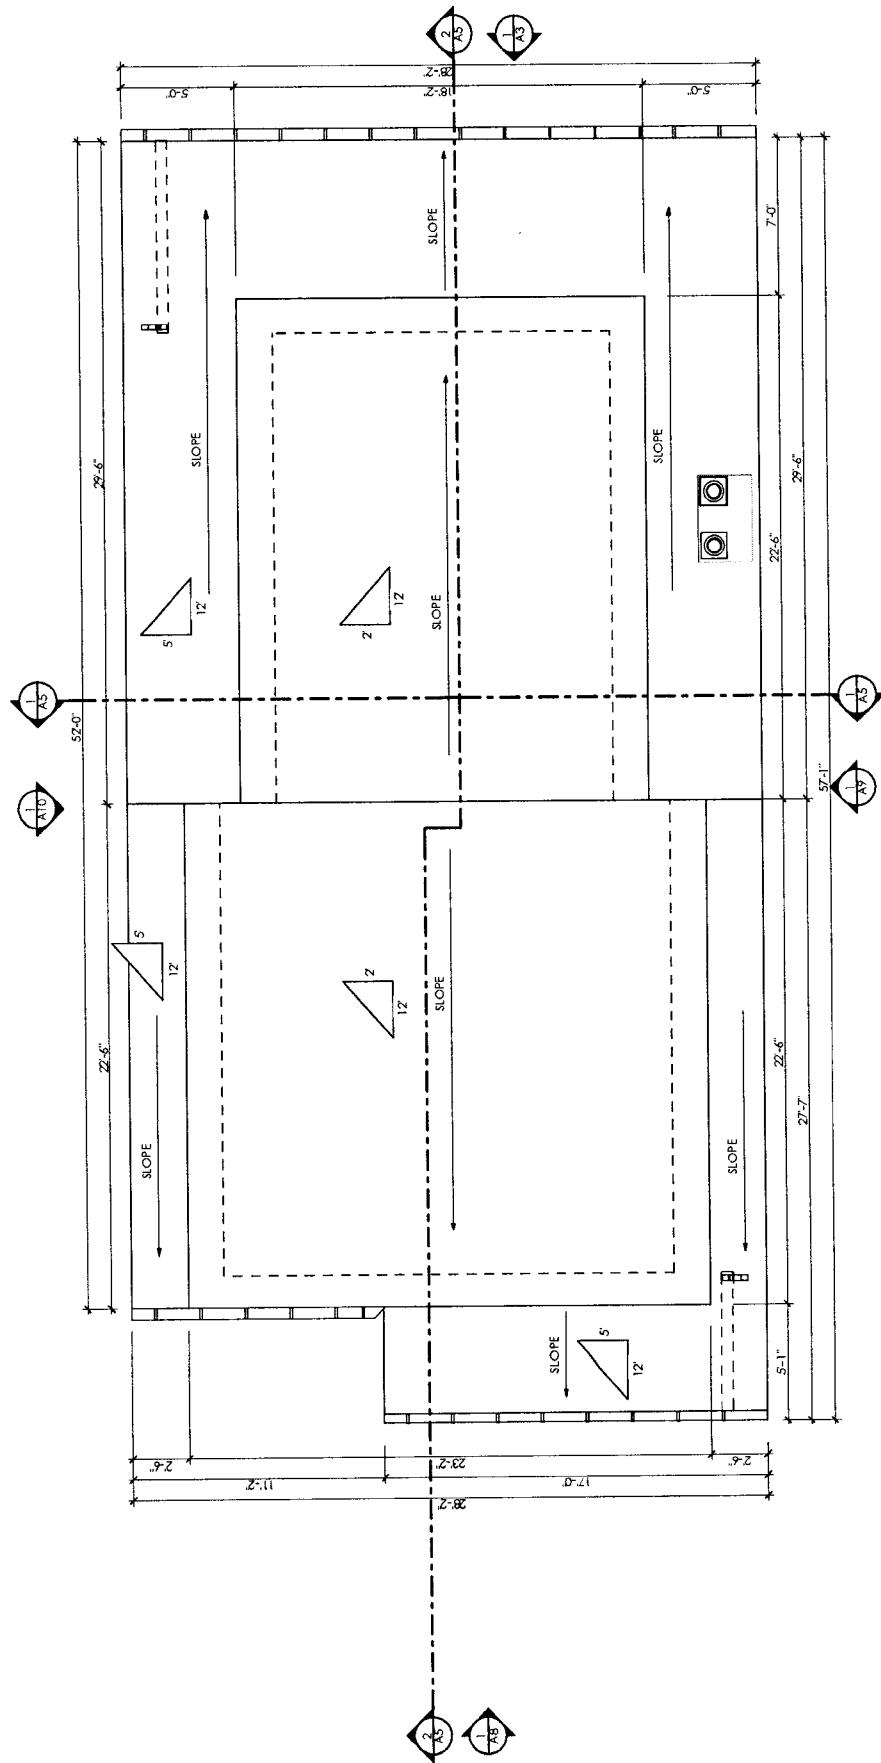


M:\Projects\R\ReppeR\Construction\Report\16\_28-06\_HISTORIC PRESERVATION.pdf

**NOT FOR CONSTRUCTION**

**Front Elevation**

SCALE: 3'16" = 1'-0"

-10'  
-12'-6"  
Foundation

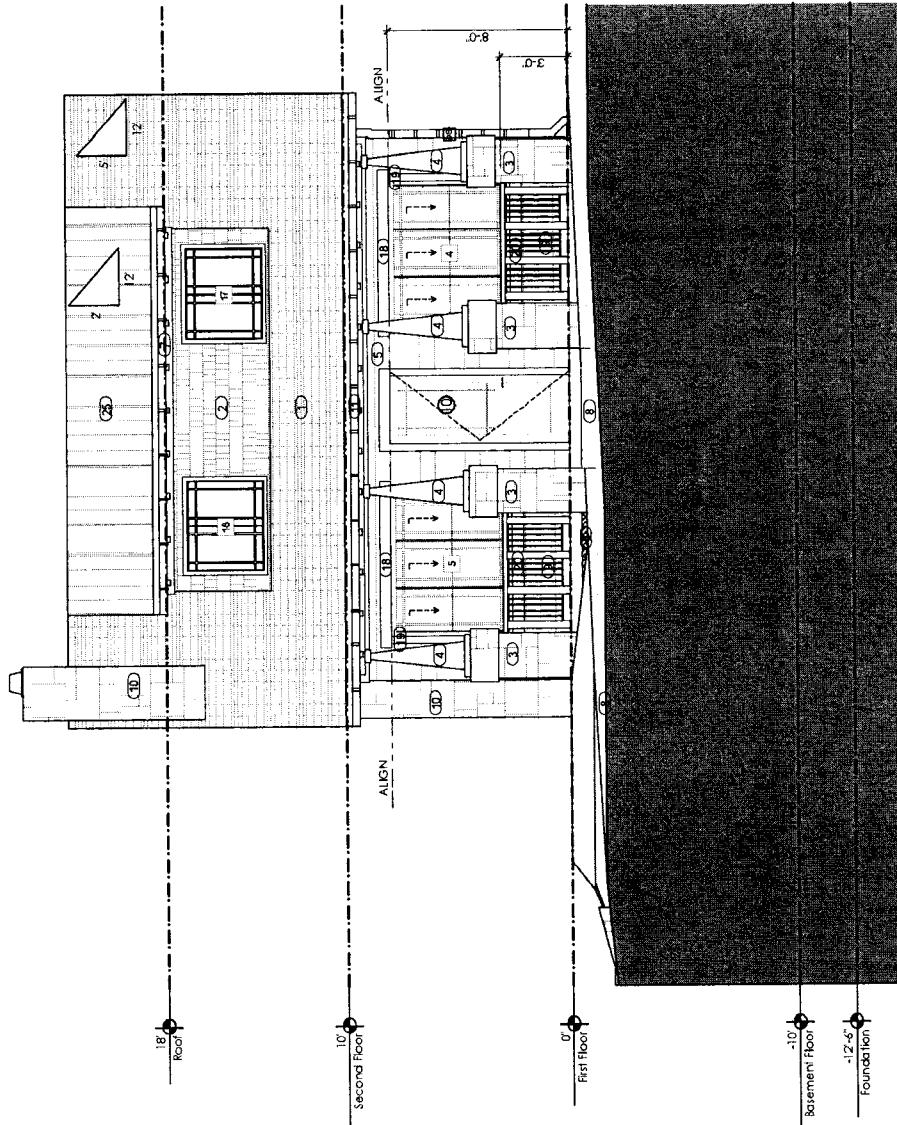

1  
A3

MANION + ASSOCIATES ARCHITECTS, P.C.  
Repper Residence  
36 Philadelphia Ave  
Takoma Park, MD 20912  
T: 301.229.7000 F: 301.229.7171 www.maniandassociates.com  
DRAWN BY: Rebekah Lebel  
ISSUE DATE: 28/06/2016  
COPYRIGHT © 2016 ALL RIGHTS RESERVED


# NOT FOR CONSTRUCTION

Rear Elevation

1

A8

SCALE: 3/16" = 1'-0"

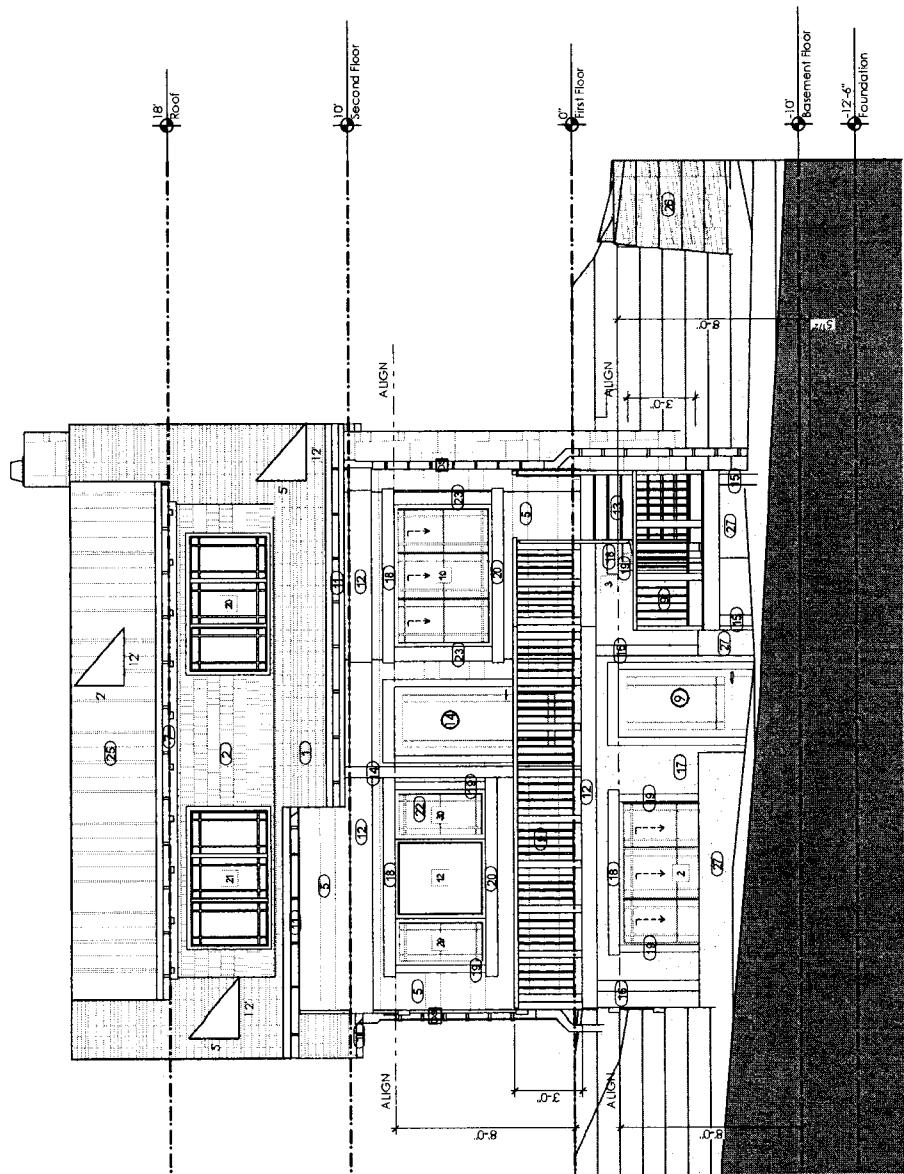


|                                      |  |                                      |
|--------------------------------------|--|--------------------------------------|
| MANION + ASSOCIATES ARCHITECTS, P.C. | 36 Philadelphia Ave<br>Takoma Park, MD 20912             | Proposed Elevations                  |
| DRAWN BY: Rebekah Leal               | T301.229.7000 F:301.229.7171 WWW.MANIONANDASSOCIATES.COM | COPYRIGHT © 2016 ALL RIGHTS RESERVED |
| ISSUE DATE: 20/06/2016               | 36 Philadelphia Ave<br>Takoma Park, MD 20912             |                                      |
|                                      |  |                                      |

# Left Elevation

SCALE: 3/4" = 1'-0"

1  
A9  
AS

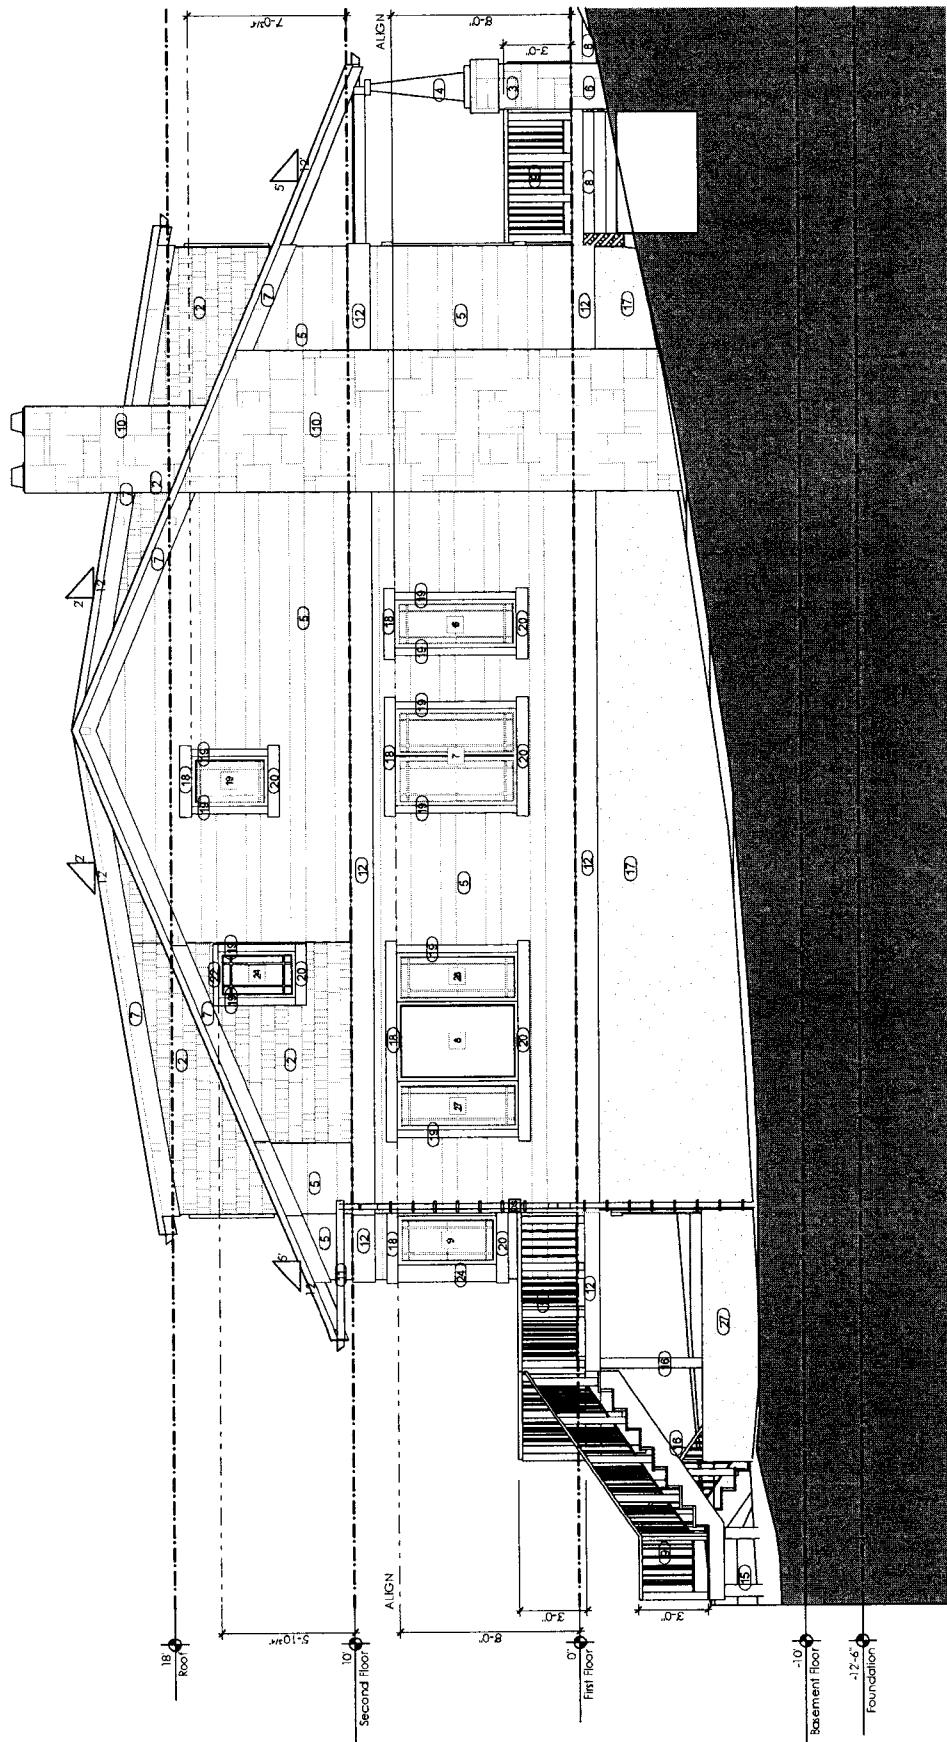

|                       |   |   |  |
|-----------------------|---|---|--|
| ISSUE DATE 06/06/2016 | REPELLED ResidencE<br>36 PhiladelphiA Ave<br>7307 Maccabim Blvd. Ste. 216, Bethesda, Maryland 20816 | Proposed Elevation<br>Takoma Park, MD 20912 | COPYRIGHT © 2016 ALL RIGHTS RESERVED<br>MANIOU + ASSOCIATES ARCHITECTS, P.C. |
|-----------------------|---|---|--|

Reppert Residence  
36 Philadelphia Ave  
Baltimore Park, MD 20912

ISSUE DATE 28/06/2016

This architectural floor plan illustrates the layout of a building across four levels: Foundation, First Floor, Second Floor, and Roof. The plan includes various rooms, doorways, and structural details. Key features include:

- Rooms:** The Foundation level contains a central area labeled "1" and a staircase. The First Floor has a large room labeled "10" and a smaller room labeled "11". The Second Floor contains several rooms, including "12", "13", "14", "15", "16", and "17". The Roof level includes a large room labeled "18" and a smaller room labeled "19".
- Staircases:** Stairs are located on the Foundation level, between the First and Second Floors, and between the Second and Roof levels.
- Align Markings:** Several "ALIGN" markings are present, indicating specific alignment points for the building's structure.
- Dimensions:** Horizontal dimensions are marked as 7'-0", 5'-10", 8'-0", 3'-0", 0'-8", and 0'-2". Vertical dimensions for floors are 8'-0" and 3'-0".
- Foundation:** The Foundation level is shown at the bottom, featuring a central area labeled "10" and a smaller room labeled "11".
- First Floor:** The First Floor is the second level from the ground, containing a large room labeled "10" and a smaller room labeled "11".
- Second Floor:** The Second Floor is the third level from the ground, containing several rooms labeled "12", "13", "14", "15", "16", and "17".
- Roof:** The Roof level is the top level, containing a large room labeled "18" and a smaller room labeled "19".


## Right Elevation

1  
A10

SCALE: 3/16" = 1'-0"

**NOT FOR CONSTRUCTION**

Rear View  
NOT TO SCALE

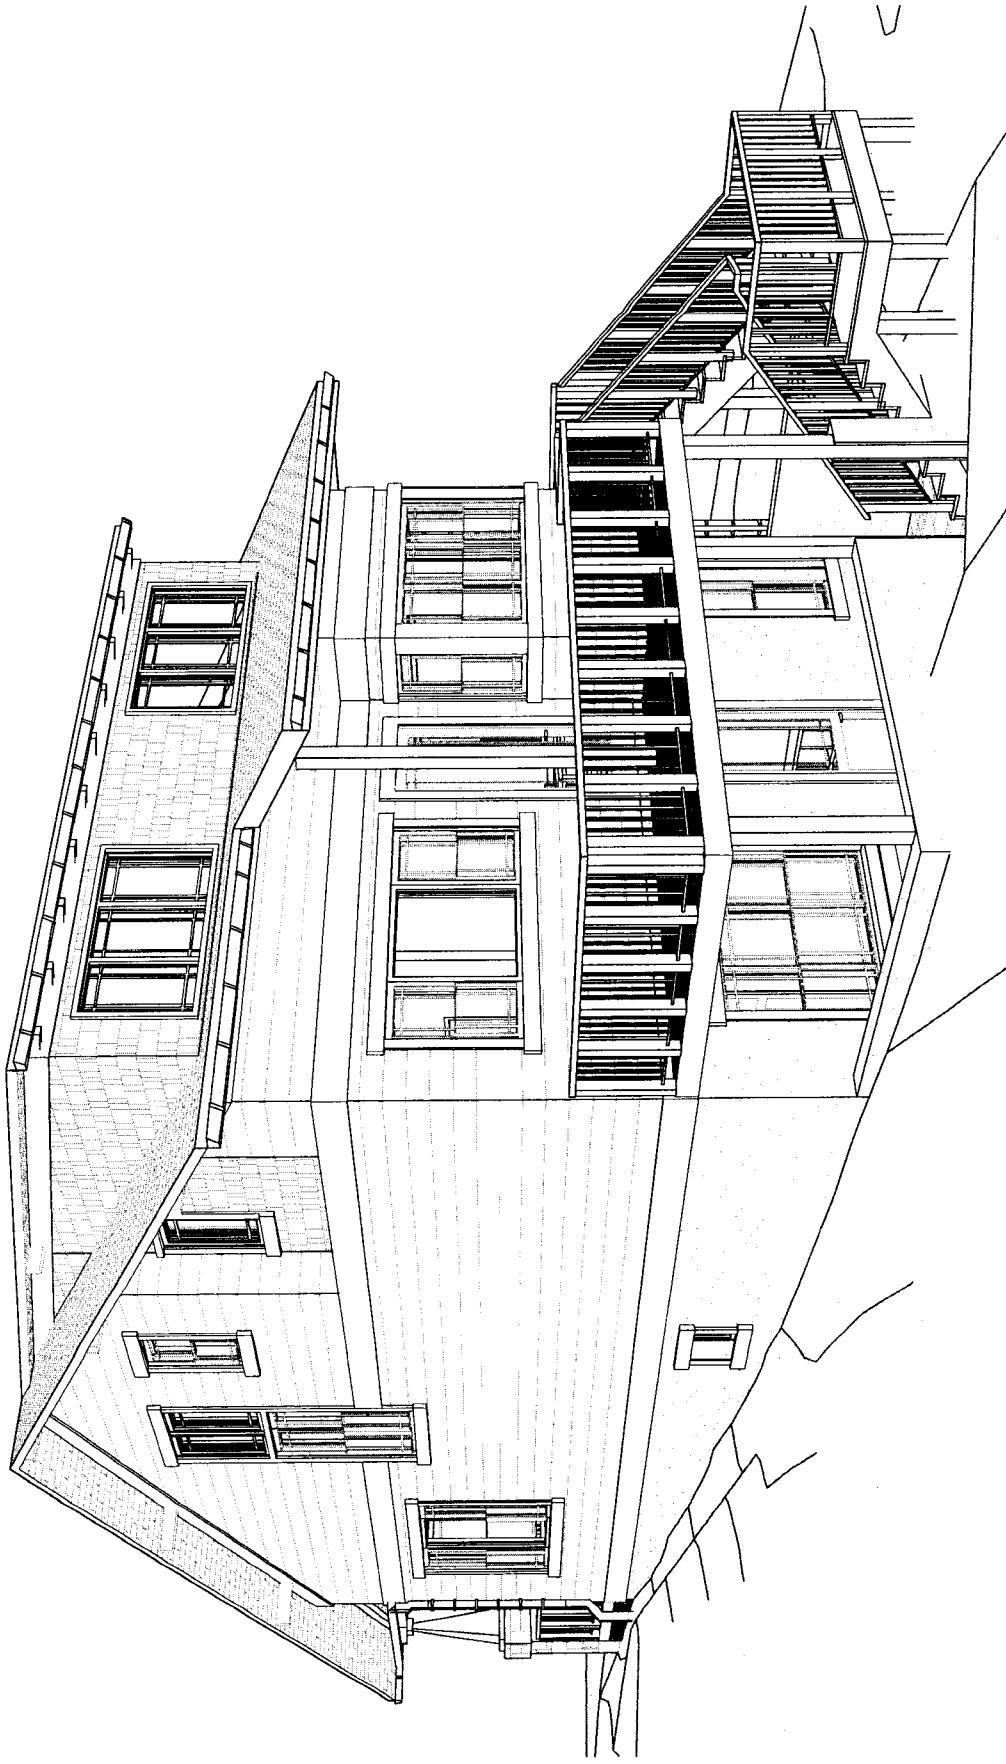

MANION + ASSOCIATES ARCHITECTS, P.C.  
Rappert Residence  
36 Philadelphia Ave  
Takoma Park, MD 20912  
7307 McGaughy Blvd, Ste. 216, Bethesda, Maryland 20816  
T301.229.7000 F301.229.7171 www.manionandassociates.com  
DRAWN BY: Rebekah Lee  
ISSUE DATE: 28/06/2016  
COPYRIGHT © 2016 ALL RIGHTS RESERVED



# NOT FOR CONSTRUCTION

| WINDOW SCHEDULE       |              |           |                    |                      |             |      |        |        |                              |
|-----------------------|--------------|-----------|--------------------|----------------------|-------------|------|--------|--------|------------------------------|
| Story                 | Mark         | Model #   | Unit Size<br>Width | Height               | R.O. Size   | Type | Temper | Egress | Notes                        |
| <b>Basement Floor</b> |              |           |                    |                      |             |      |        |        |                              |
| 1                     | 25CAWN2417   | 2'-3 1/2" | 1'-8 1/16"         | 2'-3 1/2"x1'-8 1/16" | AWNING      | NO   | NO     |        | PRAIRIE GRILLE               |
| 2                     | 25CDH2564-3  | 6'-7 5/8" | 5'-0 1/16"         | 6'-7 5/8"x5'-0 1/16" | DOUBLE HUNG | NO   |        |        | 3-WIDE UNITS. PRAIRIE GRILLE |
| 3                     | 25CDH2564    | 2'-4 7/8" | 5'-7 1/16"         | 2'-4 7/8"x5'-7 1/16" | DOUBLE HUNG | NO   | NO     |        | PRAIRIE GRILLE               |
| <b>First Floor</b>    |              |           |                    |                      |             |      |        |        |                              |
| 4                     | 25CDH2564-3  | 6'-4 7/8" | 5'-3 1/4"          | 6'-4 7/8"x5'-4 3/4"  | DOUBLE HUNG | NO   | N      |        | PRAIRIE GRILLE               |
| 5                     | 25CDH2564-3  | 6'-4 7/8" | 5'-3 1/4"          | 6'-4 7/8"x5'-4 3/4"  | DOUBLE HUNG | NO   | NO     |        | PRAIRIE GRILLE               |
| 6                     | 25CDH2564    | 2'-2 1/8" | 5'-3 1/4"          | 2'-2 1/8"x5'-4 3/4"  | DOUBLE HUNG | NO   | NO     |        | PRAIRIE GRILLE               |
| 7                     | 25CDH2564-2  | 4'-3 1/2" | 5'-3 1/4"          | 4'-3 1/2"x5'-4 3/4"  |             | NO   |        |        |                              |
| 8                     | 25CDHP4264   | 3'-6 3/4" | 5'-3 1/4"          | 3'-6 3/4"x5'-4 3/4"  | FIXED       | NO   | NO     |        | NO GRILLE                    |
| 9                     | 25CDH2552    | 2'-2 1/8" | 4'-3 1/4"          | 2'-2 1/8"x4'-4 3/4"  | DOUBLE HUNG | NO   | NO     |        | PRAIRIE GRILLE               |
| 10                    | 25CDH2552-3  | 6'-4 7/8" | 4'-3 1/4"          | 6'-4 7/8"x4'-4 3/4"  | DOUBLE HUNG | NO   | NO     |        | 3-WIDE UNITS. PRAIRIE GRILLE |
| 11                    | 25CDH2552    | 2'-2 1/8" | 4'-5 3/4"          | 2'-2 1/8"x4'-5 3/4"  | DOUBLE HUNG | NO   | NO     |        | PRAIRIE GRILLE               |
| 12                    | 25CDHP4248   | 3'-6 3/4" | 4'-0 3/4"          | 3'-6 3/4"x4'-0 3/4"  | FIXED       | NO   | NO     |        | NO GRILLE                    |
| 13                    | 25CDHP4264   | 3'-6 3/4" | 5'-3 1/4"          | 3'-6 3/4"x5'-4 3/4"  | FIXED       | NO   | NO     |        | NO GRILLE                    |
| 25                    | 25CDH2564    | 2'-2 1/8" | 5'-3 1/4"          | 2'-2 1/8"x5'-4 3/4"  | DOUBLE HUNG | NO   | NO     |        | PRAIRIE GRILLE               |
| 26                    | 25CDH2564    | 2'-2 1/8" | 5'-4 1/4"          | 2'-2 1/8"x5'-4 3/4"  | DOUBLE HUNG | NO   | NO     |        | PRAIRIE GRILLE               |
| 27                    | 25CDH2564    | 2'-2 1/8" | 5'-4 3/4"          | 2'-2 1/8"x5'-4 3/4"  | DOUBLE HUNG | NO   | NO     |        | PRAIRIE GRILLE               |
| 28                    | 25CDH2564    | 2'-2 1/8" | 5'-4 3/4"          | 2'-2 1/8"x5'-4 3/4"  | DOUBLE HUNG | NO   | NO     |        | PRAIRIE GRILLE               |
| 29                    | 25CDH2548    | 2'-2 1/8" | 4'-0 3/4"          | 2'-2 1/8"x4'-0 3/4"  | DOUBLE HUNG | NO   | NO     |        | PRAIRIE GRILLE               |
| 30                    | 25CDH2548    | 2'-2 1/8" | 4'-0 3/4"          | 2'-2 1/8"x4'-0 3/4"  | DOUBLE HUNG | NO   | NO     |        | PRAIRIE GRILLE               |
| <b>Second Floor</b>   |              |           |                    |                      |             |      |        |        |                              |
| 14                    | 25CDH2564-2  | 4'-3 1/2" | 5'-3 1/4"          | 4'-3 1/2"x5'-4 3/4"  | DOUBLE HUNG | NO   | NO     |        | PRAIRIE GRILLE               |
| 15                    | 25CDHP2442   | 2'-0 3/4" | 3'-6 3/4"          | 2'-0 3/4"x3'-6 3/4"  | FIXED       | NO   | NO     |        | PRAIRIE GRILLE               |
| 16                    | 25CDHP2442   | 2'-0 3/4" | 3'-6 3/4"          | 2'-0 3/4"x3'-6 3/4"  | FIXED       | NO   | NO     |        | PRAIRIE GRILLE               |
| 17                    | 25CCMT244... | 4'-0 3/4" | 3'-4 3/4"          | 4'-0 3/4"x3'-4 3/4"  | CASEMENT    | NO   | YES    |        | 2-WIDE UNITS. PRAIRIE GRILLE |
| 18                    | 25CCMT244... | 4'-0 3/4" | 3'-4 3/4"          | 4'-0 3/4"x3'-4 3/4"  | CASEMENT    | NO   | YES    |        | 2-WIDE UNITS. PRAIRIE GRILLE |
| 19                    | 25CDH2540    | 2'-2 1/8" | 3'-4 3/4"          | 2'-2 1/8"x3'-4 3/4"  | DOUBLE HUNG | NO   | NO     |        | PRAIRIE GRILLE               |
| 20                    | 25CCMT244... | 6'-0 3/4" | 3'-4 3/4"          | 6'-0 3/4"x3'-4 3/4"  | CASEMENT    | NO   | YES    |        | 3-WIDE UNITS. PRAIRIE GRILLE |
| 21                    | 25CCMT244... | 6'-0 3/4" | 3'-4 3/4"          | 6'-0 3/4"x3'-4 3/4"  | CASEMENT    | NO   | YES    |        | 3-WIDE UNITS. PRAIRIE GRILLE |
| 22                    | 25CDH2540    | 2'-2 1/8" | 3'-4 3/4"          | 2'-2 1/8"x3'-4 3/4"  | DOUBLE HUNG | NO   | NO     |        | PRAIRIE GRILLE               |
| 23                    | 25CCMT2440   | 2'-0 3/4" | 3'-4 3/4"          | 2'-0 3/4"x3'-4 3/4"  | CASEMENT    | NO   | YES    |        | PRAIRIE GRILLE               |
| 24                    | 25CCMT2440   | 2'-0 3/4" | 3'-4 3/4"          | 2'-0 3/4"x3'-4 3/4"  | CASEMENT    | NO   | YES    |        | PRAIRIE GRILLE               |

|  |  |   |
|--|--|---|
| <br><b>MANION + ASSOCIATES ARCHITECTS, P.C.</b>                                | <b>Repper Residence</b><br><b>36 Philadelphia Park, MD 20912</b> | <b>Window Schedule</b>                              |
| <small>ISSUE DATE 28/06/2016</small>   | <small>DRAWN BY: Rebekah Lee</small>                             | <small>COPYRIGHT © 2016 ALL RIGHTS RESERVED</small> |
| <small>7307 MACARTHUR BLVD, STE. 216, BEVERLY HILLS, CALIFORNIA 90210</small>  |  |   |
| <small>F: 301.229.7000   E: 301.229.7171   WWW.MANIONANDASSOCIATES.COM</small> |  |   |

# NOT FOR CONSTRUCTION

## DOOR SCHEDULE

| Story          | Mark | Brand   | Model #             | Unit Size | R.O. Size | Transom Height      | Left Sidelight Width | Right Sidelight Width | Notes  |
|----------------|------|---------|---------------------|-----------|-----------|---------------------|----------------------|-----------------------|--|
|                |      |         |                     | Width     | Height    |                     |                      |                       |  |
| Basement Floor | 9    | SIMPSON | 7942-THERMAL SASH   | 3'-0"     | 8'-0"     | 3'-2 1/2"x8'-1 1/4" | N/A                  | N/A                   | CUSTOM GLASS PANEL SASH, CRAFTSMAN STYLE TO MATCH WINDOWS. VERIFY WITH ARCH. |
| First Floor    | 10   | SIMPSON | 7942-THERMAL SASH   | 3'-0"     | 8'-0"     | 3'-2 1/2"x8'-1 1/4" | N/A                  | N/A                   | CUSTOM GLASS PANEL SASH, CRAFTSMAN STYLE TO MATCH WINDOWS. VERIFY WITH ARCH. |
|                | 14   | SIMPSON | 7109-THERMAL FRENCH | 3'-0"     | 8'-0"     | 3'-2 1/2"x8'-1 1/4" | N/A                  | N/A                   | CUSTOM GLASS PANEL SASH, CRAFTSMAN STYLE TO MATCH WINDOWS. VERIFY WITH ARCH. |

## WINDOW GENERAL NOTES:

1. WINDOWS SPECIFIED A/E BY JED WEN W2500.
2. WINDOWS ARE ALUMINUM CLAD WOOD, FRAME & SASH FRENCH VANILLA COLOR, LOW-E EX ARGON GLASS, WITH PRAIRIE GRILLE, CASING TO BE FIELD APPLIED UNLESS NOTED OTHERWISE. SEE ELEVATIONS FOR GRILLE PATTERNS AND OPENING DIRECTIONS.
3. PROVIDE ALL NECESSARY HARDWARE -WHITE. WEATHER STRIPPING, TRIM PIECES, ETC./
4. PROVIDE INSECT SCREENS FOR ALL OPERABLE WINDOWS (UNLESS NOTED OTHERWISE) COLOR TO BE WHITE.
5. REFER TO PLANS AND ELEVATIONS FOR WINDOW LOCATIONS, VERIFY SIZES AND QUANTITIES PRIOR TO ORDERING.
6. APPLY SEALANT AROUND EXTERIOR PERIMETER BEHIND WINDOW TRIM AND SET INTO OPENING.
7. APPLY FOAM BACKER ROD AND SEALANT TO EXTERIOR PERIMETER OF TRIM AT SIDING JOINT.
8. APPLY LOW EXPANSION SPRAY FOAM AROUND ALL WINDOW JAMBS.
9. WINDOWS LISTED AS TEMPERED ARE FOR REFERENCE ONLY. COORDINATE WITH WINDOW SUPPLIER AND APPLICABLE CODES TO VERIFY REQUIRED LOCATIONS/ WINDOW TO BE TEMPERED PRIOR TO BIDDING/PURCHASING.
10. ALL WINDOWS TO HAVE JAMB EXTENDERS AS NECESSARY FOR 4'-9 1/16" & 6'-9 1/16" JAMBS. COORDINATE REQUIRED DEPTHS WITH PLAN.
11. FIELD VERIFY WINDOW HEIGHTS AND CLEARANCES PRIOR TO PURCHASING.
12. WINDOWS TO HAVE ADHESIVE FLASHING & SILL PANS- INSTALL PER MFR'S RECOMMENDATIONS

|            |    |                                  |
|------------|----|----------------------------------|
| Elevation  |    | 10                               |
| Mark       | 9  | NOTES CUSTOM GLASS PANEL SASH... |
| DOOR TYPES | 14 | NOTES CUSTOM GLASS PANEL SASH... |

## DOOR GENERAL NOTES:

1. CHECK DRAWINGS FOR SWING DIRECTIONS AND LOCATIONS.
2. PROVIDE ALL NECESSARY HARDWARE, WEATHER STRIPPING, TRIM PIECES, ETC.
3. EXTERIOR FRENCH DOORS ARE SIMPSON, FRENCH VANILLA, EXTERIOR THERMAL SASH AND THERMAL FRENCH, ALUMINUM CLAD WOOD HINGED PATIO DOORS- INSWING. SEE ELEVATIONS FOR GRILLE PATTERNS, EXTERIOR FRENCH & SASH STYLE
4. HARDWARE: CONSULT ARCHITECT
5. INTERIOR DOORS TO BE JELD-WEN, CRAFTSMAN III SMOOTH DOORS UNLESS SHOWN OTHERWISE.
6. APPLY SEALANT AROUND EXTERIOR PERIMETER BEHIND DOOR TRIM/ FLANGE AND SET INTO OPENING.
7. APPLY FOAM BACKER ROD & SEALANT TO EXTERIOR PERIMETER OF TRIM AT SIDING JOINT.
8. BEDROOM, BATHROOM AND ENTRY DOORS TO BE SOLID.
10. GLASS TO BE LOW-E EX ARGON TEMPERED GLASS.
11. ALL DOORS IN WALLS OTHER THAN 2x4 WALLS TO HAVE JAMB EXTENDERS AS NECESSARY.
12. FIELD VERIFY EXISTING DOOR OPENING SIZES AND COORDINATE AS REQUIRED.
13. EXTERIOR DOORS NOTED TO HAVE RETRACTABLE SCREENS SHOULD BE SITE MEASURED AND THE SCREENS CUSTOM SIZED FOR EACH DOOR LISTED. MANUFACTURER TO BE LIBERTY SCREENS, PHANTOM SCREENS OR ARCHITECT/OWNER APPROVED ALTERNATE COLOR TO MATCH DOORS.

|   |                       |                      |                       |                      |                    |               |   |
|---|-----------------------|----------------------|-----------------------|----------------------|--------------------|---------------|---|
| ISSUE DATE 20/06/2016                       | DRAWN BY: Rebekca Lea | RELEASER RESIDENTIAL | Takoma Park, MD 20912 | 36 Phillip Drive Ave | Repper Residential | Door Schedule | COPYRIGHT © 2016 ALL RIGHTS RESERVED<br>7307 McArthur Blvd, Ste 216, Bethesda, Maryland 20816 |
| <b>MANION + ASSOCIATES ARCHITECTS, P.C.</b> |                       |                      |                       |                      |                    |               |   |

# NOT FOR CONSTRUCTION

**Reserve Bottom Rail**



**Reserve Top Rail**



## INFILL DETAIL

SIZES: 6" X 6" I 4" X 4"  
COLORS: WHITE

## RAIL DETAIL

Show 6" x 6" I 4" x 4" Skirt

SIZES: 6" X 6" I 4" X 4"  
COLORS: WHITE


SCALE: 1 1/2" = 1'-0"

## Baluster connection

DRAWN BY: Rebekah Leal  
DATE: 2/06/2016


Railing Details  
Repper Residence  
36 Philadelphian Ave  
Tokoma Park, MD 20912

COPYRIGHT © 2016 ALL RIGHTS RESERVED  
7307 MacArthur Blvd, Ste 216, Bethesda, Maryland 20816  
f:301.229.7000; e:301.229.7171; www.manionandassociates.com

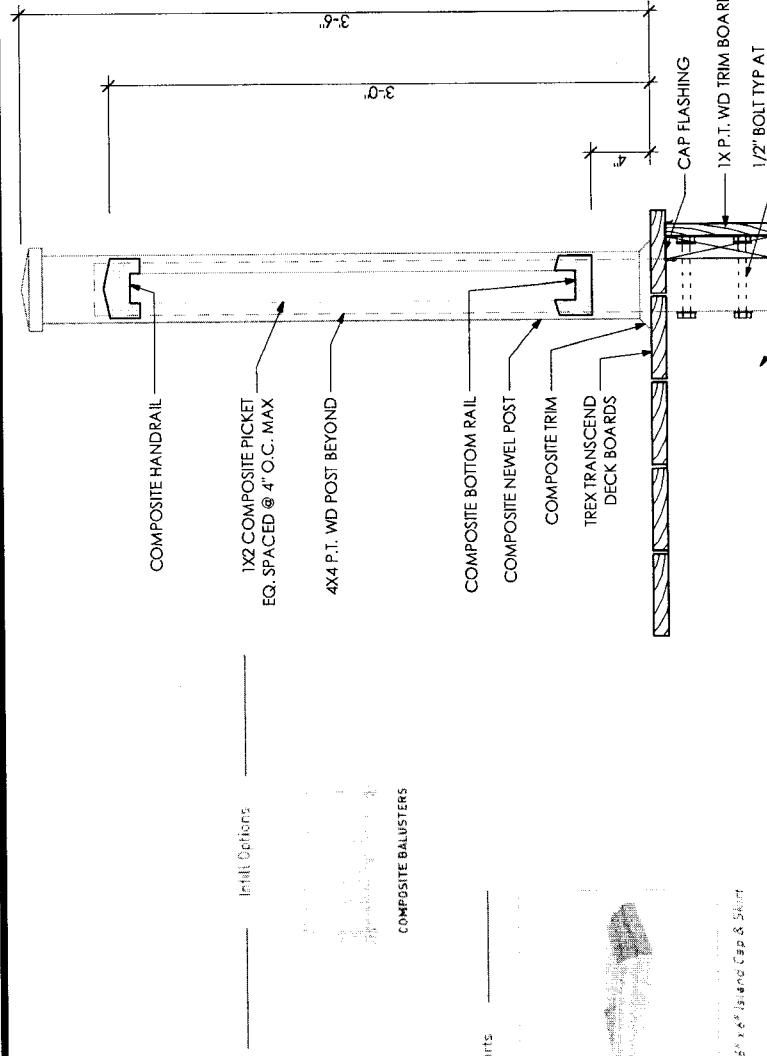

# NOT FOR CONSTRUCTION


1) ARCH- ASPHALT SHINGLE ROOF-DRIFTWOOD  
2) HARDIE SHINGLES-OLIVE  
3) EL DORADO NATURAL STONE 2x6 LEDGE GOLDEN PRAIRIE  
COLUMN BASE  
4) HARDIE BOARD COLUMN- DARK GREEN  
5) HARDIE BOARD SIDING DESIGN- DARK GREEN  
6) LATTICE  
7) BORAL TRIM-FRENCH VANILLA  
8) EL DORADO NATURAL STONE GOLDEN PRAIRIE STEPS  
9) AZEK RESERVE RAILING-WHITE  
10) EL DORADO NATURAL STONE 2x6 LEDGE GOLDEN PRAIRIE  
CHIMNEY  
11) GUTTER  
12) BORAL TRIM-FRENCH VANILLA  
13) WOOD DECK STAIRS  
14) WOOD POST PER STRUCTURAL PLANS  
15) WOOD POST PER STRUCTURAL PLANS  
16) POURED CONCRETE FOUNDATION WITH STUCCO FINISH  
17) WINDOW HEADER BORAL TRIM - 2x6- FRENCH VANILLA  
18) WINDOW BORAL TRIM 1x4- FRENCH VANILLA  
19) WINDOW SILL BORAL TRIM 2x6-FRENCH VANILLA  
20) WINDOW BORAL TRIM 1x2- FRENCH VANILLA  
21) WINDOW BORAL TRIM 1x4 CUT TO FIT-FRENCH VANILLA  
22) WINDOW BORAL TRIM 1x8 CUT TO FIT-FRENCH VANILLA  
23) WINDOW BORAL TRIM 1x6 CUT TO FIT-FRENCH VANILLA  
24) WINDOW BORAL TRIM 1x10 CUT TO FIT-FRENCH VANILLA  
25) STANDING SEAM METAL ROOF-SHAKE GRAY  
26) EXISTING CONCRETE DRIVEWAY  
27) NEW RETAINING LOW WALL

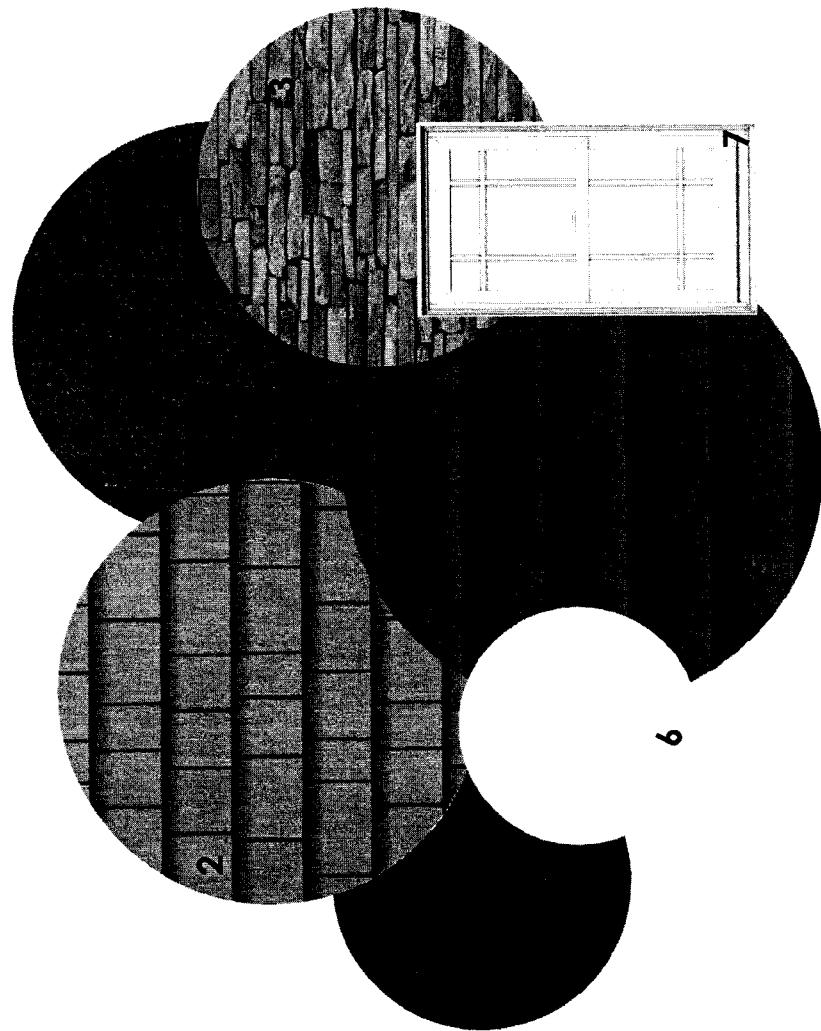


|  |
|--|
| ELEVATION KEY NOTES                                  |
| 1) ARCH- ASPHALT SHINGLE ROOF- DRIFTWOOD             |
| 2) HARDIE SHINGLES- OLIVE                            |
| 3) EL DORADO NATURAL STONE 2x6 LEDGE GOLDEN PRAIRIE  |
| COLUMN BASE  |
| 4) HARDIE BOARD COLUMN- DARK GREEN                   |
| 5) HARDIE BOARD SIDING DESIGN- DARK GREEN            |
| 6) LATTICE   |
| 7) BORAL TRIM-FRENCH VANILLA                         |
| 8) EL DORADO NATURAL STONE GOLDEN PRAIRIE STEPS      |
| 9) AZEK RESERVE RAILING-WHITE                        |
| 10) EL DORADO NATURAL STONE 2x6 LEDGE GOLDEN PRAIRIE |
| CHIMNEY  |
| 11) GUTTER   |
| 12) BORAL TRIM-FRENCH VANILLA                        |
| 13) WOOD DECK STAIRS                                 |
| 14) WOOD POST PER STRUCTURAL PLANS                   |
| 15) WOOD POST PER STRUCTURAL PLANS                   |
| 16) POURED CONCRETE FOUNDATION WITH STUCCO FINISH    |
| 17) WINDOW HEADER BORAL TRIM - 2x6- FRENCH VANILLA   |
| 18) WINDOW BORAL TRIM 1x4- FRENCH VANILLA            |
| 19) WINDOW SILL BORAL TRIM 2x6-FRENCH VANILLA        |
| 20) WINDOW BORAL TRIM 1x2- FRENCH VANILLA            |
| 21) WINDOW BORAL TRIM 1x4 Cut To Fit-FRENCH VANILLA  |
| 22) WINDOW BORAL TRIM 1x8 Cut To Fit-FRENCH VANILLA  |
| 23) WINDOW BORAL TRIM 1x6 Cut To Fit-FRENCH VANILLA  |
| 24) WINDOW BORAL TRIM 1x10 Cut To Fit-FRENCH VANILLA |
| 25) STANDING SEAM METAL ROOF-SHAKE GRAY              |
| 26) EXISTING CONCRETE DRIVEWAY                       |
| 27) NEW RETAINING LOW WALL                           |

|   |   |   |                      |                         |                                      |
|---|---|---|----------------------|-------------------------|--------------------------------------|
| DRAWN BY: REBECCA LEAI                      | REPEPER Residence                                     | 36 Philadelphia Ave                       | Tokoma Park MD 20912 | Material Specifications | COPYRIGHT © 2016 ALL RIGHTS RESERVED |
| DATE 28/06/2016                             | 7307 MAGAHR BLVD, SUITE 216, Bethesda, Maryland 20816 | F301.229.7171 WWW.MANIONANDASSOCIATES.COM |                      |                         |                                      |
| <b>MANION + ASSOCIATES ARCHITECTS, P.C.</b> |   |   |                      |                         |                                      |

**Existing Property Condition Photographs (duplicate as needed)**

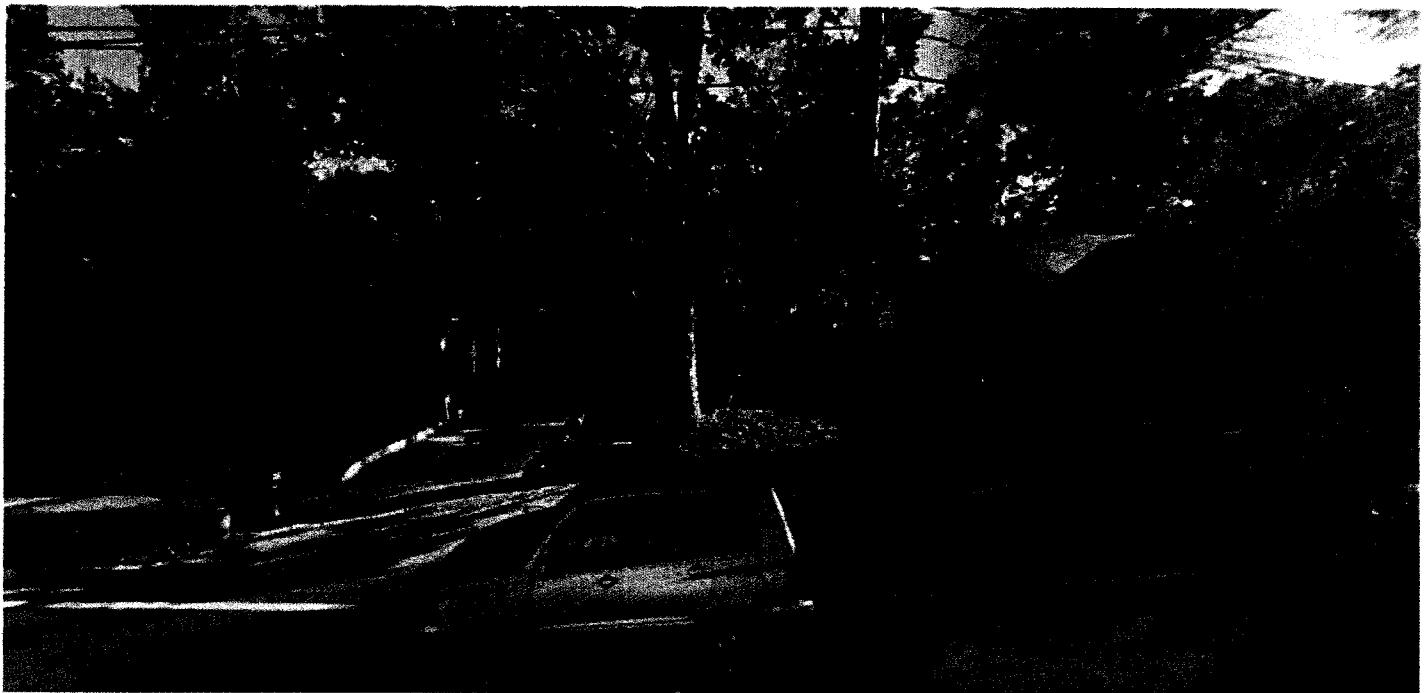

**Detail:** \_\_\_\_\_ Front of the lot. Left and Right adjacent houses.

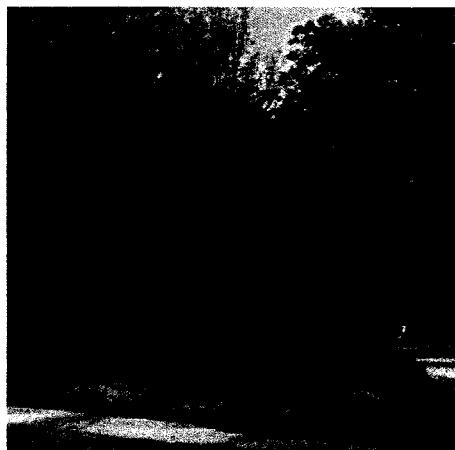

**Detail:** \_\_\_\_\_ Adjacent house on left--Adjacent house on right

**Applicant:** Tiffany Manion

**Page:** 1 of 2

**Existing Property Condition Photographs (duplicate as needed)**



**Detail:** \_\_\_\_\_  
View from the lot to the Front houses on Park Ave.



**Detail:** \_\_\_\_\_  
View from the lot to the intersection of Maryland 410 and Park Ave

---

**Applicant:** Tiffany Manion

**Page:** 2 of 2

**HAWP APPLICATION: MAILING ADDRESSES FOR NOTIFYING**  
[Owner, Owner's Agent, Adjacent and Confronting Property Owners]

| <b>Owner's mailing address</b>  | <b>Owner's Agent's mailing address</b>   |
|---|--|
| Wesley Reppert<br>1300 Eye Street NW, Suite 600<br>Washington, DC 20005         | Rita Kader<br>5823 Goldsboro Road<br>Bethesda, MD 20817                                  |
| <b>Adjacent and confronting Property Owners mailing addresses</b>               |  |
| Left Side:<br>Gary P Lovett<br>38 Philadelphia Ave<br>Takoma Park, MD 20912     | Right Side:<br>Claude Philomene<br>34 Philadelphia Ave<br>Takoma Park, MD 20912          |
| Rear:<br>Michael & Maya Bernstein<br>120 Grant Ave<br>Takoma Park, MD 20912     | Front Side:<br>Zocca Valentino<br>29 Philadelphia Ave<br>Takoma Park, MD 20912           |
| Rear Side:<br>A&J Construction CO INC<br>116 Grant Ave<br>Takoma Park, MD 20912 | Front Side:<br>Durban Christopher M et La Tr<br>37 Maryland 410<br>Takoma Park, MD 20912 |