

# HISTORIC PRESERVATION COMMISSION

Marc Elrich
County Executive

Robert K. Sutton Chairman

Date: February 18, 2022

# **MEMORANDUM**

TO: Mitra Pedoeem

Department of Permitting Services

FROM: Michael Kyne

Historic Preservation Section

Maryland-National Capital Park & Planning Commission

SUBJECT: Historic Area Work Permit # 978966: Installation of new telecommunications equipment

The Montgomery County Historic Preservation Commission (HPC) has reviewed the attached application for a Historic Area Work Permit (HAWP). This application was **Approved with one (1) condition** at the February 16, 2022 HPC meeting.

1. The proposed new RF Friendly Canister will be painted matte blue, with final review and approval delegated to staff.

The HPC staff has reviewed and stamped the attached construction drawings.

THE BUILDING PERMIT FOR THIS PROJECT SHALL BE ISSUED CONDITIONAL UPON ADHERENCE TO THE ABOVE APPROVED HAWP CONDITIONS AND MAY REQUIRE APPROVAL BY DPS OR ANOTHER LOCAL OFFICE BEFORE WORK CAN BEGIN.

Applicant: Leigh Dukatt

Address: 17800 Bowie Mill Road, Derwood

This HAWP approval is subject to the general condition that the applicant will obtain all other applicable Montgomery County or local government agency permits. After the issuance of these permits, the applicant must contact this Historic Preservation Office if any changes to the approved plan are made. Once work is complete the applicant will contact Michael Kyne at 301.563.3403 or <a href="michael.kyne@montgomeryplanning.org">michael.kyne@montgomeryplanning.org</a> to schedule a follow-up site visit.





# **APPLICATION FOR** HISTORIC AREA WORK PERMIT HISTORIC PRESERVATION COMMISSION

301.563.3400

<b>APPLICANT</b>	AP	PL	.IC	ΑI	V		
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APPLICANT:	
Name: Leigh Dukatt (T-Mobile)	LDukatt@advantageengineers.com E-mail:
Address: 7151 Columbia Gateway Dr Ste A	E-mail: LDukatt@advantageengineers.com  City: Columbia Zip: 21046
Daytime Phone: 602-692-9996	Tax Account No.: 00706980
AGENT/CONTACT (if applicable):	
Name:	E-mail:
Address:	City: Zip:
Daytime Phone:	Contractor Registration No.:
LOCATION OF BUILDING/PREMISE: MIHP# o	of Historic Property 22/017-000A
Is the Property Located within an Historic Distri	APPROVED
REVIEWED and documentation from By Michael Kyne at 3:12 pm, Feb 18, 2 Are other Planning and/or Hearing Examiner A (Conditional Use, Variance, Record Plat, etc.?) I supplemental information.	pprovals, f YES, inc AMML II. MMM
Building Number: 17800 Stree	Bow
	rest Cross Street: Fraley Farm Rd
Lot: Block: Subc	livision: Parcel:
for proposed work are submitted with this be accepted for review. Check all that apply:  New Construction Deck/Por Addition Fence Demolition Hardscap Grading/Excavation Roof  I hereby certify that I have the authority to male	
	this to be a condition for the issuance of this permit.

127530/231

# Adjacent and Confronting Properties:

Rockville, MD 20855

17834 Fraley Farm Road

5612 Silver Oak Court

17821 Fraley Farm Road

17813 Fraley Farm Road

5617 Silo Hill Court

5612 Silo Hill Court

17801 Fraley Farm Road

17805 Bowie Mill Road

17801 Bowie Mill Road

17709 Bowie Mill Road

17705 Bowie Mill Road

18405 Muncaster Road

# **REVIEWED**

By Michael Kyne at 3:12 pm, Feb 18, 2022

**APPROVED** 

Montgomery County

Rame h. M.

**Historic Preservation Commission** 

Description of Property: Please describe the building and surrounding environment. Include information on significant structures,
landscape features, or other significant features of the property:
Silo on a farm with various buildings & structures

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Description of Work Proposed: Please give an overview of the work to be undertaken:

Remove (3) & add (3) antennas, add (9) RRUs, remove (1) & add (1) equipment cabinet and (1) battery cabinet, and other associated equipment at existing silo

**REVIEWED** 

By Michael Kyne at 3:12 pm, Feb 18, 2022

**APPROVED** 

**Montgomery County** 

**Historic Preservation Commission** 

Ramth./M

Work Item 1: Telecommunications	
Description of Current Condition: Existing Site for T-Mobile	Proposed Work: Proposed equipment upgrades at existing site for T-Mobile
Work Item 2:	
REVIEWED  By Michael Kyne at 3:12 pm, Feb 18, 20.	APPROVED  Montgomery County  Historic Preservation Commission
Work Item 3:	
Description of Current Condition:	Proposed Work:
	7

# HISTORIC AREA WORK PERMIT CHECKLIST OF APPLICATION REQUIREMENTS

	Required Attachments						
Proposed Work	I. Written Description	2. Site Plan	3. Plans/ Elevations	4. Material Specifications	5. Photographs	6. Tree Survey	7. Property Owner Addresses
New Construction	*	*	*	*	*	*	*
Additions/ Alterations	*	*	*	*	*	*	*
Demolition	*	*	*		*		*
Deck/Porch	*	*	*	*	*	*	*
Fence/Wall	*	*	*	*	*	*	*
Driveway/ Parking Area	*	*		*	*	*	*
Grading/Exc avation/Land scaing	*	*		*	*	*	*
Tree Removal	*	*		*	*	*	*
Siding/Roof Changes	*	*	*	*	*		*
Window/ Door Changes	*	*	*	*	*		*
Masonry Repair/ Repoint	*	*	*	*	*		*
Signs	*	*	*	*	*		*

**REVIEWED** 

By Michael Kyne at 3:12 pm, Feb 18, 2022

APPROVED

**Montgomery County** 

**Historic Preservation Commission** 

Rameta Man

By Michael Kyne at 3:13 pm, Feb 18, 2022


# T-MOBILE NORTHEAST LLC

FRALEY FAMILY - ROCKVILLE 7WAN162B 67D5A997DB HYBRID

17800 BOWIE MILL ROAD DERWOOD, MARYLAND 28055

# SITE INFORMATION SITE NUMBER SITE NUMBER SITE NUMBER SITE ADRESS. TYANH'GS FRALEY FAMILY - ROCKVILLE FRALEY FAMILY - ROCKVILLE TYOS BOYNE BLL ROAD DERWOOD, MAYLAND 28055 RE-1 TAX.MAP. HTZPP22 JURISDICTION: MONTGOMERY COUNTY, MARYLAND SITE COORDINATES: OROUND ELEVATION SITE COURD STANCY STRUCTURE PYE SLO STRUCTURE PYE SLO STRUCTURE PYE SLO TYP 67'S AGL TOP OF EXSTING SILO) TYP 67'S AGL TEMANT: TEMANT: TEMANT: TEMANT: TEMANT: TEMANT: THANDER STRUCTURE MONTER AT LIC THANDER MONTER AVENUE BELTSVILLE MANYLAND 27055 HARRY FRALEY ET AL. OWNER'S NAME OWNER'S ADDRESS: 1780 FRALEY ET AL. 1787 FRALEY ET AL. 1

CODE ANALYSIS				
BUILDING CODE:	IBC 2018			
ELECTRICAL CODE:	NFPA 70, NEC 2014			
FIRE CODE:	2015 NFPA 101			
USE GROUP:	U (UTILITY)			
CONSTRUCTION TYPE:	IIB			

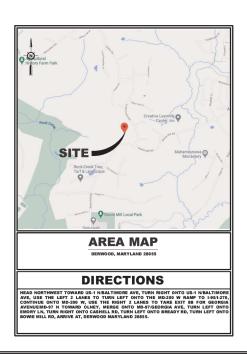

# APPROVED Montgomery County

Historic Preservation Commission

Ramkh Mann

advantage engineers
7151 COLUMBIA GATEWAY DRIVE SUITE A

### SCOPE OF WORK

- REMOVE EXISTING RF FRIENDLY CANISTER
- INSTALL (1) NEW RF FRIENDLY CANISTER REMOVE (3) EXISTING ANTENNAS
- REMOVE (3) EXISTING TIMAS
- REMOVE (12) 1-1/4" COAX
- INSTALL (3) PROPOSED ANTENNAS
   INSTALL (9) PROPOSED RRUS
- REMOVE (1) EXISTING 2106 EQUIPMENT CABINET
- INSTALL (1) PROPOSED 6160 EQUIPMENT CABINE
- INSTALL (1) PROPOSED 8160 BATTERY CABINET
- INSTALL (6) PROPOSED 6x24 HYBRID CABLES 30M
- INSTALL (1) PSU 4813

	SHEET INDEX		
DRAWING SHEET	DRAWING TITLE		
T-1	TITLE SHEET		
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S-2	SILO ELEVATION		
A-1	ANTENNA PLAN & NOTES		
A-2	PLUMBING DIAGRAM & CABLES		
A-3	PROPOSED & EXISTING EQUIPMENT CABINET LAYOUT		
A-4	DETAILS		
D-1	6160 EQUIPMENT CABINET DETAIL		
D-2	B160 BATTERY CABINET DETAIL		
G-1	GROUNDING DIAGRAM & DETAILS		
E-1	ELECTRICAL DETAILS		
E-2	ELECTRICAL NOTES		

### DO NOT SCALE DRAWINGS

CONTRACTOR IS TO VERIFY ALL PLANS, EXISTING DIMENSIONS & CONDITIONS RELATING TO THIS PROJECT. CONTRACTOR SHALL IMMEDIATELY NOTIFY THE ENGINEER IF THERE ARE ANY DISCREPANCIES PRIOR TO CONSTRUCTION.

APPROVA	LS
T-MOBILE PROJECT MANAGER	DATE:
T-MOBILE RF ENGINEER	DATE:
LANDLORD	DATE:



DRAWN BY:	EDZ
CHECKED BY:	MRL
SCALE:	NOTED
100 110	19E0047 001


### **TITLE SHEET**

# **T** 4

FRALEY FAMILY - ROCKVILLE 7WAN162B 17800 BOWIE MILL ROAD DERWOOD, MARYLAND 28055



PROFESSIONAL CERTIFICATION. I HEREBY CERTIFY THAT THESE DOCUMENTS WERE CERTIFY THAT THESE DOCUMENTS WERE AM A DULY LICENSED PROFESSIONAL ENGINEER UNDER THE LAWS OF THE STATE OF MARYLAND, LICENSE NO. 41497, EXPIRATION DATE: 0-10-52-4"

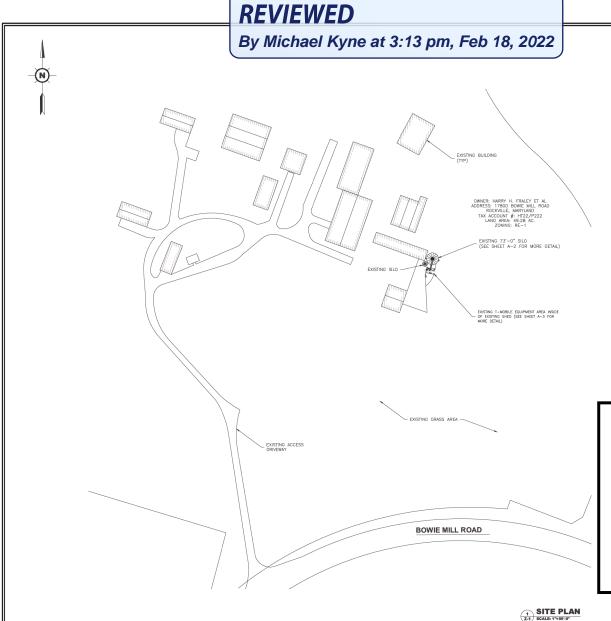

### SITE INFORMATION

SITE NUMBER: SITE NAME: FRALEY FAMILY - ROCKVILLE SITE ADDRESS: 17800 BOWIE MILL ROAD DERWOOD, MARYLAND 28055

ZONING DISTRICT RE-1 TAX MAP: HT22/P222 JURISDICTION: MONTGOMERY COUNTY. MARYLAND

SITE COORDINATES: N 39° 09' 0.49" (NAD 83) W 77° 06' 51.55" (NAD 83) GROUND ELEVATION: 496'± (NAVD 88) STRUCTURE TYPE:

STRUCTURE HEIGHT: 73'± AGL (TOP OF EXISTING SILO) ANTENNA RAD CENTER 79'-6"+ AGL T-MOBILE NORTHEAST LLC 12050 BALTIMORE AVENUE BELTSVILLE, MARYLAND 207

OWNER'S NAME: HARRY FRALEY ET AL OWNER'S ADDRESS: 17800 BOWIE MILL ROAD ROCKVILLE, MARYLAND 20855-1609



SCHEDULE OF REVISIONS

ZONING COMMENTS ISSUED FOR CONSTRUCTION

19E0047.001

SITE PLAN

2 01-07-2022 NEW CANISTER DESIGN

CHECKED BY:

JOB NO:

- PROPERTY LINE INFORMATION WAS PREPARED USING AVAILABLE SITE PLANS, DEEDS, TAX MAPS, AND PLANS OF RECORD. INFORMATION SHOWN SHOULD NOT BE CONSTRUED AS AN ACCURATE BOUNDARY SURVEY.
- THE PROPOSED FACILITY WILL CAUSE NO INCREASE IN STORMWATER RUNOFF. THEREFORE, NO DRAINAGE STRUCTURES ARE PROPOSED.

- THE PROPOSED DEVELOPMENT DOES NOT INCLUDE STREET SIGNS OF ANY TYPE, NO SIGNS WILL BE POSTED EXCEPT THOSE REQUIRED.
- 8. THE PROPOSED DEVELOPMENT DOES NOT INCLUDE OUTDOOR STORAGE OR ANY SOLID WASTE RECEPTACLES.

### **GENERAL NOTES:**

- THIS PLAN WAS PREPARED WITHOUT THE BENEFIT OF A TITLE REPORT AND IS SUBJECT TO ALL EASEMENTS AND RESTRICTIONS OF RECORD.
- 4 THE FACILITY IS UNMANNED AND NOT FOR HUMAN HABITATION. (THERE IS NO HANDICAP ACCESS REQUIRED).
- 5. THE FACILITY IS UNMANNED AND DOES NOT REQUIRE POTABLE WATER OR SANITARY SERVICE.
- 6. ELEVATIONS REFER TO THE NORTH AMERICAN VERTICAL DATUM OF 1988 (NAVD

# **APPROVED**

**Montgomery County Historic Preservation Commission** 


**Z-1** 


FRALEY FAMILY - ROCKVILLE 7WAN162B 17800 BOWIE MILL ROAD DERWOOD, MARYLAND 28055

SHEET NO. 2 OF 13



GRAPHIC SCALE (SCALE BASED ON FULL SIZE 24"x36" SHEETS ONLY) (DO NOT USE SCALE ON OTHER SIZED DRAWINGS)

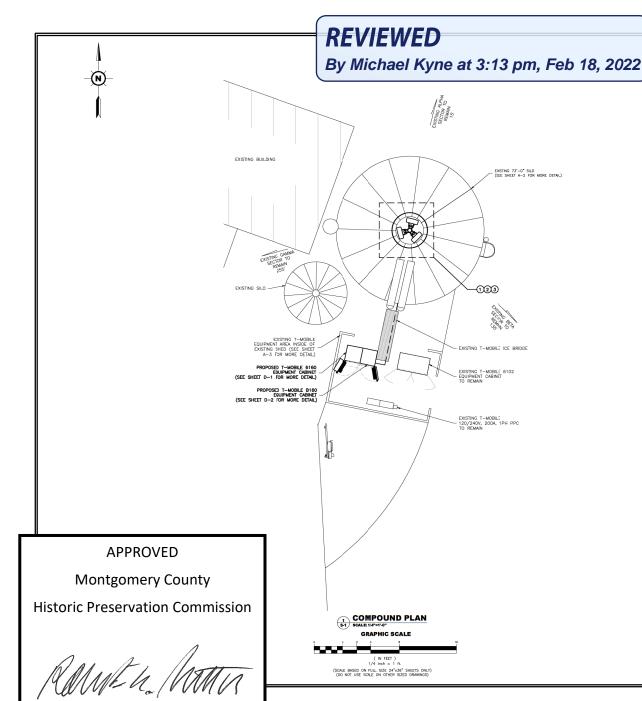

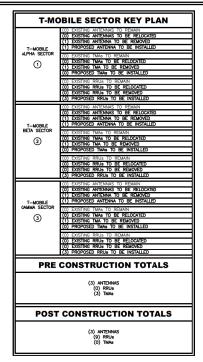

### **GENERAL NOTES**

- THE CONTRACTOR SHALL COMPLY WITH ALL APPLICABLE CODES, ORDINANCES, LAWS AND REQULATIONS OF ALL MUNICIPALITIES, UTILITIES COMPANY OR OTHER FUBLIC AUTHORITIES.
- THE CONTRACTOR SHALL BE RESPONSIBLE FOR OBTAINING ALL PERMITS AND INSPECTIONS THAT MAY BE REQUIRED BY ANY FEDERAL, STATE, COUNTY OR NUNICIPAL AUTHORITIES.
- 3. THE CONTRACTOR SHALL NOTIFY THE CONSTRUCTION MANAGER, IN WRITING, OF INY CONFLICTS, ERRORS OR OMISSIONS PRIOR TO THE SUBMISSION OF BIDS OR PERFORMANCE OF MORK, MINOR OMISSIONS OR ERRORS IN THE BID LOCUMENTS SHALL NOT RELEVE THE CONTRACTOR FROM RESPONSIBILITY FOR THE OMERAL INTERN OF THESE DRAWINGS.
- 4. THE CONTRACTOR SHALL BE RESPONSIBLE FOR PROTECTING ALL EXISTING SITE IMPROVEMENTS PRIOR TO COMMENCING CONSTRUCTION. THE CONTRACTOR SHALL FEPAIR ANY DAMAGE CAUSED AS A RESULT OF CONSTRUCTION OF THIS FACILITY.
- THE SCOPE OF WORK FOR THIS PROJECT SHALL INCLUDE PROVIDING ALL MATERIALS, EQUIPMENT AND LABOR REQUIRED TO COMPLETE THIS PROJECT, ALL EQUIPMENT SHALL BE INSTALLED IN ACCORDANCE WITH THE MANUFACTURER'S FECOMMENDATIONS.
- THE CONTRACTOR SHALL VISIT THE PROJECT SITE PRIOR TO SUBMITTING A BID TO VERIFY THAT THE PROJECT CAN BE CONSTRUCTED IN ACCORDANCE WITH THE CONTRACT DOCUMENTS.
- THE FACILITY IS UNMANNED AND NOT FOR HUMAN HABITATION. (THERE IS NO HANDICAP ACCESS REQUIRED).
- THE FACILITY IS UNMANNED AND DOES NOT REQUIRE POTABLE WATER OR SANITARY SERVICE.
- THE PROPOSED DEVELOPMENT DOES NOT INCLUDE OUTDOOR STORAGE OR ANY SOLID WASTE RECEPTACLES.
- THE PROPOSED DEVELOPMENT DOES NOT INCLUDE STREET SIGNS OF ANY TYPE, NO SIGNS WILL BE POSTED EXCEPT THOSE REQUIRED.
- 11. NO SIGNIFICANT NOISE, SMOKE, DUST OR ODOR WILL RESULT FROM THIS FACILITY.
- 12. ELEVATIONS REFER TO THE NORTH AMERICAN VERTICAL DATUM OF 1988 (NAVD
- CONSTRUCTION TO COMMENCE UPON COMPLETION OF A PASSING STRUCTURAL ANALYSIS. STRUCTURAL ANALYSIS TO BE PERFORMED BY ADVANTAGE ENGINEERS



REV. NO.	DATE	DESCRIPTION OF CHANGES
0	11-05-2021	ISSUED FOR CONSTRUCTION
1	11-17-2021	ZONING COMMENTS
2	01-07-2022	NEW CANISTER DESIGN
3		
4		
85		
	SCI	EDULE OF REVISIONS

NO. DATE	DESCRIPTION OF CHANGES
DRAWN BY:	EDZ
CHECKED BY	f: MRL
SCALE:	NOTED
JOB NO:	19E0047.001
DRAWING TI	TLE:

### **COMPOUND PLAN**


DRAWING SHEET:

**S-1** 

RALEY FAMILY - ROCKVILLE 7WAN162B 17800 BOWIE MILL ROAD DERWOOD, MARYLAND 28055



By Michael Kyne at 3:13 pm, Feb 18, 2022

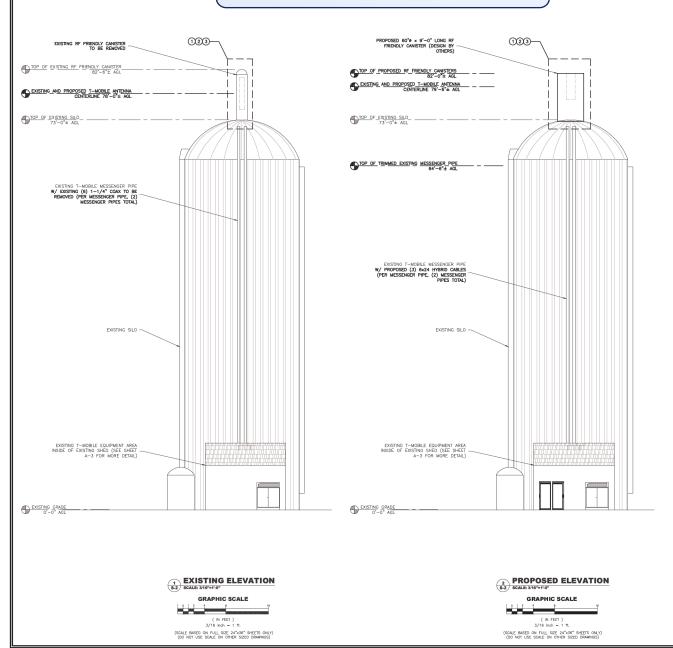

T-MOBILE SECTOR KEY PLAN

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### GENERAL NOTES

- THE CONTRACTOR SHALL COMPLY WITH ALL APPLICABLE CODES, ORDINANCES, LAWS AND REGULATIONS OF ALL MUNICIPALITIES, UTILITIES COMPANY OR OTHER PUBLIC AUTHORITIES.
- THE CONTRACTOR SHALL BE RESPONSIBLE FOR OBTAINING ALL PERMITS AND INSPECTIONS THAT MAY BE REQUIRED BY ANY FEDERAL, STATE, COUNTY OR MUNICIPAL AUTHORITIES.
- 3. THE CONTRACTOR SHALL NOTIFY THE CONSTRUCTION MANAGER, IN WRITING, OF ANY CONFLICTS, ERRORS OR OMISSONS OF PRIOR TO THE SUBMISSON OF BIDS OR PERFORMANCE OF WORK, MINOR OMISSONS OR ERRORS IN THE BID DOCUMENTS SHALL NOT RELEVE THE CONTRACTOR FROM RESPONSIBILIT FOR THE OVERALL INTERN OF THESE DRAWING.
- 4. THE CONTRACTOR SHALL BE RESPONSIBLE FOR PROTECTING ALL EXISTING SITE IMPROVEMENTS PRIOR TO COMMENCING CONSTRUCTION. THE CONTRACTOR SHALL REPAIR ANY DAMAGE CAUSED AS A RESULT OF CONSTRUCTION OF THIS FACILITY.
- THE SCOPE OF WORK FOR THIS PROJECT SHALL INCLUDE PROVIDING ALL MATERIALS, EQUIPMENT AND LABOR REQUIRED TO COMPLETE THIS PROJEC ALL EQUIPMENT SHALL BE METALLED IN ASSOCIATION TO THE PROJECT MANUFACTURER'S RECOMME.
- 6. THE CONTRACTOR SHALL VI BID TO VERIFY THAT THE P WITH THE CONTRACT DOCUM
- THE FACILITY IS UNMANNED HANDICAP ACCESS REQUIRE
- B. THE FACILITY IS UNMANN
- 9. THE PROPOSED DEVELOP
- 10 THE BRODOSED DEVELOR
- 11. NO SIGNIFICANT NOISE, FACILITY.
- 12. ELEVATIONS REFER TO TH (NAVD 88).
- CONSTRUCTION TO CO STRUCTURAL ANALYSIS.





DEADWING TITLE:

SILO ELEVATION

DRAWING SHEET:

**S-2** 

FRALEY FAMILY - ROCKVILLE 7WAN162B 17800 BOWIE MILL ROAD DERWOOD, MARYLAND 28055


# **APPROVED**

**Montgomery County** 

**Historic Preservation Commission** 

Rameh Mann

By Michael Kyne at 3:13 pm, Feb 18, 2022

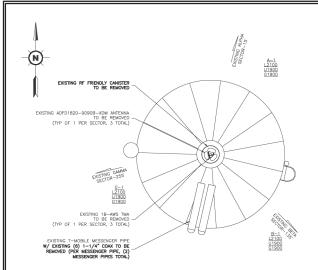



### STRUCTURAL NOTES

- DESIGN REQUIREMENTS PER INTERNATIONAL BUILDING CODE 2015 AND THE ANSI/TIA-222-G STRUCTURAL STANDARDS FOR STEEL ANTENNA TOWERS AND ANTENNA
- SUPPORTING STRUCTURES.

  WHORMATION SHOWN ON THESE DEMANINGS WAS DISTANCE BY FIELD MESSUREMENT AND FROM THE EXISTING STRUCTURAL DEAWNINGS. THE GENERAL CONTRACTOR PROBABILITY ALL EXISTING CONDITIONS AND NOTEY THE ARCHITECT/EXGINEER OF ANY DECKREANCES PRIOR TO ORDERING MARERIALS OR PROCEEDING WITH PROPERTY ALL EXISTING CONDITIONS AND NOTEY THE ARCHITECT/EXGINEER OF ANY DECKREANCES PRIOR TO ORDERING MARERIALS OR PROCEEDING WITH PROPERTY OF THE STRUCTURE STREET OF THE CONDITION OF THE ARCHITECT/EXISTING FOR STRUCTURAL STEEL BUILDINGS ALLOWABLE STRESS DESIGN AND FLASTED CESSION INCLUDING THE COMMENTARY AND THE AISC CODE FOR STANDARD PRACTICE.

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  UNDER'NS. THE CONTRACTOR SHALL FURNISH ALL CONNECTION HARDWARE FOURTH OF SECURE THE CABLES. CONNECTION HARDWARE SHALL BE STANLESS STELL
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  CUTURAL STELL FRAMING SHALL CONFORM TO ASTM AASS. PASTEMESS SHALL BE 5/8" MM. DIAMETER BERRING TYPE COMMETTED WITH THREAD RELIGIOUS WITH THREAD STRUMBS. OTHERWISE AND CONFORM TO ASTM AASS. ASTRIBUTED AND CONFORM TO ASTMIT ASTRIBUTED AND CONFORM TO ASTMIT ASTRIBUTED. CONFORM TO ASTMIT ASSMITTED AND CONFORM TO ASTMIT ASSMITTED AND CONFORM TO ASTMIT ASSMITTED AND CONFORM TO ASSMITT ASSMITTED AND CONFORM TO ASSMITT ASSMITTED AND CONFORM TO ASSMITT ASSMITTED.

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# PROPOSED FFV4-65A-R3V1 ANTENNA AND PROPOSED (3) RRUS BELOW (TYP PER SECTOR, 3 SECTORS TOTAL) (SEE DETAIL 1/A-4) PROPOSED 60"# X 9'-0" LONG RF FRIENDLY CANISTER (DESIGN BY OTHERS) N600, L600, L700, L1900, G1900, U1900, L2100, L2500, N2500 W/ PROPOSED (3) 6x24 HYBRID CABLES (PER MESSENGER PIPE, (2) MESSENGER

PROPOSED ANTENNA PLAN

### **GENERAL CONTRACTOR NOTES**

- IMMEDIATELY.
  CONTRACTOR IS TO VERIFY ALL ANTENNA AZIMUTHS WITH THE T-MOBILE CONSTRUCTION MANAGER PRIOR TO CONSTRUCTION.



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5		
4		
3		
2	01-07-2022	NEW CANISTER DESIGN
1	11-17-2021	ZONING COMMENTS
0	11-05-2021	ISSUED FOR CONSTRUCTION
REV. NO.	DATE	DESCRIPTION OF CHANGES

NO. DATE	DESCRIPTION OF CHANGES
DRAWN BY:	EDZ
CHECKED BY	f: MRL
SCALE:	NOTED
JOB NO:	19E0047.001

**ANTENNA PLAN** & NOTES



RALEY FAMILY - ROCKVILLE 7WAN162B 17800 BOWIE MILL ROAD DERWOOD, MARYLAND 28055

SHEET NO. 5 OF 13



# PROPOSED ANTENNA SCHEDULE

POSITION	ANTENNA RAD CENTER	EXISTING AZIMUTH	EXISTING TECH	ANTENNA MANUFACTURER	EXISTING ANTENNA MODEL #	EXISTING RRU/TMA	EXISTING RRU/TMA	EXISTING MDT	EXISTING EDT
A-1	78'-0"	1"	L2100,U1900, G1900	ANDREW	ADFD1820-9090B-XDM	1B-AWS	N/A	0.	3/3
B-1	78'-0"	1"	L2100,U1900, G1900	ANDREW	ADFD1820-9090B-XDM	1B-AWS	N/A	0.	5/5
G-1	78'-0"	1"	L2100,U1900, G1900	ANDREW	ADFD1820-9090B-XDM	1B-AWS	N/A	0,	5/5

**EXISTING ANTENNA SCHEDULE** 


**APPROVED** Montgomery County **Historic Preservation Commission** 


Rame h. Mu

	POSITION	ANTENNA RAD	PROPOSED	PROPOSED	ANTENNA	PROPOSED ANTENNA	PROPOSED	PROPOSED		
Ш	1 03,11014	CENTER	AZIMUTH	TECH	MANUFACTURER	MODEL #	RRU/TMA	RRU/TMA	MDT	EDT
	A-1	79'-6"	15'	N600, L600, L700, L1900, G1900, U1900, L2100,	COMMSCOPE	FFV4-65A-R3V1	4480 B71+B85 8863		0.	3/3/3/3
Ш				L2500, N2500			B41	N/A		2/2
	B-1	79'-6"	135	N600, L600, L700, L1900, G1900, U1900, L2100, L2500, N2500	COMMSCOPE	FFV4-65A-R3V1	4480 B71+B85 8863 B41	4460 B25+B66 N/A	o.	3/3/3/3
	G-1	79'-6"	255'	N600, L600, L700, L1900, G1900, U1900, L2100, L2500, N2500	COMMSCOPE	FFV4-65A-R3V1	4480 <u>B71+B85</u> 8863 B41	4460 B25+B66 N/A	0.	3/3/3/3

# ANTENNA/RRU/TMA SPECS

EXISTING ANTENNAS	MANUFACTURER	ANTENNA MODEL #	QUANTITI	neigni	WIDIH	DEFIN	WEIGHT
	ANDREW	ADFD1820-9090B-XDM TO BE REMOVED	3	51.7*	12.1"	4.5"	22.05 LBS
FINAL PROPOSED	MANUFACTURER	ANTENNA MODEL #	QUANTITY	HEIGHT	WIDTH	DEPTH	WEIGHT
ANTENNA CONFIGURATION	COMMSCOPE	FFV4-65A-R3V1	3	48.2"	25.2"	9.3*	79.4 LBS
FXISTING	MANUFACTURER	TMA MODEL #	QUANTITY	HEIGHT	WIDTH	DEPTH	WEIGHT
TMAs	GENERIC	TWIN STYLE 1B-AWS TO BE REMOVED	3	10.04"	9.29"	4.84"	22.5 LBS
	MANUFACTURER	RRU MODEL #	QUANTITY	HEIGHT	WIDTH	DEPTH	WEIGHT
FINAL PROPOSED	ERICSSON	4480 B71+B85	3	21.8"	15.7"	7.5*	84 LBS
RRU CONFIGURATION	ERICSSON	4460 B25+B66	3	19.6"	15.7*	12.1"	109 LBS
	ERICSSON	8863 B41	3	18.82"	14.76*	5.71	49.8 LBS

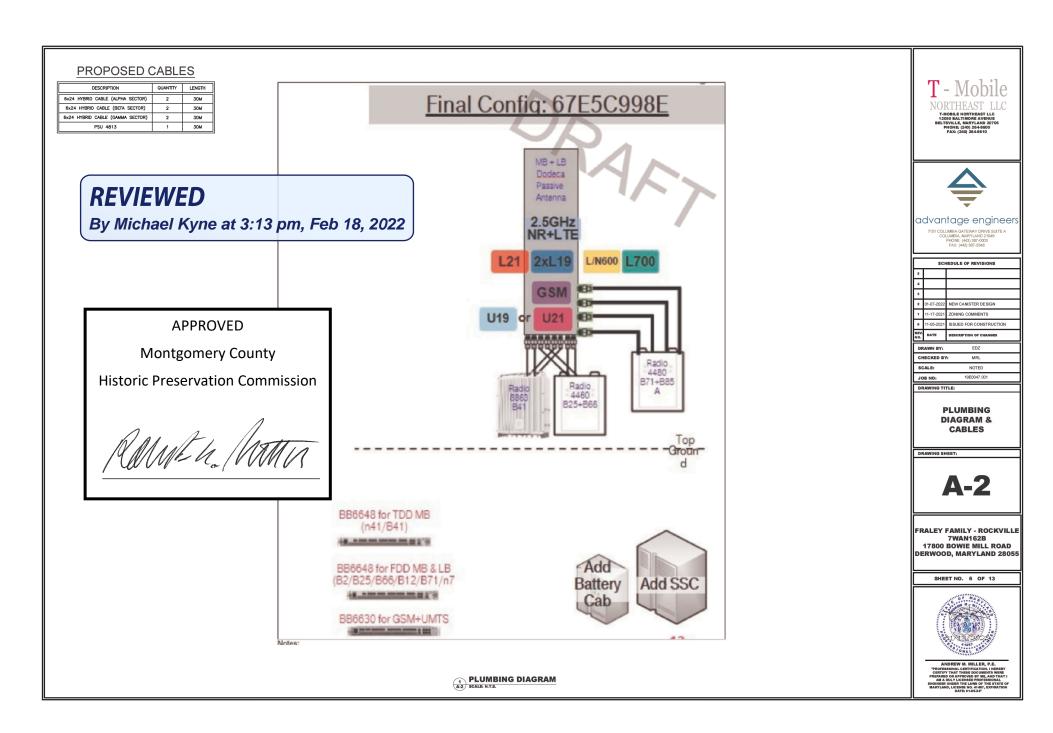

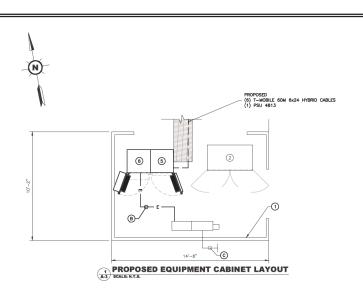

1	-MOBILE CABINET PLAN KEY	
IDENTIFIER	CABINET AND STATUS	DETAIL
1	EXISTING 14'-0"x10'-2" EQUIPMENT AREA TO REMAIN	N/A
2	EXISTING 6102 EQUIPMENT CABINET TO REMAIN	N/A
(3)	EXISTING 120/240V, 200A, 1PH PPC TO REMAIN	N/A
4	EXISTING RBS 2106 EQUIPMENT CABINET TO BE REMOVED	N/A
(5)	PROPOSED B160 BATTERY CABINET TO BE INSTALLED	D-2
6	PROPOSED 6160 EQUIPMENT CABINET TO BE INSTALLED	D-1

CABINET	INSTALL	ATION	NOTES
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- SEE SHEET D-1 FOR 6160 EQUIPMENT CABINET SPECIFICATIONS AND ERICSSON SUGGESTED INSTALLATION INSTRUCTIONS.
- SEE SHEET D-2 FOR B160 BATTERY CABINET SPECIFICATIONS AND ERICSSON SUGGESTED INSTALLATION INSTRUCTIONS.





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REV. NO.	DATE	DESCRIPTION OF CHANGES

NO. DATE	DESCRIPTION OF CHANGES
DRAWN BY:	EDZ
CHECKED BY	f: MRL
SCALE:	NOTED
JOB NO:	19E0047.001

PROPOSED &
EXISTING
EQUIPMENT
CABINET LAYOUT

DRAWING SHEET:



FRALEY FAMILY - ROCKVILLE 7WAN162B 17800 BOWIE MILL ROAD DERWOOD, MARYLAND 28055

SHEET NO. 7 OF 13



PROFESSIONAL CERTIFICATION. I HEREI CERTIFY THAT THESE DOCUMENTS WER FREPARED OR APPROVED BY ME, AND THA AM A DULY LICENSED PROFESSIONAL MICHEER UNDER THE LAWS OF THE STATI MARYLAND, LICENSE NO. 41407, EXPIRATI DATE: 91-95-24"

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EXISTING EQUIPMENT CABINET LAYOUT


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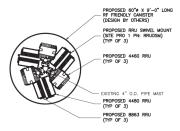
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Historic Preservation Commission

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FFV4-65A-R3-V1 ANTENNA

AND RRU MOUNTING DETAIL

A4 SCALE NOT TO SCALE

# **REVIEWED**

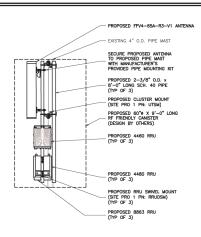By Michael Kyne at 3:13 pm, Feb 18, 2022

APPROVED

Montgomery County

**Historic Preservation Commission** 







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DETAILS




FRALEY FAMILY - ROCKVILLE 7WAN162B 17800 BOWIE MILL ROAD DERWOOD, MARYLAND 28055


SHEET NO. 8 OF 13




"PROFESSIONAL CERTIFICATION. I HEREBY CERTIFY THAT THESE DOCUMENTS WERE PREPARED OR APPROVED BY ME, AND THAT AM A DULY LICENSED PROFESSIONAL ENGINEER UNDER THE LAWS OF THE STATE C MARYLAND, LICENSE NO. 41497, EXPIRATION DATE: 0.45247

By Michael Kyne at 3:13 pm, Feb 18, 2022

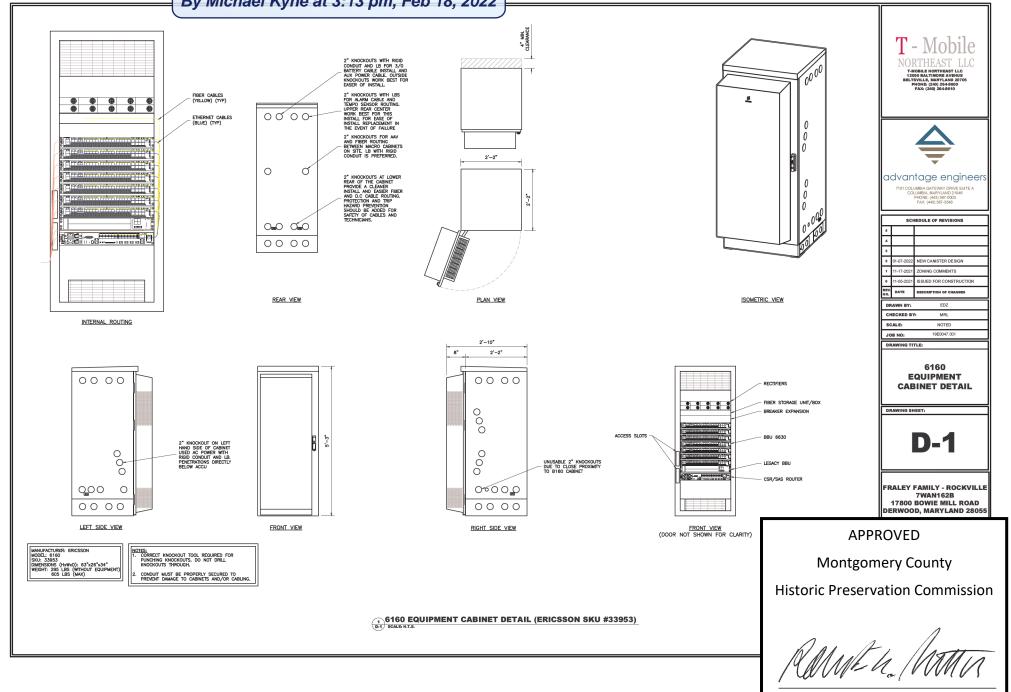

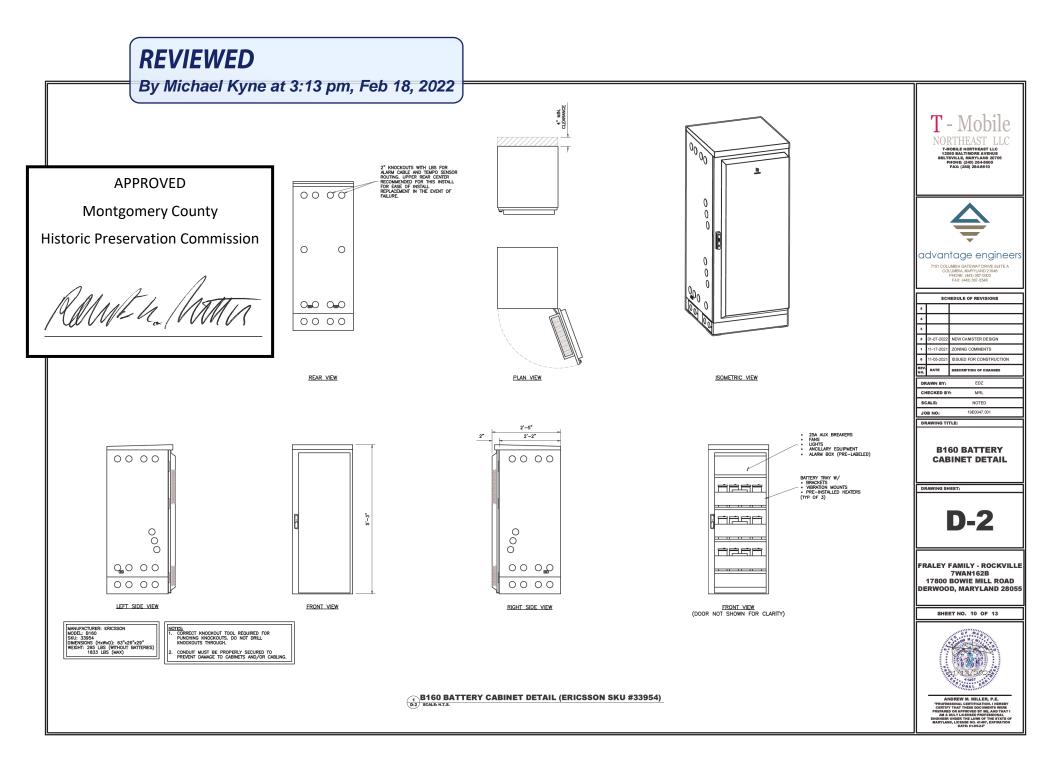

By Michael Kyne at 3:13 pm, Feb 18, 2022

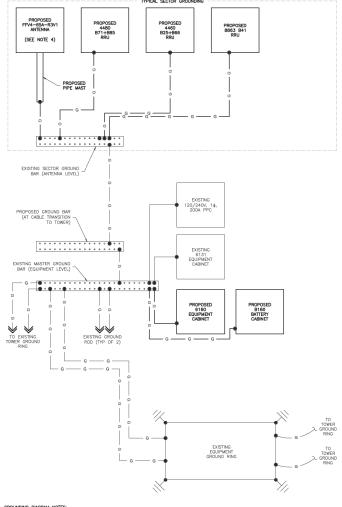

### GROUNDING DIAGRAM NOTES:

- EQUIPMENT SHOWN DIAGRAMMATICALLY, REFER TO LAYOUT PLANS FOR EXACT EQUIPMENT LOCATION.
- 2. NO EXOTHERMIC WELDS (CADWELD) ALLOWED AT ANTENNA LEVEL.
- GROUND CABLES SHALL BE #2 AWG, GREEN, TINNED, SOLID COPPER CONDUCTORS UNLESS OTHERWISE NOTED.

# GROUNDING DIAGRAM G-1 SCALE: N.T.S.


- ALL GROUNDING SYSTEM CONDUCTORS AND CONNECTIONS BELOW GRADE SHALL BE THERMAL WELDS AT GROUND RODS AND AT A MINIMUM OF 36" BELOW GRADE.
- 2. ALL INSTALLATIONS SHALL BE FIELD VERIFIED.
- ALL GROUND WIRE SHALL BE #2 AWG BARE COPPER TINNED UNLESS NOTED
- THE CONTRACTOR SHALL COORDINATE INSTALLATION OF GROUND RODS AND GROUND RING WITH FOUNDATION AND UNDERGROUND CONDUIT.
- ANTENNA GROUND KITS SHALL BE FURNISHED BY SPRINT AND INSTALLED BY ELECTRICAL CONTRACTOR.

- PLASTIC CLIPS OR METAL CLIPS WHICH DO NOT COMPLETELY SURROUND THE GROUNDING CONDUCTORS SHALL BE USED TO FASTEN AND SUPPORT GROUNDING CONDUCTORS, FERROUS METAL CLIPS WHICH COMPLETELY SURROUND THE GROUNDING CONDUCTOR SHALL NOT BE USED.

### **GROUNDING NOTES:**

- KOPR-SHIELD ANTI-OXIDATION COMPOUND SHALL BE USED ON ALL GROUNDING CONNECTIONS.

- GROUNDING WIRE SHALL NOT BE INSTALLED OR ROUTED THROUGH HOLES IN ANY METAL OBJECTS OR SUPPORTS TO PRECLUDE ESTABLISHING A "CHOKE"

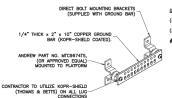

GROUND BAR DETAIL

(4) MECHANICAL CONNECTION #2 AWG BCW TO EQUIPMENT CABINETS (2) TWO HOLE LUG TO BE USED WITH #2 AWG BCW TO GROUND RING #6 AWG FROM ANTENNA CABLE GROUND KITS.



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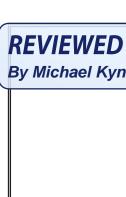
**GROUNDING** 

**DIAGRAM & DETAILS** 

**G-1** 

FRALEY FAMILY - ROCKVILLE 7WAN162B 17800 BOWIE MILL ROAD **DERWOOD, MARYLAND 28055** 





By Michael Kyne at 3:13 pm, Feb 18, 2022

EXISTING CONDUIT & CONDUCTORS TO REMAIN EXISTING 240V, 3W, 200A METER TO REMAIN (DOMINION #97 361 556) EXISTING 240V, 200A, 2 POLE ENCLOSED CIRCUIT BREAKER TO REMAIN FACTORY INSTALLED WIRING-PROPOSED (3) #1/0 & (1) #6 GND IN PROPOSED 1-1/2" CONDUIT (TO REPLACE-EXISTING CONDUIT AND CONDUCTORS) PROPOSED (3) #2 & (1) #6 GND IN PROPOSED 1-1/2" CONDUIT PROPOSED 2" TELCO CONDUIT
(FOR COMMUNICATIONS) PROPOSED 2" POWER CONDUIT (FOR DC POWER)

EXISTING COMMERCIAL SERVICE

- ALL ELECTRICAL WORK SHALL BE DONE IN ACCORDANCE WITH GURRENT DOOPTED NATIONAL ELECTRIC GODES AND ALL LOCAL L
- JUPPLIEDTS. AT BTS COUPPIENT ENDS PRIOR TO THE EQUIPMENT INSTALLATION SHALL BE STUBBED AND CAPPED AT PLATFORM. IF SERVICE LINES CAN'T BE INSTALLED INITIALLY, PROVIDE NYLON PULL CORD IN CONDUITS.

ELECTRICAL ONE LINE DIAGRAM

E-1 SCALE: N.T.S.

**APPROVED** 

**Montgomery County** 

**Historic Preservation Commission** 

120/240 VAC, 1PH, 200 AMP FEEDER IS EXISTING SERVICE: 120/240 VAC DESIGNATION: T-MOBILE PANEL Panel Circuit and Load Schedule LOCATION: T-MOBILE PLATFORM Load per phase (VA) Load 8200 8,200 PROPOSED 6160 THWN-2 10,000

BUX THWN-2 10,000


RED THWN-2 10,000 #1/O

BUX THWN-2 10,000 #1/O

RED THWN-2 10,000 #1/O

RED THWN-2 10,000 #1/O CABINET 0 200 SubTotal 8,200 8,200 10.250 10,250 Voltage: 120/240 Neutral: 200 Amps Main Breaker: 200 Amp Frame Main Lugs: 200 Amps Manufacturer: SQUARE D 0.53 Model Number Trip: 200 Amps

PANEL SCHEDULE
8-1 SCALE: N.T.S.

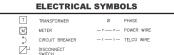





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### **ELECTRICAL DETAILS**



FRALEY FAMILY - ROCKVILLE 7WAN162B 17800 BOWIE MILL ROAD DERWOOD, MARYLAND 28055



### GENERAL ELECTRICAL NOTES & BASIC ELECTRICAL REQUIREMENTS

- ENERAL ELECTRICAL NOTES & BASIC ELECTRICAL REQUIREMENTS

  THE DRAWINGS ARE PROVIDED TO DEPICT DESIGN INTENT AND ARE NOT TO BE CONSIDERED MINISTRALING DAWNINGS. NOT ALL COMPONENTS OF CONNECTIONS ARE SHOWN. COURIEMENT AND RESIDNESS AND ALL CONTINUES AND ALL CONTINUES AND ALL CONTINUES AND ALL CONTINUES. THE CONTRACTOR SHALL BE RESPONSIBLE FOR DETERMINING PINAL CONDUIT STANDARDS. THE CONTRACTOR SHALL BE RESPONSIBLE FOR ALL RESIDANCIAN AND METHODS. THE CONTRACTOR SHALL BE RESPONSIBLE FOR ALL RESIDANCIAN COMPONENTS AND METHODS. THE CONTRACTOR SHALL BE RESPONSIBLE FOR ALL RESPONSIBLE FOR ALL RESIDANCIAN CONTRACTOR SHALL RESPONSIBLE FOR ALL RESPONSIBLE FOR ALL RESIDANCIAN CONTRACTOR SHALL RESPONSIBLE FOR ALL RESPONSIBLE FOR

- MATIONAL ELECTRICAL CODE AND OTHER APPLICABLE CODES.

  1 THE CONTINUEDOR SMALL BE RESPONDED FOR DETAINING ALL FERMITS AND INSPECTIONS

  1 THE CONTINUEDOR SMALL BE RESPONDED FOR DETAINING ALL FERMITS AND INSPECTIONS

  1. CONTINUEDOR SMALL BE RESPONDED ALL SMALL BE RESPONDED FOR THE PROPERTY OPERATIVE SYSTEM DEROZED THROUGHOUT AS INDICATED IN THE CONTINUEDOR SMALL BE RESPONDED THROUGHOUT AS INDICATED IN THE CONTINUED SYSTEM DEROZED THROUGHOUT AS INDICATED IN THE CONTINUED NO SMALL BE RESPONDED FOR PROTECTION ALL ESSING STEEL CONTINUED TO SMALL BE RESPONDED FOR PROTECTION ALL ESSING STEEL AND AND AND ASSOCIATION AND ASSOCIATION OF THE SPECIAL FEBRUARY AND DAMAGE CAUSED AS A RESULT OF CONSTRUCTION OF THIS FORLITY.

  12. THE CONTRACTOR SHALL BE RESPONDED FOR CLEMNING OF THE WORK STEEL AND THE CONTRACTOR SHALL BE RESPONDED FOR THE WORK STEEL AND THE CONTRACTOR SHALL BE RESPONDED FOR CLEMNING OF THE WORK STEEL AND ELECTRICATED AND ASSOCIATION OF THE WORK STEELED AND ASSOCIATION OF THE WORK STEELED AND ASSOCIATION OF THE WORK STALL BE CONTINUED AND ASSOCIATION OF THE WORK

- 24. ANY CODE VIOLATIONS DUE TO THE CONTRACTOR'S WORK SHALL BE CORRECTED AT THE

**REVIEWED** 

### ELECTRICAL SPECIFICATIONS: ELECTRICAL MATERIALS AND EQUIPMENT

- RIGO DALVANIZAD STELL (RSS), CONDUT SAUL JE USD FIRS OVERROR LOCATIONS ABVYGUENDAND UNESSENDENT PRODUCTION (ADMINISTRATION OF THE PROPERTY ON THE PROMINES, FOR UNDERGROUND RUNDS. RIGID CONDUT AND FITTINGS SHALL BE STELL COATED WITH ZINC EXTERIOR AND HERROR BY THE TOTO DE QUALWARKING PROCESS. CONDUT SHALL BE PRODUCED TO ANSI SPECIFICATIONS (OS. 1, FEDDRAL SPECIFICATION WHICE-SHAD SHAD SHALL BE STELL COATED WITH ZINC EXTERNAL OF THE PROPERTY OF THE SHAD SHALL BE POLYMATICHLORIDE SCHEDULE 40 (PWC). SCHEDULE 40 (P

- INSTRUCTIONS.

  ENT OR RIGO CALVANIZED STELL CONDUIT MAY BE USED IN FINISHED INTERIOR SPACES, CONCEASE IN WALLS AND CELLINGS. BUT SHALL BE MILD STEEL, ELECTRICALLY WELDED, LEICTRO-CALVANIZED OR HOT-PUPPE CALVANIZED AND PRODUCED TO ASIS SPECEPICATION ELECTRO-CALVANIZED OR HOT PUPPE CALVANIZED AND PRODUCED TO ASIS SPECEPICATION WELL SHALL CONFIDENCE OF A SISTEMATION OF THE CONTROL OF A SISTEMATION OF THE CONTROL OF THE CONTRO

- MINIMUM SIZE CONDUIT SHALL BE \$ INCH.

  MINIMUM SIZE CONDUIT SHALL SHALL SHALL SHALL SHOWN OR REQUIRED BY THE NEC.

  ALL CONDUITS SHALL BE MET WITH BENDS MINE IN ACCORPANCE WHITH KEC. NO RIGHT

  MINIMUM SIZE SHALL BE MET WITH BENDS MINE IN ACCORPANCE WITH KEC. NO RIGHT

  SWEEPS FOR ALL CONDUITS 2 INCH OF LARGE LESIONS WITH 12 INCH MINIMUM MISIDE

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  SWEEPS FOR ALL CONDUITS 2 INCH MINIMUM MINIM
- BUSHINGS. CONTRACTOR SHALL BE RESPONSIBLE FOR PROTECTING ALL CONDUITS DURING
- CONTRACTOR SHALL BE RESPONSIBLE FOR PROTECTING ALL COMOUNTS DURING CONSTRUCTION.

  TOMORY OF THE CONTRACTOR OF THE CONTRACTOR OF CONTRACTOR SHALL REPLACE ANY CONDUCT STATES AND THE CONTRACTOR SHALL REPLACE ANY COMOUNTS CONTRACTOR SHALL REPLACE ANY COMOUNTS CONTRACTOR SHALL REPLACE ANY COMOUNTS SHALL BE SWABBED CLEAN BY PULLING AN APPROPRIATELY SIZED MANDREL HEROUGH THE COMOUNT BEFORE INSTITUTION OF COMOUNTS OF THE CONTRACTOR SHALL BE FREE OF DIRT AND DEBRIS.

  BEFORE OF THE CONTRACTOR SHALL BE STATED THE CONTRACTOR SHALL BE FREE OF DIRT AND DEBRIS.

- 15. INSTALL PULL STRANGS IN ALL CLEAN EMPTY CONDUITS. IDENTIFY PULL STRANGS IN ALL CLEAN EMPTY CONDUITS. IDENTIFY PULL STRANGS IN ALL CLEAN EMPTY AND EXCEPTION OF THE PROPERTY AND CONDUCTORS, OF AS INDICATED ON THE DRAWNIGS.

  16. CONDUITS SHALL BE INSTALLED IN SUCH A MANNER AS TO DESIGHE AGAINST COLLECTION OF THE PROVIDE CORE DRILLING AS INCESSARY FOR PENETRATIONS TO ALLOW FOR RACEWAYS AND CABLES TO BE ROUTED THROUGH THE BULDING, DO NOT PENETRATE STRUCTURAL MAMBERS. SLEEYES AND/OR PENETRATIONS IN THE RATED CONSTRUCTION (MALLS AND FLOORS) SHALL OF THE WALL FLOOR OF STRUCTURE, FIRE STOPS AT FLOOR PENETRATIONS SHALL PREVENT AND SHALL FROM THE STRUCTURE PROPERTY OF THE WALL FLOOR OF STRUCTURE, FIRE STOPS AT FLOOR PENETRATIONS SHALL PREVENT AND SHALL BE OUT. APPROVED FOR THE STRUCTURE PROPERTY OF THE STRUCTURE PROPERT
- THIS PURPOSE. ON SHAPE, THE WAY CHIEF, ALL WALCHM, SHALL BE OLD. PREPOSED TO COOLUITS SHALL BE FASTEND SECURELY IN PLACE WITH APPROVED NON-PERFORATE STRAPS AND IMMERIES EXPLOSE EXPLISE FOR ATTACHING HARGERS TO STRUCTURE ARE PROMISELY TO THE STRUCTURE AND EXPLOSED AND EXPLOSED AND THE STRUCTURE AND THE STRUCTUR
- LOCKNUT ON OUTSIDE AND INSIDE.

  20. SPARE CONDUITS SHALL BE FURNISHED WITH PULL LINES AND CAPPED WITH FACTORY CAPS.

By Michael Kyne at 3:13 pm, Feb 18, 2022

- 1. CONDUCTORS AND CABLE SHALL BE FLAME-RETARDANT, MOISTURE AND HEAT RESISTANT THERMOPLASTIC, SINGLE CONDUCTOR, COPPER, TYPE THHN/THWN-2, 600 VOLT, OR TYPE XHHW, 600V OR XHHW-2, 600V. SIZE AS INDICATED. #12 AWG SHALL BE THE MINIMUM SIZE

- CONDUCTOR.

  #10 AME AND SMALLER CONDUCTORS SHALL BE SOLD AND #8 AWG AND LARGER CONDUCTORS SHALL BE STRANGED.

  ONDUCTORS SHALL BE STRANGED.

  OF THE CONDUCTORS SHALL BE STRANGED OF THE CONDUCTOR SHALL BE USED FOR TERMINATION OF ALL STRANGED CONDUCTORS.

  ALL CONDUCTORS SHALL BE TAGGED AT BOTH ENDS OF THE CONDUCTOR, AT ALL PULL BOXES, JUNCTORS BOXES, DUCTORS BOXES, BOXES BOXES, B
- BUALS, JUNCIUM BOXES, COUPMENT AND CABINETS AND SHALL BE DENTRIED WITH APPROVED PLASTIC TAGS.
  CONTRACTOR SHALL PROVIDE STRAIN-RELIEF AND CABLE SUPPORTS FOR ALL CABLE ASSEMBLES, COAX CABLES, NAME STRAIN-RELIEF & CABLE SUPPORTS SHALL BE APPROVED FOR THE PURPOSE. ZIP TIES OR VELCO STRAPS ARE NOT PREMITTED.

### ELECTRICAL SPECIFICATIONS: ELECTRICAL MATERIALS AND EQUIPMENT, CONTINUED

- DECOMECT SHOULD BY HEAVY DUTY, FUSIBLE, DEAD FRONT, QUICK-MAKE, QUICK-BREAK, DESCENDED SHOTCHES SHALL BE HEAVY DUTY, FUSIBLE, DEAD FRONT, QUICK-MAKE, QUICK-BREAK, CARRIER AND RIAMA RATING AS INDICATED.

  AMPERADE AND RIAMA RATING AS INDICATED.

  BERTALL DECOMENTED SHOTCHES LAND FUSIBLE, COINCET TO WRITHIN STREAM OF GROUNDING AS INDICATED SHOTCH AND FUSIBLE SHOTCH AS INDICATED AND FUSIBLE SHOTCH AND FUSIBLE SHOTCH AS INDICATED AND FUSIBLE SHOTCH SHOTCH AS INDICATED AN

- UNUSED BROWNER OF THE SHALL BE TYPEWRITTEN, NOT HANDWRITTEN.
  ALL PAREL DIRECTORIES SHALL BE TYPEWRITTEN, NOT HANDWRITTEN.
  PAREL DIRECTORIES SHALL BE UPDATED TO ACCURATELY REFLECT THE FINAL CIRCUITING.
  ALL UNUSED CIRCUIT BREAKERS SHALL BE SWITCHED OFF AND LABELED "SPARE".

### EXTERNALLY MOUNTED SURGE PROTECTION DEVICES

- RATED FOR THE INTENDED APPLICATION AND AS INDICATED ON THE DRAWINGS: 120/240V, SINGLE PHASE, OR 120/200V, SINGLE PHASE, OR 120/200V, THREE PHASE, OR 480/277V, SINGLE PHASE OR 480/277V, REPORT PHASE OR 480/277V, REPORT PHASE OR 480/27V, REPOR

- POWER PROTECTION. CASINET. (PPC)

  1. MATED FOR USE, AT 120/240Y, SINGLE PMAE, THREE WIE FLUS GROUND OF 170/200Y, SINGLE PMAE, THREE WIE FLUS GROUND OF 170/200Y, SINGLE PMAE, THREE WIE FLUS GROUND OF 170/200Y, SINGLE PMAE, AND THE PMAE AND THE SINGLE FOR THE SINGLE PMAE AS SECURITY OF THE DEWINDS.

  2. ALLIMINUM OR COPPER BUS, BATED FOR 200 AMPRES OR AS INDICATED ON THE DEWINDS, AND HAVE A SHORT CHORUTY MICHAEL OF THE DEWINDS, AND THE DEWINDS OF THE DEWINDS, AND THE SINGLE PMAE AND THE SINGLE PM

- 1. WEATHERPROF ENCLOSURE WHICH INCLUDES A 120V, 20A OFCI RECEPTACLE AND A 120V, 20A TOSLE SWITTER.

  2. WILLIES CORER, CORROSION RESISTANT, GALWANZED STEEL ENCLOSURE. OF OR RECEPTACLE AND LOTH SWITTER SHALL BE WIRED ON SEPARATE CIRCUITS, UNLESS OTHERWISE NOTED ON THE DRAWNISE.

  A C.E. # USEDSTOORD OR APPROVED EDUAL.



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CHECKED BY: 19E0047.001 DRAWING TITLE:

> **ELECTRICAL NOTES**

DRAWING SHEET:

FRALEY FAMILY - ROCKVILLE 7WAN162B 17800 BOWLE MILL BOAD DERWOOD, MARYLAND 28055

SHEET NO. 13 OF 13



### **APPROVED**

Montgomery County

**Historic Preservation Commission** 

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