

HISTORIC PRESERVATION COMMISSION

Marc Elrich County Executive Robert K. Sutton Chairman

Date: May 13, 2022

MEMORANDUM

TO:	Mitra Pedoeem
	Department of Permitting Services
FROM:	Michael Kyne
	Historic Preservation Section
	Maryland-National Capital Park & Planning Commission
SUBJECT:	Historic Area Work Permit # 989960: Fenestration alterations

The Montgomery County Historic Preservation Commission (HPC) has reviewed the attached application for a Historic Area Work Permit (HAWP). This application was <u>Approved</u> at the May 4, 2022 HPC meeting.

The HPC staff has reviewed and stamped the attached construction drawings.

THE BUILDING PERMIT FOR THIS PROJECT SHALL BE ISSUED CONDITIONAL UPON ADHERENCE TO THE ABOVE APPROVED HAWP CONDITIONS AND MAY REQUIRE APPROVAL BY DPS OR ANOTHER LOCAL OFFICE BEFORE WORK CAN BEGIN.

Applicant:James and Emily Petrila (Patricia Mendoza, Agent)Address:2 East Melrose Street, Chevy Chase

Address. 2 East Menose Street, Chevy Chase

This HAWP approval is subject to the general condition that the applicant will obtain all other applicable Montgomery County or local government agency permits. After the issuance of these permits, the applicant must contact this Historic Preservation Office if any changes to the approved plan are made. Once work is complete the applicant will contact Michael Kyne at 301.563.3403 or michael.kyne@montgomeryplanning.org to schedule a follow-up site visit.



	For Staff only: HAWP# <u>989960</u>
APPLICATIO	Data assigned
HISTORIC AREA W	ORK PERMIT
APPLICANT:	
Name: James Petrila & Emily Petrila	E-mail: jpetrila@gmail.com
Name: James Petrila & Emily Petrila Address: 2 E Melrose St	City: Chevy Chase Zip: 20815
Daytime Phone: 2025500739	Tax Account No.:
AGENT/CONTACT (if applicable):	
Name: Patricia F Mendoza	E-mail: pferrufino.m@gmail.com
Address: 9044 Templeton dr	E-mail: pferrufino.m@gmail.com City: Frederick Zip: 21704
Address: 9044 Templeton dr Daytime Phone: 2405957953	Contractor Registration No.:
LOCATION OF BUILDING/PREMISE: MIHP # of Histori	
Is the Property Located within an Historic District?	Yes/District Name No/Individual Site Name
Is there an Historic Preservation/Land Trust/Environmer map of the easement, and documentation from the Ea	
Are other Planning and/or Hearing Examiner Approvals (Conditional Use, Variance, Record Plat, etc.?) If YES, i supplemental information.	
Building Number:	APPROVED
Building Number: Street:	Montgomery County
Town City: Nearest Cross	s S Historic Preservation Commission
Lot: By Michael Kyne at 12:44 pm, May 13, 2022	
TYPE OF WORK PROPOSED: See the checklist on F for proposed work are submitted with this applic be accepted for review. Check all that apply:	
New Construction Deck/Porch Addition Fence Demolition Hardscape/Lands Grading/Excavation Roof	Solar Tree removal/planting
I hereby certify that I have the authority to make the for and accurate and that the construction will comply with agencies and hereby acknowledge and accept this to Patricia Ferrutino Mendoza	bregoing application, that the application is correct th plans reviewed and approved by all necessary

Signature of owner or authorized agent

Description of Property: Please describe the building and surrounding environment. Include information on significant structures, landscape features, or other significant features of the property:

This is a Historic house Basement /1st floor /2nd floor/ Attic

> **REVIEWED** By Michael Kyne at 12:44 pm, May 13, 2022



Description of Work Proposed: Please give an overview of the work to be undertaken:

The work to be performed is at basement of the property and it will be mainly interior

Underpinning will be performed under the certification of a structural engineer

The goal is to achieve a higher ceiling height

Currently 6'-6" the plan is to have 9' ceiling height

There will be some interior demolition including existing columns (as per structural solution) to open up the space and accommodate new layout

Enlargement of a few inches of main door into basement

At west side elevation/basement: proposed new window at new office **as per proposed new work **

At east side elevation/1st Level: The existing library door will be converted into a window

Material/Colors/Style will remain as original

BASEMENT/LINDERPINNING Work Item 1: INTERIOR LAYOU + × Description of Current Condition: Proposed Work: · LINDER PINNING, LINDER THE BASEMENT IS A CINFINISH CERTIFICATION of structuren SPACE . EXISTING HEIGHT 6-6" ENGENEER. the GOAL IS to CREATE A NEW OPEN SPACE HEIGHT OF 9' CLEAR FROM FLOOR to CEILING-. SOME DEMO. INVOLUED. COLUMNS. NEW LUTERIOR LAYOUT. NEW COWMNS WILL BE REPLACING old ones Work Item 2: PROPOSED 48" × 36" WINDOW / BASEMENT Description of Current Condition: Proposed Work: OPEN to ACOMODATE NEW EURBENT CONDITION IS FOUNDATION WALL AT WEST 48" ×36" WINDOW this will be chertifled By SIDE OF THE HOUSE . STRUCTUREN ENGENEER. IT WILL BEING LIGHT TO (N)OPFI APPROVED Montgomery County Historic Preservation Commission REVIEWED By Michael Kyne at 12:44 pm, May 13, 2022 AMMEL /MA 1St PLa Work Item 3: DOOR AT UBRARY Proposed Wo Description of Current Condition: CONVERT EXISTING DODE INTO the Basting POOR IS A WINDOW HTILLING SAME NOT BEIGN UTILIZED AS OPENING AND REEPING Basting FRAMING AS MUCH. MULH AS POSIBLE, NO CHANGING COLOR. SEE ELEVATION Work Item 4 Enlarge MAIN BOOR PROPOSED WORK: DODE WREENHLY 32" OPEN A LITTLE BIT to FIT 36" DOOR

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By Michael Kyne at 12:44 pm, May 13, 2022

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HAWP APPLICATION: MAILING AD

[Owner, Owner's Agent, Adjacent and Confronting Property Owners]

Owner's mailing address	Owner's Agent's mailing address
James Petrila	Patricia Ferrufino Mendoza
2 E Melrose st	9044 Templeton dr
Chevy Chase MD 20815	Frederick , Md 21704
Adjacent and confronting	Property Owners mailing addresses
Norman & Jeanne Asher	Patrick & Lindsay Conway
1 E Melrose St	5 E Melrose St
Chevy Chase MD 20815	Chevy Chase MD 20815
Britt & Keeley Snider	Manuel & Jamie Bramao
6 E Melrose St	1 E Lenox St
Chevy Chase MD	Chevy Chase MD 20815
20815	
20010	
James Spiegelman & Elizabeth Kannan	
3 E Lenox St	2 West Melrose Street
Chevy Chase MD 20815	Chevy Chase, MD 20815
-	

HISTORIC AREA WORK PERMIT CHECKLIST OF APPLICATION REQUIREMENTS

	Required Attachments						
Proposed Work	I. Written Description	2. Site Plan	3. Plans/ Elevations	4. Material Specifications	5. Photographs	6. Tree Survey	7. Property Owner Addresses
New Construction	*	*	*	*	*	*	*
Additions/ Alterations	*	*	*	*	*	*	*
Demolition	*	*	*		*		*
Deck/Porch	*	*	*	*	*	*	*
Fence/Wall	*	*	*	*	*	*	*
Driveway/ Parking Area	*	*		*	*	*	*
Grading/Exc avation/Land scaing	*	*		*	*	*	*
Tree Removal	*	*		*	*	*	*
Siding/Roof Changes	*	*	*	*	*		*
Window/ Door Changes	*	*	*	*	*		*
Masonry Repair/ Repoint	*	*	*	*	*		*
Signs	*	*	*	*	*		*

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By Michael Kyne at 12:44 pm, May 13, 2022

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By Michael Kyne at 12:46 pm, May 13, 2022

HOUSE ADDITION

2 E MELROSE ST CHEVY CHASE MD 20815

SCO	PE OF W	ORK				
9 FT HIGH CEILING IN	BASEMENT. E PARTS INCLUDING CTURAL IT OF EXISTING DOO UT					
CONVERTION OF EXI INTO NEW 48"X48" W		R EAST SIDE	BUILDING DA	TA		
		INTERNATIONAL I NATIONAL ELECT PLUMBING CODE		2018 EDITION 2018 EDITION 2018 EDITION		
		EXISTING	PROPOSED		NEW AREA	ALLOW
	ZONE BASEMENT FIRST FLOOR	R-60 1,215.9 SF	SF 0 SF			
	TINGTITLOOK	13,330.0 SF	U SP			

ZONE	R-60					
BASEMENT	1,215.9 SF		- SF			
FIRST FLOOR	13.330.0 SF	0	SF			
SECOND FLOOR	13,330.0 SF	0	SF			
ATTIC	13,330.0 SF	0	SF			
Construct Type						
Total New Const.						
		Front	Side	Rear	Max Heigh	
	SETBACKS	250 Ft	250 Ft	250 Ft	250 Ft	

GENERAL DATA

1. All construction shall be in compliance with the International Residential Code

- 2015 IRC . 2. The contractor shall verify all dimentions, grades, boundaries and construction
- 2. The contractor state vering an contentions, grades, boundaries and consolution before proceeding with the work.
 3. Wood stud bearing wells to be 2x6, 2x4 at 16 O.C. unlessoftierwise noted, SFF# 42 grade or before.
 4. All wood less than 6" from grade shall be presureded treated. All wood plated on slab

- to be pressure treated. 5. Provide minimum of R-49 Roof Insulation with vapor barrier and insulation baffles.
- at each roof bay eave. 6. Provide R-20 batt issuitation with vapor on all finished frame walls unless otherwise noted. 7. All exterior wood to be pressured treated or painted minimum of two coats of paint. All exterior metal-Louvers/steel lintel angel, flashing shall be galvanized and painted.
- 8. Provide ¹ T&O rated physicod subfloor.
 9. Provide ²-24 foot at each post at each end of double joists unless noted ofherwise.
 10. Prov pistures signal should show in only be guidance, floor joists supplier shall provide joint injoint of the other physical should provide joint injoint a single information of the other physical should provide joint injoint and store with the encoded should be informed at 3-07 the other physical should be informed as a single physical should be single physical should be informed as a single physical should
- high. 12. Smoke detectors to be installed in accordance with local codes and requirements

- Since detectors to be installed in accordance with local codes and requirem and to be installed with the electrical system.
 All electrical work shalt be installed in accordance with NEC and local codes.
 Hore that work shalt be installed in accordance with mechanical codes.
 Bottom of botting shalt be a minimum of 30 biolow grade.
 Dimensions given on floor plans are also be so of insted wall.
 General contractor and manufactures to coordinate all dimensions concerning
- General of instance and manufactures to docume a minimization solutioning doors, panels, which we have a solution of their openings prior to fabrication and construction.
 Typical interior partitions 2x4 wood studs with one layer ²/₂ gypsum board both sides unless otherwise noted.
 Provide shealing at all all scherior frame walls as shown on drawings. Install in

- Provide Streaming at an an excernmentations.
 Provide continuous footing drain tile along the building basement perimeter. Drain to positive outfall.

or run downspout into sleeve connected to below-grade pipe directing water away or run domispoul nito sietevi connected to below-grade type directing water away tom building. 22. Provide a minimum of one light future in con trusses attic access. 23. Sol barling canado yshall be minimum. 24. Concente: 3000 ppi minimum. 25. Minimum design loads shall be '30 PSF holabile attice. 10 PSF non storage attic, 30 PSF root, 40 PSF est balconies, PEF development.
 PEF development.

21. Provide splash block at all downpouts to direct water waav from building

INDEX IN PROGRESS...

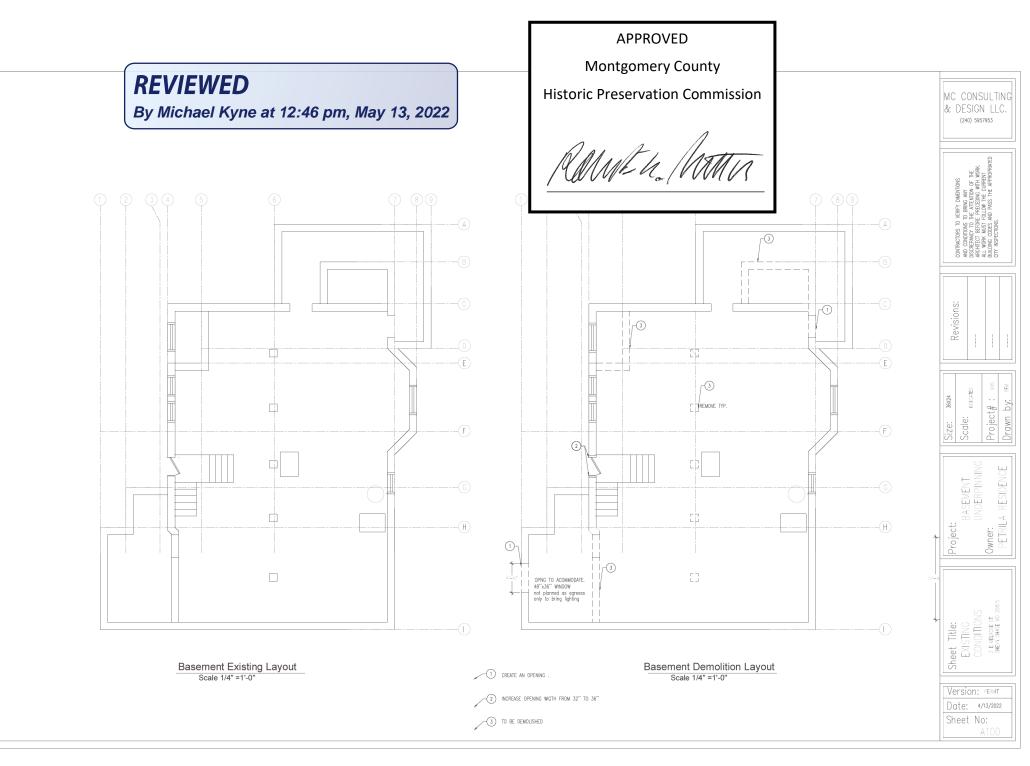
APPROVED **Montgomery County** MC CONSULTING **Historic Preservation Commission** & DESIGN LLC. (240) 5957953 Rame h. M WORK WORK DIMENTIONS S ANY S ANY ENTION OF TH DING WITH W NITH OF TIONS 2Y TO BEFOR MUST CONDITION REPANCY CHITECT F L WORK / UILDING C AND ARC BUIL BUIL **GENERAL DATA** ZONING SUMMARY Revisions: EXISTING PROPOSED NEW AREA ALLOW Zone Lot Sq R-60 Ld Area 13,330.0 S Ld Coverage % Construct Type 13,330.0 Sł Basement Area Total New Const May Hein SETBACKS 250 Ft 250 Ft 250 Ft 250 Ft 12 INDICATED 36X24 Project# : Drawn by: Scale: Size: MENT Ē RESID \exists Project iner: ETRI Own SYMBOL KEY SHEET MELROSE ST Title:

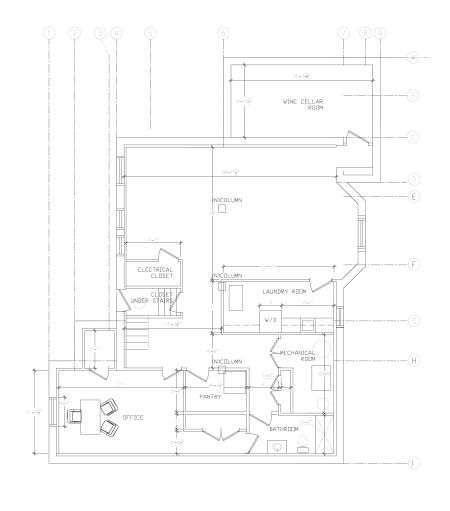
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Basement Proposed Layout Scale 1/4" =1'-0"

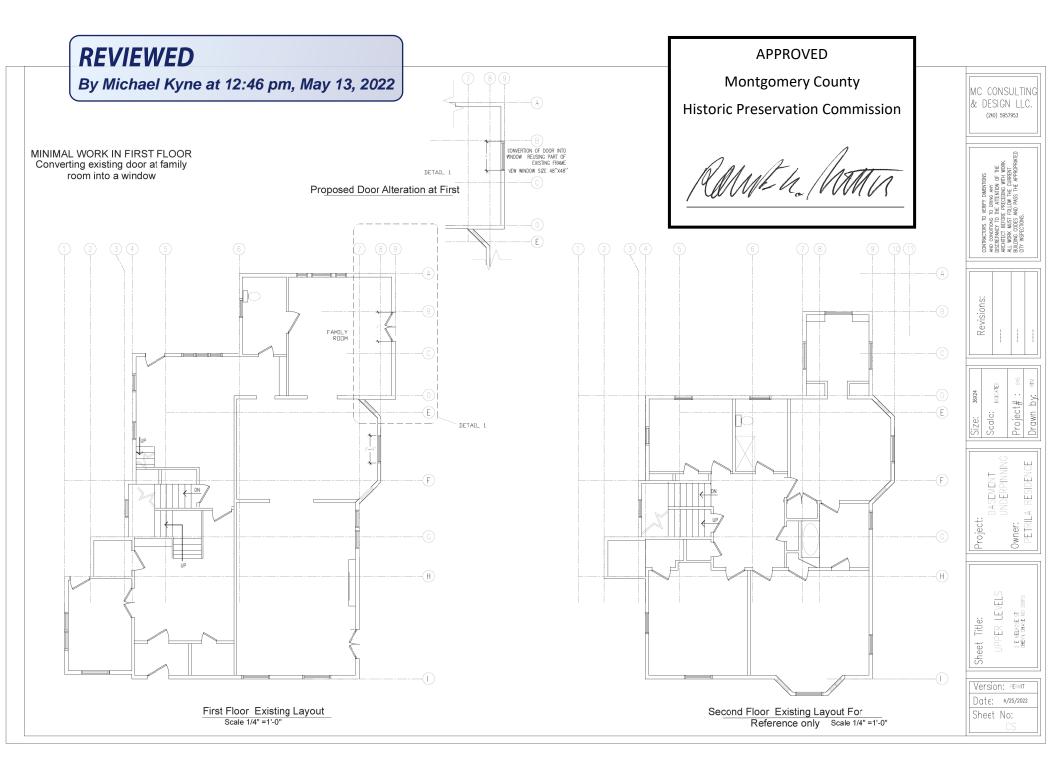
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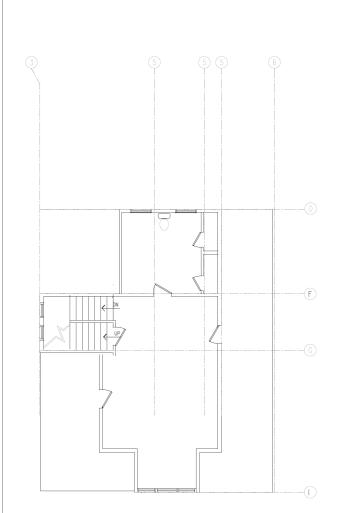
By Michael Kyne at 12:46 pm, May 13, 2022

APPROVED **Montgomery County Historic Preservation Commission** RAMEL_ MATTI

& DESIGN LLC. (240) 5957953 CON AND DISC ARC ALL Revisions: INDICATED Project# : 36X24 Drawn by: Scale: Size: BASEMENT UNDERPINNIN RESIDENCE Owner: PETRILA Project: NEW WORK 2 E MELROSE ST CHEVY CHASE MD : Sheet Title: Version: PERMIT Date: 4/13/2022 Sheet No:

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Attic Floor Existing Layout For Reference only Scale 1/4" =1'-0"

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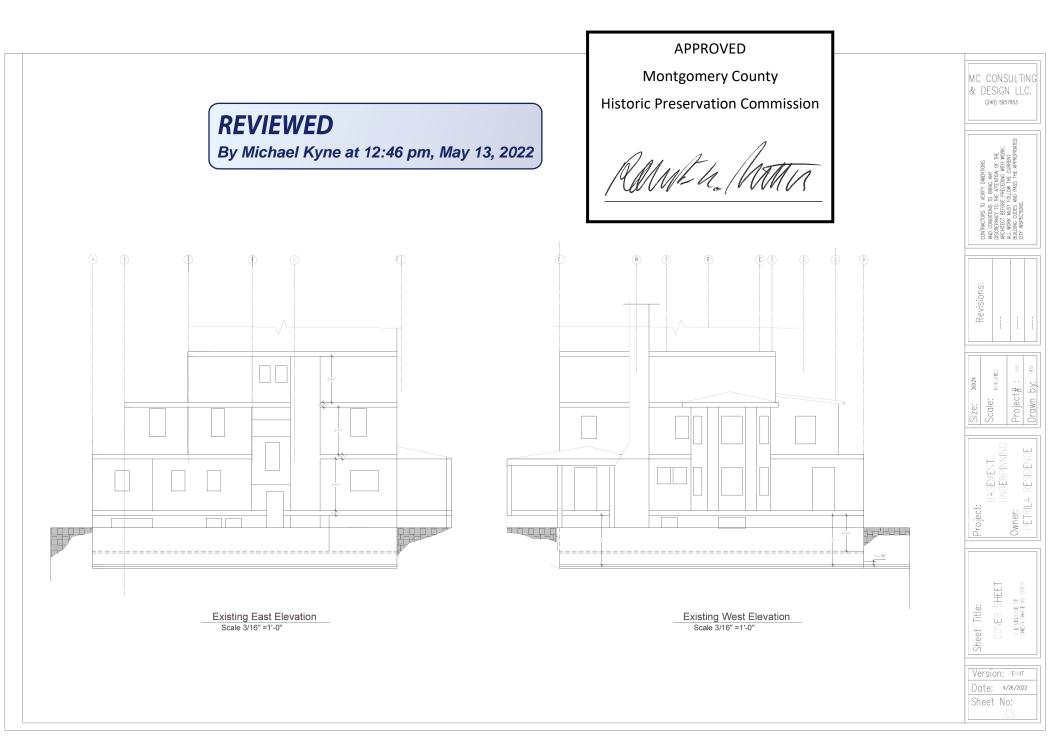
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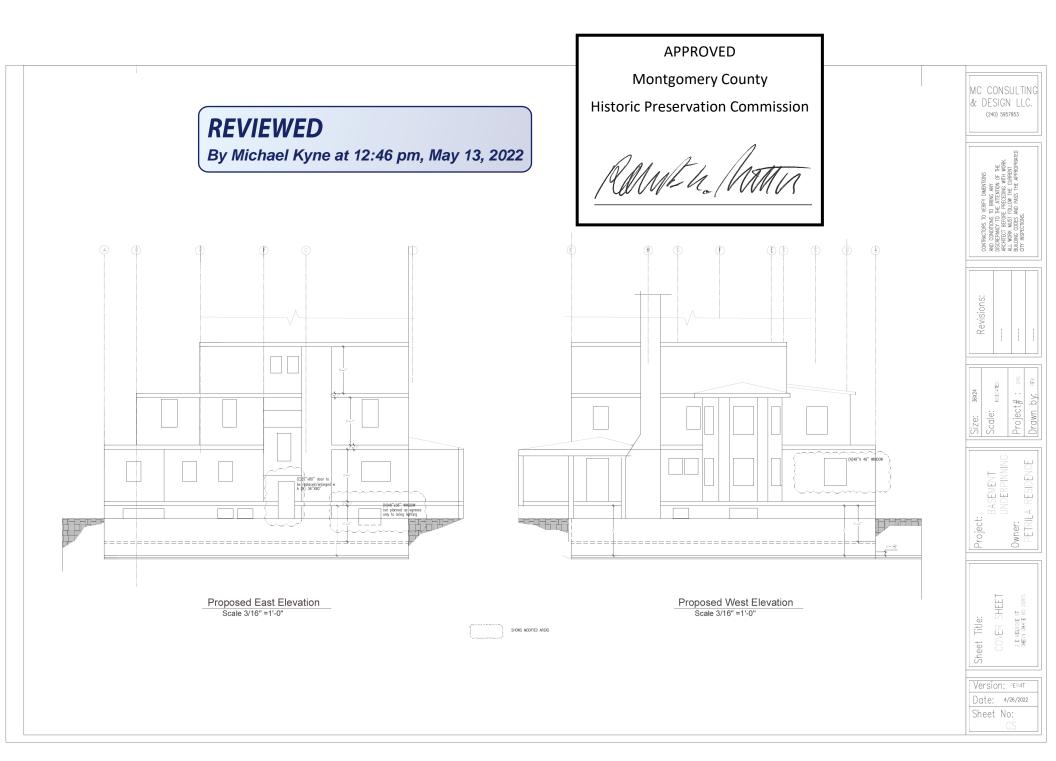
Montgomery County Historic Preservation Commission

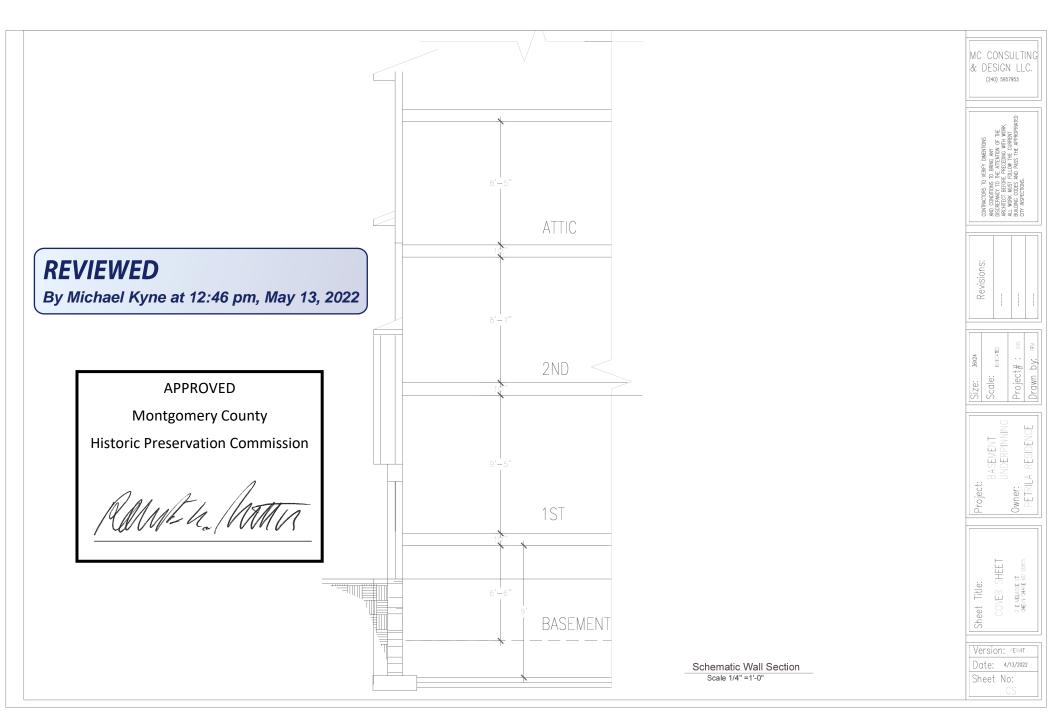
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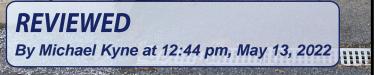
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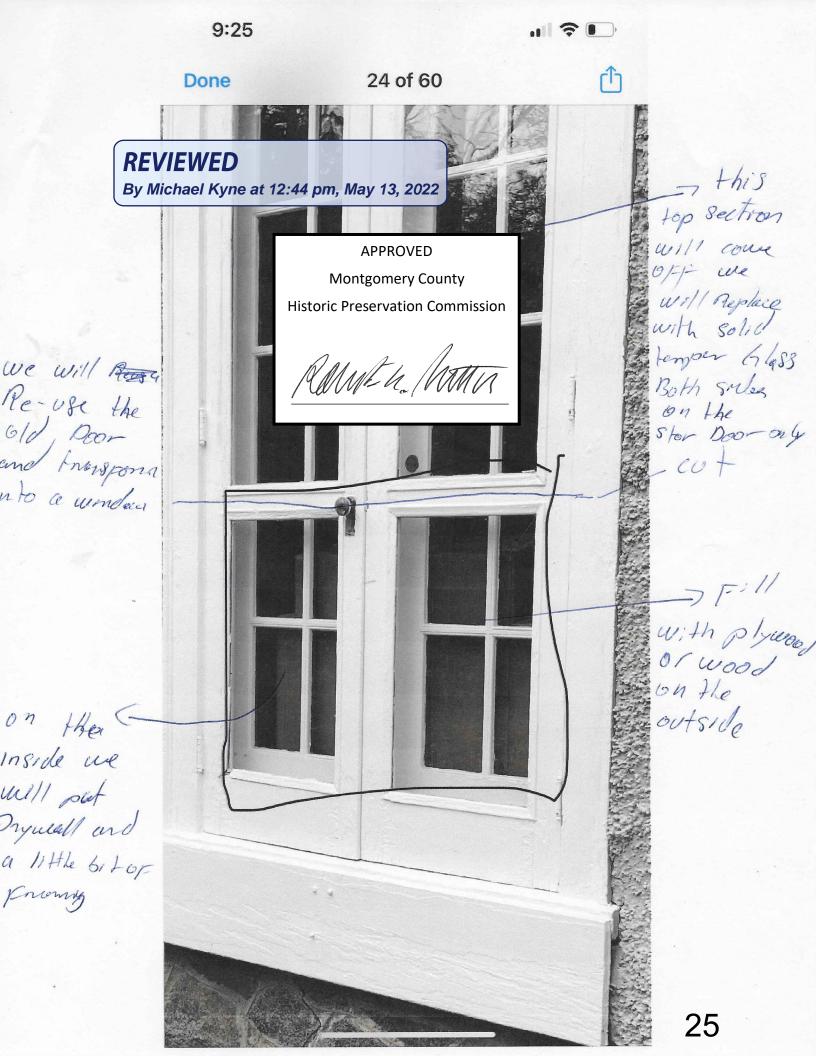
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RAMEL. MATTA



E-SERIES Windows

Architectural Collection



UNMATCHED FREEDOM

Whether you're looking for traditional styling or a more contemporary look – if it's possible, it's possible with E-Series windows and patio doors. With custom colors, unlimited interior options and dynamic sizes and shapes, every E-Series product is made to your exact specifications. Giving you unmatched flexibility and design freedom.



- Virtually maintenance-free exteriors never need painting and won't peel, blister or flake*
- Extruded aluminum exteriors provide greater structural capabilities than thinner, roll-form aluminum
- Weather-resistant construction for greater comfort and energy efficiency
- Many E-Series windows and patio doors have options that make them ENERGY STAR[®] v. 6.0 certified throughout the U.S.



- 50 exterior colors, seven anodized finishes and custom colors
- Variety of wood species and interior finishes
- Extensive hardware selection, grilles, decorative glass options and more
- Available with Stormwatch® Protection for coastal areas

PRODUCT TYPES

- Casement windows
- French casement windows
- Push out casement windows
- Awning windows

- Push out awning windows
- Double-hung windows
- Double-hung insert windows
- Double-hung sash replacement kits
- Bay and Bow windows
- Gliding windows



*Visit andersenwindows.com/warranty for details.

E-SERIES Windows

PRODUCT OPTIONS

EXTERIOR COLORS		
Anodized Finishes		
Wood Species All interior finish options are shown o	n pine.	
Factory-Finished Interiors		
A PARTY AND A PART		
Naturally occurring variations in grain, color and texture of wood	make each window one of a kind.	
Painted Interiors Available on pine.		
**	**	
	- HARDWARE OP	TIONS [†]
CASEMENT & AWNING ^{$++$}		DOUBLE-HUNG & GLIDING ^{††}
Casement	Awning	Standard Sash Locks Optional Sash Lifts
	4	P
Antique Brass Polished Brass Black		Antique Brass Polished Brass Black Bronze
Bronze Oil Rubbed Bronze [‡] Bright Chrome Satin Chrome Gold [‡]		Oil Rubbed Bronze Bright Chrome Satin Chrome Gold Pewter White
Pewter [‡] White	Antique Brass	
‡Gold, Oil Rubbed Bronze and Pewter are available on Casement windows only.	Polished Brass Black Oil Rubbed Bronze	
Bold name denotes finish shown.	Satin Chrome White	· · · · · · · · · · · · · · · · · · ·
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		Montgomery County
REVIEWED		Historic Preservation Commission
By Michael Kyne at 12:4	14 nm May 13 2022	
By menaci tyric at 12.	14 pm, may 13, 2022	PAL. A. Proto
	Fi	
	is either Sapele or Sipo, both non-endangered sp	ican mahoganies.
	and black are also available on maple. †Anodize	

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Krosswood Doors 36 in. x 80 in. Rustic Knotty Alder 4-Lite Clear Glass 2-Panel Unfinished Wood Front Door Slab KA.554.30.68.134

