

HISTORIC PRESERVATION COMMISSION

Marc Elrich County Executive Robert K. Sutton Chairman

Date: November 21, 2022

MEMORANDUM

TO:	Mitra Pedoeem
	Department of Permitting Services
FROM:	Dan Bruechert
	Historic Preservation Section
	Maryland-National Capital Park & Planning Commission
SUBJECT:	Historic Area Work Permit #1001229 – Partial Demolition, Addition, and Window
	Replacement

The Montgomery County Historic Preservation Commission (HPC) has reviewed the attached application for a Historic Area Work Permit (HAWP). This application was <u>Approved</u> at the September 21, 2022 HPC meeting.

The HPC staff has reviewed and stamped the attached construction drawings.

THE BUILDING PERMIT FOR THIS PROJECT SHALL BE ISSUED CONDITIONAL UPON ADHERENCE TO THE ABOVE APPROVED HAWP CONDITIONS AND MAY REQUIRE APPROVAL BY DPS OR ANOTHER LOCAL OFFICE BEFORE WORK CAN BEGIN.

Applicant:Amit BarmanAddress:6712 Westmoreland Avenue, Takoma Park

This HAWP approval is subject to the general condition that the applicant will obtain all other applicable Montgomery County or local government agency permits. After the issuance of these permits, the applicant must contact this Historic Preservation Office if any changes to the approved plan are made. Once work is complete the applicant will contact Dan Bruechert at 301.563.3408 or Dan.Bruechert@montgomeryplanning.org to schedule a follow-up site visit.



WESTMORELAND AVE RENOVATION 6712 Westmoreland Ave, Takoma Park, MD 20912

SCOPE OF WORK: CONVERT THE EXISTING LIVABLE ATTIC SPACE TO A SECOND FLOOR, KEEPING THE FRONT PORCH AND FRONT WALL AS IS. ADD A 250 SF ADDITION AT FIRST FLOOR. TOTAL EXISTING ATTIC SPACE IS 522 SF, TOTAL NEW SECOND FLOOR IS 1488 SF, EFFECTIVE NEW ADDITIONAL DWELLING ON SCCOND FLOOR IS 966 SF TOTAL NEW ADDITION IS 1,216 SF

ARCHITECTS


RCHITECTS WHO BUILD ww.architectswhobuild.com BUILD

CONTACT PERSON: AMIT BARMAN EMAIL:AMITBARMAN.ARCH@GMAIL.COM PH: 864 643 7251

Sheet List						
Sheet Number	Sheet Name					
A0.0	COVER					
A1.0	DEMOLITION PLAN					
A1.1	FLOOR PLANS					
A1.2	FLOOR PLANS					
A2.0	ELEVATION					
A2.1	ELEVATIONS					
A2.2	ELEVATIONS					
A3.0	SECTION					

APPROVED
Montgomery County
Historic Preservation Commission
Rame ha Matter



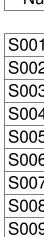



STRUCTURAL ENGINEERS



ARCHITECTS ENGINEERS CONSTRUCTION MANAGERS

12430 HILL CREST FULTON MD 20759 TEL. (240) 418 1389 FAX (888) 374 5418 INFO@ARENCO-LLC.COM

	Sheet List
Sheet Number	Sheet Name
01	GENERAL NOTES
02	FOUNDATION PLAN
03	FIRST FLOOR PLAN
04	SECOND FLOOR PLAN
05	ROOF PLAN
06	2ND FL WALL BRACING PLAN
07	SECTIONS
08	TYPICAL DETAILS
09	TYPICAL DETAILS

APPLICABLE BUILDING CODES:

ICC International Residential Code/2018 NFPA 13D/2013 COMAR NFPA 13D/2013 WSSC PLUMBING 7 FUEL GAS CODE

BUILDING INFORMATION:

EXISING BUILDING TOTAL FOOT PRINT: 1348 SF PROPOSED ADDITION FOOTPRINT: TOTAL CONDITIONED AREA INCLUDING **EXISTING AND PROPOSED:** 3877 SF

EXISTING BUILDING MAX HEIGHT: **PROPOSED ADITION MAX HEIGHT:** FIRE SUPRESSION SYSTEM:


617 SF

18'-0"

26'-0"


NON SPRINKLERED


and. hington, D wood St N ted Sta tal Servi nily Dollar

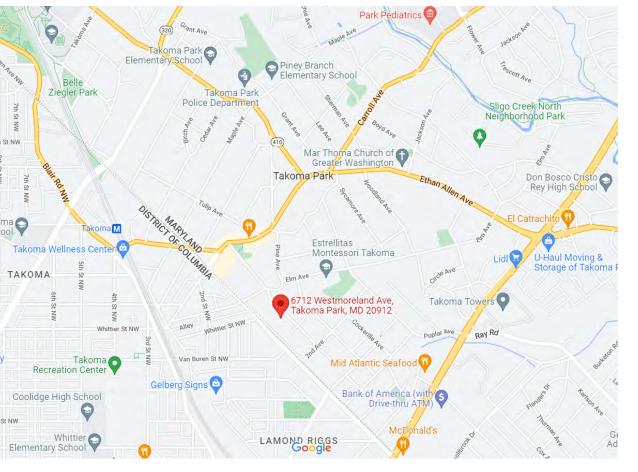

VICINITY MAP


"PROFESSIONAL CERTIFICATION I HEREBY CERTIFYTHAT THESE DOCUMENTS WERE PREPARED OR APPROVED BY ME, AND THAT I AM A DULY LICENSED PROFESSIONAL ARCHITECT UNDER THE LAWS OF THE STATE MARYLAND, LICENSE NO.18563, EXPIRATION DATE: 05/14/2024"

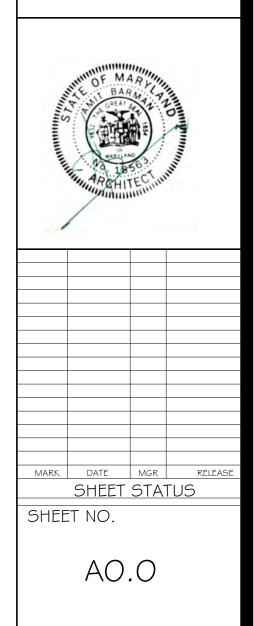


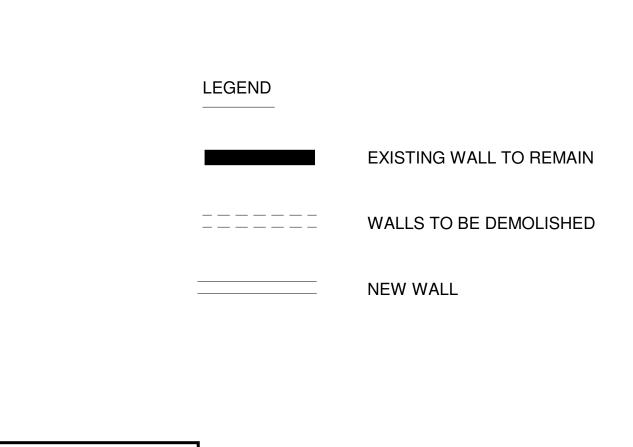


APPROVED Montgomery County **Historic Preservation Commission**


REVIEWED By Dan.Bruechert at 1:23 pm, Nov 21, 2022

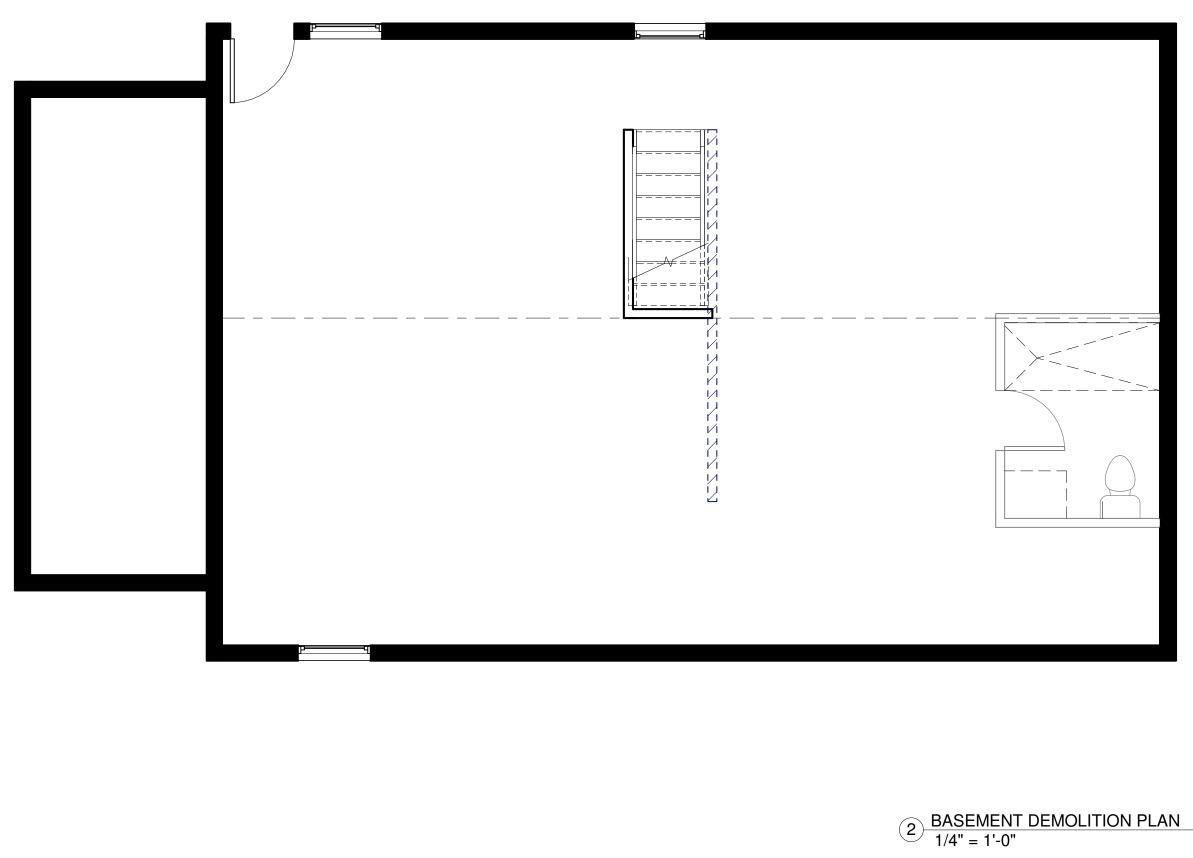


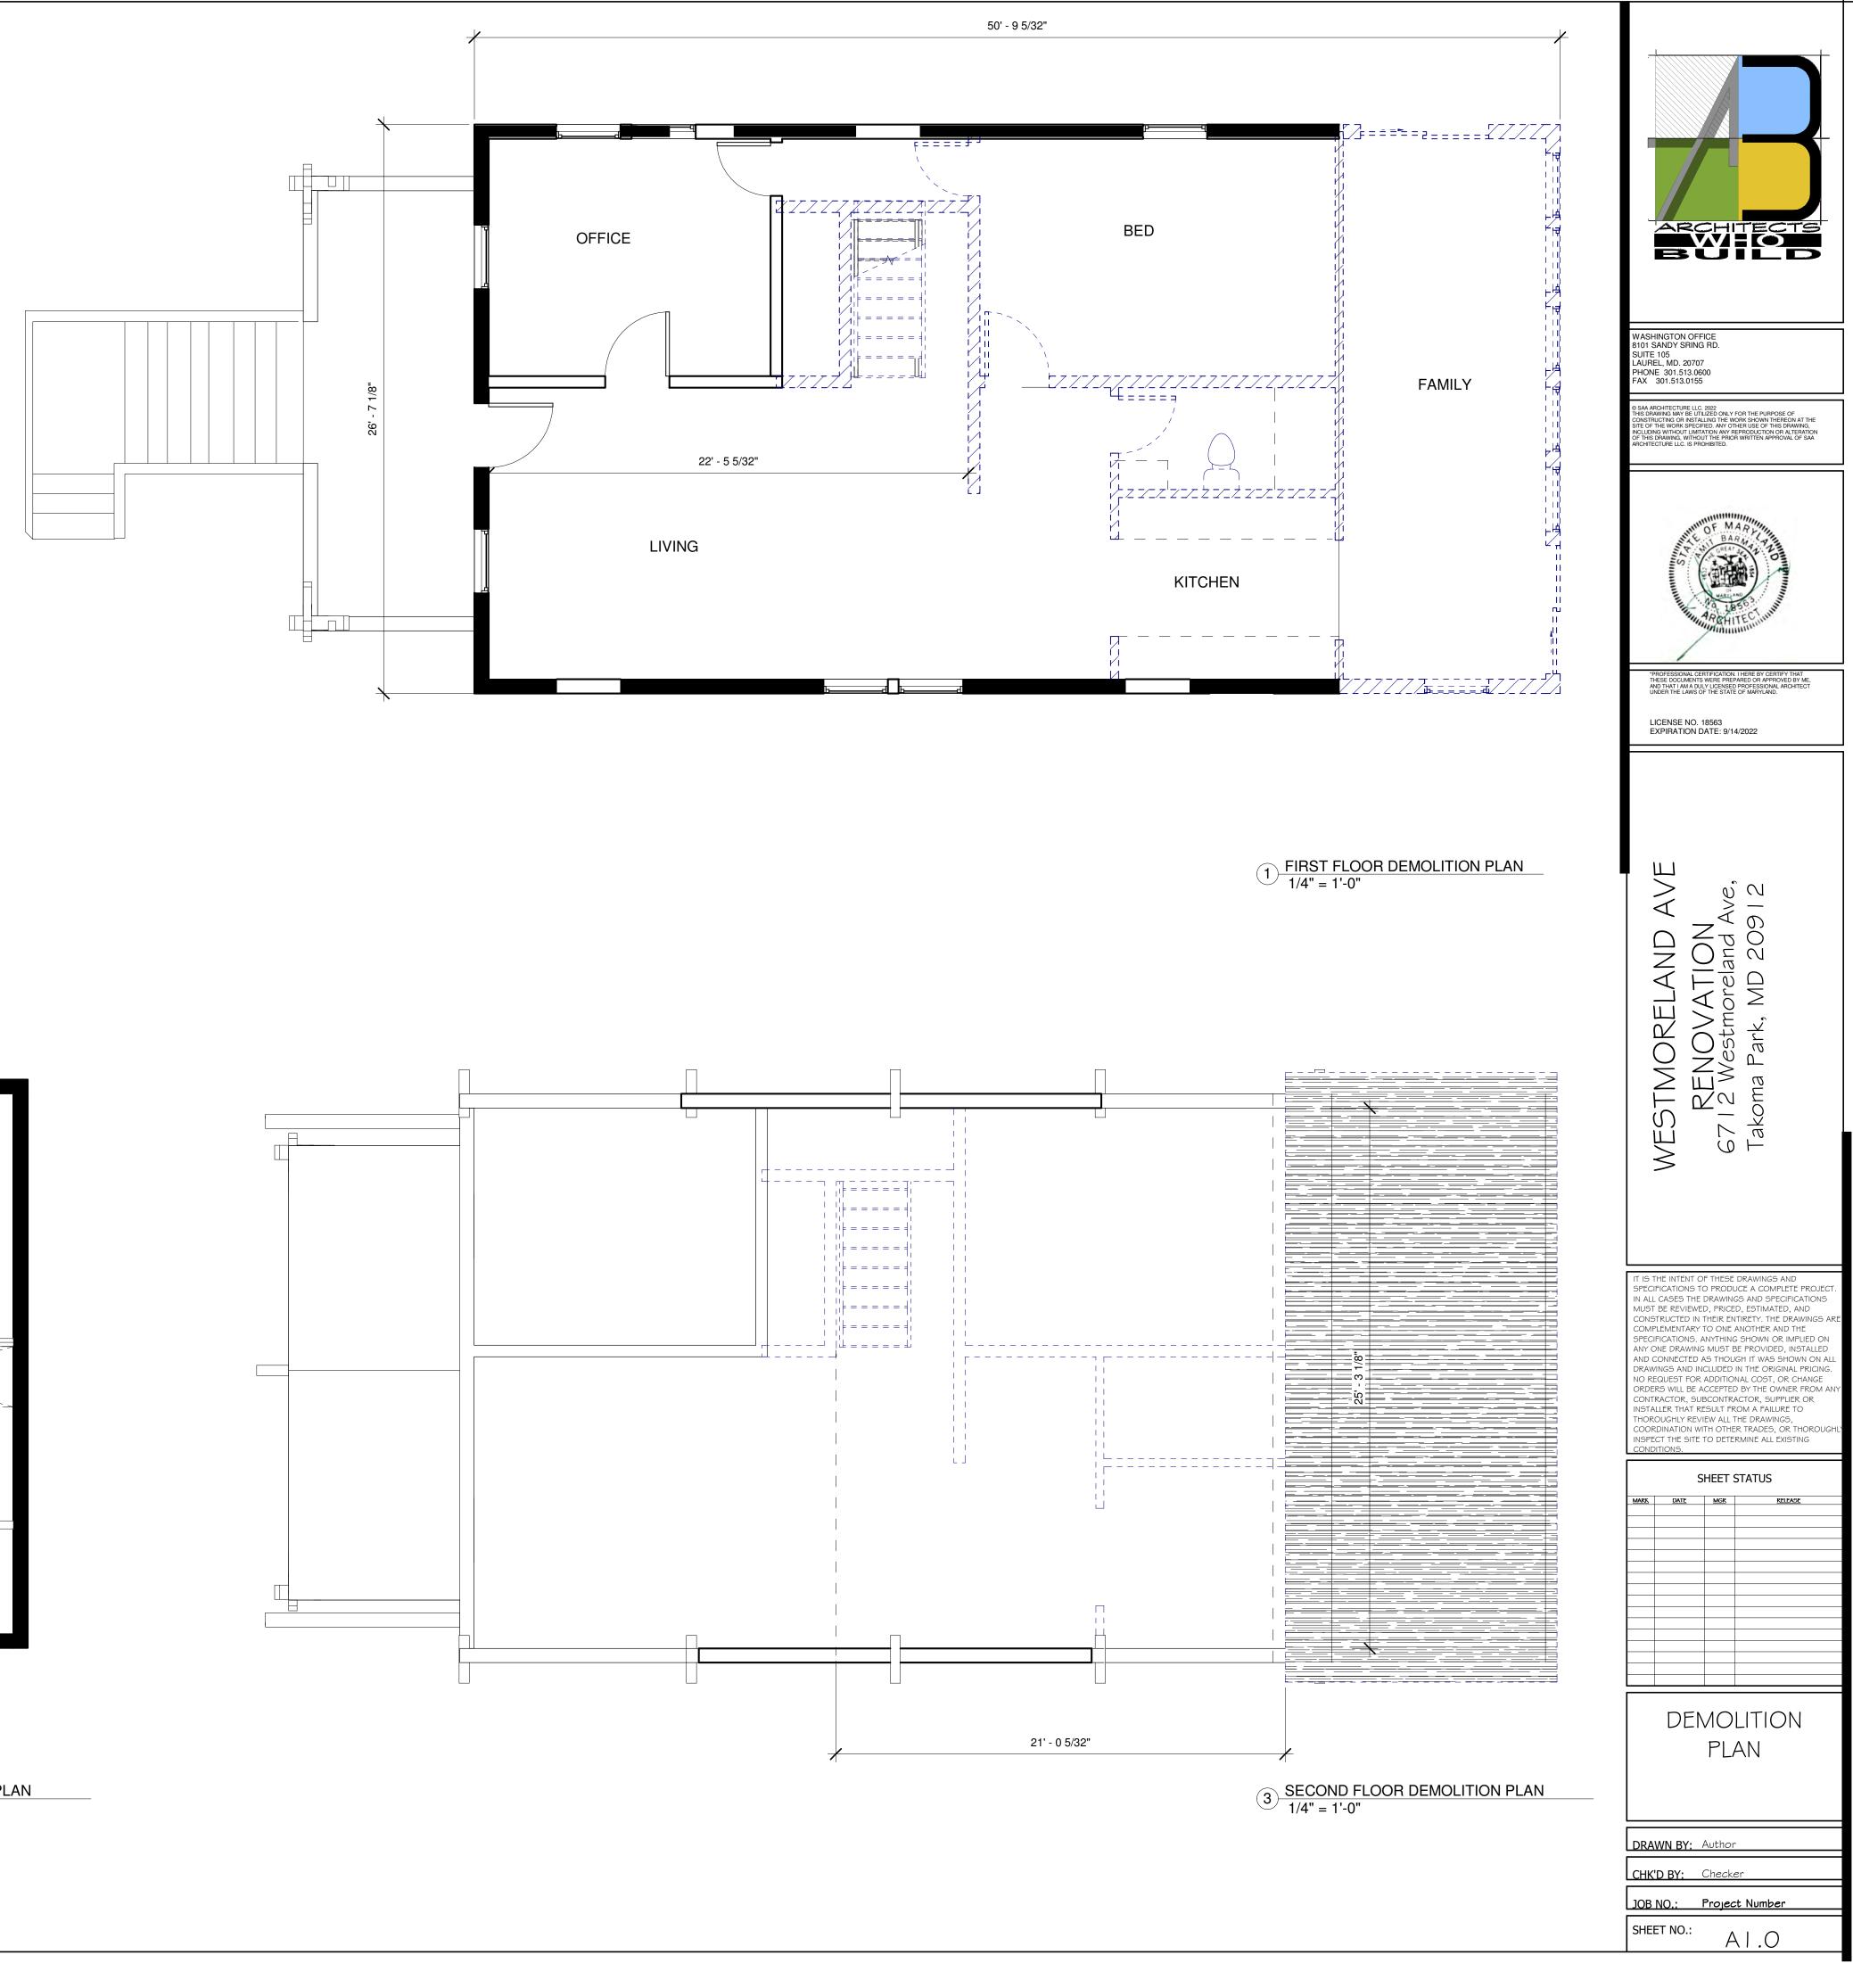


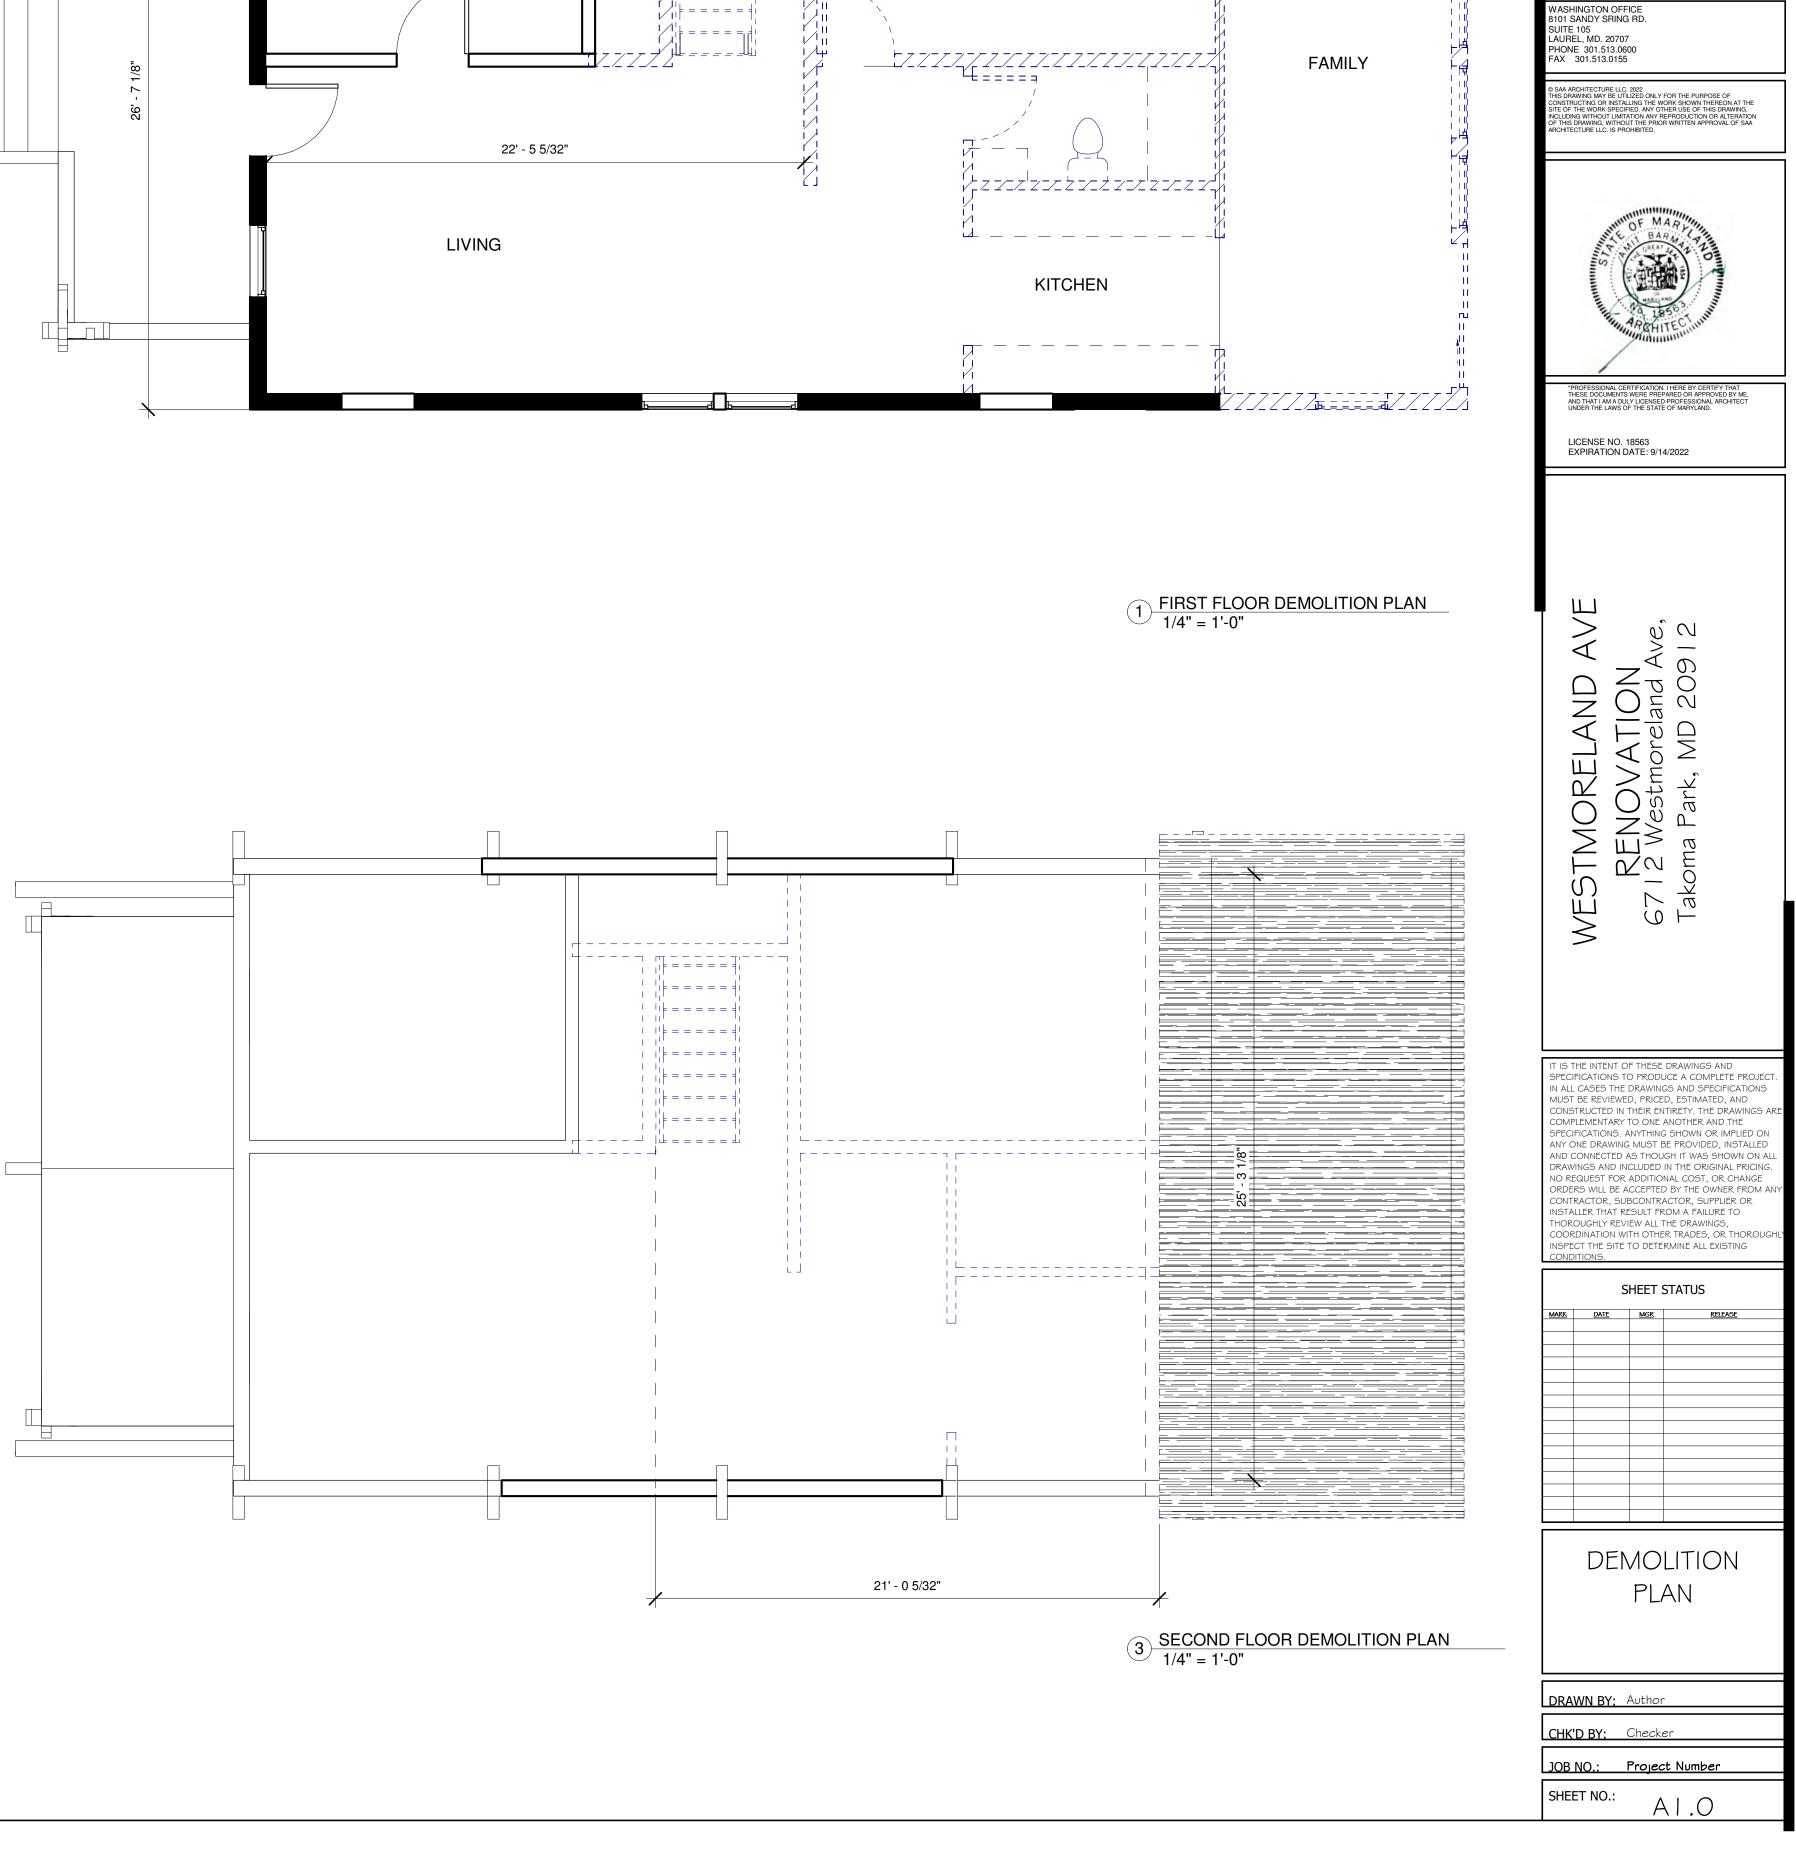

D 7' - 11" LEGEND _____ EXISTING WALL TO REMAIN _____ WALLS TO BE DEMOLISHED _ _ _ _ _ _ _ _ _ \mathbf{X} NEW WALL _____ CH \mathbf{X} 1 A3.0 APPROVED Montgomery County Historic Preservation Commission Ramen Man **D** REVIEWED By Dan.Bruechert at 1:23 pm, Nov 21, 2022 ____ _ _ _ _ _ _ _ _ __ 4. - 11 1/2" - m -1 A3.0 ß _____ __ ___ __ ___

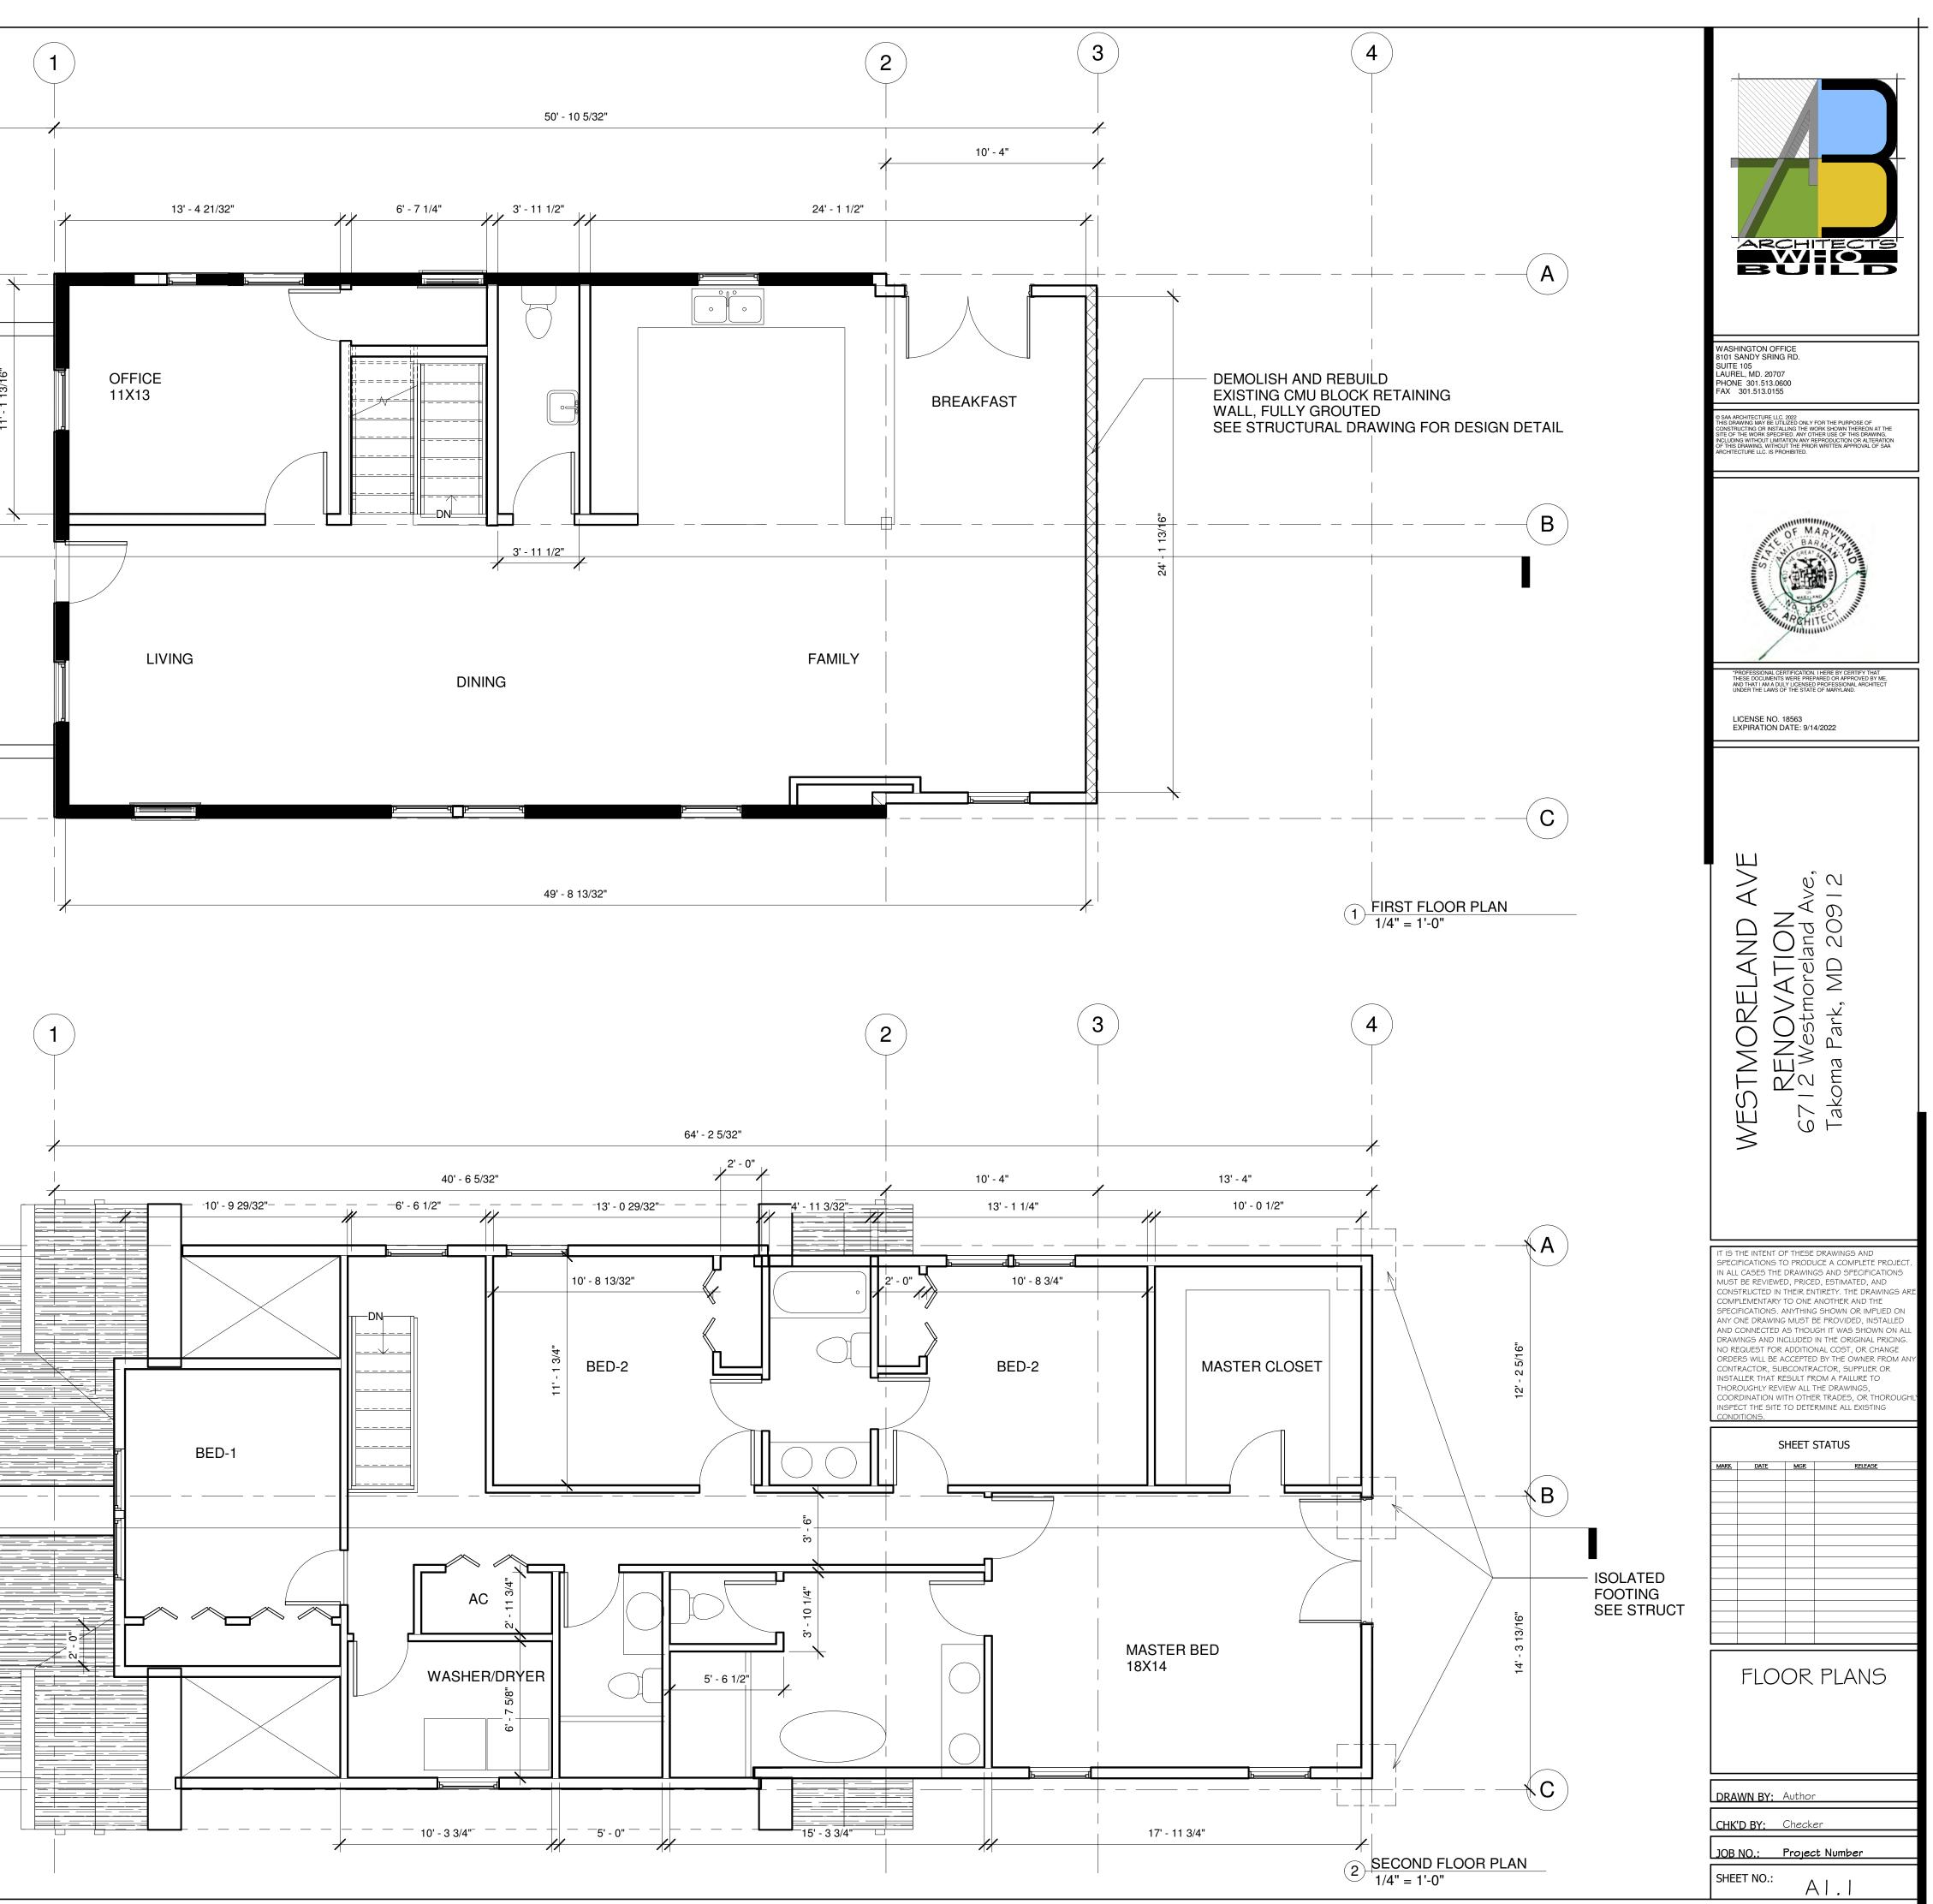

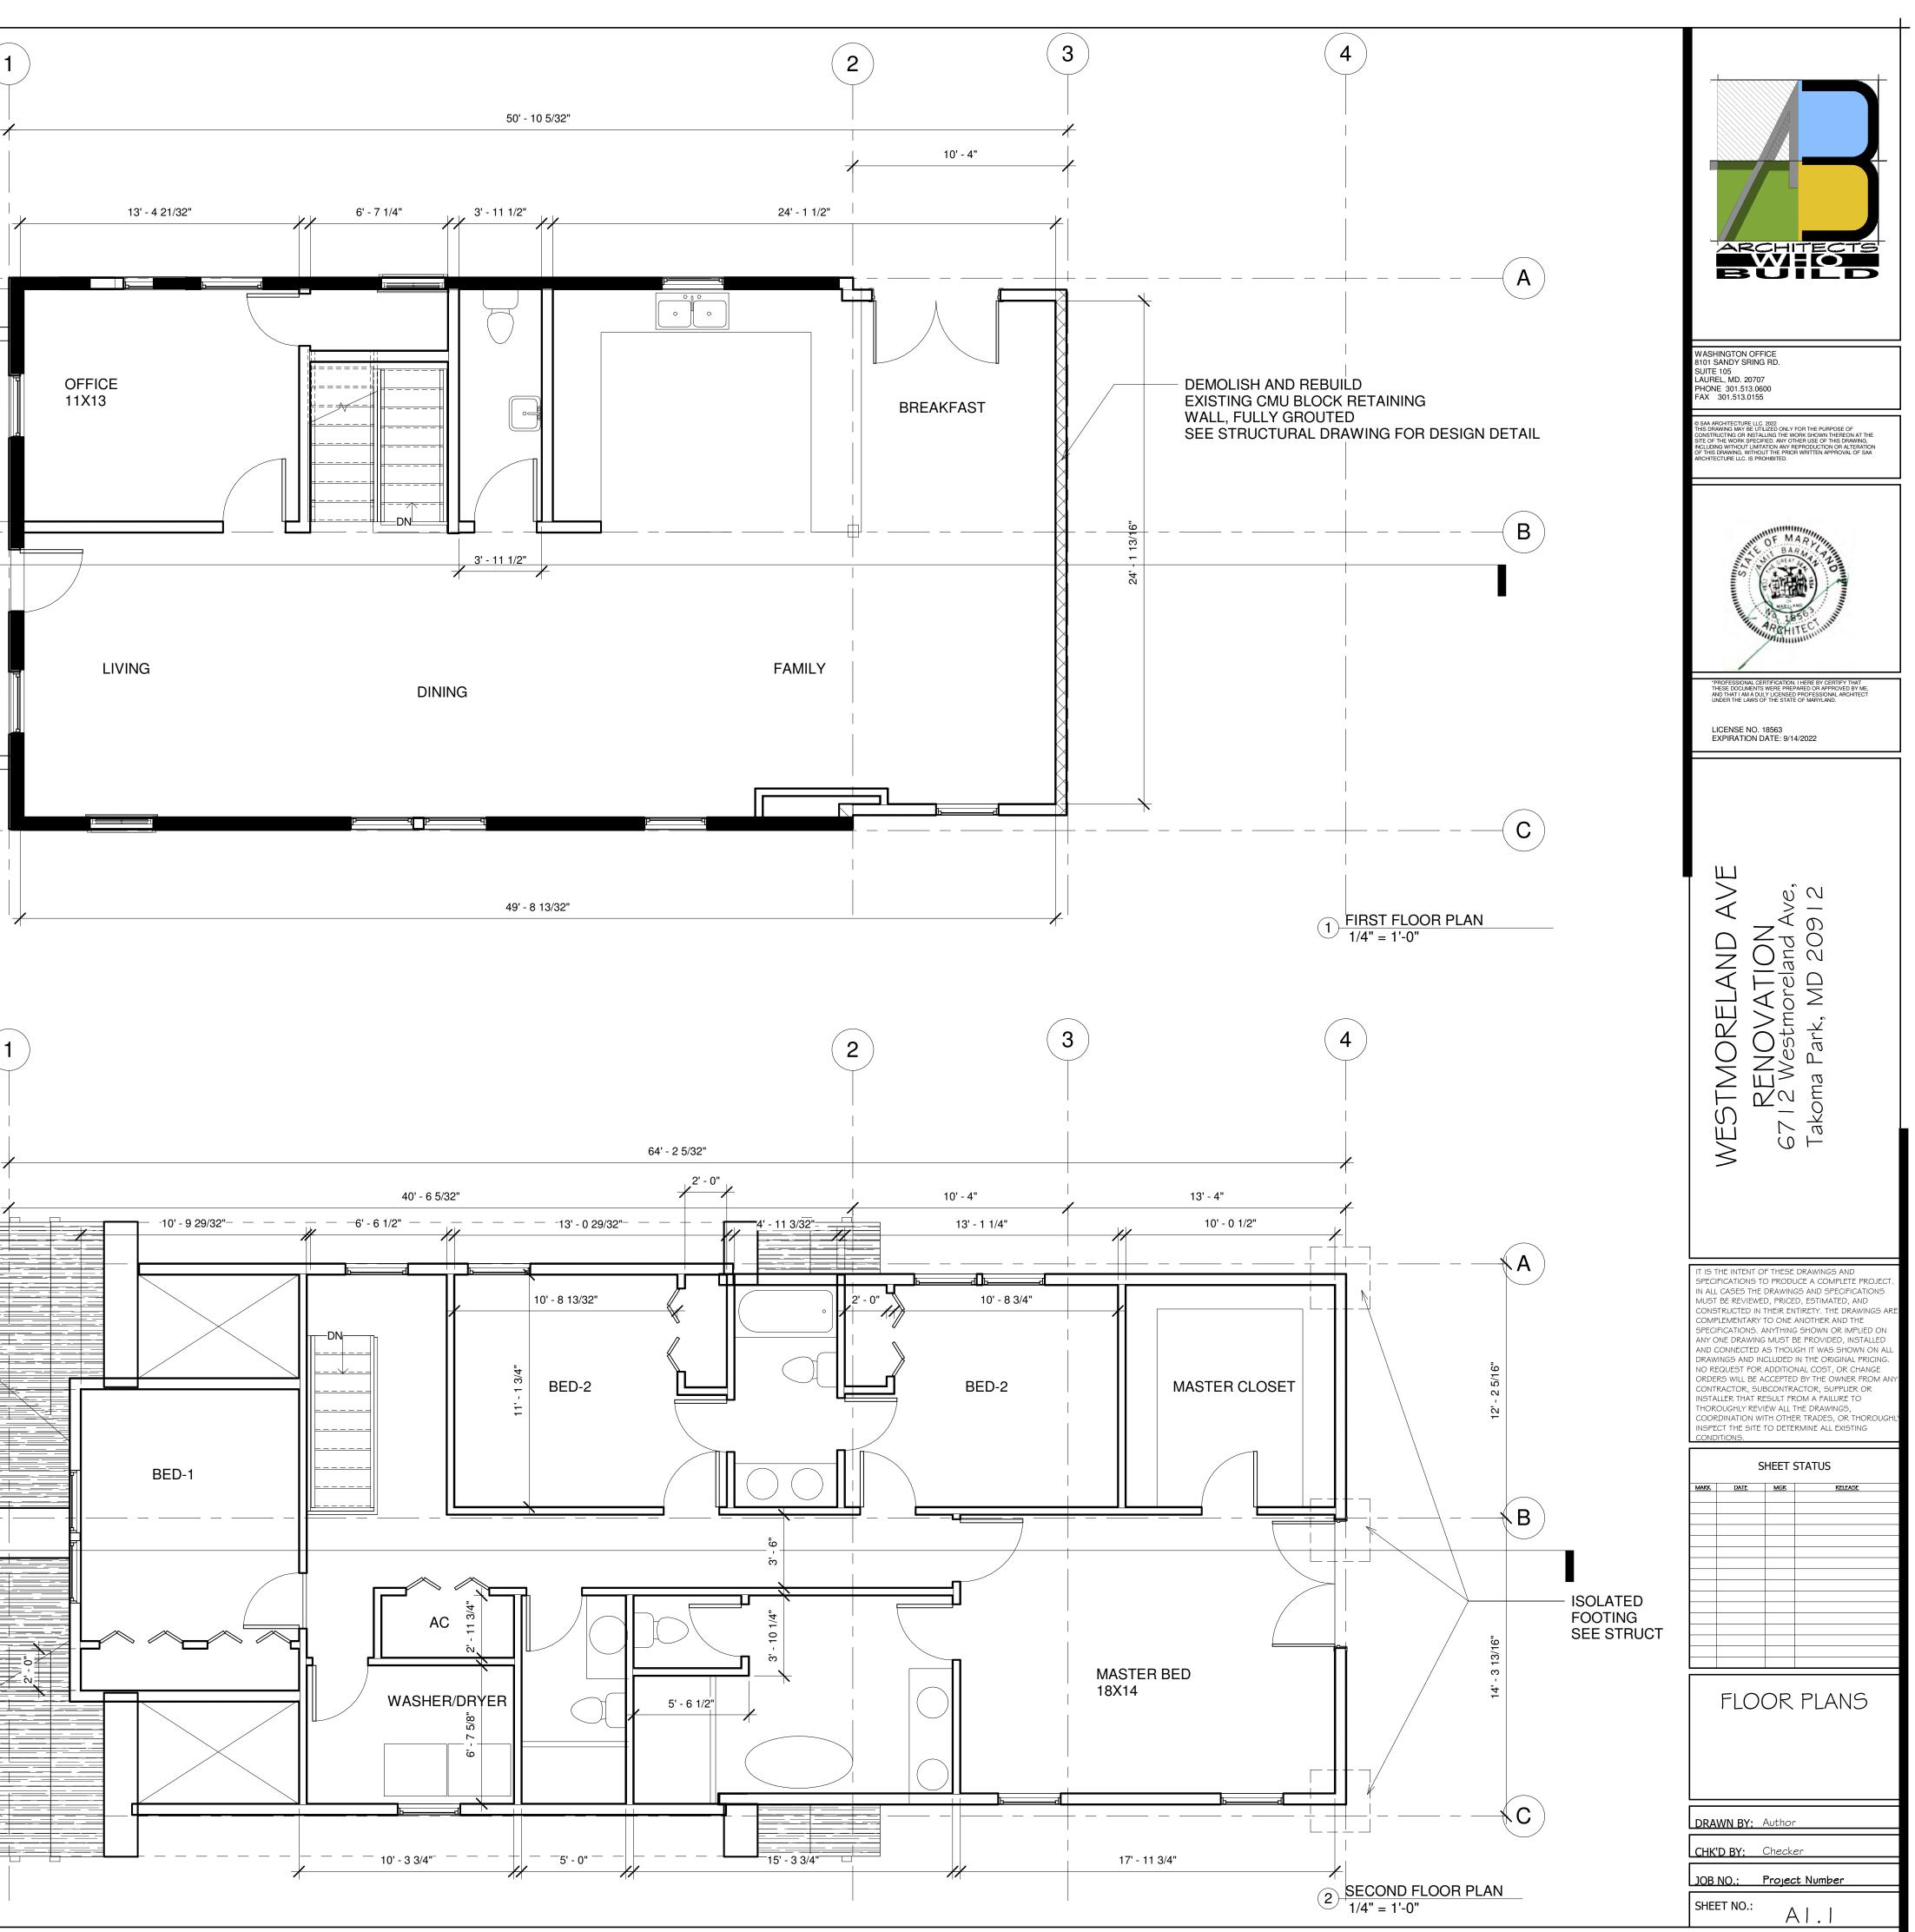


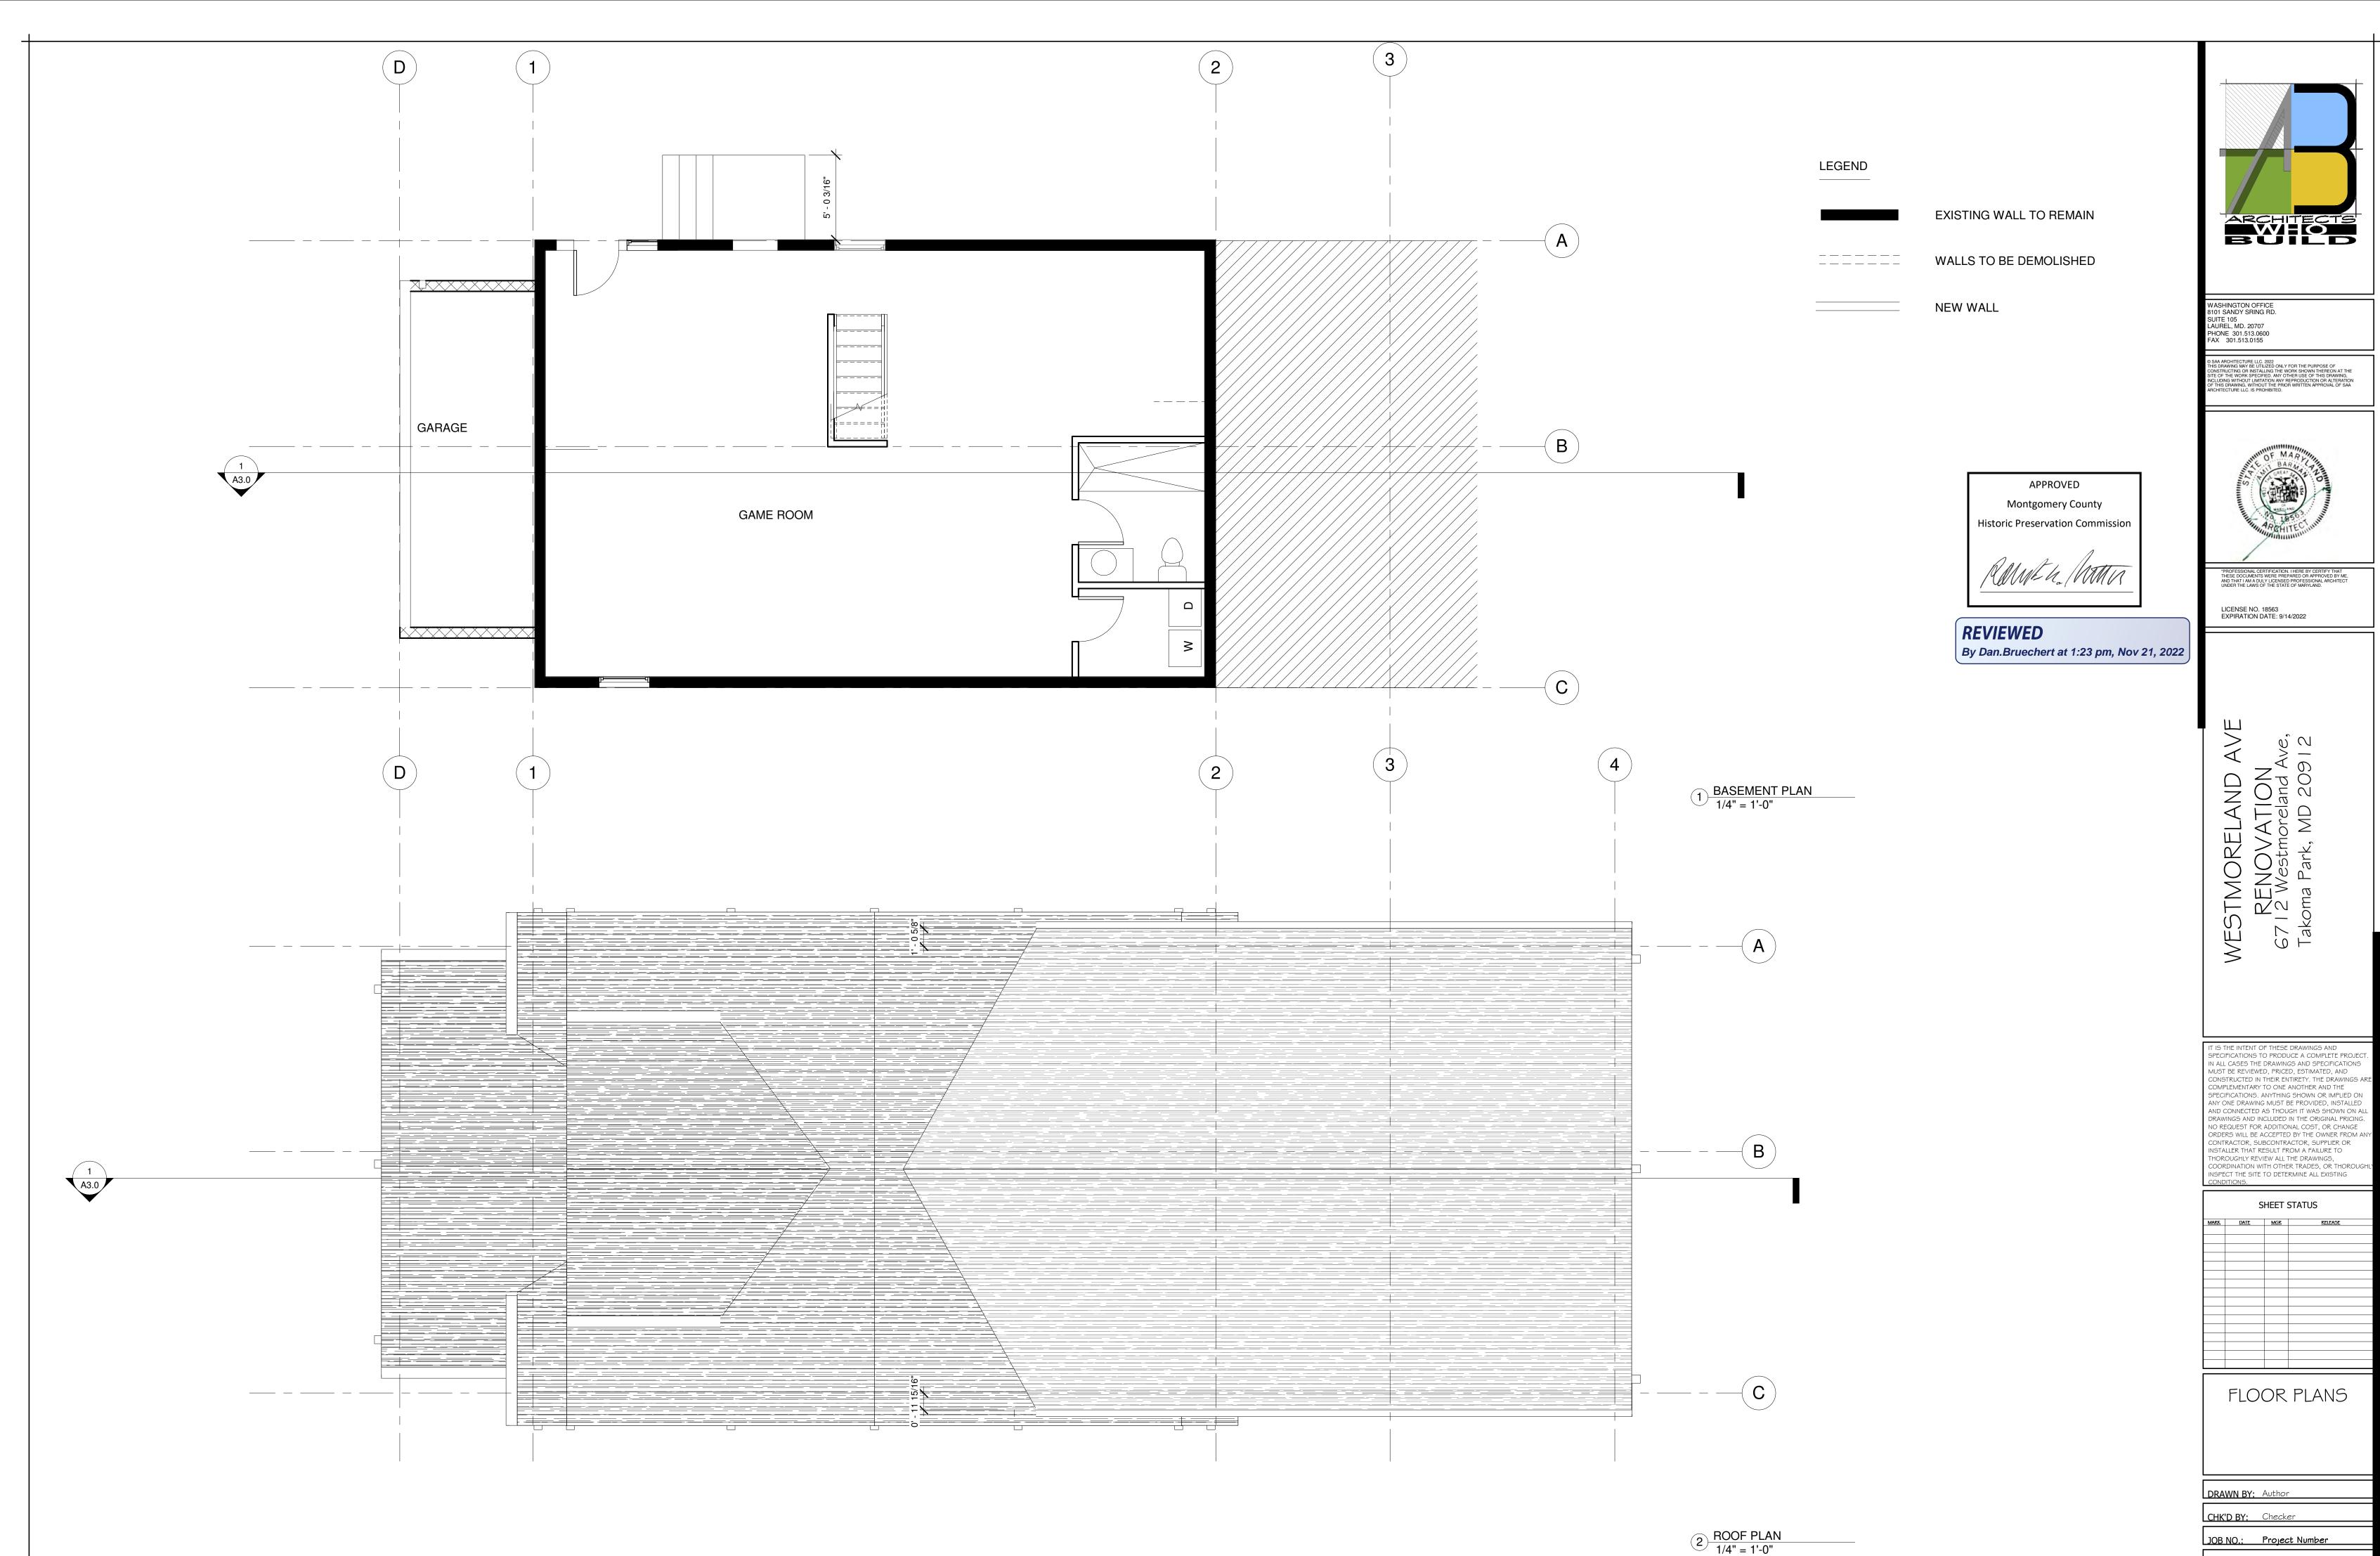

1/1/4/2022 10:46:141

SHEET NO .:


AI.2

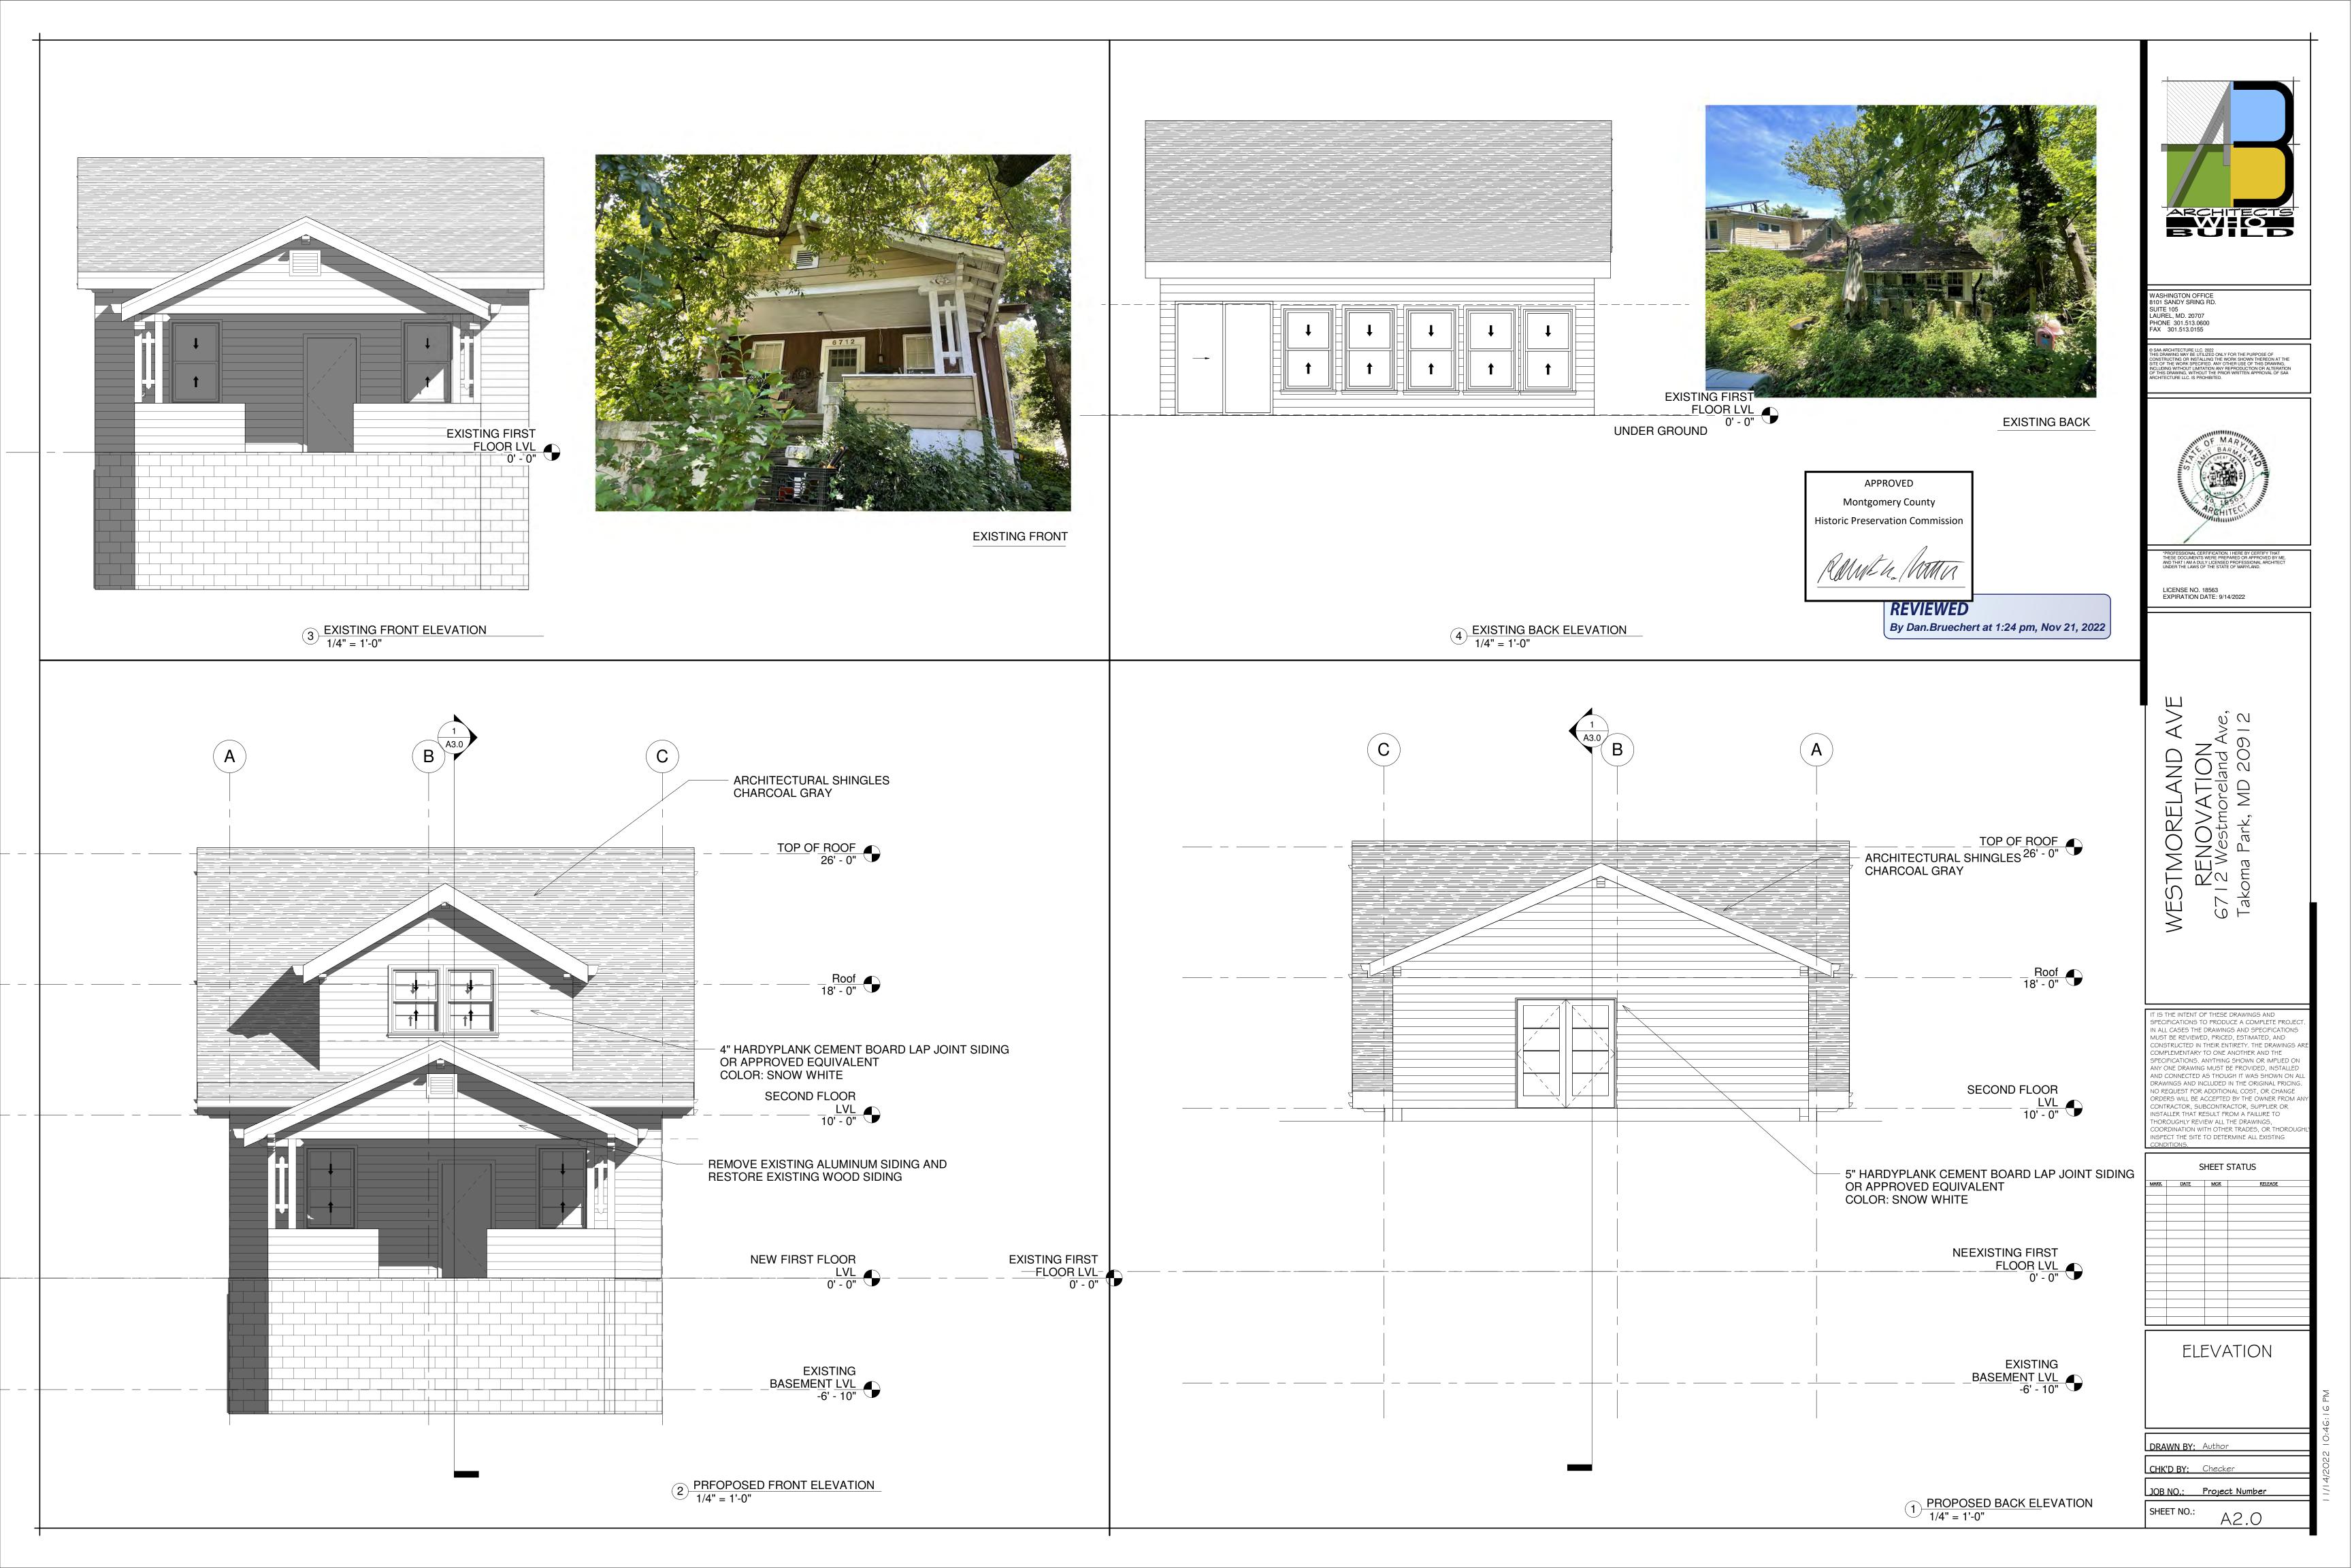


Montgomery County Historic Preservation Commission


MME H. MMM

REVIEWED By Dan.Bruechert at 1:24 pm, Nov 21, 2022

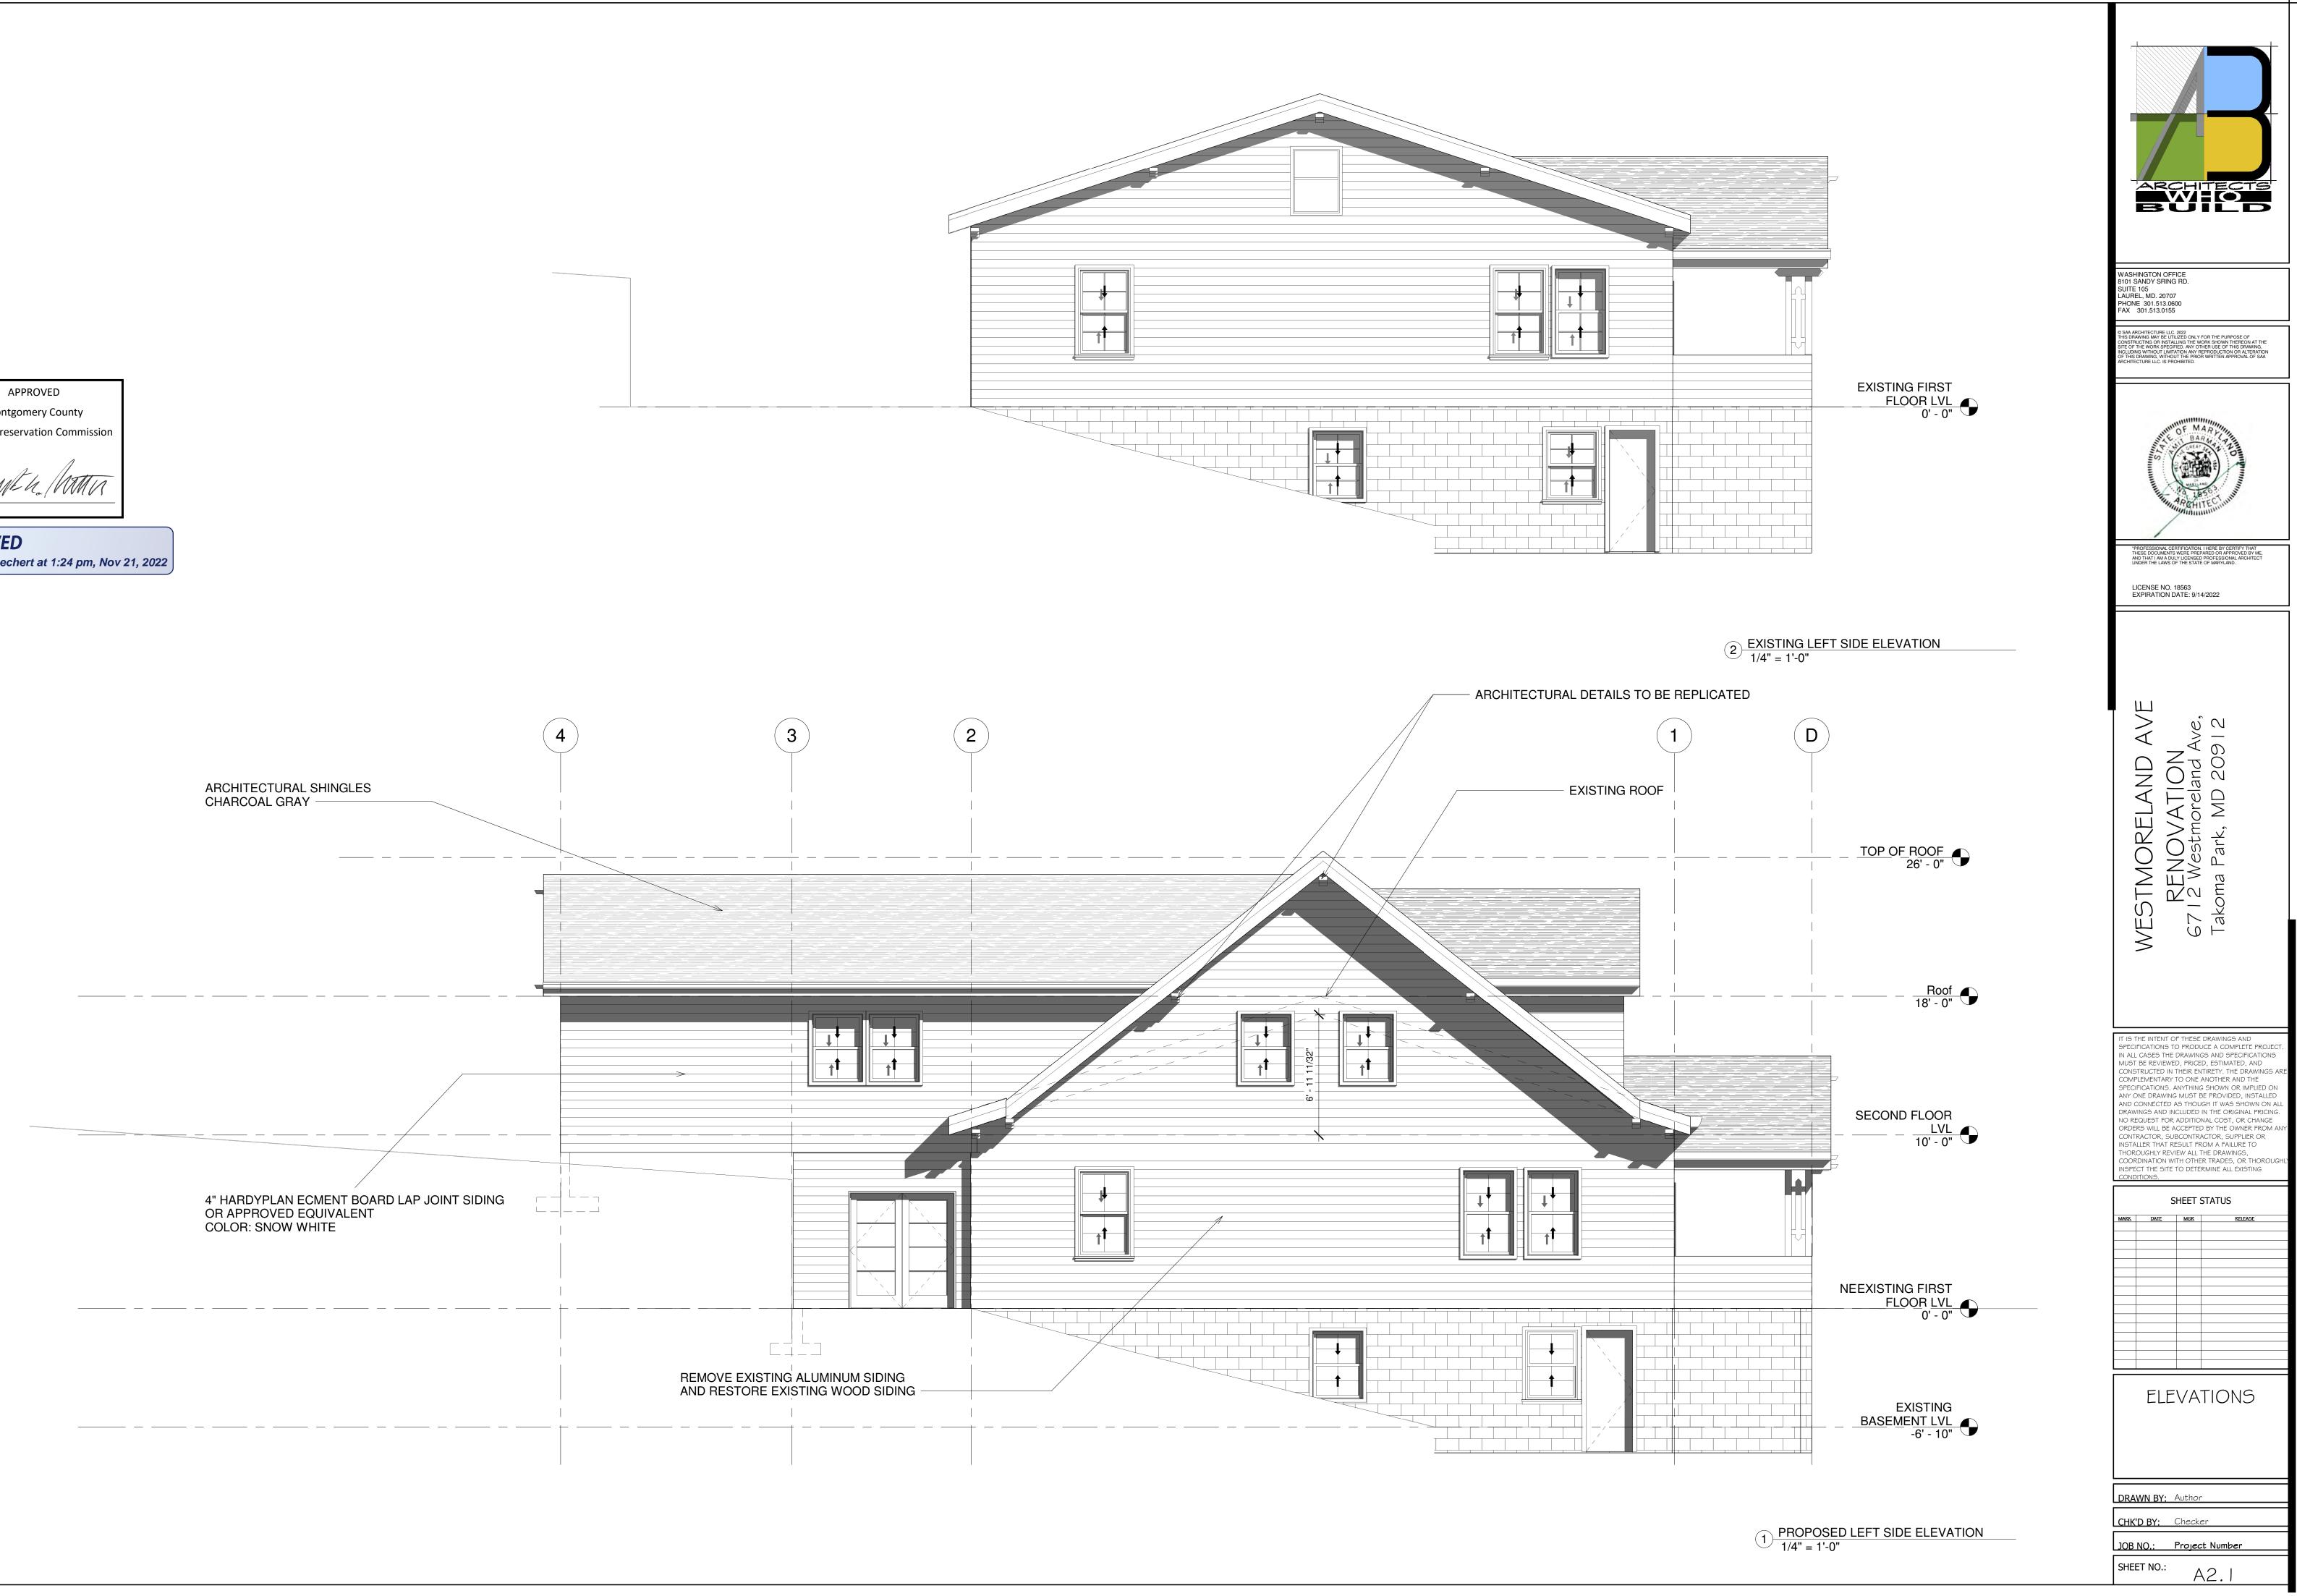

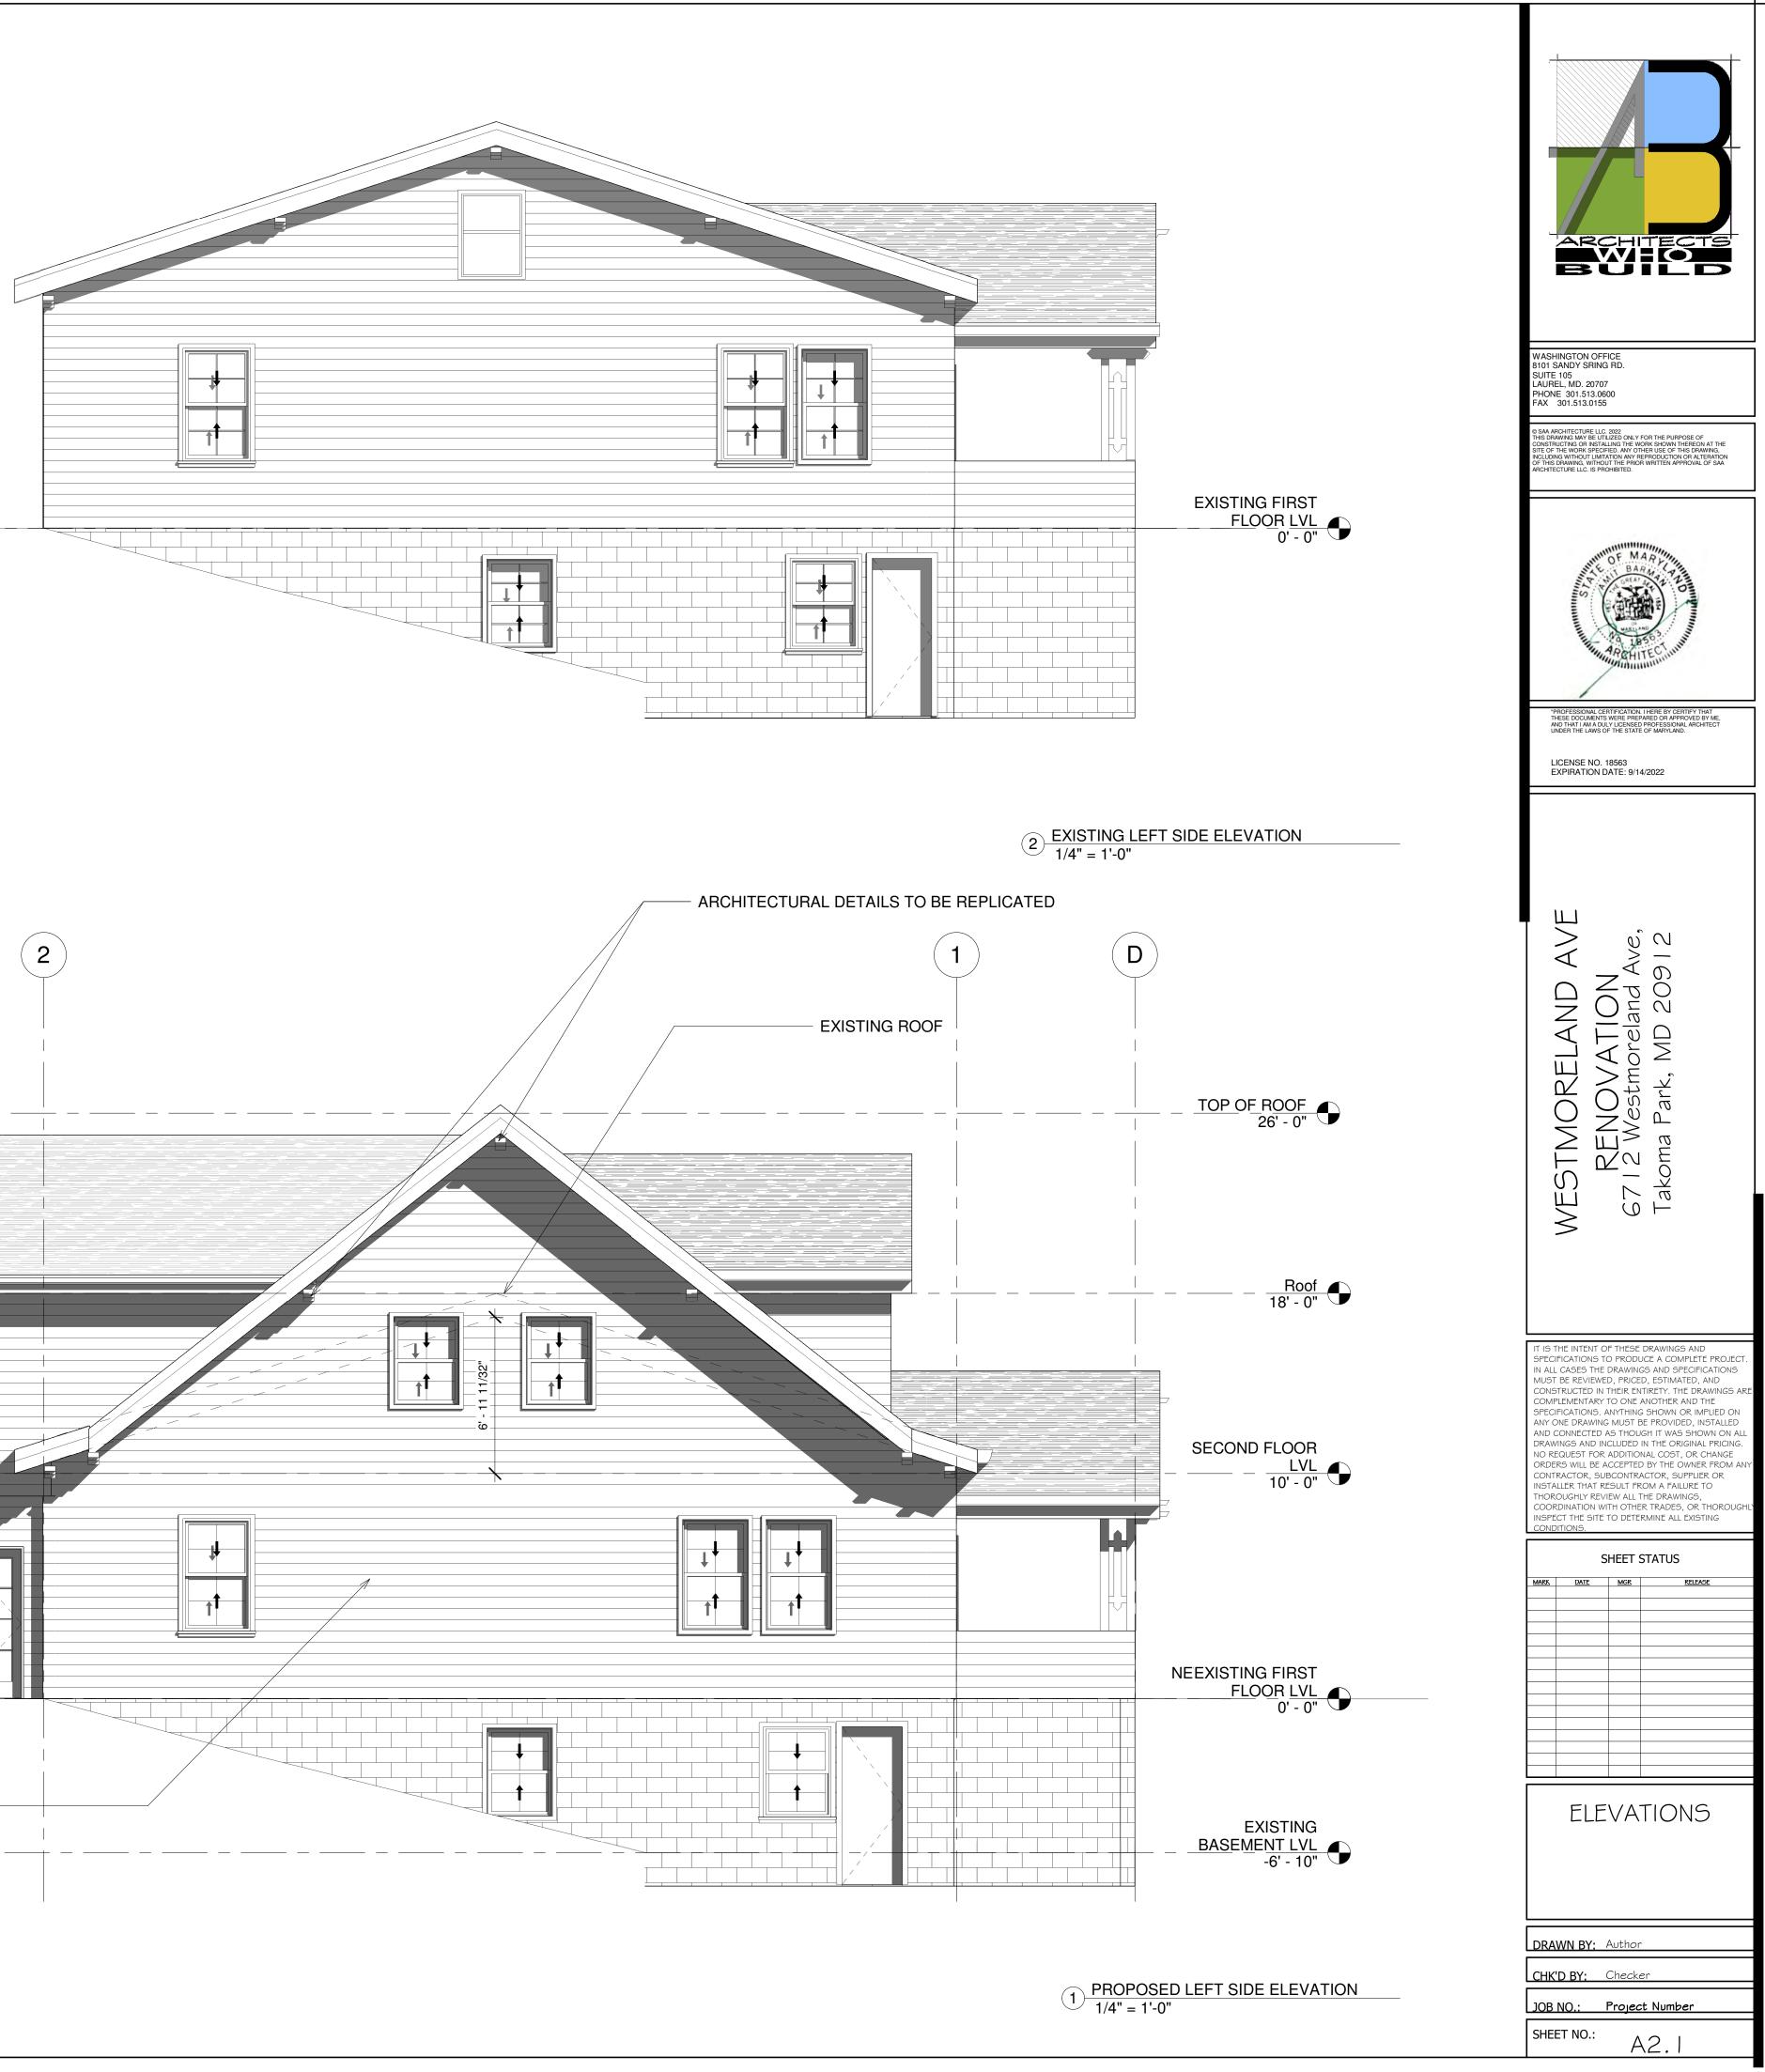



			F	
		↓		

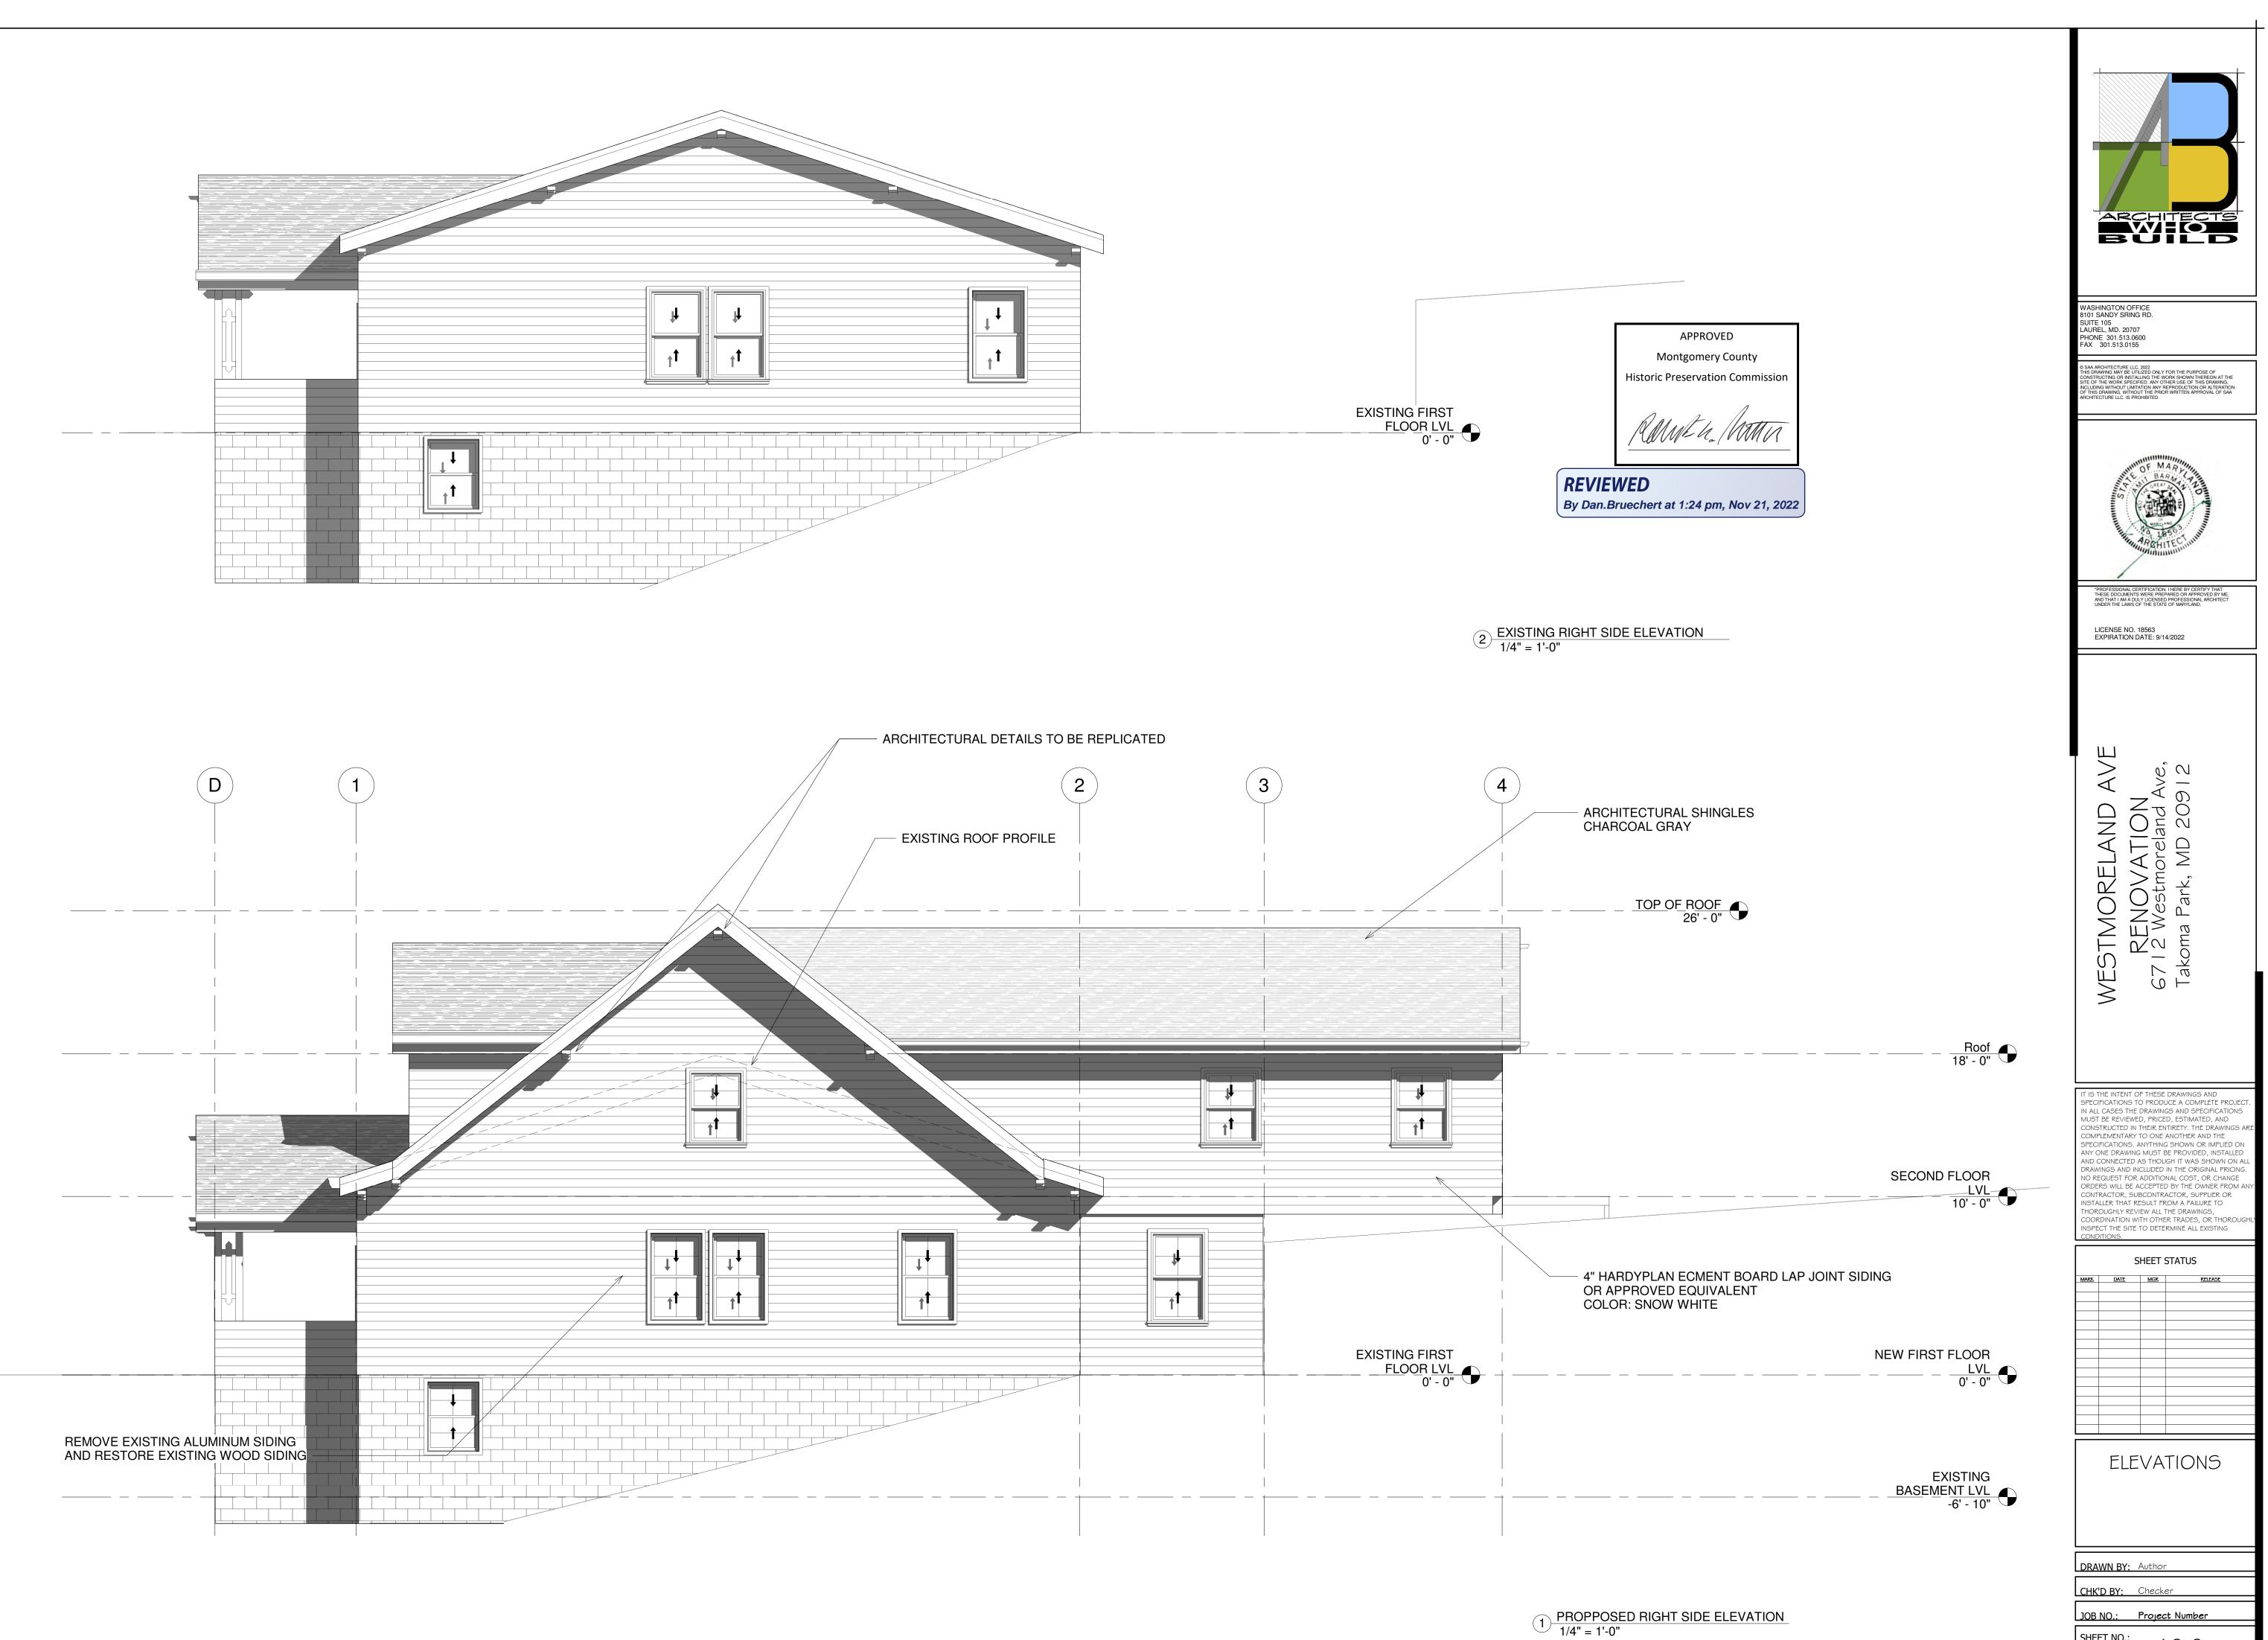


SHEET NO .:

A2.2

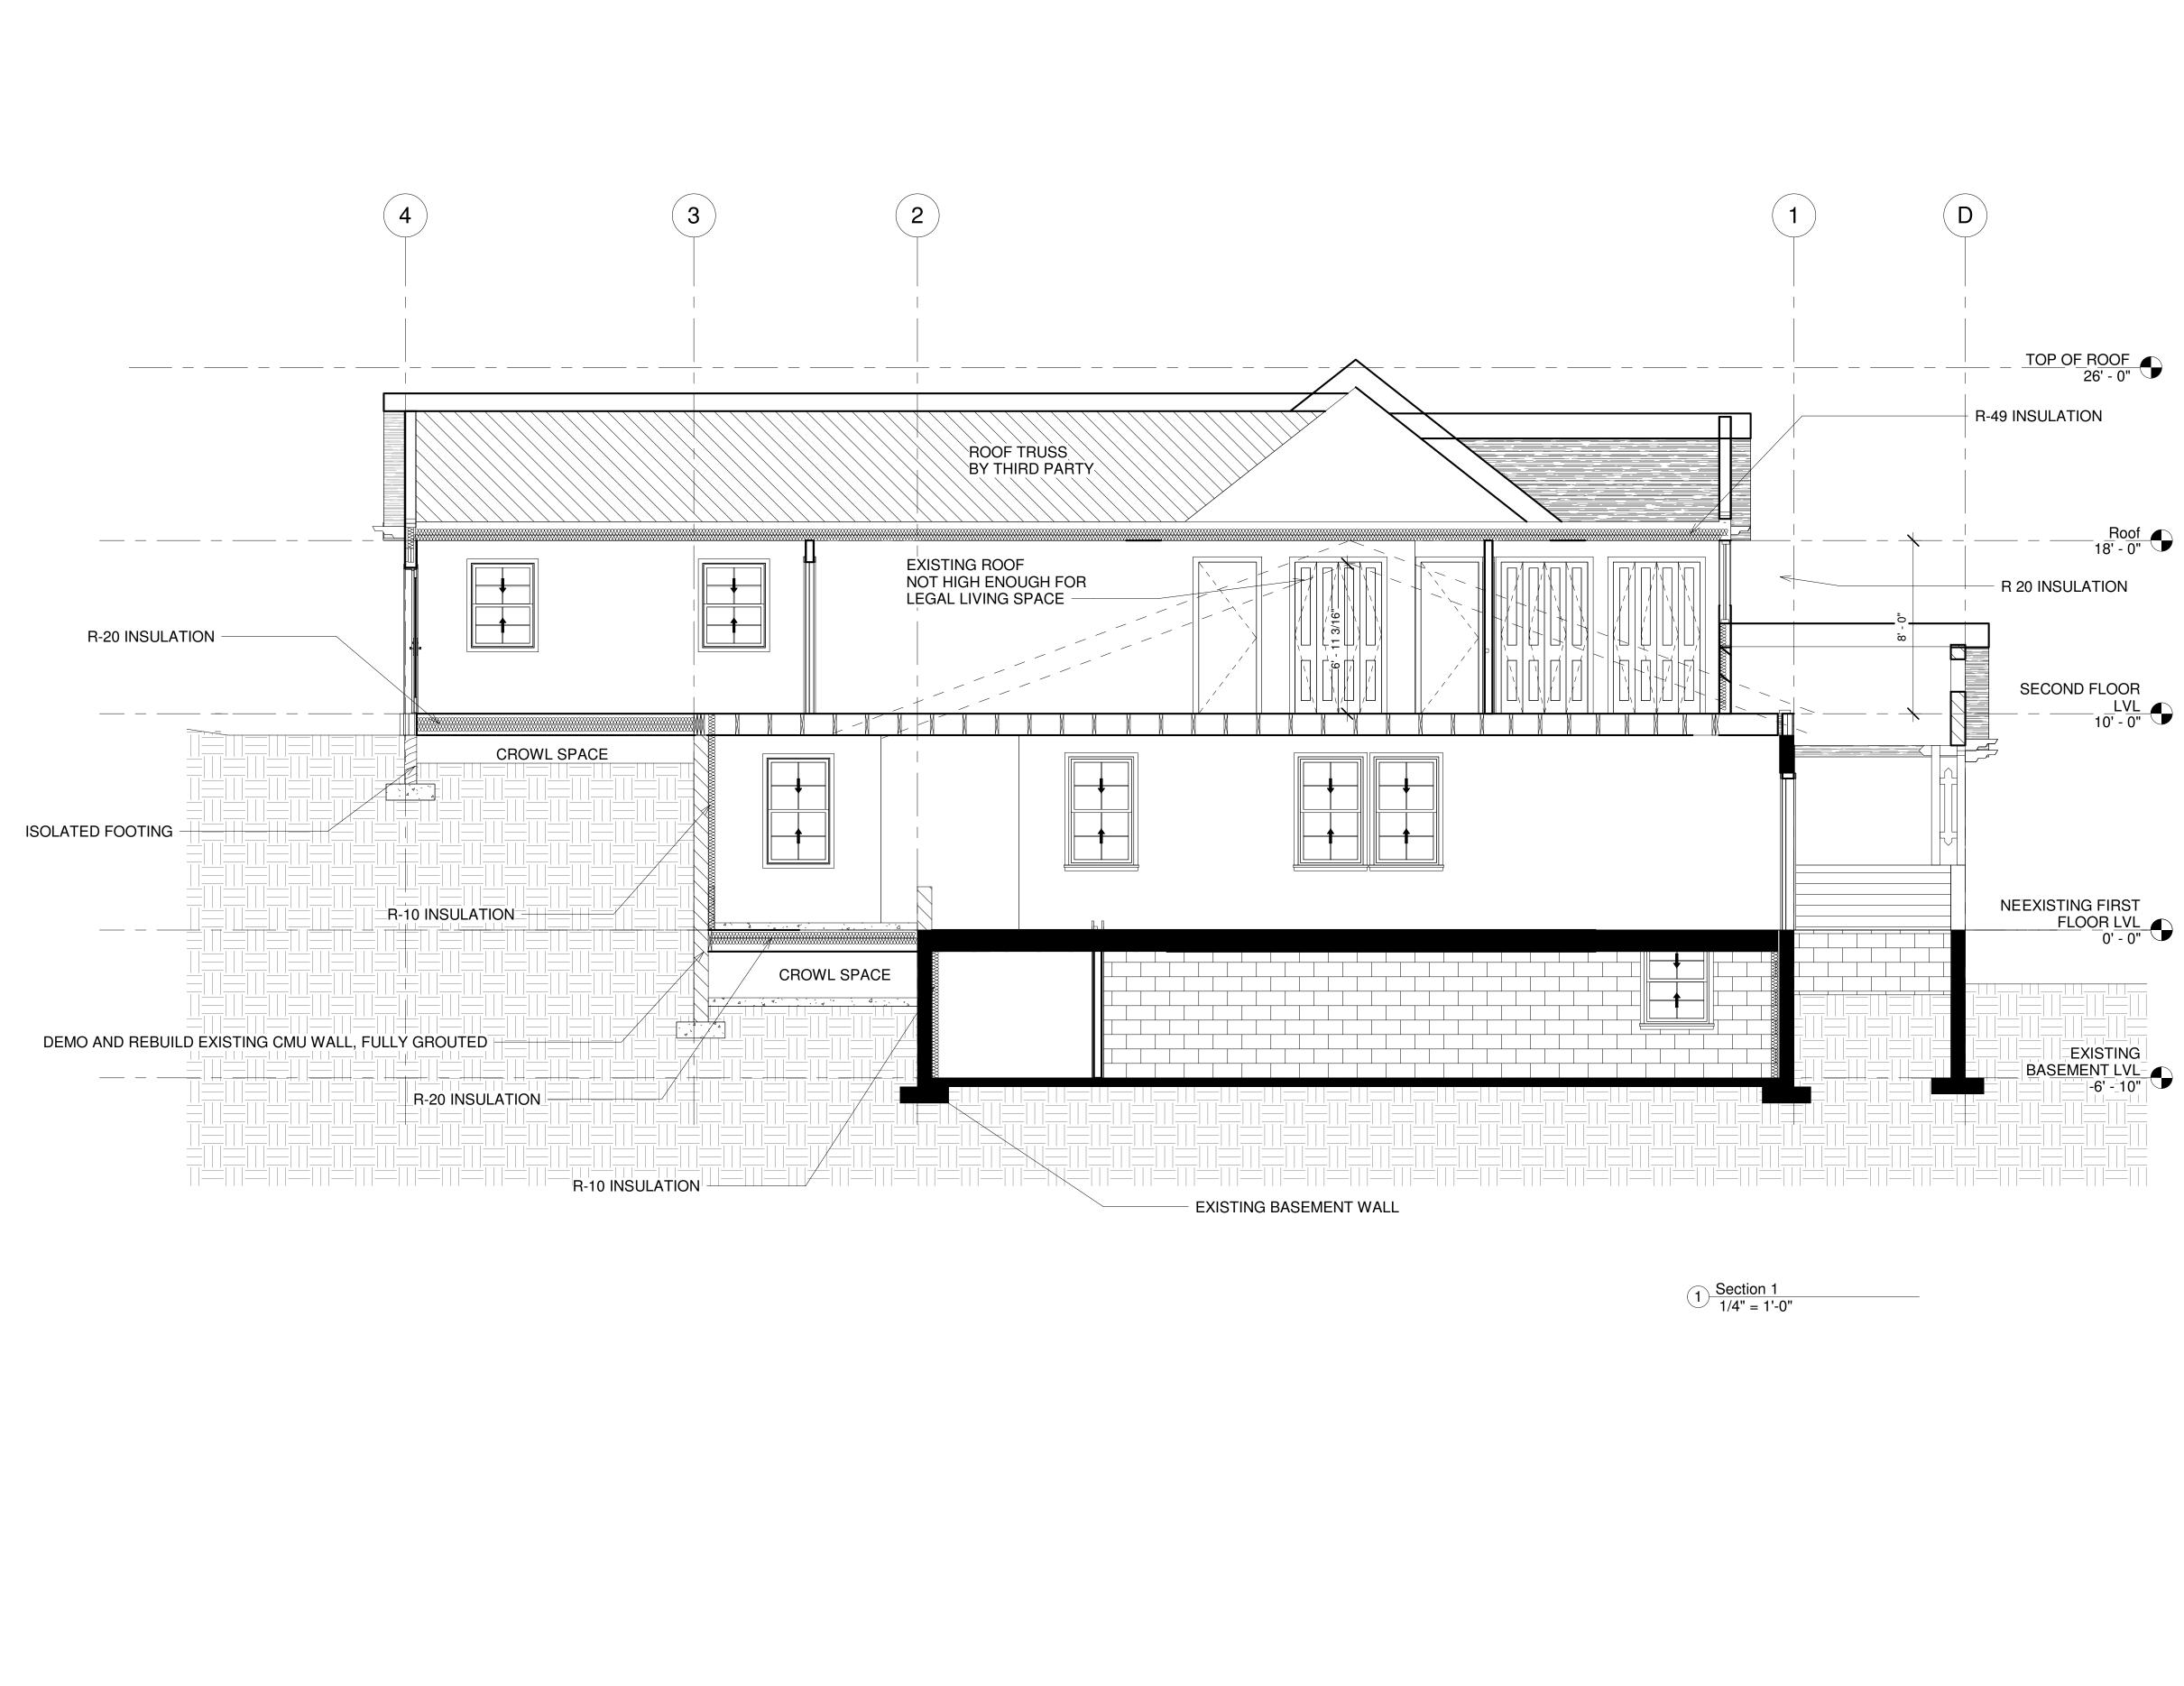

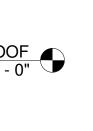




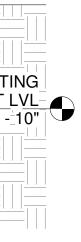

APPROVED Montgomery County Historic Preservation Commission

MMEL. WATTIS

REVIEWED By Dan.Bruechert at 1:24 pm, Nov 21, 2022

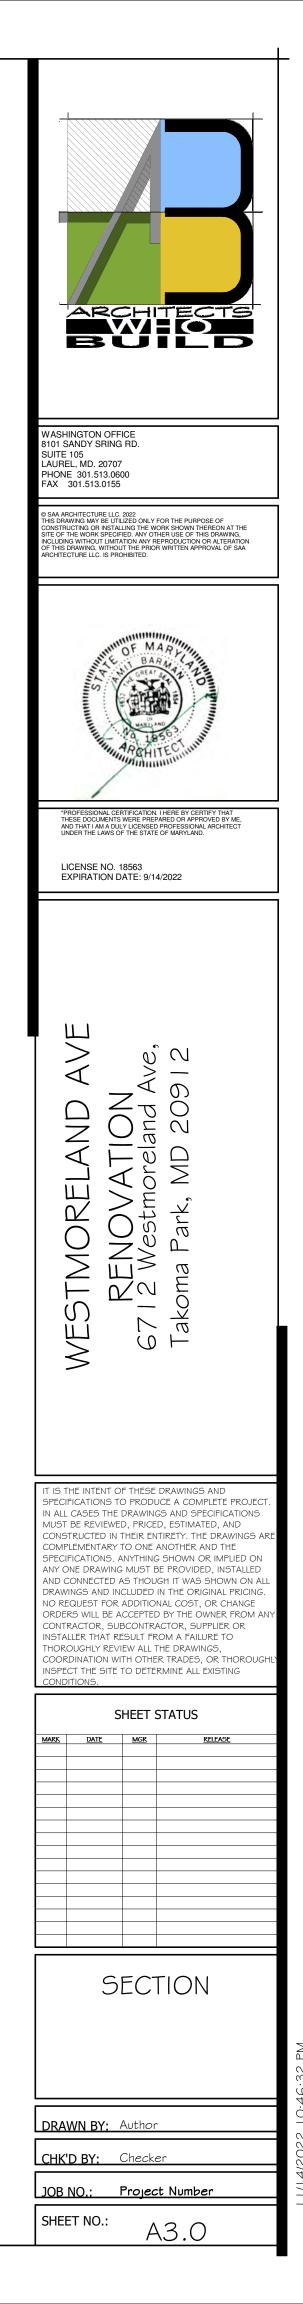

1. INTERNATIONAL RESIDENTIAL BUILDING CODE- 2018 EDITION

<u>GENERAL NOTES</u>:

- WINDOWS IN ALL BEDROOMS ARE DOUBLE HUNG. WHEN THE LOWER SASH IS RAISED FROM INSIDE THESE WINDOWS THEY PROVIDE EMERGENCY AND RESCUE OPENINGS THAT ARE
- THE BOTTOM OF THE EGRESS WINDOW OPENING CAN'T EXCEED 44" FROM THE FINISHED FLOOR.
- THE MINIMUM OPENING AREA OF THE EGRESS WINDOW IS 5.7 SQUARE FEET. • THE MINIMUM EGRESS WINDOW OPENING HEIGHT IS 24" HIGH.
- THE MINIMUM EGRESS WINDOW OPENING IS 20" WIDE.
- 2. SMOKE DETECTOR AND CARBON MONOXIDE DETECTOR LOCATIONS ARE AS SHOWN ON PLANS.
- 3. ALL NEW EXTERIOR LOAD BEARING WALLS ARE 2X6" STUDS @ 16" O/C WITH $\frac{5}{8}$ " SHEATHING BOARDS ON EXTERIOR AND $\frac{1}{2}$ " GB ON INSIDE FACE.
- ALL INTERIOR NON LOAD BEARING WALLS ARE 2"X4" STUDS @ 16" O/C WALLS 5. WITH $\frac{1}{2}$ " GB ON EACH FACE EXCEPT NOTED OTHERWISE.
- 6. NEW SECOND FLOOR AND ROOF AS SHOWN ON STRUCTURAL PLAN.
- 7. SEE STRUCTURAL DRAWINGS FOR FLOOR FARMING INCLUDING LOAD BEARING WALLS LOCATIONS.
- 8. ALL NEW DOORS AND WINDOWS ARE AS SHOWN ON PLANS AND FRAMING CONTRACTOR SHALL PROVIDE OPENING INTO WALLS WITH HEADERS AND JAMS PER CODE AND DETAILS.
- THE CONTRACTOR SHALL VERIFY ALL EXISTING DIMENSIONS PRIOR TO CONSTRUCTION.
- 10. ALL DIMENSIONS, LOCATIONS AND ELEVATIONS OF STRUCTURES SHOWN ON THE CONTRACT DRAWINGS SHALL BE VERIFIED IN THE FIELD BY THE CONTRACTOR. ALL DISCREPANCIES SHALL BE BROUGHT TO THE ATTENTION OF THE ENGINEER BEFORE PROCEEDING WITH THE WORK.
- 11. ALL WORK SHALL BE DONE ACCORDANCE WITH MONTGOMERY COUNTY BUILDING CODE.
- 12. THE CONTRACTOR SHALL HOLD HARMLESS THE ARCHITECT/ENGINEER FROM AND AGAINST ALL CLAIMS, DAMAGES, LOSSES AND EXPANSES INCLUDING ATTORNEY'S FEE ARISING FROM THE PERFORMANCE OF THE WORK DONE BY THE CONTRACTOR.
- 13. ALL WORK AND MATERIALS SHALL MEET THE REQUIREMENTS OF THE LOCAL AND STATE BUILDING CODES AND THE SPECIFICATIONS OF THE NATIONAL BOARD OF UNDERWRITERS. THE DRAWINGS SHOWING THE GENERAL GREEMENTS AND EXTENT OF WORK. AS THE WORK PROGRESSES THE CONTRACTOR AT NO EXTRA COST SHALL MAKE MODIFICATIONS TO MAKE PART ALIGN.
- 14. CHANGES TO THE PLAN BY THE CONTRACTOR SHALL BE THE RESPONSIBILITY OF THE PERSONS MAKING SUCH CHANGES. CONTRACTOR SHALL CHECK AND VERIFY ALL PLAN DIMENSIONS AND CONDITIONS BEFORE PROCEEDING WITH CONSTRUCTION.
- 15. DO NOT SCALE DRAWINGS. ALL WRITTEN DIMENSIONS SHALL GOVERN.
- 16. IT IS THE RESPONSIBILITY OF THE CONTRACTOR TO INSURE PROPER INSTALLATION OF ALL METAL FASTENERS PER MANUFACTURER'S SPECIFICATIONS.
- 17. STRUCTURAL DRAWINGS SHALL BE USED IN CONJUNCTION WITH ARCHITECTURAL DRAWINGS FOR BIDDING AND CONSTRUCTION. CONTRACTOR SHALL VERIFY DIMENSIONS AND CONDITIONS FOR COMPATIBILITY AND SHALL NOTIFY ARCHITECT ON ANY DISCREPANCIES PRIOR TO CONSTRUCTION.
- 18. CONTRACTOR SHALL VERIFY ALL EXISTING CONDITIONS PRIOR TO COMMENCING WORK AND DETERMINE THE LOCATION OF ALL ADJACENT UNDERGROUND UTILITIES PRIOR TO COMMENCING EXCAVATION AND NOTIFY ARCHITECT OF DISCREPANCIES AND CONFLICTS.
- 19. CONTRACTOR SHALL PROVIDE TEMPORARY BRACING FOR THE STRUCTURE AND STRUCTURAL COMPONENTS UNTIL ALL FINAL CONNECTIONS HAVE BEEN COMPLETE IN ACCORDANCE WITH THE PLANS.
- 20. CONTRACTOR SHALL BE RESPONSIBLE FOR ALL SAFETY PRECAUTIONS AND THE METHODS, TECHNIQUES, SEQUENCES OR PROCEDURES REQUIRED TO PERFORM THE WORK. THE STRUCTURAL ENGINEER HAS NO OVERALL SUPERVISIONS/AUTHORITY OR ACTUAL AND/OR DIRECT RESPONSIBILITY FOR THE SPECIFIC WORKING CONDITIONS AT THE SITE AND/OR ANY HAZARDS RESULTING FROM THE ACTIONS OF ANY TRADE CONTRACTOR. THE STRUCTURAL ENGINEER HAS NO DUTY TO INSPECT, SUPERVISE, NOTE, CORRECT, OR REPORT ANY HEALTH OR SAFETY DEFICIENCIES OF THE OWNER, CONTRACTORS, OR OTHER ENTITIES OR PERSONS AT THE PROJECT SITE.

CONC	CRETE:
1.	REINFORCED CONCRETE SHALL BE DETAILED AND CONSTRUCTED IN ACCORDANCE WITH AMERICAN CONCRETE INSTITUTE, (ACI 301) "SPECIFICATION FOR STRUCTURAL CONCRETE FOR BUILDINGS" AND ACI 318 "BUILDING CODE REQUIREMENTS FOR STRUCTURAL CONCRETE".
2.	NEW CONCRETE FOR FOOTING AND FILLED IN CMU SHALL BE MINIMUM OF 3000 PSI AT 28 DAYS.
3.	ALL REINFORCEMENT SHALL CONFORM TO ASTM SPECIFICATION A185.
4.	NEW FOOTING AND SLAB SHALL BE POURED ON 4" GRAVEL OR CR6 AS SHOWN ON SECTION.
5.	NEW ROOF SHALL BE CONSTRUCTED ACCORDING WITH STRUCTURAL FRAMING PLAN AND ARCHITECTURAL DETAILS.
6.	THE OWNER SHALL RETAIN THE SERVICES OF A SOIL CONSULTANT APPROVED BY THE ARCHITECT TO CHECK AND VERIFY THE REQUIRED SOIL BEARING PRESSURE OF EACH FOOTING.
7.	ALL CONTINUOUS REINFORCING SHALL BE SPLICED WITH "B" SPLICE STAGGERED, UNLESS NOTED OTHERWISE. FOOTING AND OTHER CONRETE POURED AGAINST EARTH -3 "
8.	FORMED CONRETE EXPOSED TO EARTH -2 " FOR BEARS LARGER THAN #5, 1/2" FOR #5 AND SMALLER BARS.
9.	WHERE DISCREPANCIES EXIST BETWEEN THE STANDARD COMMENTS, NOTES FROM THE DESIGN PROFESSIONAL OR THE CODE, THE MOST RESTRICTIVE SHALL APPLY. ALL CONSTRUCTION SHALL COMPLY WITH THE 2015 INTERNATIONAL RESIDENTIAL CODE (IRC).
10.	FOUNDATION WALLS ENCLOSING BASEMENTS OR OTHER HABITABLE SPACE SHALL BE DAMPPROOFED PER IRC — WHERE A HIGH WATER TABLE OR OTHER SEVERE WATER CONDITION EXISTS, THE WALLS SHALL BE WATERPROOFED.
11.	PROVIDE A MINIMUM 4-INCH PERFORATED DRAIN AROUND USABLE SPACE BELOW GRADE OR OTHER EQUIVALENT MATERIALS PER IRC THE PIPE SHALL BE COVERED WITH NOT LESS THAN 6 INCHES OF WASHED GRAVEL OR CRUSHED ROCK. THE DRAIN SHALL DAYLIGHT TO THE EXTERIOR BELOW THE FLOOR LEVEL OR TERMINATE IN A MINIMUM 20-GALLON SUMP PIT.
12.	INTERIOR BEARING WALLS AND COLUMNS SHALL BE ISOLATED FROM THE BASEMENT FLOOR SLAB.
13.	AT WALKOUTS THE FOUNDATION WALL SHALL BE INSULATED WITH A MINIMUM R -13 INSULATION FOR A MINIMUM OF 3 FEET BELOW THE BOTTOM OF THE SLAB.
14.	ANCHOR BOLTS – MINIMUM $1/2$ -INCH ANCHOR BOLTS WITH 7" EMBEDMENT AT MAXIMUM 6 FEET O.C. AND WITHIN 6 INCHES OF THE END OF EACH SILL PLATE.
15.	WHERE FLOOR JOISTS ARE PARALLEL TO THE FOUNDATION WALL, THE WALL SHALL

15. WHERE FLOOR JOISTS ARE PARALLEL TO THE FOUNDATION WALL, THE WALL SHALL BE SUPPORTED LATERALLY AT THE TOP BY SOLID BLOCKING FOR A MINIMUM OF TWO JOIST SPACES, SPACED NOT MORE THAN 2'-10" FEET O.C.

CONCRETE SHALL BE DETAILED AND CONSTRUCTED IN ACCORDANCE
CAN CONCRETE INSTITUTE, (ACI 301) "SPECIFICATION FOR STRUCTURAL
FOR BUILDINGS" AND ACI 318 "BUILDING CODE REQUIREMENTS FOR
CONCRETE".

WOC	D NOTES:	
1.	FRAMING LUMBER SHALL BE KILN D COMFORMANCE WITH WCLIB STANDAR NO. 17, LATEST EDITION. ALL WOOD STANDARDS OR THE IBC AS A MINII MINIMUM STANDARDS:	RD GRADING RULES FOR WEST COAS FRAME CONSTRUCTION SHALL CON
	JOISTS: (2X8 AND SMALLER)	HEM-FIR NO. 2 MINIMUM BASE VALUE, FB=850 PS
	BEAMS AND STRINGERS: (2X10 AND LARGER)	DOUGLAS FIR NO. 1 MINIMUM BASE VALUE, FB=1350 P
	POSTS AND TIMBERS: (4X4 AND LARGER)	DOUGLAS FIR NO. 2 MINIMUM BASE VALUE, FB=1200 P
	STUDS, PLATES & MISC. FRAMING:	DOUGLAS FIR OR HEM—FIR STANDARD GRADE
	TOP AND BOTTOM PLATES AT BEARING WALLS GRADE	DOUGLAS FIR-LARCH CONSTRUCTIO
	2X6 STUDS AND PLATES:	HEM-FIR NO.3/ STUD GRADE
2.	ENGINERRED LUMBER SHALL BE INS	TALLED PER MANUFACTURER'S SPEC
3.	ENGINEERED LUMBER MEMBERS SHA THE NATIONAL RESEARCH BOARD. E NOTING THE NAME AND PLANT NUM NATIONAL RESEARCH BOARD NUMBE LUMBER SHALL BE MANUFACTURED REPORT AND GLUED WITH A WATERI OF ASTM D2559 WITH ALL GRAIN P	ACH PIECE SHALL BEAR A STAMP (BER OF THE MANUFACTURER, THE (R, AND THE QUALITY CONTROL AGEI IN ACCORDANCE WITH THE APPROP PROOFING ADHESIVE MEETING THE F
	PSLFB=2900PSIE=2000LVLFB=2600PSIE=1900LSLFB=1700PSIE=1300	PSI FV =290 PSI NER-292 PSI FV =285 PSI NER-126 PSI FV =150 PSI NER-481

4. DESIGN SHOWN ON PLANS IS BASED ON LUMBER MANUFACTURED E GEORGIA-PACIFIC. ALTERNATE MANUFACTURERS MAY BE USED SUBJE AND APPROVAL BY THE ARCHITECT AND STRUCTURAL ENGINEER. ALT HANGERS AND ORHER HARDWARE MAY BE SUBSITUTED FOR ITEMS THEY HAVE ICBO APPROVAL FOR EQUAL OR GREATER LOAD CAPACIT HANGERS AND OTHER HARDWARE SHALL BE COMPATIBLE IN SIZE WI PROVIDED.

GLUED LAMINATED MEMBERS SHALL BE FABRICATED IN CONFORMANC ANSI/AITC A190.1 AND ASTM D3737. EACH MEMBER SHALL BEAR AN IDENTIFICATION MARK AND SHALL BE ACCOMPANIED BY AN ATTIC CER CONFORMANCE. ALL SIMPLE SPAN BEAMS SHALL BE DOUGLAS FOR 24F-V4, FB=2400 PSI, FV=190 PSI. CAMBER ALL GLULAM BEAMS FOOR RADIUS UNLESS NOTED OTHERWISE ON THE PLANS.

ALL WOOD IN DIRECT CONTACT WITH CONRETE OR MASONRY SHALL PRESSURE-TREATED WITH AN APPROVED PRESERVATICE OR (2) LAYE IMPREGNATED BUILDING PAPER SHALL BE PROVIDED BETWEEN UNTRE AND CONCRETE OR MASONRY. ALL WOOD EXPOSED TO WEATHER WIT ADEQUATE PROTECTION OF A ROOF OR EAVE SHALL BE APPROVED NATURAL RESISTANCE TO DECAY OR PRESSURE TREATED. SUCH MEM HORIZONTAL MEMBERS SUCH AS GIRDERS, JOISTS, DECKING, OR VER SUCH AS POSTS. POLES AND COLUMNS.

PLYWOOD SHEATHING SHALL BE GRADE C-D, EXTERIOR GLUE OR STI II, EXTERIOR GLUE SHALL BE IN CONFORMANCE WITH APA STANDARD STRAND BOARD OF EQUIVALENT THICKNESS, EXPOSURE RATING AND MAY BE USED IN LIEU OF PLYWOOD.

FLAT 2X BLOCKING AT ALL UNFRAMED PLYWOOD PANEL EDGES AND EDGE NAILING SPECIFIED.

9. FLOOR SHEATHUNG SHALL BE $\frac{3}{4}$ " (NOM) WITH SPAN RATING 40/20

10. WALL SHEATHING SHALL BE $\frac{1}{2}$ " (NOM) WITH SPAN RATING $\frac{24}{3}$

11. PLYWOOD OOF AND FLOOR SHEATHING TO BE LAID UP WITH GRAIN TO SUPPORTS AND NAILED WITH 8D NAILS AT 6" O.C. TO FRAMED AND OVER STUD WALLS AS SHOWN ON PLANS AND AT 12" O.C. INTERMEDIATE SUPPORTS UNLESS NOTED OTHERWISE. PROVIDE APPRO EDGE CLIPS AT 16" O.C. AT UNBLOCKED ROOF SHEATHING EDGES. SHEATHING EDGES SHALL HAVE APPROVED TONGUE-AND-GROOVE JO BE SUPPORTED WITH SOLID BLOCKING. TOENAIL BLOCKING TO SUPPO @ 12" O.C. UNLESS NOTED OTHERWISE. AT BLOCKED FLOOR AND RO DIAPHRAGMS PROVIDE FLAT 2X BLOCKING AT ALL UNFRAMED PLYWOO EDGES AND NAIL WITH EDGE NAILING SPECIFIED.


12. FLOOR AND ROOF FRAMING: PROVIDE DOUBLE JOISTS AROUND ALL FLOORS OR ROOFS UNLESS OTHERWISE NOTED. PROVIDE SOLID BLOG BEARING JOINTS, TOENAIL JOISTS TO SUPPORTS WITH TWO 16D NAILS TIMBER JOISTS TO FLUSH HEADERS OR BEAMS WITH SIMPSON HANGERS.


13. ALL COLUMNS AND POSTS SUPPORTING BEAMS NOT SPECIFIED FOR SHALL CONSIST OF 2 STUDS SPIKE LAMINATED TOGATHER WITH 16D 0/C.

	WOOD FRAMING: 1. FRAMING LUMBER FOR BEAMS AND JOISTS SHALL HAVE FB= 1100 PSI, E=1,300.00, AND FOR STUDS AND POSTS, FC= 500 PSI, E = 1,200.000 PSI	
AND MARKED IN COAST LUMBER CONFORM TO THE THE FOLLOWING	2. PROVIDE 2–2 X 6 @ EACH SIDE OF OPENINGS UNLESS NOTED OTHERWISE. 3. ALL WOOD LINTEL SHALL BE 2–2 X 8 UNLESS OTHERWISE NOTED.	FRACONECKT
	4. PROVIDED CROSS-BRIDGING FOR JOISTS AT 8'-0" INTERVALS.	
PSI	5. WOOD JOISTS AND BEAMS SHALL NOT BE CUT OR DRILLED UNLESS SO AUTHORIZED BY THE ARCHITECT.	
0 PSI	6. PROVIDE APPROVED HURRICANE CONNECTIONS BETWEEN FRAMING MEMBERS.	
0 PSI	7. LUMBER IN CONTACT WITH MASONRY OR CONCRETE SHALL BE PRESSURE	
	TREATED AGAINST DECAY. 8. PROVIDED DOUBLE JOISTS BELOW NON-BEARING PARTITIONS PARALLEL TO JOISTS.	LEST 759 1389 5418 C.COM
CTION	9. FRAMING LUMBER SHALL HAVE 19% MAXIMUM MOISTURE CONTENT.	L CREST D 20759 418 138 374 5411
SHON	10. BRUSH PRESERVATIVE SOLUTION ON ALL EDGES THAT ARE CUT IN MEMBERS THAT ARE IN CONTACT WITH CONCRETE OR MASONRY.	HILL HILL (40) B8) ENCC
SPECIFICATIONS.	11. PROVIDE MANUFACTURERS' STANDARD JOIST OR STANDARD BEAM HANGERS	12430 FULTO FULTO FAX RARIE
A PROCESS BY P OR STAMPS HE GRADE, THE	AT WALL WOOD TO WOOD CONNECTIONS THAT REQUIRE JOISTS OR BEAMS FRAMING INTO THE SIDE OR FACE OF THE SUPPORTING MEMBER. THE CAPACITY OF THE HANGER SHALL BE FOR THE MAXIMUM SHEAR CAPACITY OF THE JOISTS OR BEAM.	0
AGENCY. ALL ROPRIATE NER		Gers
E REQUIREMENTS THE MEMBER.	PLYWOOD SHEATHING: 1. ALL PLYWOOD SHEATHING SHALL BE CD-GRADE, UNLESS OTHERWISE SHOWN, WITH EXTERIOR GLUE MANUFACTURED INACCORDANCE WITH PRODUCT STANDARD PS183, LATEST ADDITION, ROOF AND WALL SHEATHING.	ARCHITECTS ENGINEERS CONSTRUCTION MANAGERS
	2. PLYWOOD SHEATHING SHALL BE LAID WITH END JOINT STAGGERED.	ARCHITECTS ENGINEERS CONSTRUCTIO
BY THE ECT TO REVIEW TERNATE JOIST	3. BLOCK ALL WALL SHEATHING WITH 2X4 FLAT BLOCKING AT ALL EDGES.	AR EN CO
SHOWN PROVIDED TIES. ALL JOIST	4. LAYOUT PLYWOOD TO ELIMINATED ANY WIDTH LESS THAN 1'-0"	
ITH MEMBERS		
E WITH ND AITC		2 月
RTIFICATE OF COMINATION	DESIGN LOADS:	TERATION ELAND AVE MD 20912 HEDULES
TO A 2,000	FLOOR LIVE LOAD = 40 PSF FLOOR DEAD LOAD = 10 PSF	LTERAT ELAND MD 2(HEDUL
BE	STAIR LIVE LOAD = 100 PSF DECKS LIVE LOAD = 40 PSF	ALTERATION SELAND AV MD 2091 SCHEDULES
ERS OF ASPHALT EATED WOOD	ROOF LIVE LOAD = 40 PSF ROOF DEAD LOAD = 10 PSF	
THOUT THE WOOD OF	GROUND SNOW LOAD = 40 PSF WIND SPEED - 120 MPH MAX	N & N & STMO PARK AND S AND S
IBERS INCLUDE RTICAL MEMBERS	HANDRAIL – 200 LB CONCENTRATED LATERAL LOAD	
RUCTURAL DS. ORIENTED	SOIL BEARING CAPACITY = 2000 PSF	ADDITI(6712 W TAKOMA MA NOES
PANEL INDEX		67 GENERAL
NAIL WITH		GEN
		DISCLAIMER
PERPENDICULAR PANEL EDGES		PROFESSIONAL CERTIFICATION. I HEREBY CERTIFY THAT THESE DOCUMENTS WERE PREPARED
TO OVED PLYWOOD		OR OPPROVED BY ME, AND THAT I AM A DULY LICENSED PROFESSIONAL ENGINEER UNDER THE LAWS OF THE
ALL FLOOR DINTS OR SHALL		UNDER THE LAWS OF THE STATE OF MARYLAND, LICENSE NO. 23081 EXPIRATION DATE: 04/24/2023
ORTS WITH 16D ROOF		04/24/2023
OD PANEL		WORKSON OF MARY
OPENINGS IN		
CKING AT ALL S. ATTACH		10, 23081
METAL JOIST		Repair
SIZE ON PLAN		
NAILS AT 9"		REVISIONS
		PROJECT NUMBER
	APPROVED	R22-258
	Montgomery County	DRAWN BY
	Historic Preservation Commission	SP
		APPROVED BY
	ROUME La MATTIS	PP
	REVIEWED	11-11-22
	By Dan.Bruechert at 1:24 pm, Nov 21, 2022	ORIGINAL SHEET SIZE 36X24
		SHOULD MEASURE 1":
		PAGE
		01 OF 09
		DRAWING

S001

WA	LL SYMBOL	S
TYPE	DESCRIPTION	
	EXISITNG WALLS DEMOLITION	
	EXISTING WALLS	
	PROPOSED STUD WALL	
	NEW CMU WALL	

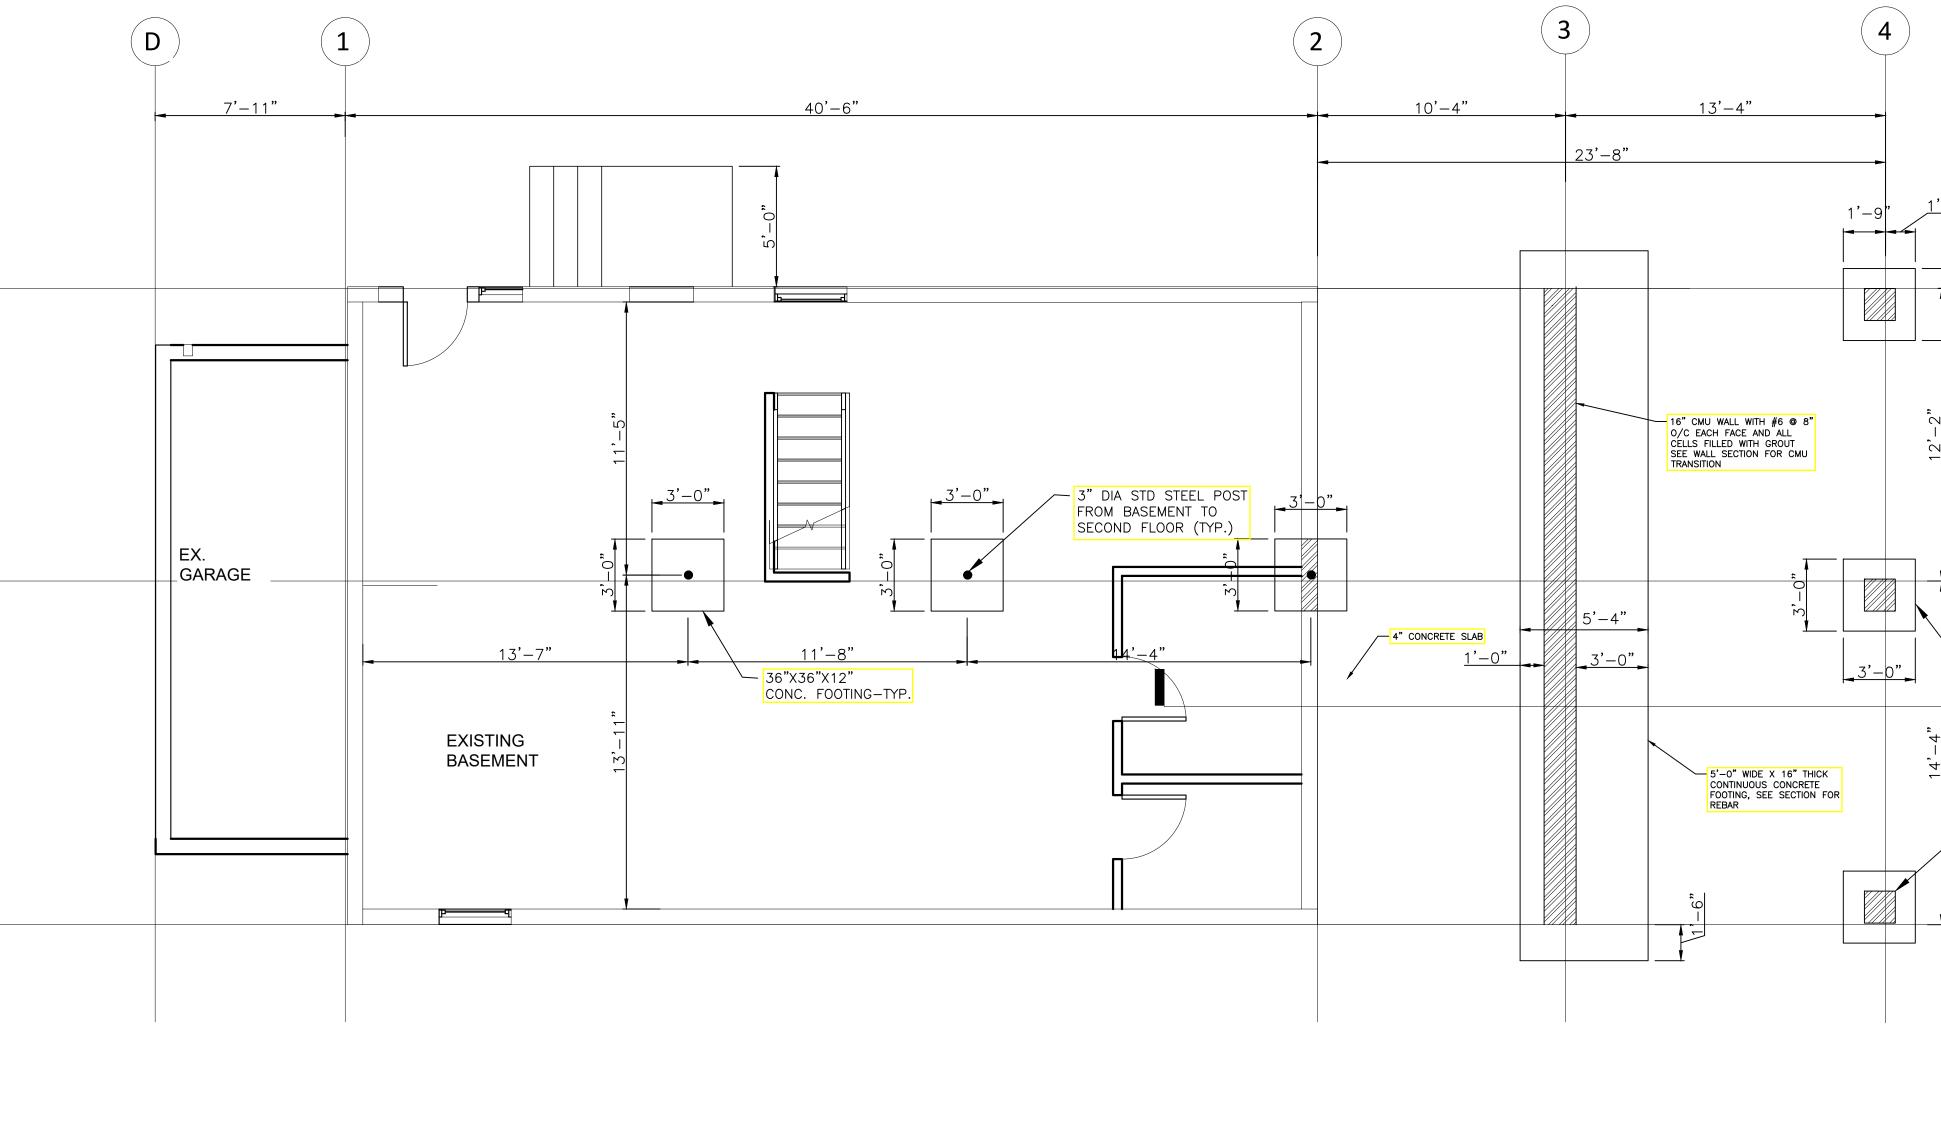

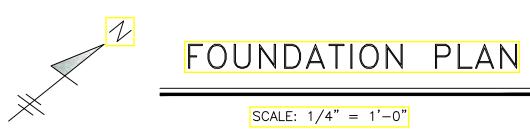



NOTES: 1. FOR GENERAL NOTES SEE DRAWING S1. 2. CONCRETE FOR THE FOOTING SHALL BE 3000 PSI @ 28 DAYS. 3. ALL NEW EXTERIOR STUD WALLS SHALL HAVE 2"X6" STUDS © 16" O/C. WITH 5/8" DRY WALL INSIDE FACE AND %" EXTERIOR SHEATHING BOARD ON EXTERIOR FACE. 4. ALL NEW INTERIOR STUD WALLS SHALL BE 2"X4" STUDS @ 16" O/C. WITH 5/8" DRY WALL ON BOTH SIDES EXCEPT NOTES OTHERWISE. 4. ALL WORK SHALL BE IN ACCORDANCE WITH MONTGOMERY COUNTY BUILDING CODE. ARENCO ARCHITECTS ENGINEERS CONSTRUCT ADDITION & ALTERATION PROJECT ADDRESS 6712 WESTMORELAND AVE TAKOMA PARK, MD 20912 (**A**) DISCLAIMER PROFESSIONAL CERTIFICATION. I HEREBY CERTIFY THAT THESE DOCUMENTS WERE PREPARED OR APPROVED BY ME, AND THAT I AM A DULY LICENSED PROFESSIONAL ENGINEER UNDER THE LAWS OF THE STATE OF MARYLAND, LICENSE NO. 23081 EXPIRATION DATE: 04/24/2023 B THE OF MARY \searrow No. 23081 - 36"X36"X12" CONC. FOOTING-TYP. 6 S05 <u>REVISIONS</u> PROJECT NUMBER / 16"X16 CMU PIER WITH 4 #5 VERTICAL BARS (TYP) R22-258 DRAWN BY C SP APPROVED APPROVED BY PP Montgomery County **Historic Preservation Commission** DATE 11-11-22 MMEh./MMA ORIGINAL SHEET SIZE 36X24 SHOULD MEASURE 1": REVIEWED PAGE By Dan.Bruechert at 1:24 pm, Nov 21, 2022 02 OF 09


<u>DRAWING</u>

	WΑ			S	Y	Μ	В	\bigcirc		S
--	----	--	--	---	---	---	---	------------	--	---

TYPE	DESCRIPTION
	EXISITNG WALLS DEMOLITION
	EXISTING WALLS
	PROPOSED STUD WALL
	NEW CMU WALL

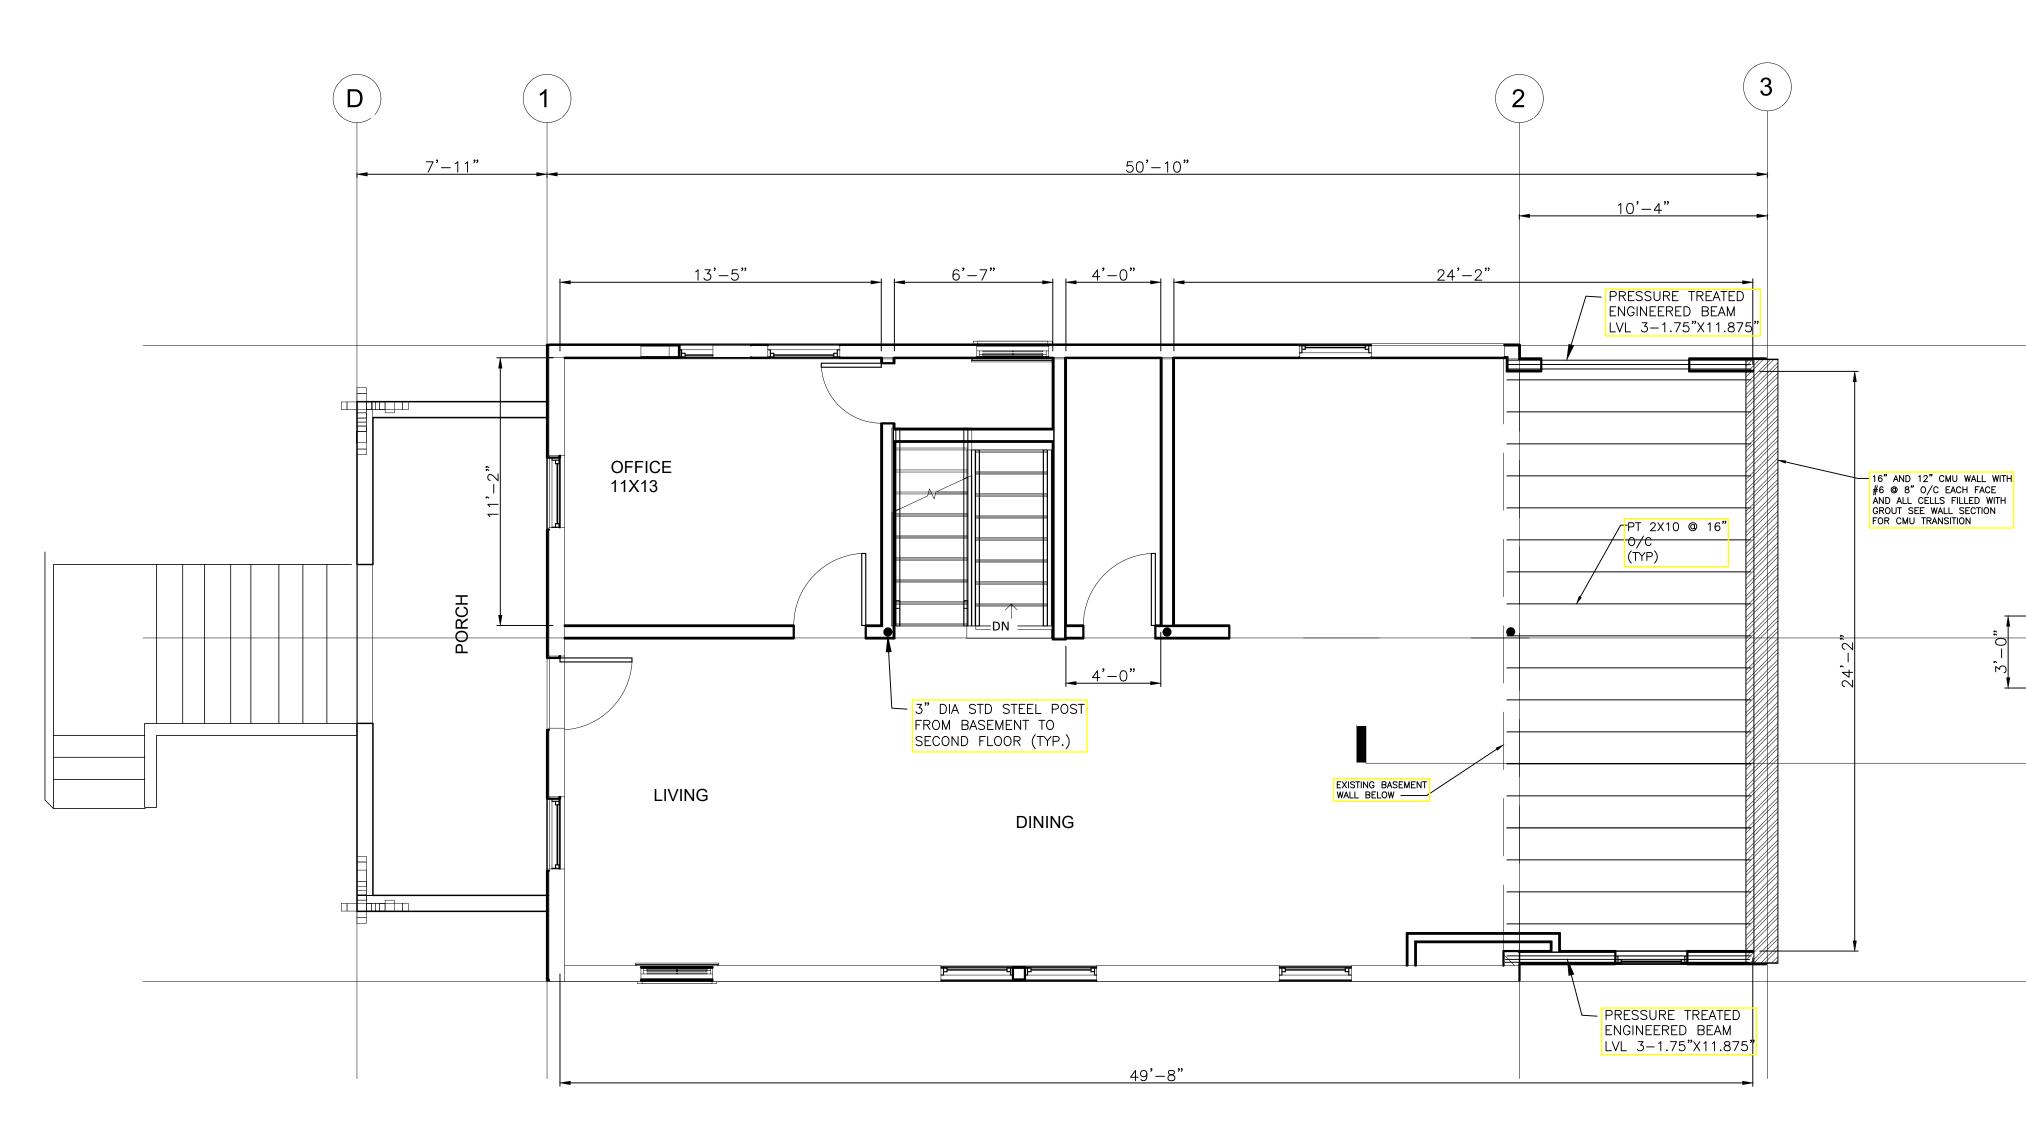


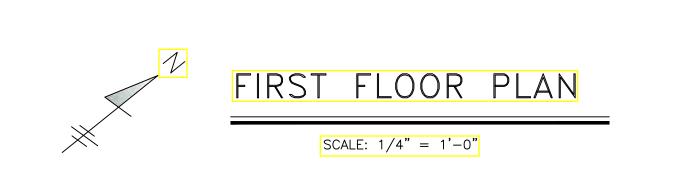


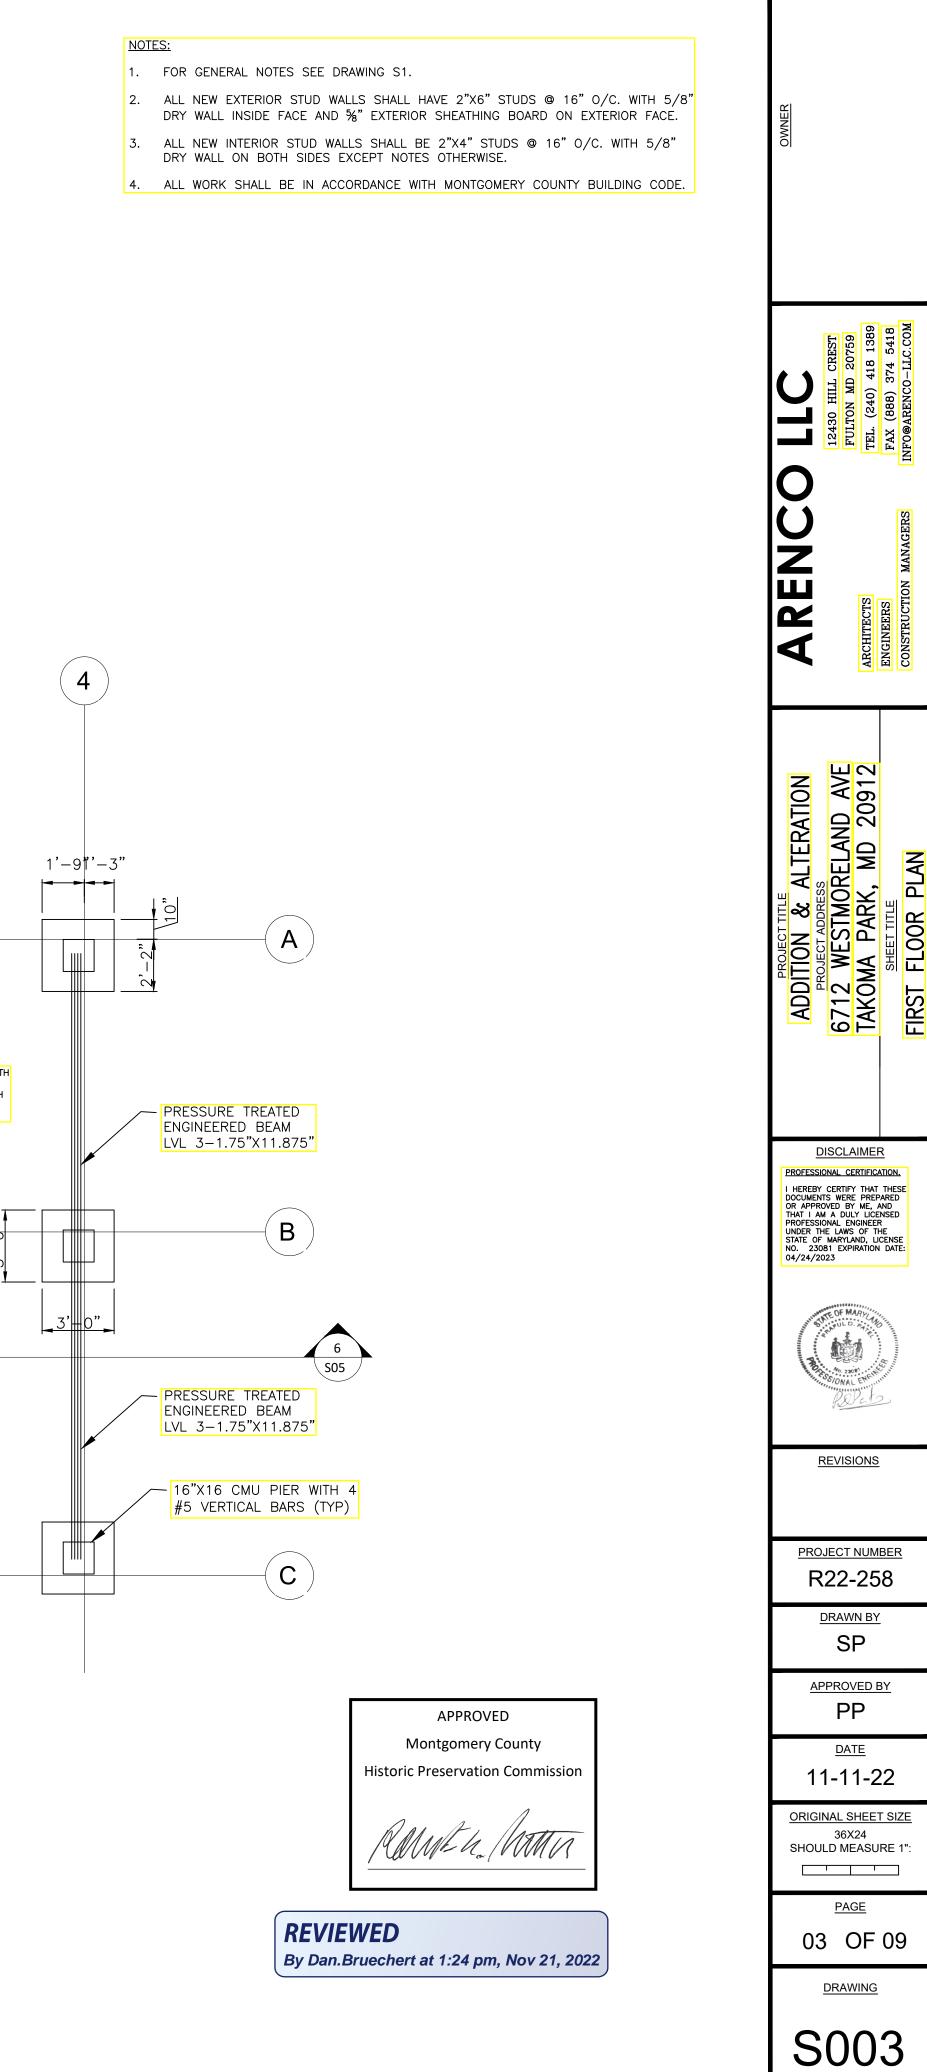

WALL SYMBOLS

TYPE	DESCRIPTION
	EXISITNG WALLS DEMOLITION
	EXISTING WALLS
	PROPOSED STUD WALL
	NEW CMU WALL

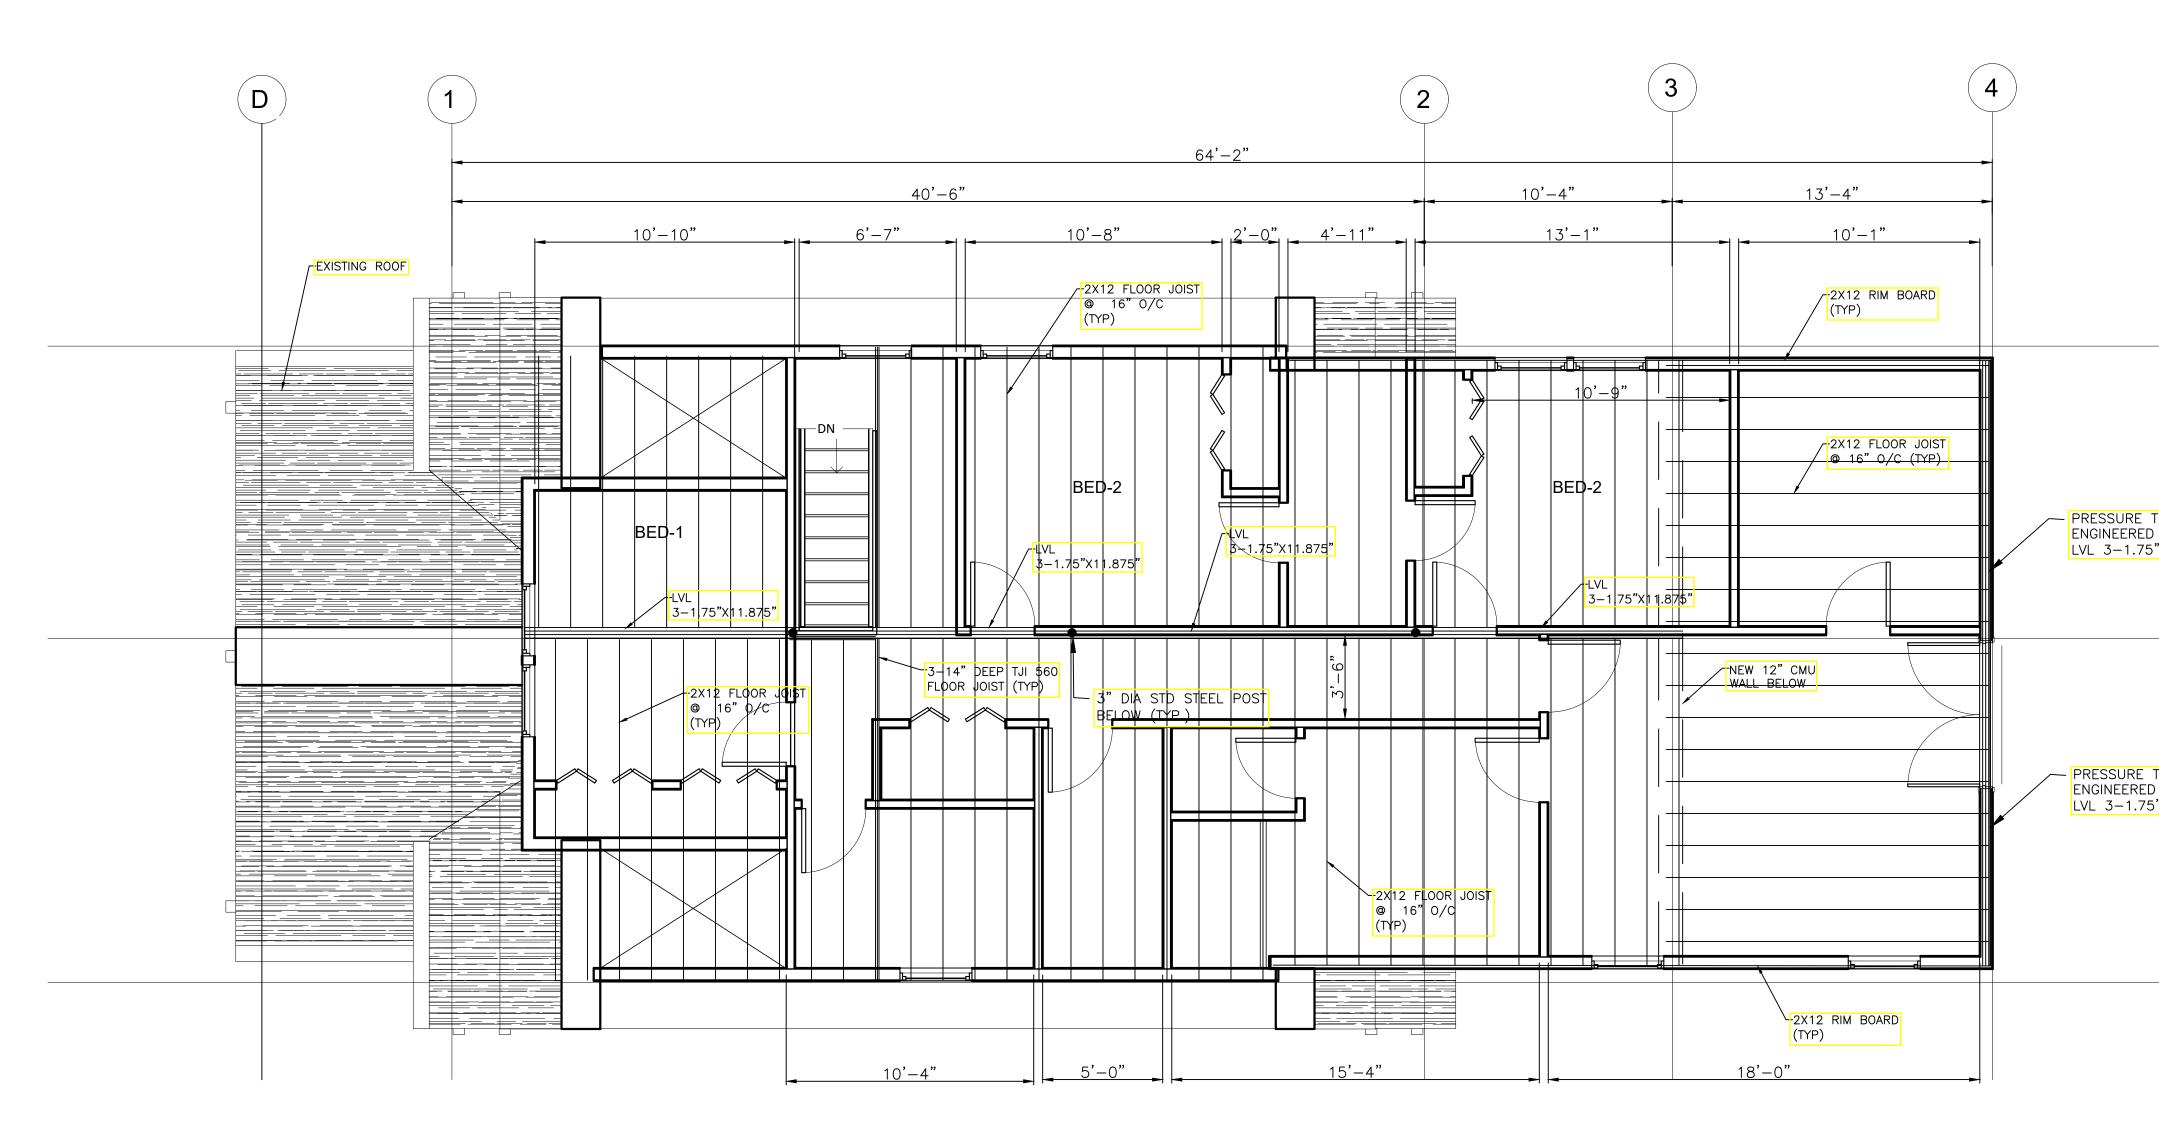

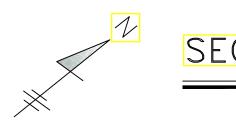

SECOND FLOOR PLAN

SCALE: 1/4" = 1'-0"


	<u>NOTES:</u> 1. FOR GENERAL NOTES SEE DRAWING S1.	
	2. ALL NEW EXTERIOR STUD WALLS SHALL HAVE 2"X6" STUDS @ 16" O/C. WITH 5/8" DRY WALL INSIDE FACE AND %" EXTERIOR SHEATHING BOARD ON EXTERIOR FACE.	띴
	 ALL NEW INTERIOR STUD WALLS SHALL BE 2"X4" STUDS @ 16" O/C. WITH 5/8" DRY WALL ON BOTH SIDES EXCEPT NOTES OTHERWISE. 	OWNER
	4. ALL WORK SHALL BE IN ACCORDANCE WITH MONTGOMERY COUNTY BUILDING CODE.	
		L CREST L CREST D 20759 418 1389 374 5418 0-LLC.COM
		LLC 12430 HILL FULTON MD FULTON FULTON FULTON FULTON FULTON FULTON FULTON FULTON FULTON FULTON FULTON FULTON FULTON FULTON FULTON
		LLC 12430 HILL FULTON MD FULTON MD FULTON MD FULTON MD FULTON MD FULTON MD FULTON MD FULTON MD FULTON MD FULTON MD
		0
		ENCO PION MANAGERS
		ARCHITECTS ENGINEERS CONSTRUCTION MANAGERS
		ARCHI ENGIN CONS'
		ATION VD AVE 20912
— (A)—	Т	
		PROJECT TITLE TION & ALT ROJECT ADDRESS WESTMORE MA PARK, N SHEET TITLE D FLOOR PL
ĩ	N	ADDITION & AL PROJECT ADDRESS PROJECT ADDRESS 6712 WESTMORE TAKOMA PARK, SHEET TITLE SHEET TITLE SHEET TITLE
TREATED		SE 1
E TREATED ED BEAM 75"X11.875"		
		DISCLAIMER
		PROFESSIONAL CERTIFICATION.
		OCCUMENTS WERE PREPARED OR APPROVED BY ME, AND THAT I AM A DULY LICENSED PROFESSIONAL ENGINEER UNDER THE LAWS OF THE STATE OF MARYLAND, LICENSE NO. 23081 EXPIRATION DATE: 04/24/2023
		NO. 23081 EXPIRATION DATE: 04/24/2023
E TREATED		STELLD, ST. B
75"X11.875"		No. 2308
		Palato
		REVISIONS
(<u>C</u>)	1	PROJECT NUMBER
		R22-258
	APPROVED	
	Montgomery County Historic Preservation Commission	APPROVED BY
		PP
	Rame ha MATTIS	DATE 11 11 22
		0RIGINAL SHEET SIZE
	REVIEWED	36X24 SHOULD MEASURE 1":
	By Dan.Bruechert at 1:24 pm, Nov 21, 2022	
		04 OF 09


DRAWING


S004

WALL SYMBOLS


TYPE	DESCRIPTION
	EXISITNG WALLS DEMOLITION
	EXISTING WALLS
	PROPOSED STUD WALL
	NEW CMU WALL

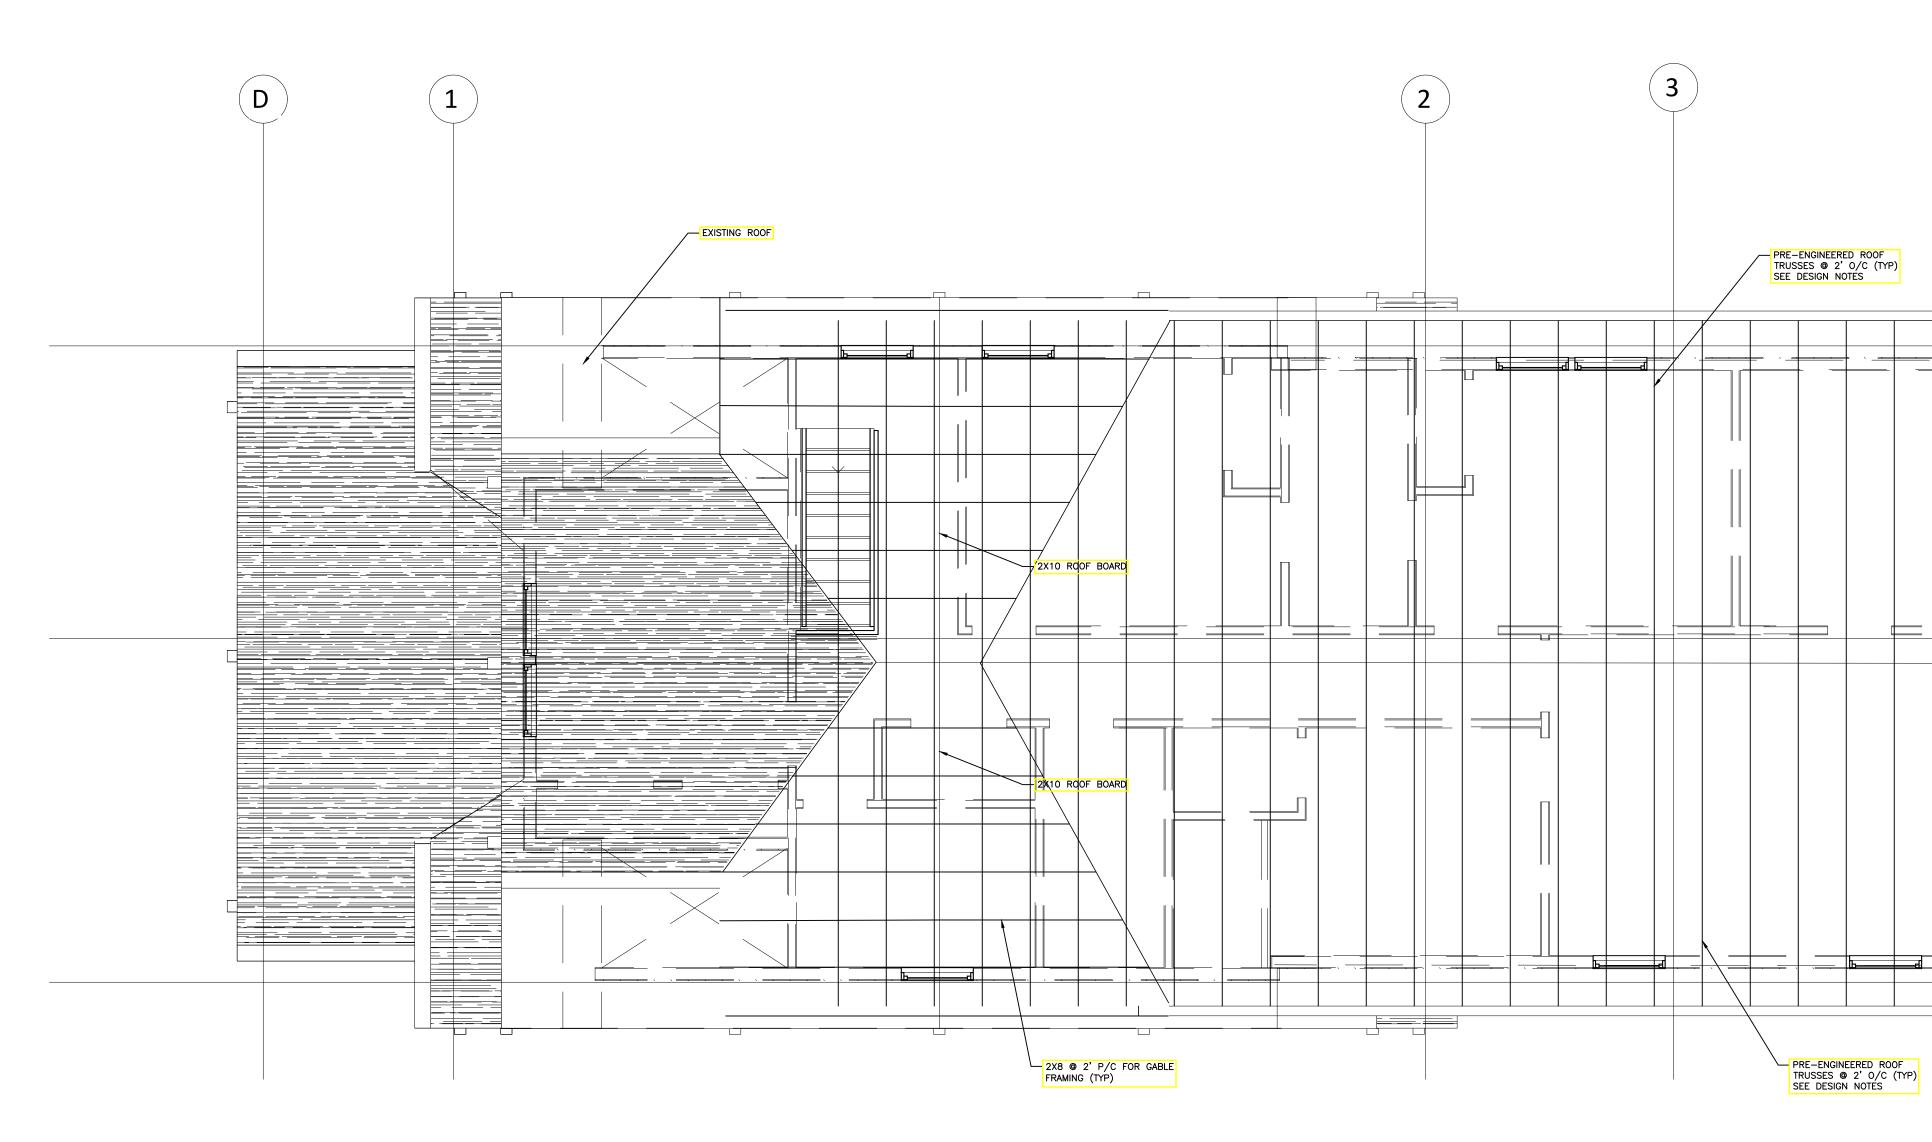

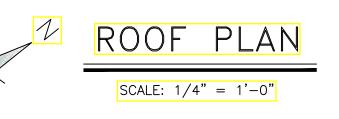

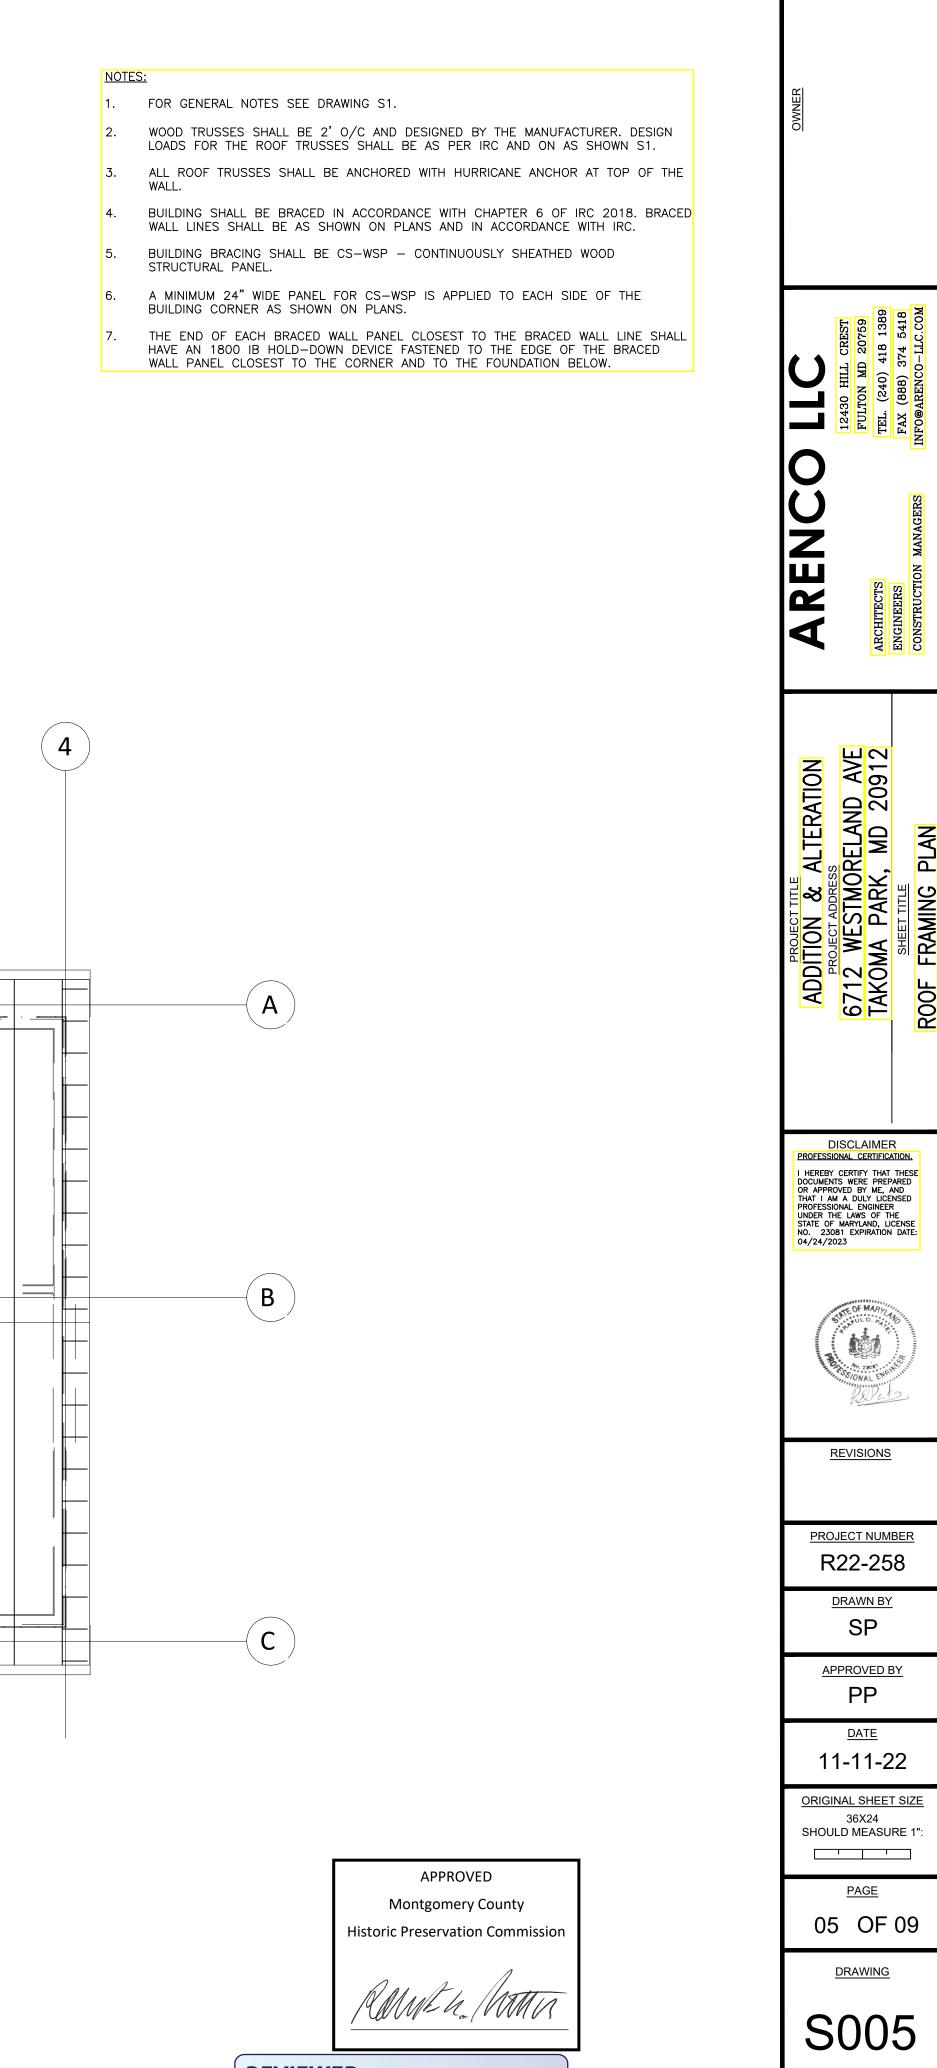

REVIEWED By Dan.Bruechert at 1:24 pm, Nov 21, 2022

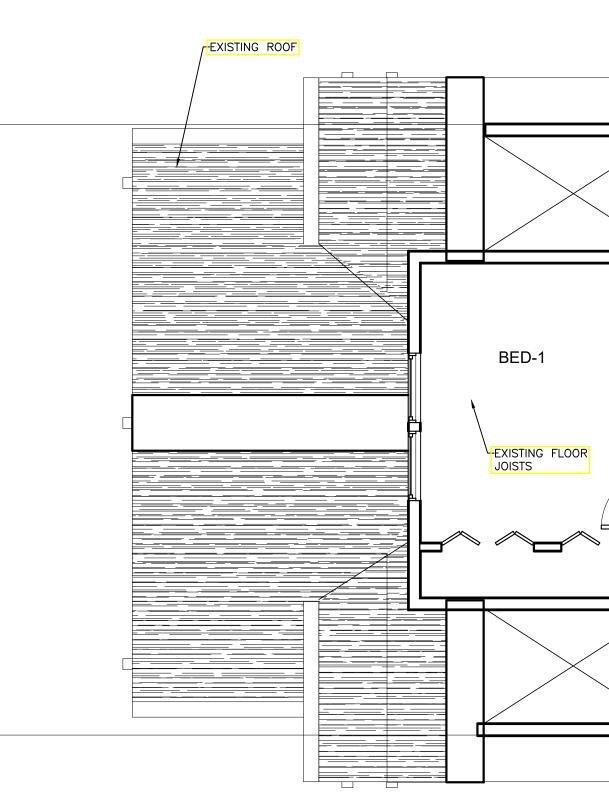

APPROVED Montgomery County Historic Preservation Commission

RAMEL MATTA


REVIEWED By Dan.Bruechert at 1:24 pm, Nov 21, 2022

-		4	9'—11"			
1'-10" <u>2'-11"</u> CS-WSP CS-WSP		<u>18'-5"</u> CS-WSP		-		4'-5" S-WSP
	BED-2			= d⊡ = _d 10'-9" BED-2		
AC	1 \$60 YP)					
	14" DEEP TJI S FLOOR JOIST (<u>25'-10"</u>	9'-11"	14" DEEP T FLOOR JOIS	TJI 560 ST (TYP) 7'-8" CS-WSP	

2ND FL WALL BRACING PLAN


SCALE: 1/4" = 1'-0"

	WALL BRACING REQUIREMENTS							
BWL	BETWEEN LINES	METHOD	LENGTH	REQUIRED L (TABLE R602.10.3) (1)	ADJUSTMENT FACTOR WIND	TOTAL REQUIRED	PROVIDED	NOTES
11	M-N	CS-WSP	49'-11"	7'-6"	1	7'-6"	37'-6"	
12	M-N	CS-WSP	49'-11"	7'-6"	1	7'-6"	40'-10"	
М	11-12	CS-GB	25'-5"	8'-0"	1	8'-0"	22'-0"	
N	11-12	CS-WSP	25'-5"	4'-6"	1	4'-6"	19'-3"	

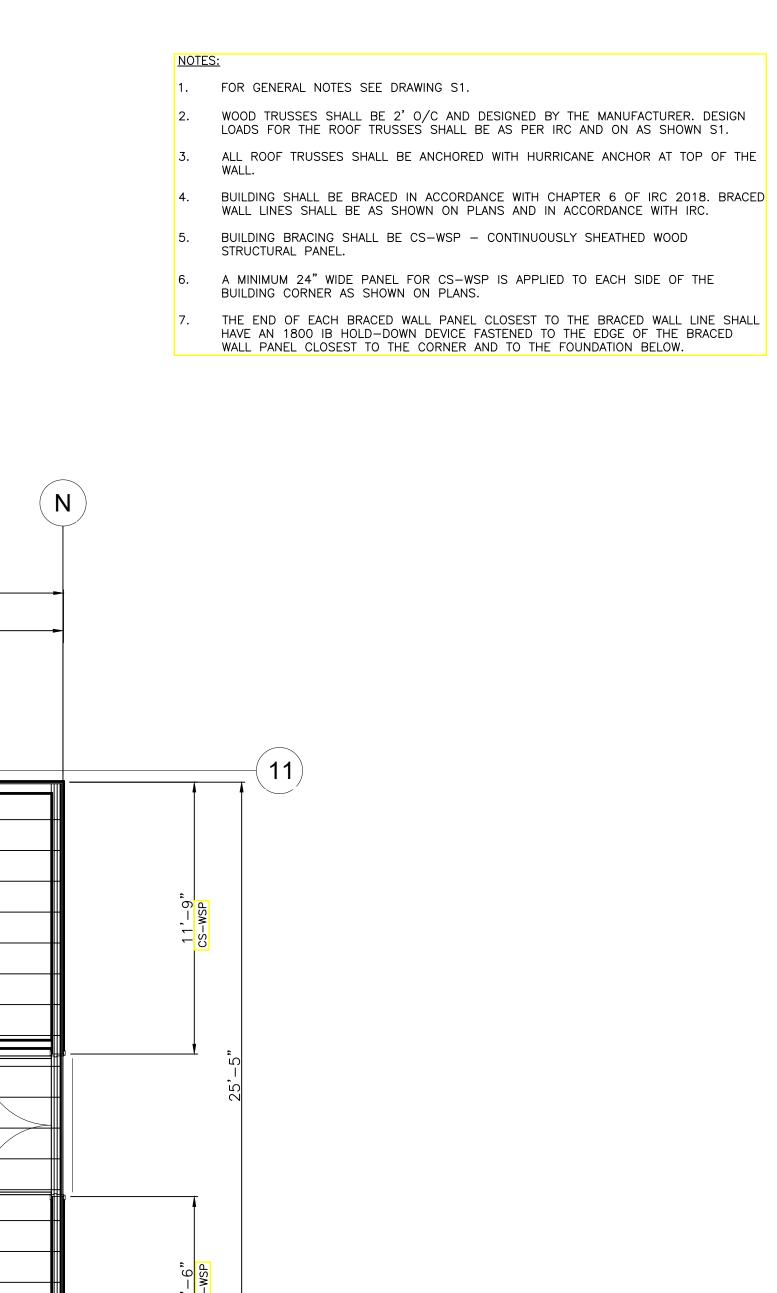

/			
(1	0	
		Ζ	
		/	/


OWNER
I MANAGERS N MANAGERS
VE VE 12 ARCHITECTS ENGINEERS CONSTRUCTION MANAGERS
ADDITION & ALTERATION PROJECT ADDRESS 6712 WESTMORELAND AV TAKOMA PARK, MD 2091 SHEET TITLE 2ND FL WALL BRACING PLAN
DISCLAIMER PROFESSIONAL CERTIFICATION. I HEREBY CERTIFY THAT THESE DOCUMENTS WERE PREPARED OR APPROVED BY ME, AND THAT I AM A DULY LICENSED PROFESSIONAL ENGINEER UNDER THE LAWS OF THE STATE OF MARYLAND, LICENSE NO. 23081 EXPIRATION DATE: 04/24/2023
<u>PROJECT NUMBER</u> R22-258
DRAWN BY SP APPROVED BY PP
DATE 11-11-22 ORIGINAL SHEET SIZE 36X24 SHOULD MEASURE 1":
PAGE 06 OF 09 DRAWING S006

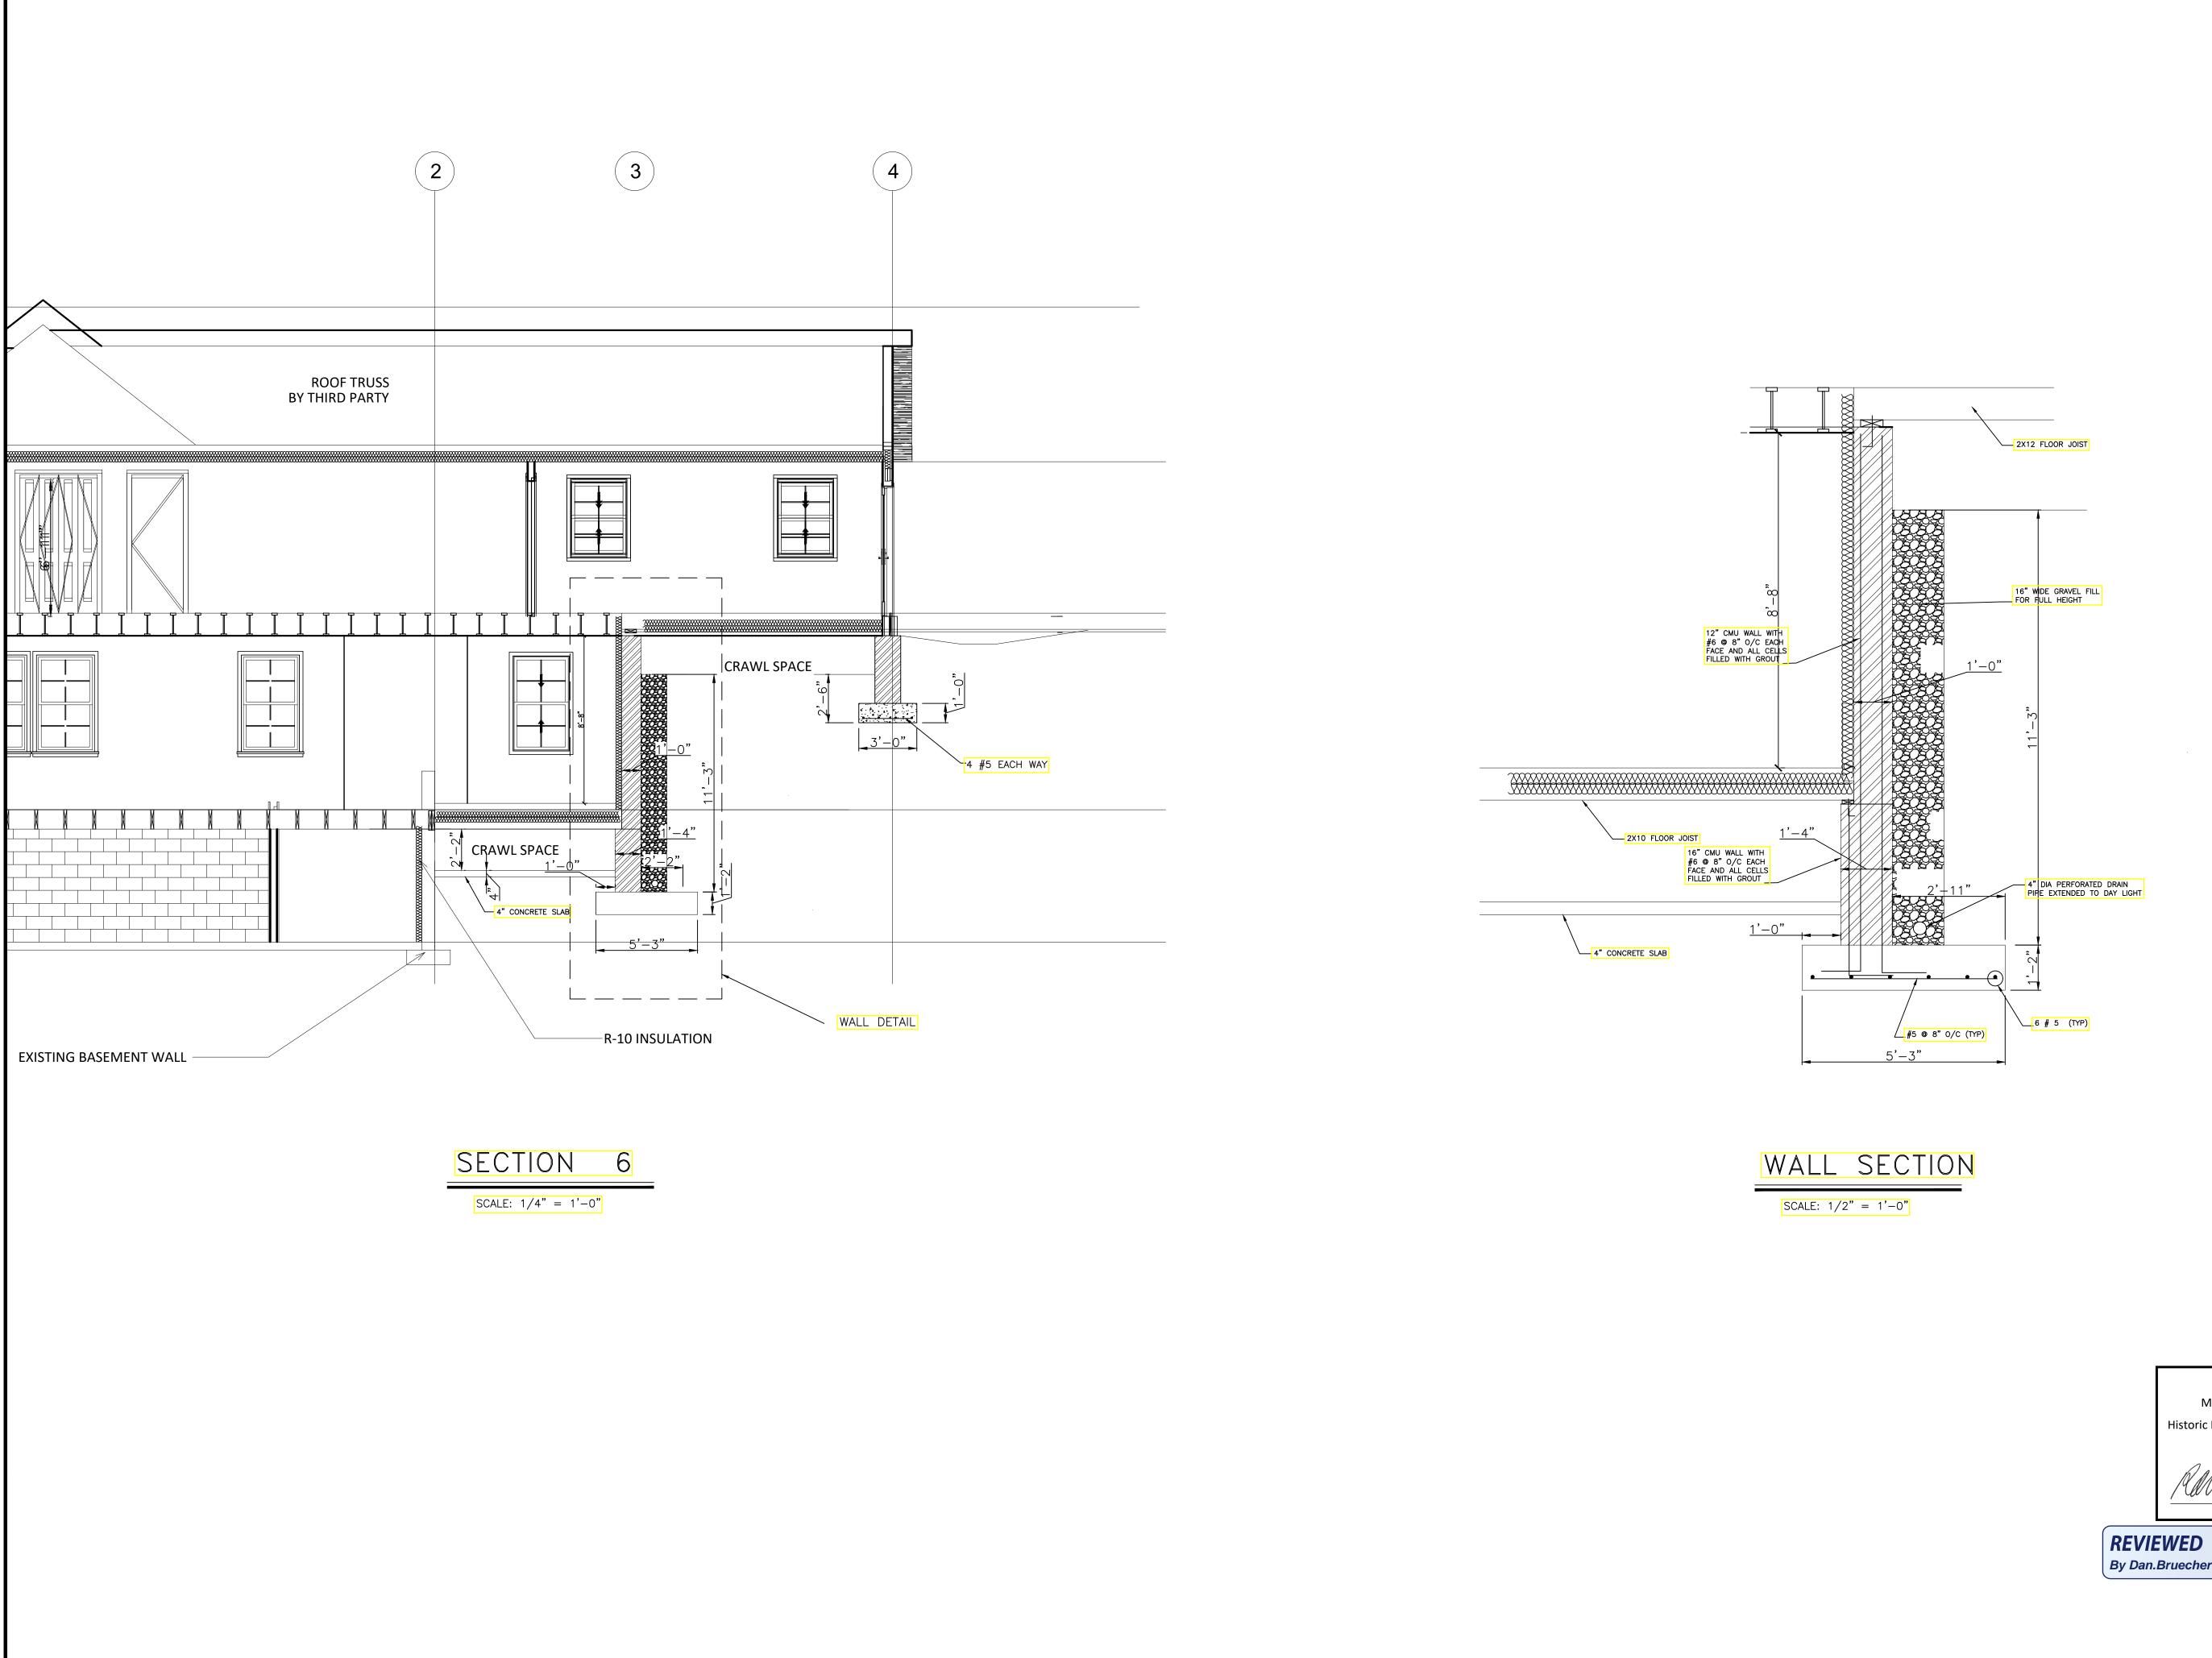

APPROVED Montgomery County Historic Preservation Commission Kamen / Man

By Dan.Bruechert at 1:25 pm, Nov 21, 2022

OWNER
ARCHITECTS ARCHIT
ADDITION & ALTERATION PROJECT ADDRESS 6712 WESTMORELAND AVE TAKOMA PARK, MD 20912 SECTION AND DETAILS
DISCLAIMER PROFESSIONAL CERTIFICATION. I HEREBY CERTIFY THAT THESE DOCUMENTS WERE PREPARED OR APPROVED BY ME, AND PROFESSIONAL ENGINEER UNDER THE LAWS OF THE STATE OF MARYLAND, LICENSE NO. 23081 EXPIRATION DATE: 04/24/2023
REVISIONS PROJECT NUMBER R22-258 DRAWN BY SP
APPROVED BY PP DATE 11-11-22 ORIGINAL SHEET SIZE 36X24 SHOULD MEASURE 1": PAGE
07 OF 09 DRAWING S007

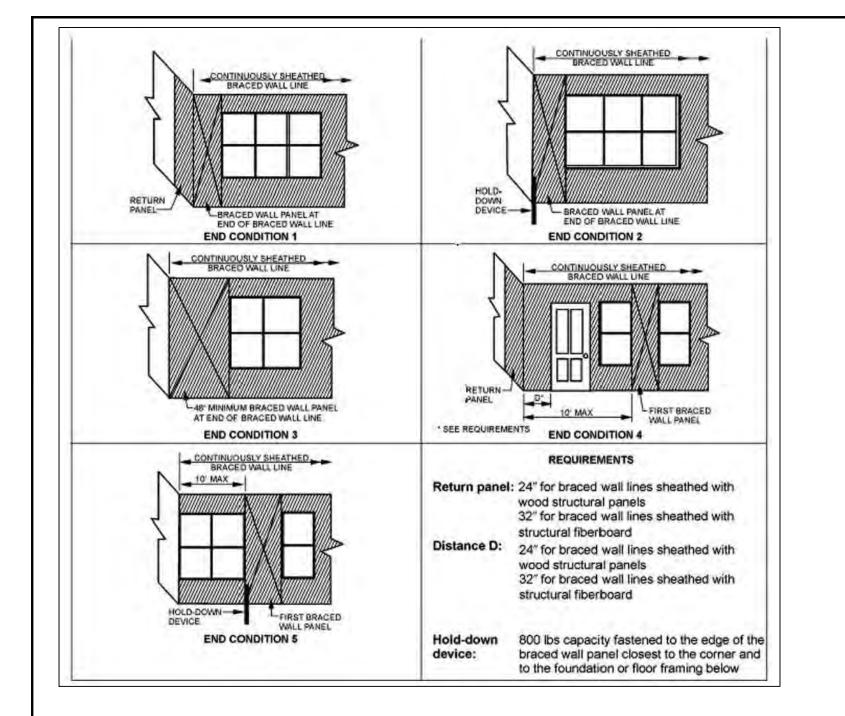

8d common nall (0.131" x 2-1/2")

at 6 In. o.c. on all panel edges

8d common (0.131" x 2-1/2") at 12 in. o.c. on

all framing members not at panel edges

Orientation of studs may vary. See Figure R602.3(2)

Gypsum wallboard as required and installed in accordance with Chapter 7

Continuous wood structural panel

braced wall line


(a) Outside corner detail

Minimum 24 In. wood structural panel sheathing


16d nail (0.131" x 3-1/2") at 12 in. o.c. —


Optional non-structural filler panel


common nall (0.131° x 2-1/2°) 5 In. o.c. on all panel edges "

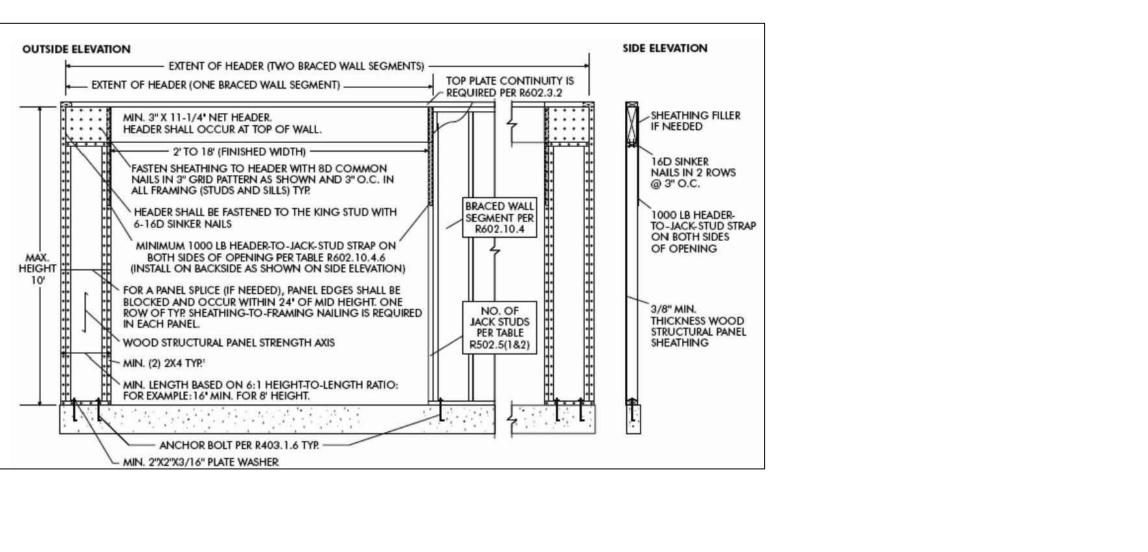




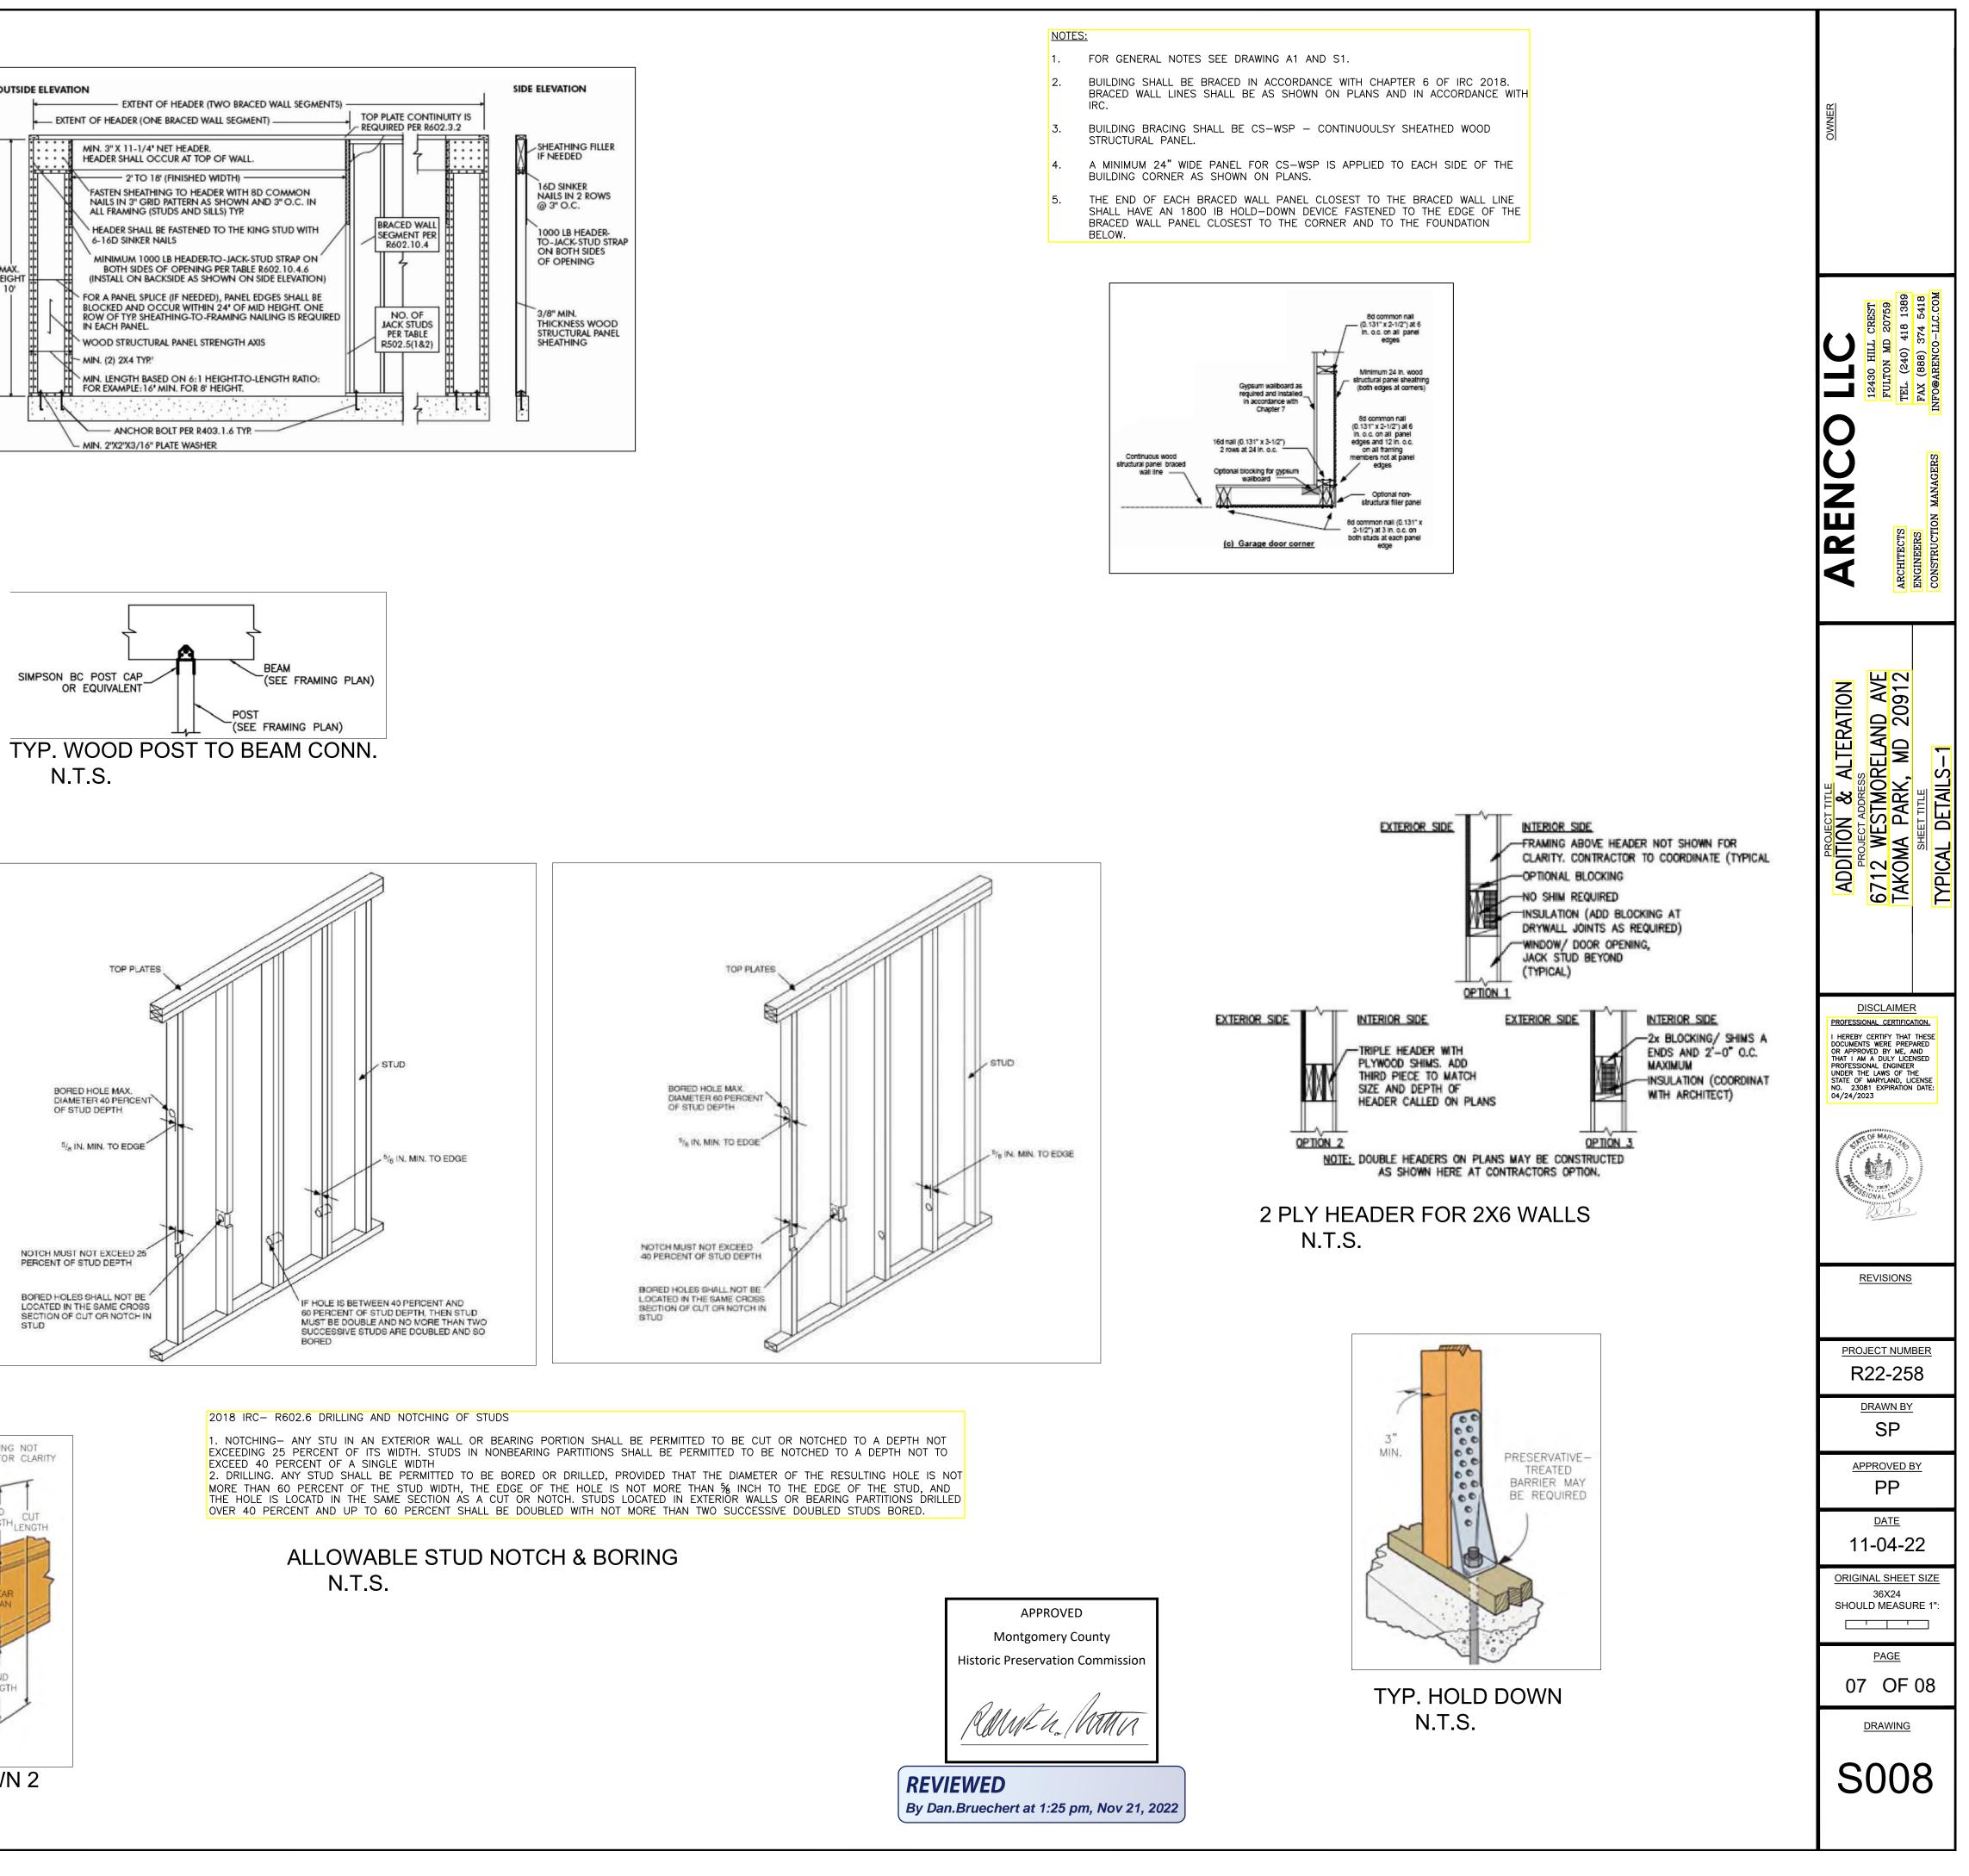


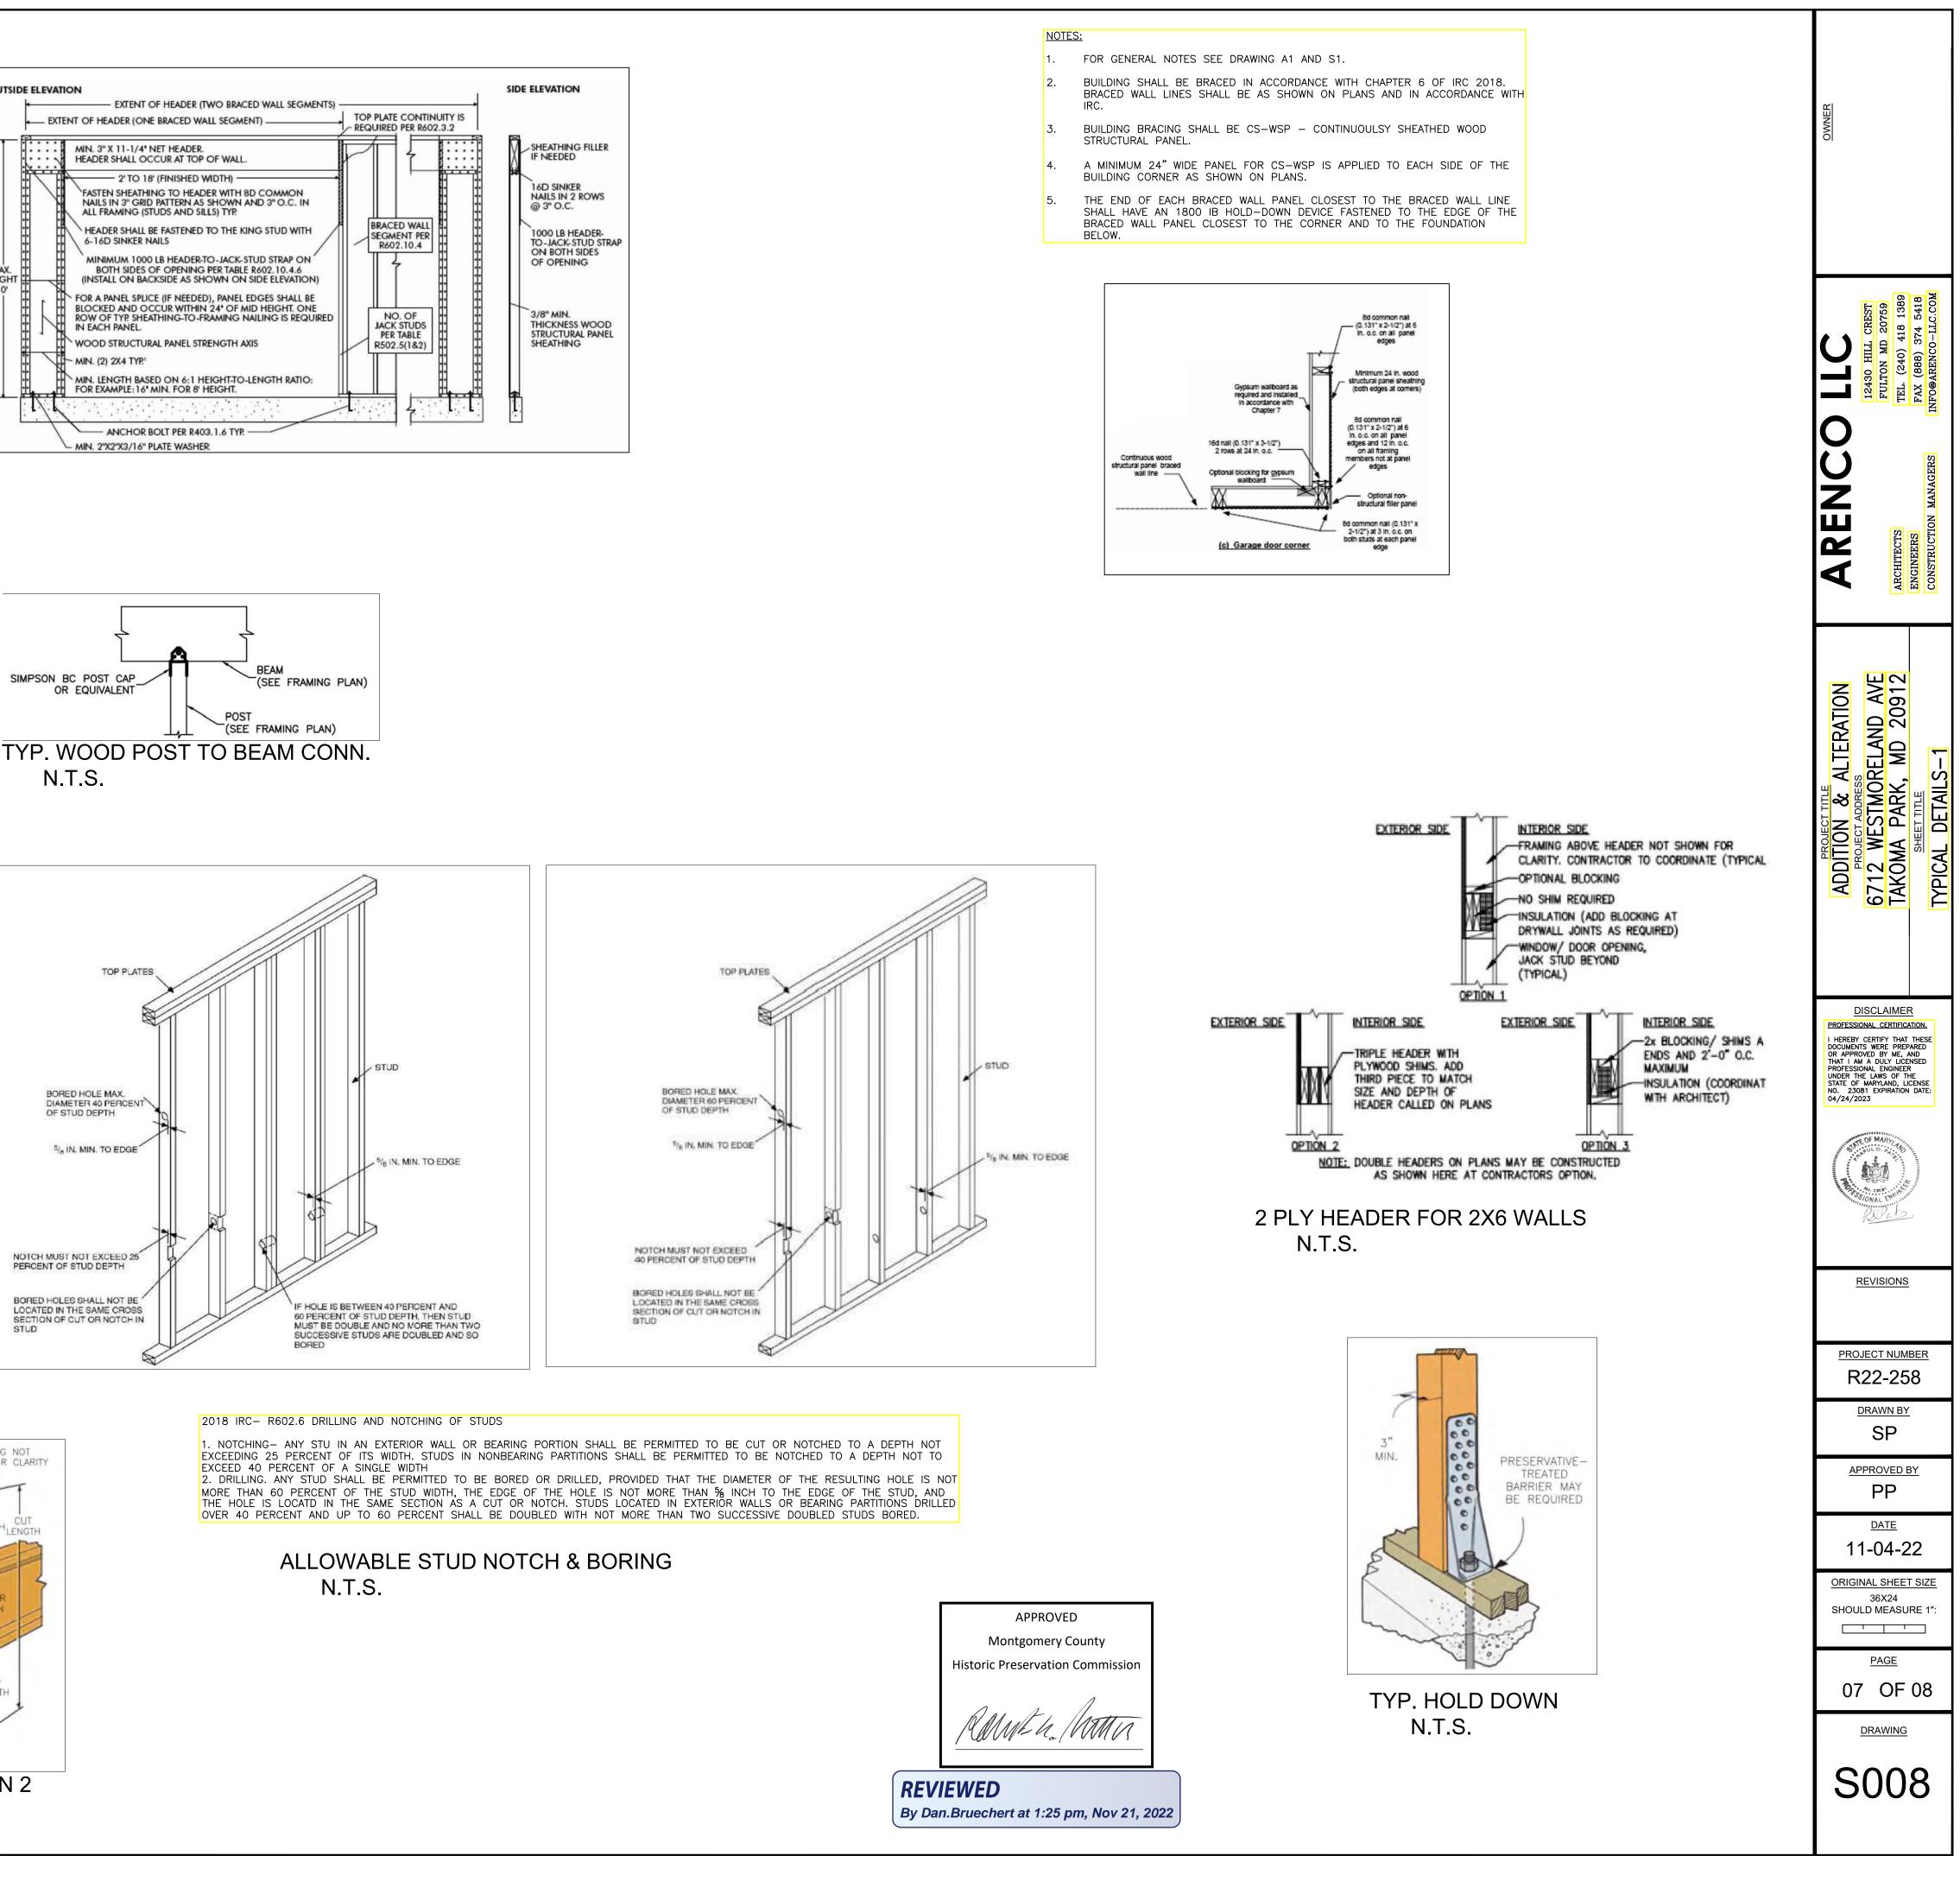


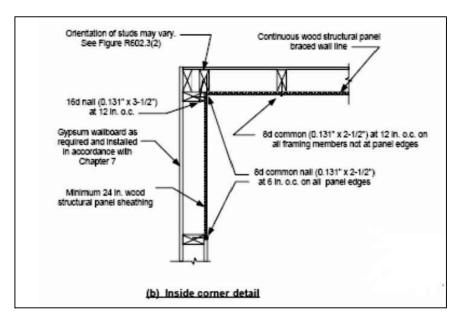

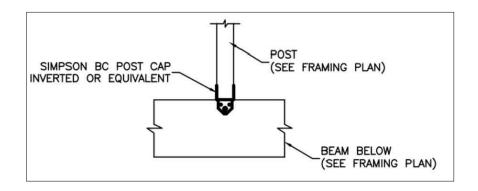


TYP. WOOD POST TO FLOOR JOIST CONN. N.T.S.

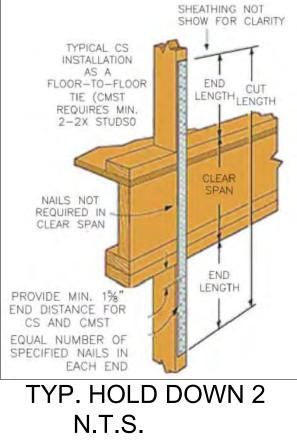

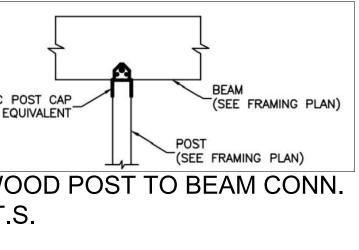





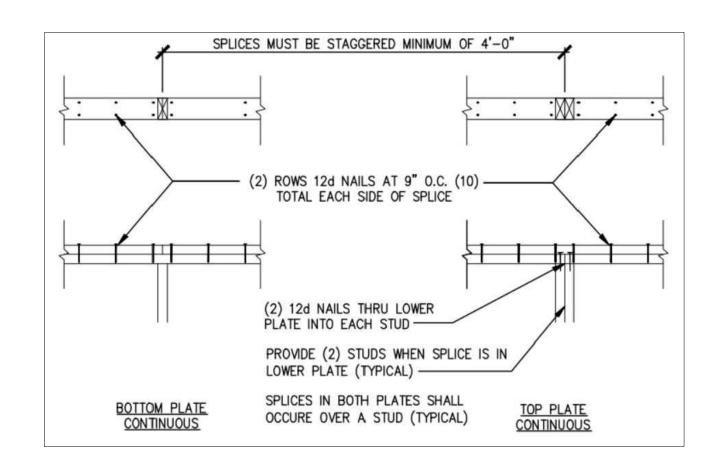


TYP TOP PL SPLICE N.T.S.

METHOD	MATERIAL	MINIMUM THICKNESS	FIGURE	CONNECTION CRITERIA
<u>CS-WSP</u>	Wood structural panel	<u>3/8"</u>		6d common (2"x0.113") nails at 6" spacing (panel edges) and at 12" spacing (intermediate supports) o 16 ga. x 1-3/4 staples; at 3" spacing (panel edges) and 6" spacing (intermediate supports)
<u>CS-G</u>	Wood structural panel adjacent to garage openings and supporting roof load only ^{a,b}	<u>3/8"</u>	FIFI	See Method CS-WSP
CS-PF	Continuous portal frame	See Section R602.10.4.1.1		See Section R602.10.4.1.1

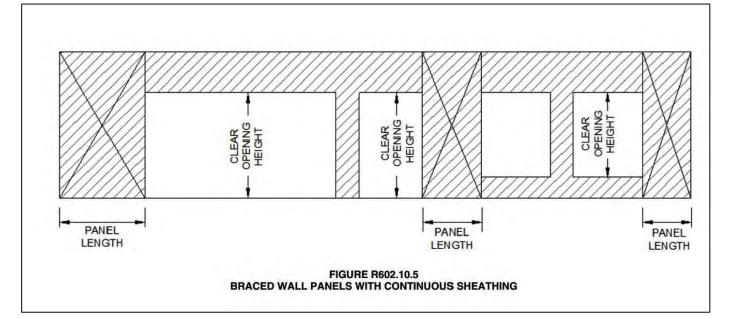


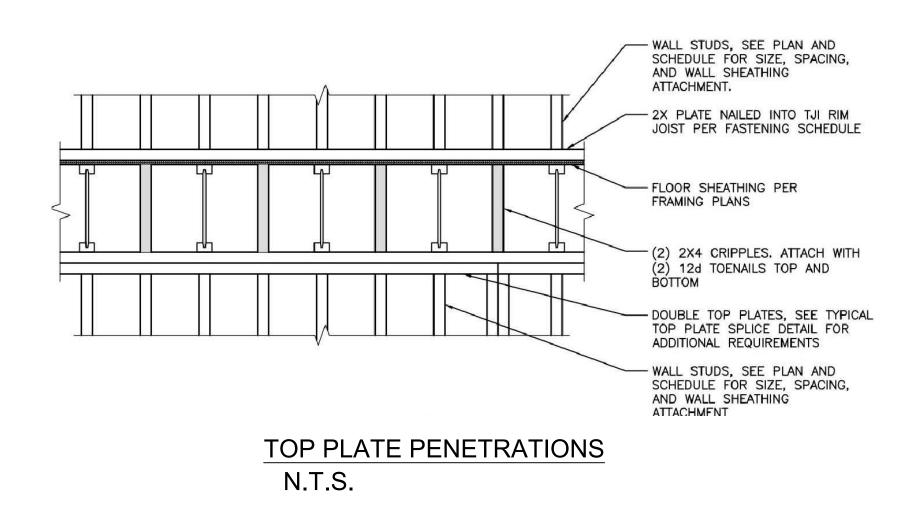


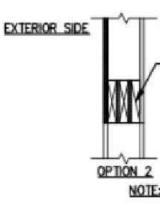

N.T.S.



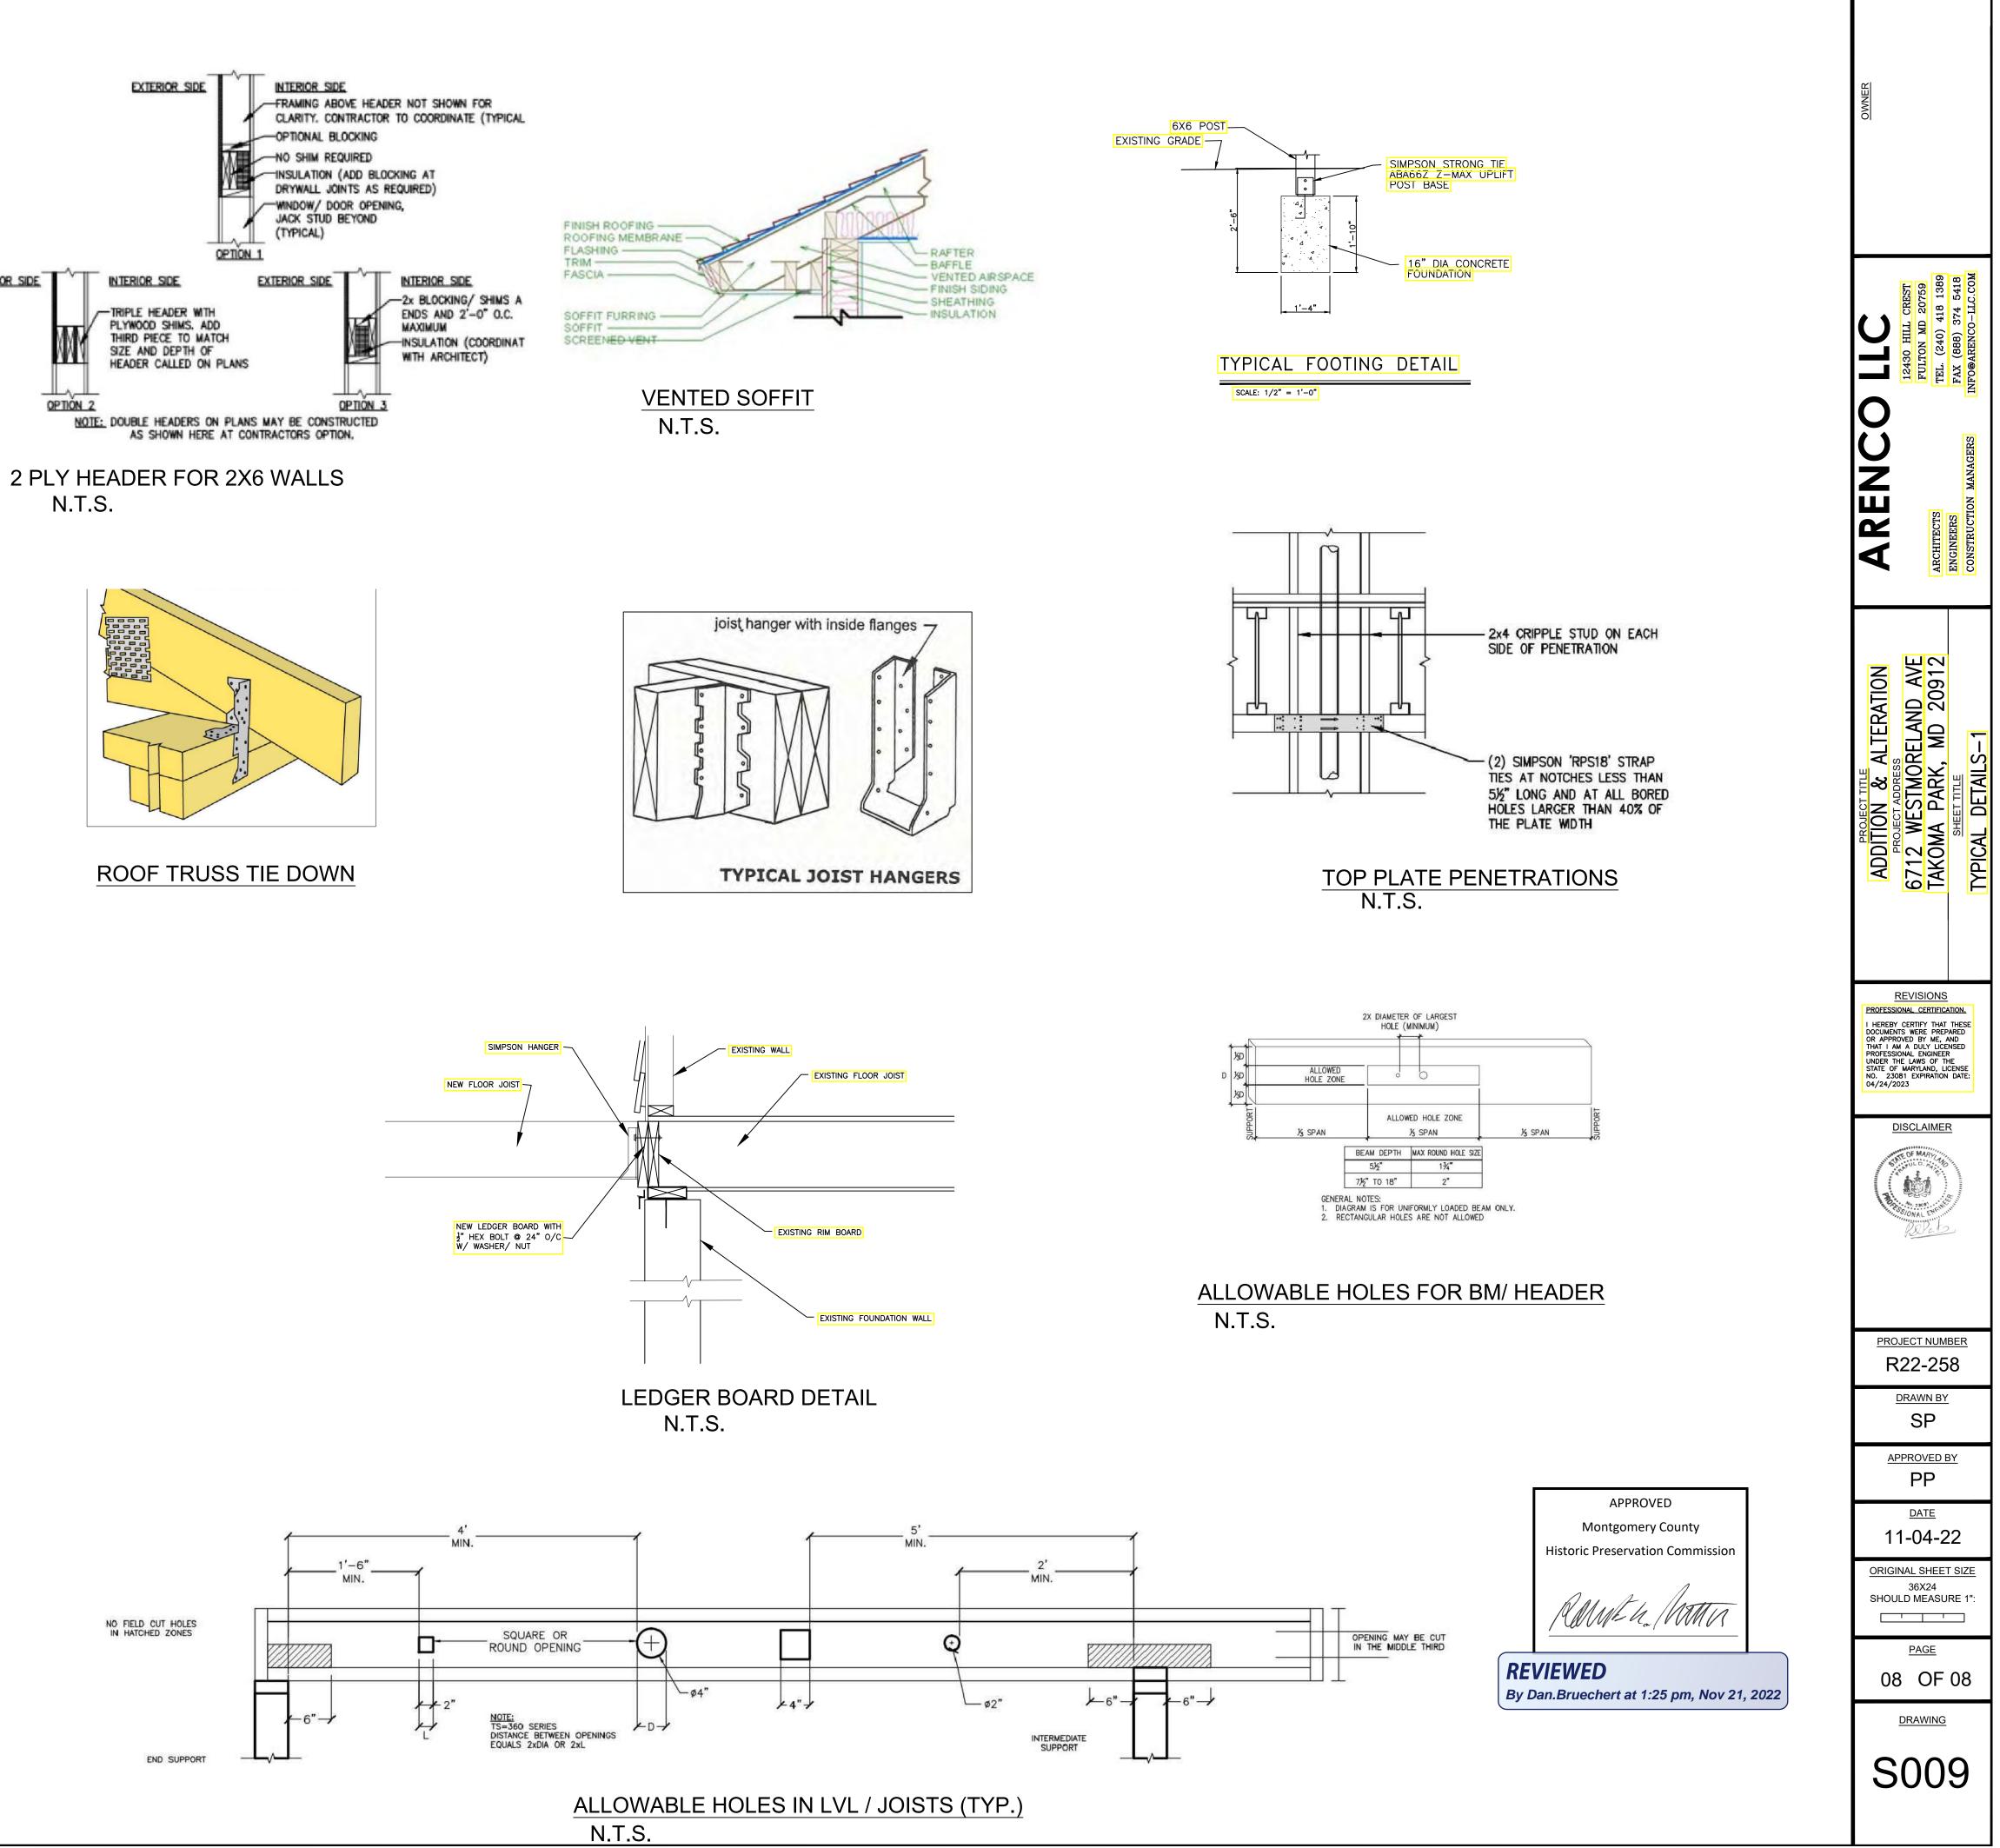

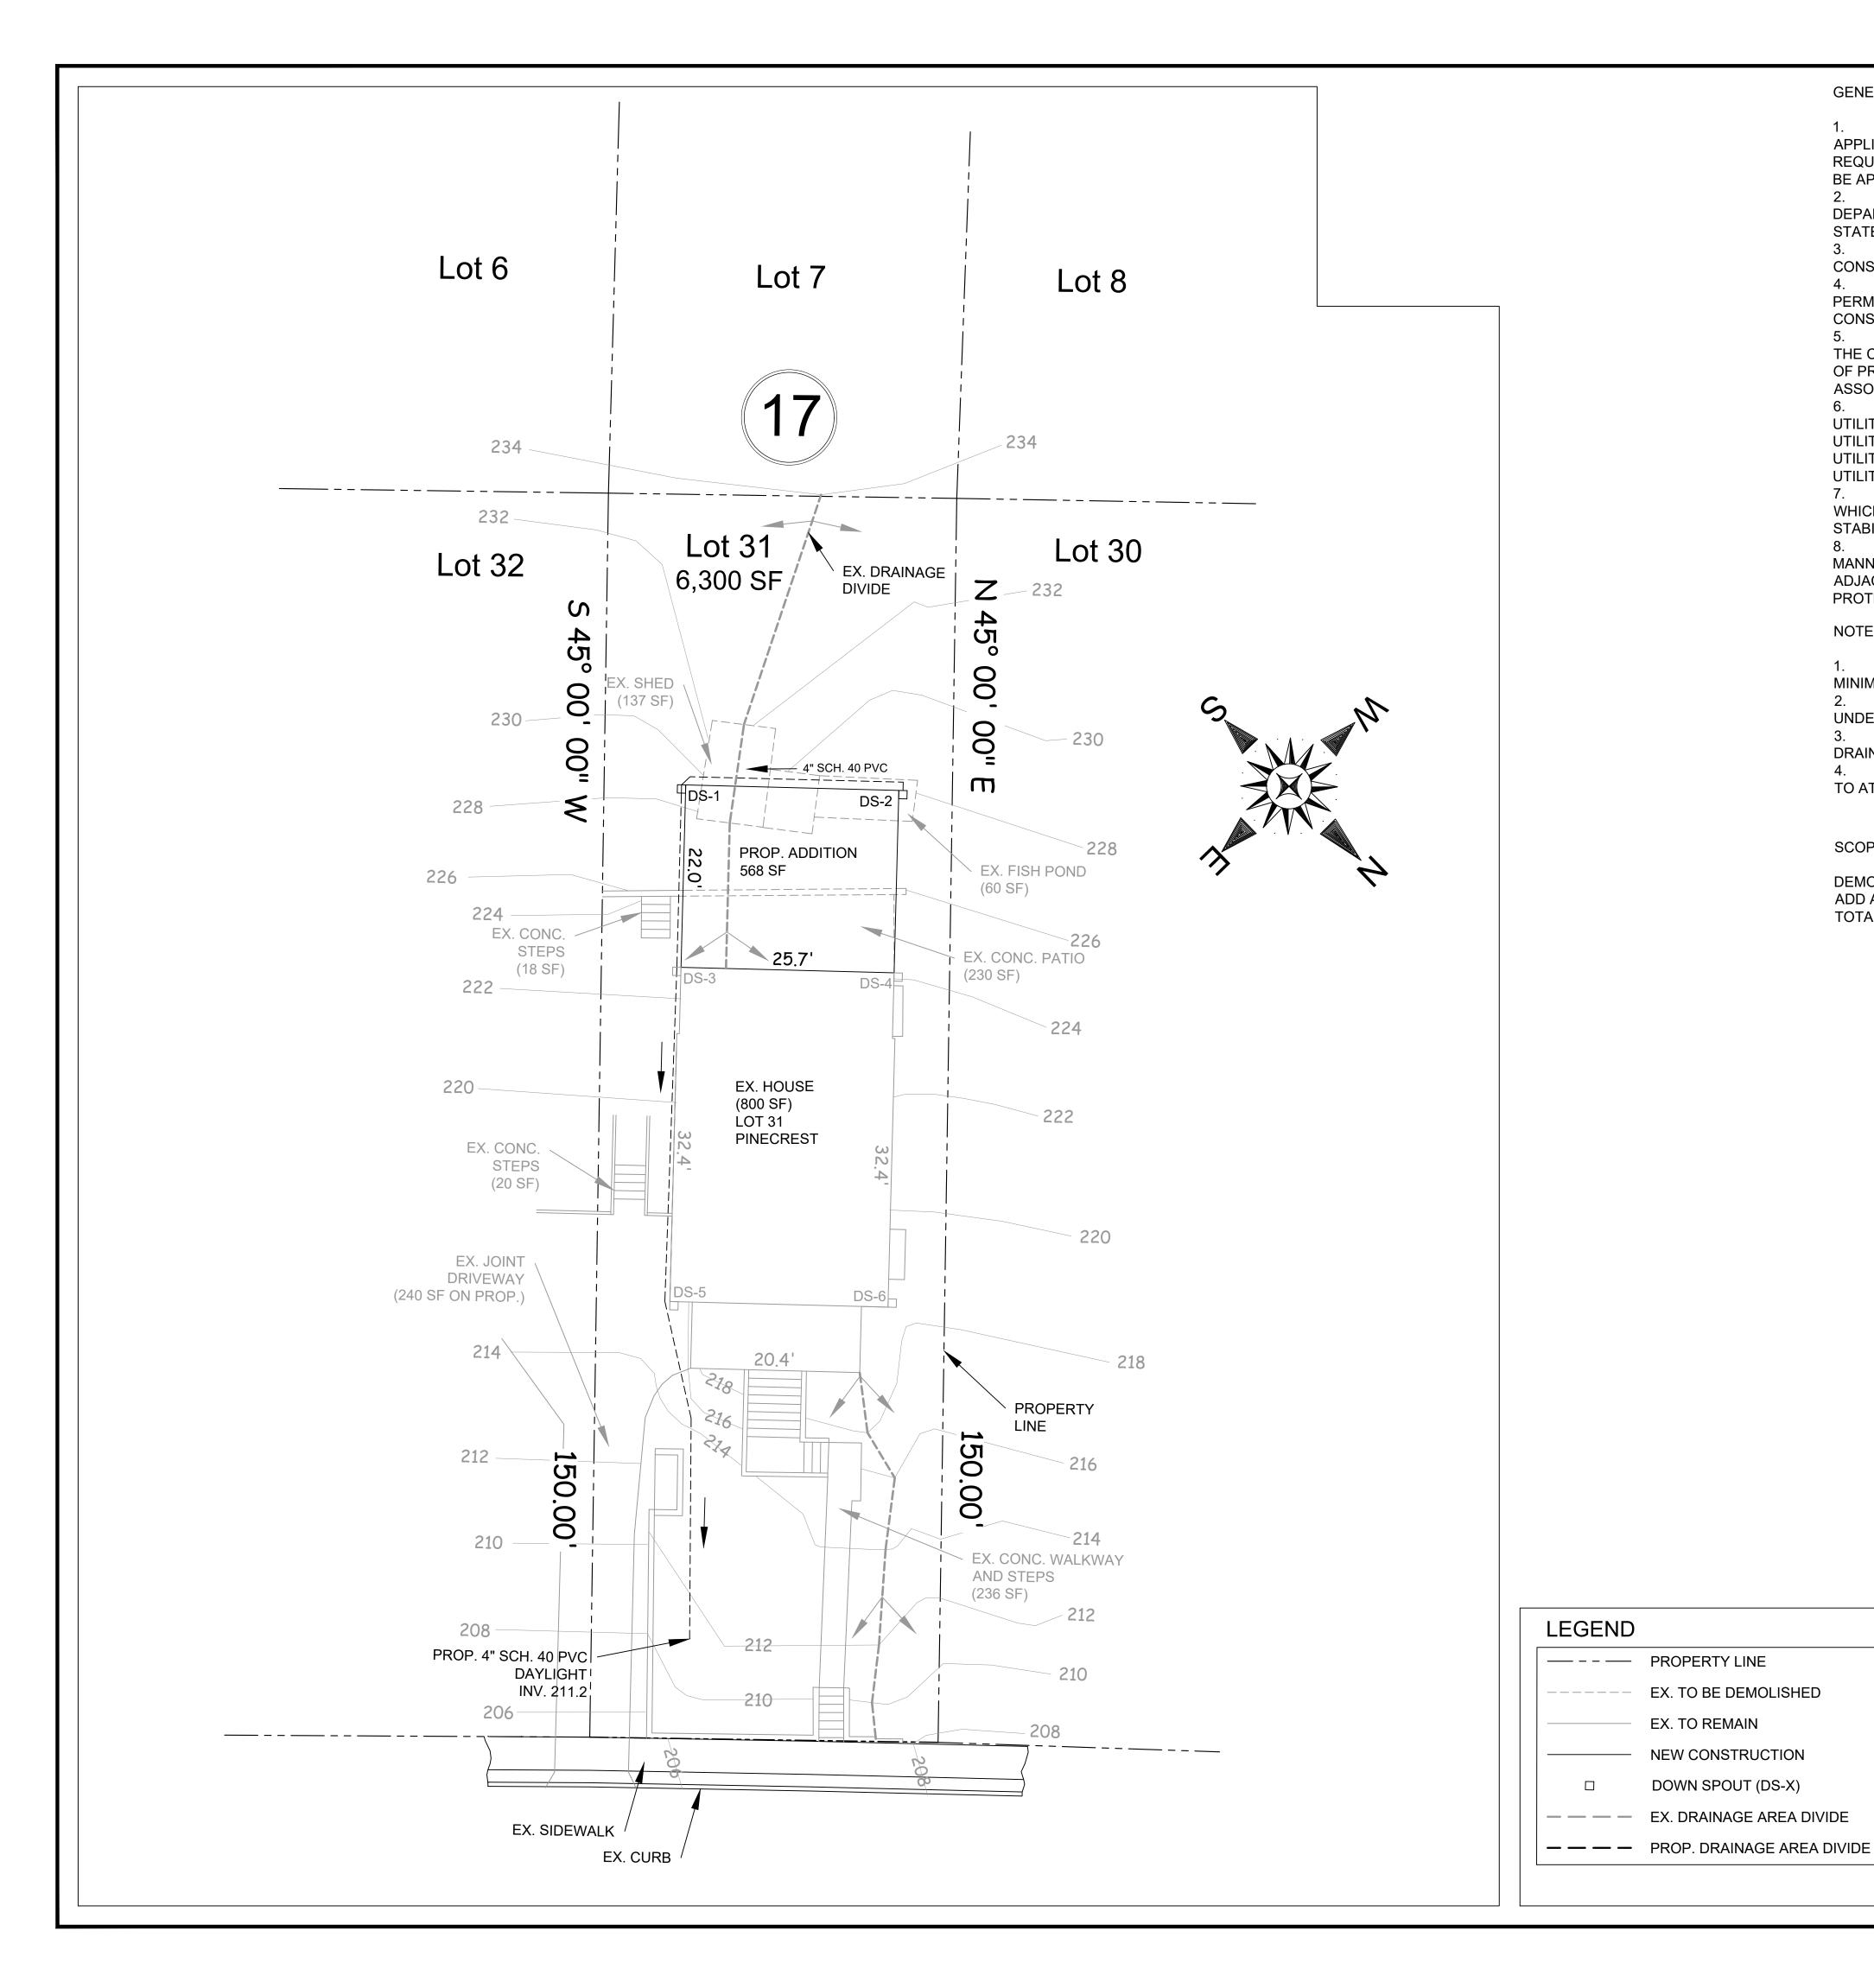

GENERAL CONSTRUCTION NOTES

1. CONSTRUCTION OF THESE PLANS SHALL BE IN ACCORDANCE WITH THE ALL APPLICABLE STANDARDS, PERMIT CONDITIONS AND SPECIFICATIONS AS WELL AS REQUIRED METHOD OF CONSTRUCTION, ANY DEVIATION FROM THESE PLANS SHALL BE APPROVED BY THE ENGINEER PRIOR TO BEGINNING THE CONSTRUCTION. 2. ALL WORK IS TO BE IN ACCORDANCE WITH MCDPS, MONTGOMERY COUNTY DEPARTMENT OF TRANSPORTATION, MSHA, WSSC, ALL OTHER LOCAL COUNTY AND STATE AGENCIES.

3. THE CONTRACTOR IS REQUIRED TO OBTAIN ALL PERMITS REQUIRED FOR CONSTRUCTION OF THESE PLANS. 4. THE CONTRACTOR IS TO VERIFY THAT ALL REQUIRED EASEMENT, LETTERS OF PERMISSION ETC., ARE RECORDED / OBTAINED PRIOR TO THE START OF ANY CONSTRUCTION.

5. ANY TIME WORK IS PERFORMED OFF-SITE, OR WITHIN AN EXISTING EASEMENT, THE CONTRACTOR IS TO NOTIFY THE HOLDER OF SAID EASEMENT AS TO THE NATURE OF PROPOSED WORK AND TO FOLLOW ANY GUIDELINES OR STANDARDS WHICH ARE ASSOCIATED WITH OR REFERENCED IN THE RECORDED EASEMENT. 6. THE CONTRACTOR IS TO VERIFY THAT THE RELOCATION OF ALL EXISTING UTILITIES IN CONFLICT WITH PROPOSED WORK HAS BEEN COMPLETED, INCLUDING UTILITY POLES AND GUY WIRES. ADDITIONALLY, AT ALL POTENTIAL UNDERGROUND UTILITY CONFLICTS, THE CONTRACTOR SHALL TEST PIT BY HAND TO VERIFY ACTUAL UTILITY LOCATION.

7. ALL LAND, ON OR OFF-SITE, WHICH IS DISTURBED BY THIS DEVELOPMENT AND WHICH IS NOT BUILT UPON OR PAVED. SHALL BE ADEQUATELY SEEDED AND STABILIZED TO CONTROL EROSION AND SEDIMENTATION. 8. ALL FINISHED GRADING, SEEDING AND SODDING SHALL BE DONE IN SUCH A MANNER TO PRECLUDE THE PONDING OF THE WATER ON THE SITE, PARTICULARLY ADJACENT TO THE BUILDING OR STORM INLETS. PROVIDE APPROVED INLET PROTECTION DURING CONSTRUCTION.

NOTES

1. PROPOSED 4" SCH. 40 UNDERDRAIN PIPE TO HAVE MINIMUM 0.5% SLOPE AND MINIMUM 6" COVER, EXCEPT WHEN DAYLIGHTING. 2. DOWN SPOUT 2 (DS-2) TO TURN CORNER ABOVE GRADE AND THEN CONNECT TO UNDERDRAIN PIPE MINIMUM 6" BELOW GRADE. 3. UNLESS OTHERWISE NOTED EXISTING GRADES TO REMAIN. MAINTAIN POSITIVE DRAINAGE AWAY FROM NEW BUILDING. 4. ZONED R-40. BUILDING RESTRICTION LINE NOT SHOWN AS IT DOES NOT APPLY TO ATTACHED ADDITIONS IN THIS ZONE.

SCOPE OF WORK

DEMOLITON OF FRAME SHED, FISH POND AND CONC. PATIO IN BACK OF PROPERTY, ADD A 568 SF ADDITION ON THREE (3) 30"X30" FOOTINGS (FOOTINGS NOT SHOWN). TOTAL BUILDING FOOTPRINT INCREASE OF THE ADDITION IS 568 SF.

TECHNICAL REV SEDIMENT CON
FOR LOCATION OF UTILITIES 1-800-257-7777, OR LOG HOURS IN ADVANCE OF AN MUST NOTIFY ALL PUBLIC U FACILITIES IN THE AREA OF THOSE FACILITIES LOCATED COMMENCING EXCAVATION. COMPLIANCE WITH REQUIREN MONTGOMERY COUNTY CODE

REVIEWED

MCDPS A YEARS



OWNER/PERMIT APPLICANT

C-BAZ-02 LLC 6349 HARRIS HEIGHTS AVE GLEN BURNIE MD 21061

BEI
PROFESSIONAL ENGINEER <u>CERTIFICATION</u> NAME, P.E. VINEET BHANOT LICENSE No. 28506
EXPIRATION DATE: 01-15-23
Vaniet Chanot Port 100 2850 0. Storate Chanot
I HEREBY CERTIFY THAT THESE DOCUMENTS WERE DESIGNED IN ACCORDANCE WITH THE APPLICABLE CODES IN THE STATE
OF MARYLAND, WERE PREPARED OR APPROVED BY ME, AND THAT I AM A DULY LICENSED ENGINEER UNDER THE LAWS OF THE STATE OF MARYLAND.
T EERS INC mon dr. suite 206 ww. md 2087/6 3 . fax (301) 528 2051
BHANOT ENGINEE 20400 OBSERVATION GERMANTOWN, TEL. (301) 591 3833 . F
PLANNERS ENGINEERS CONSTRUCTION MANAGERS
PLAT ENG
and Id Ave 20912 AN
6712 Westmoreland PROJECT ADDRESS 3712 Westmoreland Ave Facoma Park, MD 20912 SHEET TITLE DRAINAGE PLAN
6712 Westmoreland PROJECT ADDRESS 6712 Westmoreland Ave Tacoma Park, MD 20912 SHEET TILE DRAINAGE PLAN
<u>REVISIONS</u>
DISCLAIMER
PROJECT NUMBER 030122
DRAWN BY SH
VB DATE
10-26-2022 ORIGINAL SHEET SIZE 36X24
SHOULD MEASURE 1":
1" = 10'
DR-1

1 of 1

APPROVED
Montgomery County
Historic Preservation Commissio

REVIEWED By Dan.Bruechert at 1:25 pm, Nov 21, 2022

MISS UTILITY TION OF UTILITIES, CALL "MISS UTILITY" AT 57-7777, OR LOG ON TO WWW.MISSUTILITY.NET/ITICS 48 ADVANCE OF ANY WORK IN THIS VICINITY. THE EXCAVATOR IFY ALL PUBLIC UTILITY COMPANIES WITH UNDER GROUND IN THE AREA OF THE PROPOSED EXCAVATION AND HAVE CILITIES LOCATED BY THE UTILITY COMPANIES PRIOR TO NG EXCAVATION. THE EXCAVATOR IS RESPONSIBLE FOR CE WITH REQUIREMENTS OF CHAPTER 36A OF THE

TECHNICAL REVIEW OF SEDIMENT CONTROL	ADMINISTRATIVE REVIEW		DPS approval of a sediment control or stormwater management plan is for demonstrated compliance with minimum environmental runoff treatment standards and does not create or imply any right to divert or
			concentrate runoff onto any adjacent property withou that property owner's permission. It does not relieve the design engineer or other responsible person of
DATE	REVIEWED	DATE	professional liability or ethical responsibility for the adequacy of the drainage design as it affects uphill o
TECHNICAL REVIEW OF DRMWATER MANAGEMENT	SMALL LOT DRAINAGE APPROVAL		downhill properties.
	N/A: 🔲 OR		SEDIMENT CONTROL PERMIT NO.
			-
DATE	REVIEWED	DATE	SM. FILE NO. STORMWATER MANAGEMENT:
PPROVAL OF THIS PLAN WILL EXPIRE TWO FROM THE DATE OF APPROVAL IF THE PROJECT HAS NOT STARTED.		OVAL DOES NOT NEGATE THE ICDPS ACCESS PERMIT,	