

#### HISTORIC PRESERVATION COMMISSION

Marc Elrich County Executive Robert Sutton Chairman

Date: December 21, 2023

#### **MEMORANDUM**

TO:	Rabbiah Sabbakhan
	Department of Permitting Services
FROM:	Dan Bruechert
	Historic Preservation Section
	Maryland-National Capital Park & Planning Commission
SUBJECT:	Historic Area Work Permit # 1045815 - Partial Demolition and Building Addition

The Montgomery County Historic Preservation Commission (HPC) has reviewed the attached application for a Historic Area Work Permit (HAWP). This application was <u>Approved</u> at the October 25, 2023 HPC meeting.

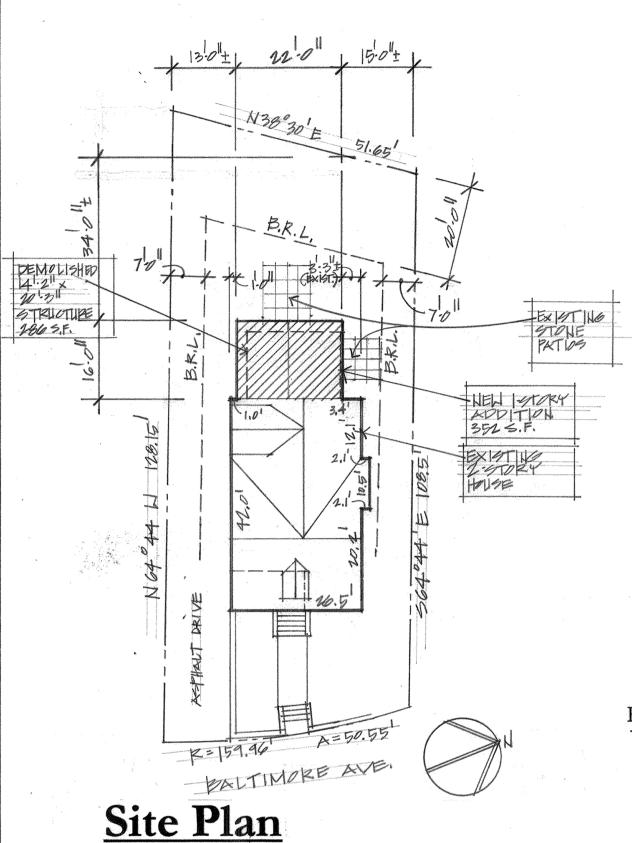
The HPC staff has reviewed and stamped the attached construction drawings.

THE BUILDING PERMIT FOR THIS PROJECT SHALL BE ISSUED CONDITIONAL UPON ADHERENCE TO THE ABOVE APPROVED HAWP CONDITIONS AND MAY REQUIRE APPROVAL BY DPS OR ANOTHER LOCAL OFFICE BEFORE WORK CAN BEGIN.

Applicant:Conor McCarthyAddress:7324 Baltimore Ave., Takoma Park

This HAWP approval is subject to the general condition that the applicant will obtain all other applicable Montgomery County or local government agency permits. After the issuance of these permits, the applicant must contact this Historic Preservation Office if any changes to the approved plan are made. Once work is complete the applicant will contact Dan Bruechert at 301.563.3408 or dan.bruechert@montgomeryplanning.org to schedule a follow-up site visit.





# 1" = 20'-0"

#### House/Site Information:

Lot: Part of 26 **Block**: 76 Address: 7324 Baltimore Ave., Takoma Park, MD 20912 Subdivision: TPL & T CO Year built: 1921 **Zoning:** R-60 Historic District: Takoma Park HAWP #1045815 approved: 10/25/2023

#### **Project Information:**

Demolish 286 SF 1-level rear addition (heavily damaged in a storm). Construct new 352 SF 1-level rear addition.

#### **Residential Code Information:**

All construction shall be in conformance with the International Residential Code (IRC), 2018 Edition, as Amended by Mont. Co., Reg. 31-19, adopted 5/20/2020.

#### **AREA CALCULATIONS**

EXISTING:	
Lot Area:	6105 s.f.
Lot Coverage/Building Area:	1408 s.f.
% of Lot Coverage:	23%
PROPOSED:	
Lot Coverage/Building Area	
(Addition only):	352 s.f.
Lot Coverage/Building Area	
(Original House + Addition):	1474 s.f.
% of Lot Coverage:	24%

### TOTAL NET NEW ROOF AREA: 66 s.f.

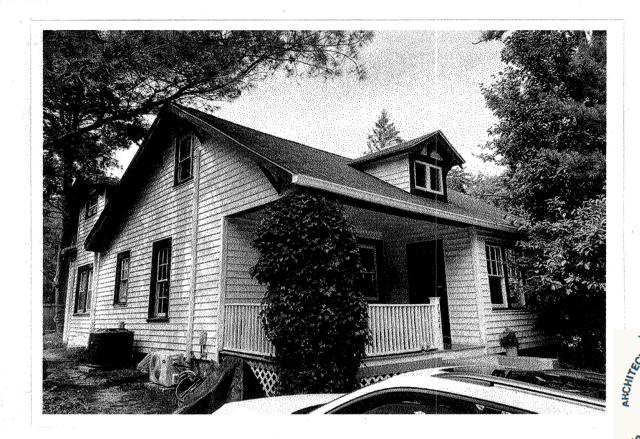
(net, after 286 s.f. rear addition demolished and 352 s.f. addition built)

#### ELECTRICAL & LIGHTING LEGEND

attention and the second second	*
"E"	Indicates existing unit (light or outlet) (all outlets to be made code-compliant)
	Duplex Outlet/new
A/C	Duplex Outlet/new/above counter
= GFCI	Duplex Outlet/new/GFCI (all outlets in kitchens, baths, and exterior are to be GFCI)
AFCI	Duplex Outlet/new/AFCI (All-Fault Circuit Interrupter outlets: for all but in Kitchen
<b>=</b> ∯=	Double Duplex Outlet
₩ F	Duplex Floor Outlet
<b>240</b>	240v Outlet
- <b>\$-</b> EF	Exhaust Fan
- <b>\$-</b> EF/H	Exhaust Fan/Heat
-Ф-ег/н/	т Exhaust Fan/Heat/Light
- $\phi$ - CF	Ceiling Fan
	Ceiling Fan/Light
- <b>今</b> -	Pendant Light Fixture
- <b>(</b> - <b>R</b>	Recessed Light Fixture
-Å-R	Recessed Light Fixture/Existing
- R/E	Recessed Light Fixture/Eyeball
-Ф-зм	Surface Mounted Light Fixture
OH .	Wall Mounted Light Fixture/Sconce
-O-WP	Light Fixture /Waterproof
D-FL	Dual Flood Light
DSL	Data/Telephone Jack
TV	Coaxial/Cable TV
SP	Audio Speaker
S	Switch
S D	Switch/Dimmer
S 3	Three-way Switch
	Track light
E== p	"Plugmold" Power Strip
=== 4 <sub>U/C</sub>	Undercabinet Lights
	Smoke & Carbon Monoxide Detectors (hard-wired in dedicated circuit, interconnected, with battery backup)
Т	Thermostat

# **House Addition McCarthy Residence**

7324 Baltimore Avenue, Takoma Park, MD 20912



APPROVED **Montgomery County Historic Preservation Commission** 

RAMEL. MATTA

REVIEWED By Dan.Bruechert at 9:48 am, Dec 21, 2023

## Sheet No. Sheet Title Cover Site Plan/Project Description/ Electrical & Lighting Legend/ D-1 1st Floor Demolition Plan (1/4"=1'-0")/ Demolition Notes A-1 First Floor Plan (1/4"=1'-0")/ Roof Plan (1/4"=1'-0") A-2 Exterior Elevations (1/4"=1'-0")/ Building Section (1/4"=1'-0") Exterior Elevation (1/4"=1'-0")/ A-3 Building Section (1/4"=1'-0")/ Wall Section (1"=1'-0") Window & Door Schedule A-4 Finish Schedule A-5 General Construction Notes/ Mechanical/HVAC Notes/ Electrical & Lighting Notes/ Plumbing Notes/ Specifications EC-1 Air Barrier, Insulation & Thermal Barrier Schedule and Diagrams S-1 Structural Specifications & Notes S-2 Foundation & 1st Floor Framing Plan $(1/4^{2}=1^{2}-0^{2})$ S-3 Roof Framing Plan (1/4"=1'-0") Wind Brace Diagram & Schedule S-4

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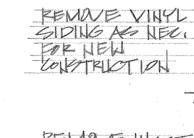
McCarthy Residence 7324 Baltimore Avenue Takoma Park, MD 20912 **11-14-2023** 

COVER

APPROVED Montgomery County **Historic Preservation Commission** 

2.4

REVIEWED By Dan.Bruechert at 9:48 am, Dec 21, 2023



DOOR

MUDROOM + VESTIBULE

# **GENERAL DEMOLITION NOTES:**

1. Demolish any construction as noted on the plans that was damaged beyond repair by the tree fall, water infiltration or mold intrusion that will hinder any aspect of the new construction.

2. Remove/re-route plumbing (water supplies, drains, vents and gas lines, radiators, etc.) as necessary to accomplish new plan layout and to minimize their impact on the new space; cap off lines as necessary during construction. If any lines discovered cannot be moved/re-routed easily, notify architect to review solutions.

3. Remove all trim, gypsum board/plaster, doors, thresholds, flooring, etc. but only as necessary to implement new layout and design.

4. For removal of any lead paint, asbestos tile, etc., a certified asbestos or lead abatement professional must be used. Contractor to ensure that containment barriers are in place to keep debris and dust at a minimum; workers to utilize proper protection equipment from hazards.

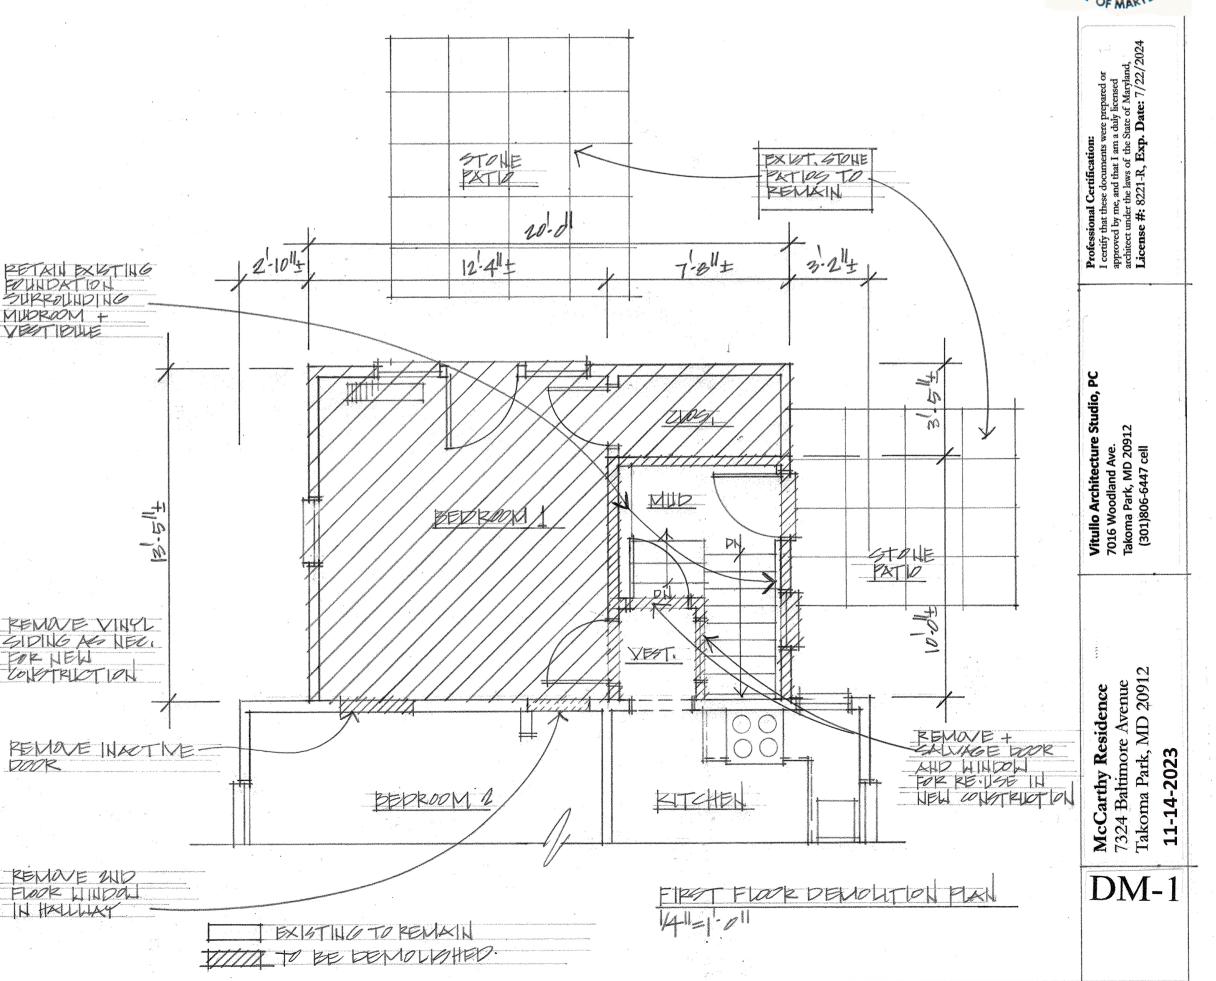
5. Remove existing wall and/or floor construction as noted on plans as necessary to implement new layout; if walls are bearing walls, use temporary supports to re-direct loads until new bearing elements are constructed. (If walls or other elements that were previously assumed to be non-bearing are actually bearing, notify architect and/or engineer immediately.)

6. Remove and salvage (as per owners' request) existing light fixtures to implement new plan layout.

7. Remove all electrical outlets, fixtures, smoke alarms, telephone wiring, exposed wiring, etc. that are to be replaced by new work.

8. Dispose of all discarded material in a safe and clean manner.

9. Protect all surfaces during demolition (and construction) from unnecessary damage.



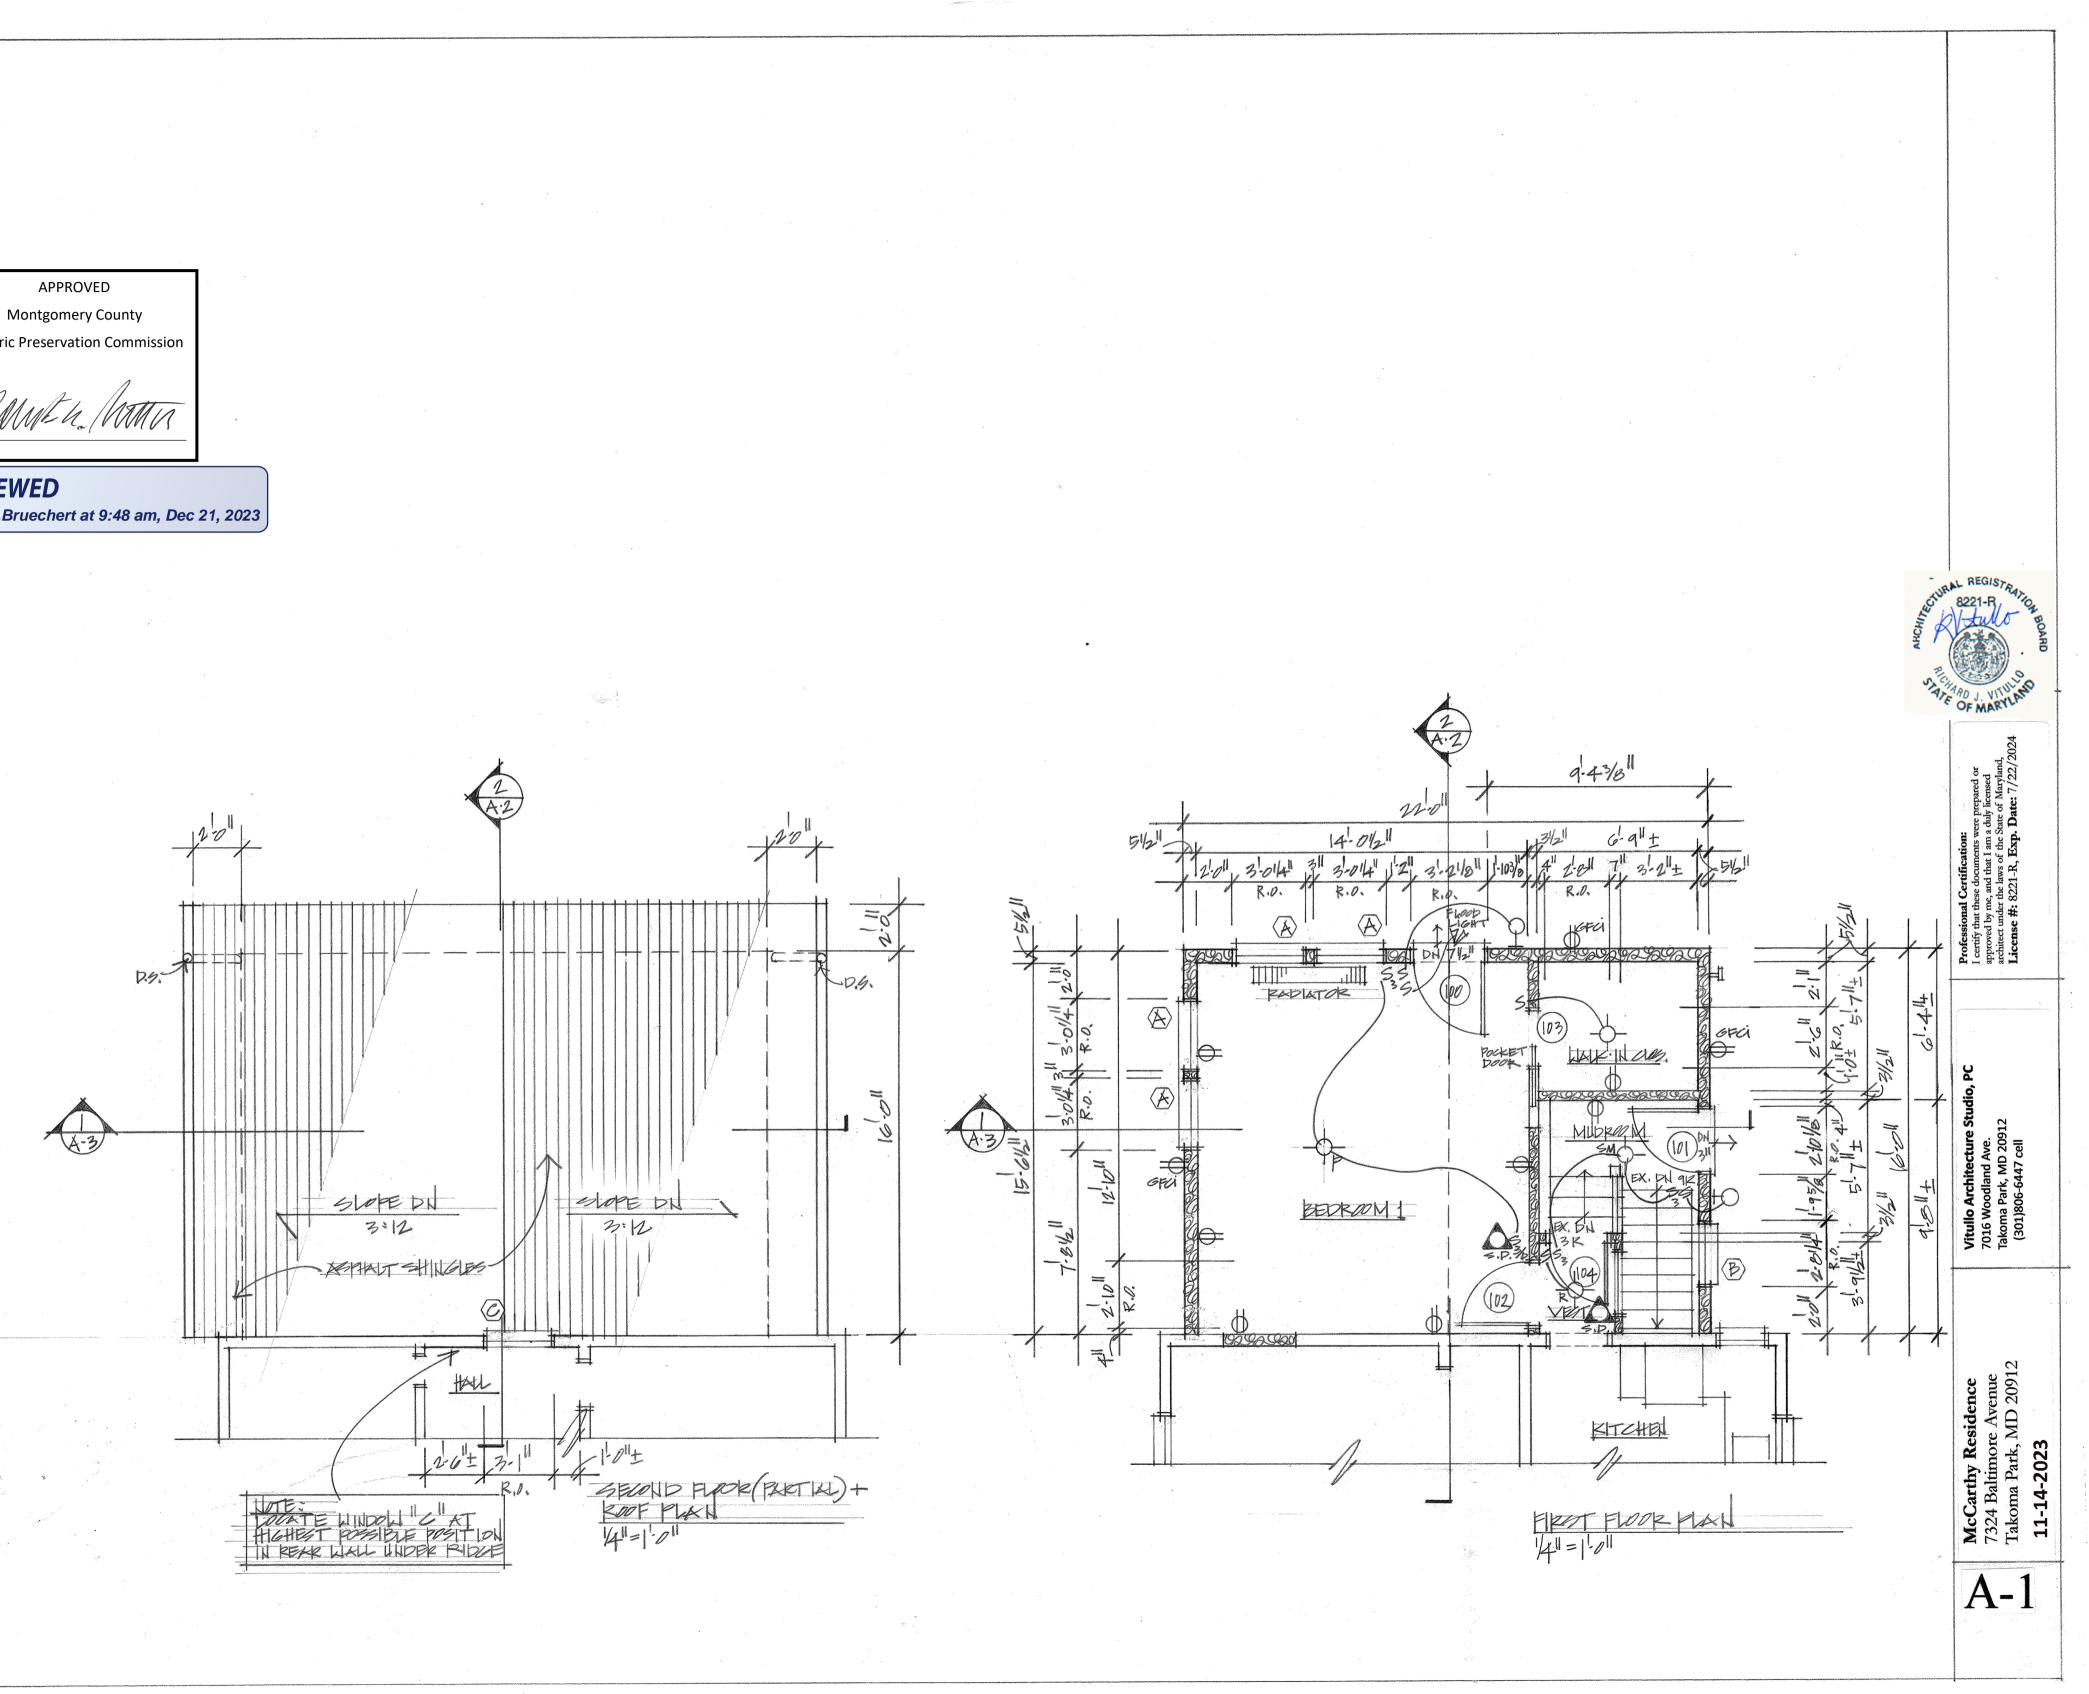
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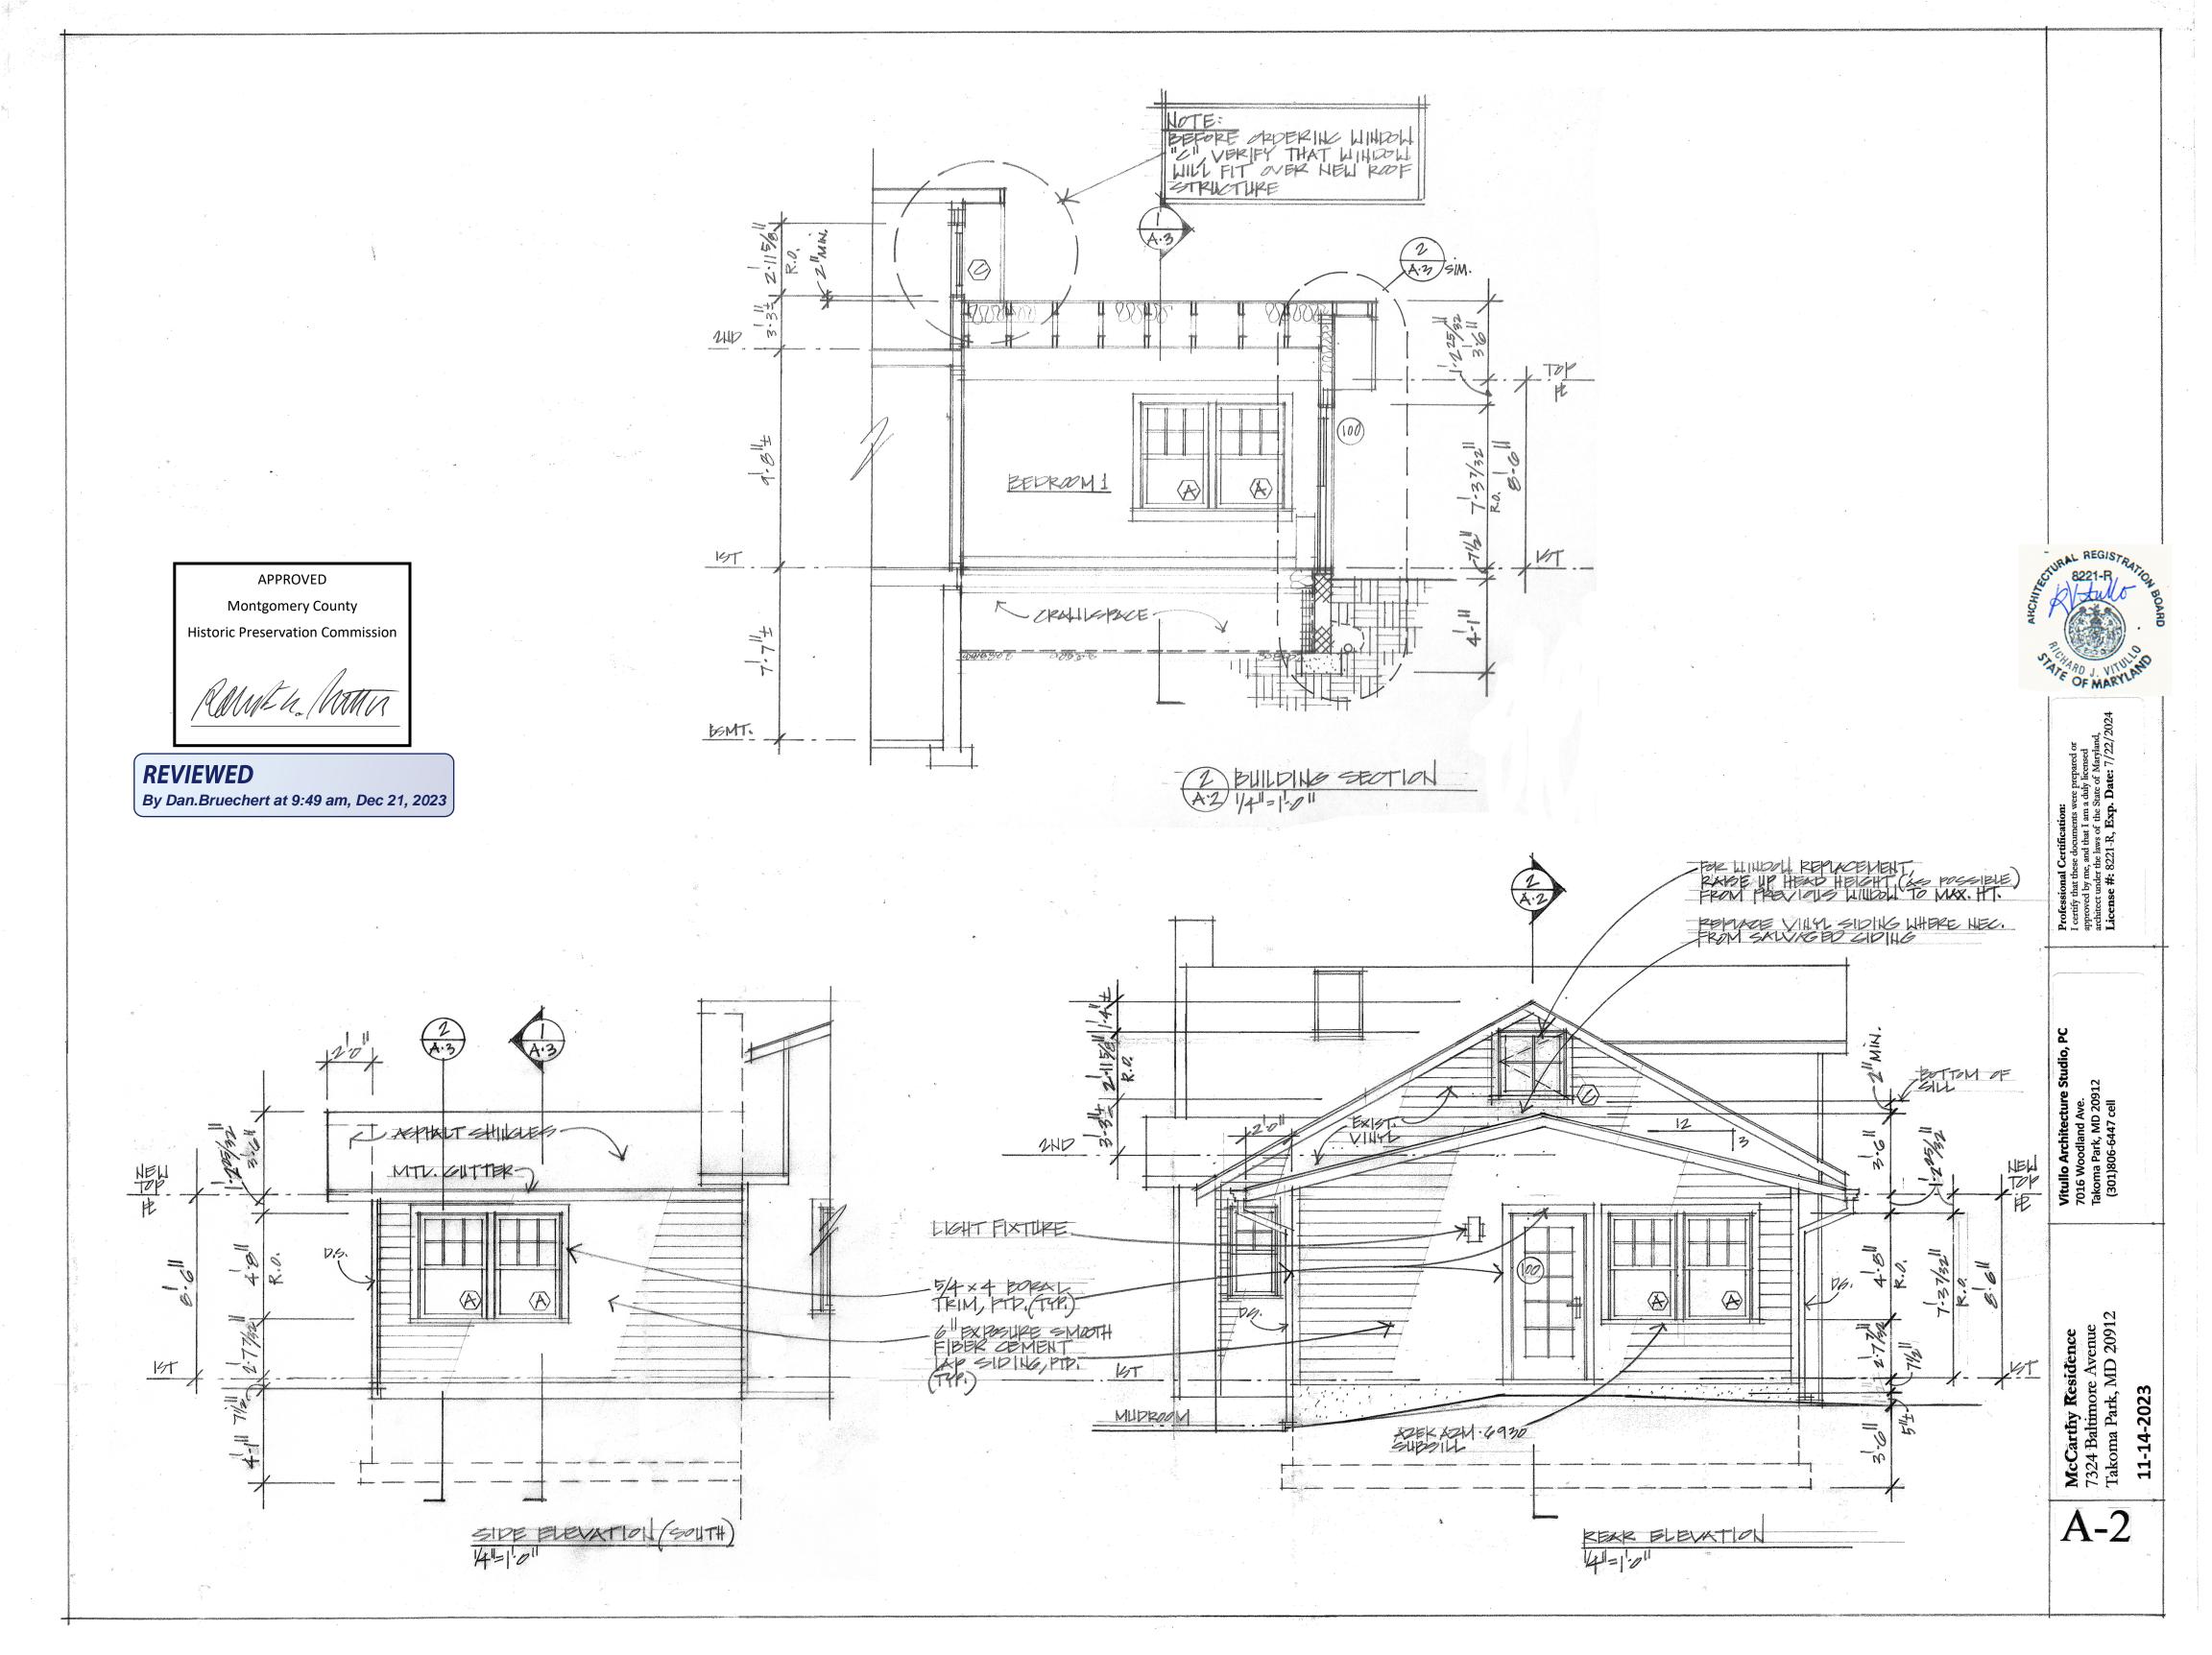
Historic Preservation Commission

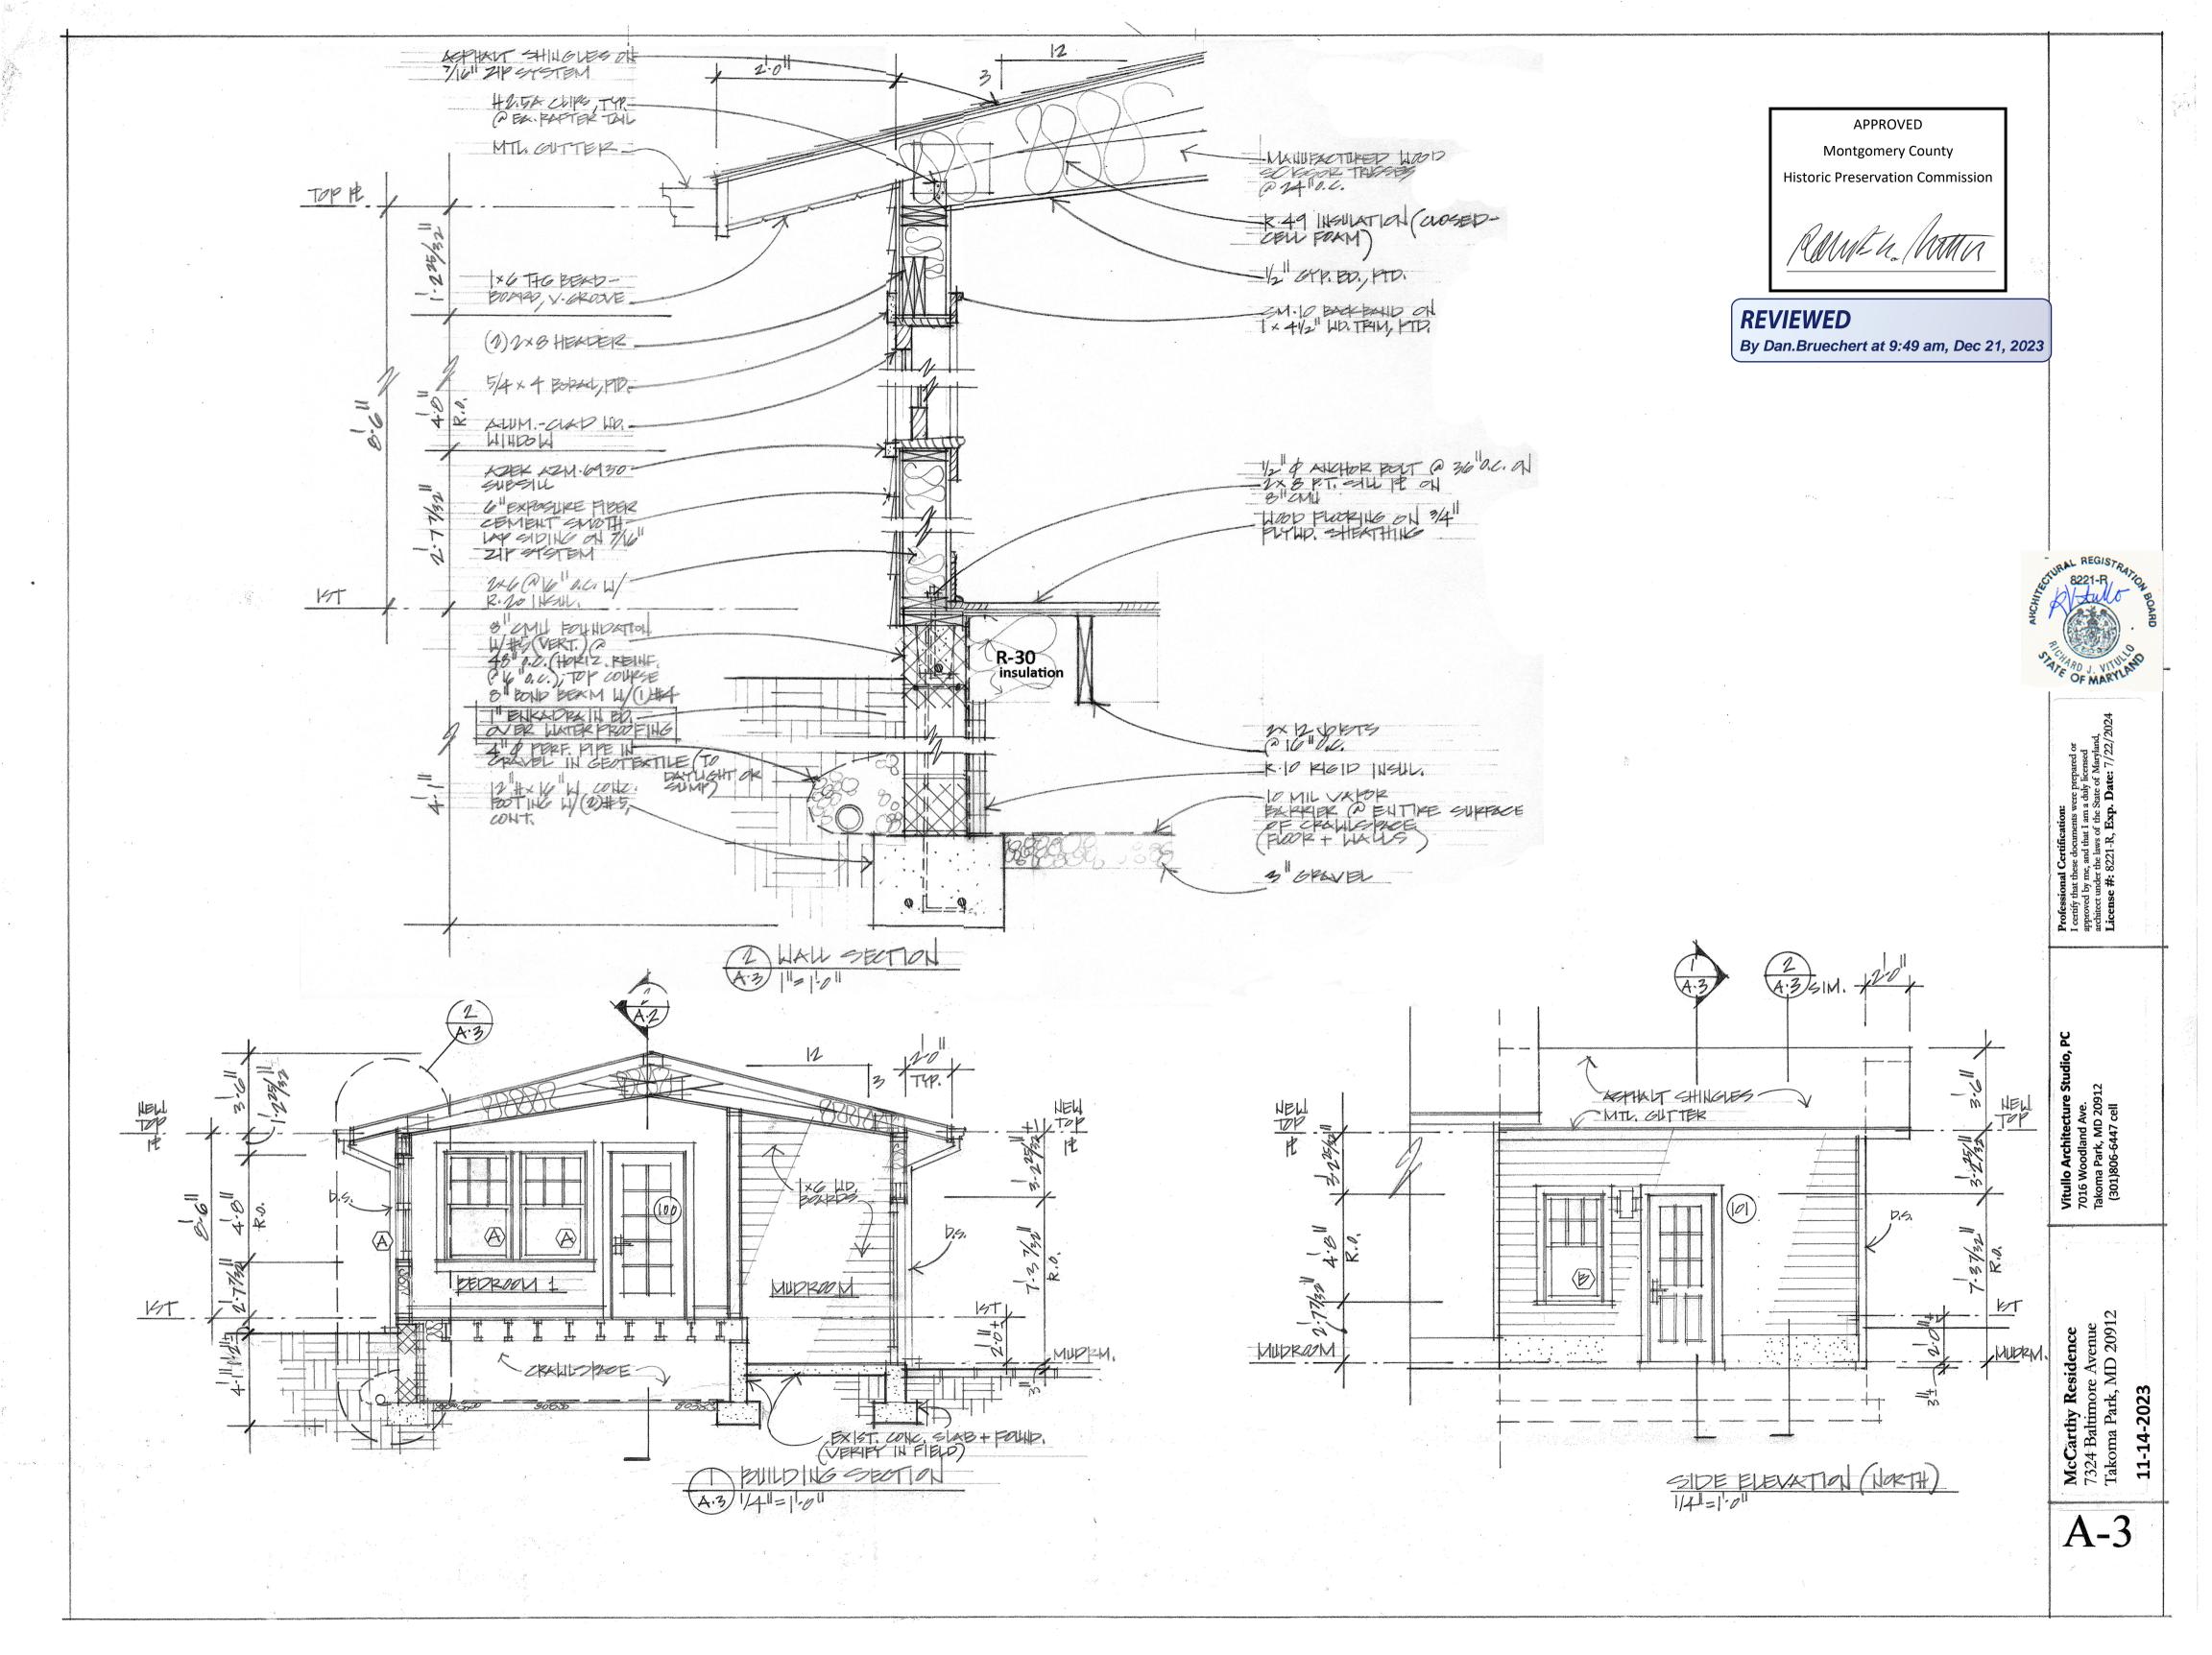
UME h. MATTA

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# REVIEWED By Dan.Bruechert at 9:48 am, Dec 21, 2023







APPROVED

Montgomery County Historic Preservation Commission

RAME L. MATTA

# REVIEWED

By Dan.Bruechert at 9:49 am, Dec 21, 2023

	M	VINDOW SCHEDUL	E			Man	ufacturer- Windows: Marvin Uli	imate			- -				La income di		linter en
No.	Mfr. Window Line/ Model No.	Height, Unit (R.O.)	Width, Unit (R.O.)	Jamb Depth	Window Type/Material	Glazing Type	Grille Structure	Mullion Divisions	Interior Color	Exterior Clad Color	Screens / Screen Door	Hardware	SHGC- value Total Unit	U-value Total Unit	Egress window	Quant.	Remarks
Α	Ultimate UDHG2 3024	4'-7 1/2" (4'-8" R.O.)	2'-11 1/4" (3'-0 1/4" R.O.)	2 X 6 wall	DOUBLE HUNG /wood interior & aluminum-clad exterior	TEMPERED 7/8" Insulating glass Low E2 w/ Argon	5/8" SDL, w/ spacer bar/ Ogee Profile	6-over-1	White	"Stone White"	YES	TBD	0.3	0.3	n/a	4	SEE ELEVATIONS FOR MULLION LAYOU
В	Ultimate UDHG2 2624	4'-7 1/2" (4'-8" R.O.)	2'-7 1/4" (2'-8 1/4" R.O.)	2 X 6 wall	DOUBLE HUNG /wood interior & aluminum-clad exterior	TEMPERED 7/8" Insulating glass Low E2 w/ Argon	5/8" SDL, w/ spacer bar/ Ogee Profile	6-over-1	White	"Stone White"	YES	TBD	0.3	0.3	n/a	1	SEE ELEVATIONS FOR MULLION LAYOU
С	Ultimate UCA 3636 E	2'-11 1/8" (2'-11 5/8" R.O.)	3'-0" (3'-1" R.O.)	2 X 4 wall	CASEMENT /wood interior & fiberglass-clad exterior	TEMPERED 3/4" Insulating glass Low E2 w/ Argon	5/8" SDL, w/ spacer bar/ Ogee Profile	4 lites	White	"Stone White"	YES	TBD	0.3	0.29	YES	1	BEFORE ORDERING WINDOW "C", VERIFY THAT WINDOW WILL FIT OVER NEW ROOF STRUCTURE; SEE ELEVATION FOR MULLION LAYOUT
UBTOTAL	· · ·												0.30 avg.	0.30 avg.		6 units	
,	**************************************	DOOR SCHEDULE	a que en sinante de la constante de la constant		an dan saka kana di sang manjan manan kana kana saka saka saka pana dan baran dan saka saka saka saka saka sak	Mar	nufacturer- Doors: Kolbe Ultra/	TBD		-		augen o carana a den ar se and manage y construction of data cara in a sub-property conservable da and a second			1		
No.	Mfr. No.	Height, Unit (R.O.)	Width, Unit (R.O.)	Jamb Depth	Door Type / Material	Glazing Type	Grille Structure	Mullion Divisions	Interior Color	Exterior Clad Color	Screens / Screen Door	Hardware/ Sill Material	SHGC-value Total Unit	U-value Total Unit	Swing direction (shown from outdside room)	Quant.	
100	Ultra UXD 3070/ HR with UP 825 Panel Design	7'-2 23/32" (7'-3 7/32" R.O.)	3'-1 5/8" (3'-2 1/8" R.O.)	2 x 6 wall	INSWING Entrance Door/ wood interior & alumclad exterior	TEMPERED Insulating glass LoE-366	7/8" " <u>PDL</u> " Beveled with 2W5H pattern	10 lites	White	"White"	TBD	Handle TBD/ Sill: aluminum "Weep Sill"	0.1	0.28	HR	1	Exterior Door (SEE PLANS FOR SWING DIRECTION)
101	Ultra UXD 2870/ HL with UP 8233 Panel Design	7'-2 23/32" (7'-3 7/32" R.O.)	2'-9 5/8" (2'-10 1/8" R.O.)	2 x 6 wall	INSWING Entrance Door/ wood interior & alumclad exterior	TEMPERED Insulating glass LoE-366	1 lite over 2 panels/ 8" cross rail at 40"/ 7/8" " <u>PDL</u> " Beveled with 3W3H pattern	9 lites	White	"White"	TBD	Handle TBD/ Sill: aluminum "Weep Sill"	0.1	0.28	HL	1	Exterior Door (SEE PLANS FOR SWING DIRECTION)
102	TBD	6'-8" (6'-9" R.O.)	2'-8" (2'-10" R.O.)	2 x 4 wall	Solid Wood 5-Panel SWING Door (match exist.)	n/a	n/a	n/a	TBD	n/a	n/a	TBD	n/a	n/a	Left Hand	1	Interior Door (SEE PLANS FOR SWING DIRECTION)
103	Salvaged door	6'-8" (6'-9" R.O.)	2'-4" (2'-6" R.O.)	2 x 4 wall	Solid Wood 5-Panel SWING Door (match exist.)	n/a	n/a	n/a	TBD	n/a	n/a	ŤBD	n/a	n/a	n/a	1	Interior Door
104	Salvaged door	6'-8" (6'-9" R.O.)	2'-6" (2'-8" R.O.)	2 x 4 wall	Solid Wood 2-Panel SWING Door	n/a	n/a	n/a	TBD	n/a	n/a	TBD	n/a	n/a	Left Hand	1	Salvaged Interior Door (SEE PLANS FOR SWING DIRECTION)
UBTOTALS										•			0.28 avg.	0.28 avg.		5 units	
TOTALS									E state of the sta	and the second s			0.28 avg.	0.27 avg.		11 units	and the second

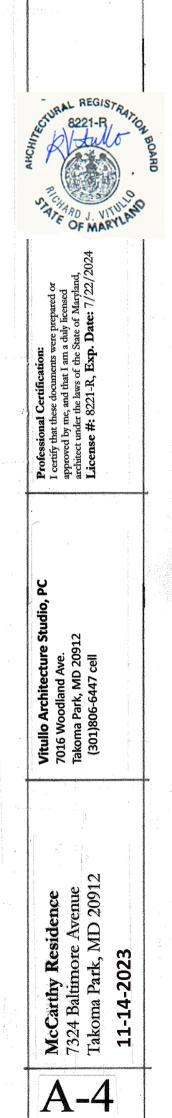
**FINISH SCHEDULE FIRST FLOOR** ROOM FLOORS BASE/ WAINSCOT WINDOW / DOOR TRIM Apron Material \* Material Finish Material Finish Head Material Jamb Material \* Fin Existing Tile (Repair/ SM-10 backband at outer SM-10 backband at Low Vestibule n/a replace if damaged, as WM-167 cap over 1 x 6 Low VOC Paint 1 x 6 edge of 1 x 4 1/2" outer edge of 1 x 4 1/2" Pa needed) Existing Tile (Repair/ replace if damaged, as Low Pai n/a SM-97 Low VOC Paint 5/4 x 4 Mudroom 5/4 x 4 5/4 x 4 needed) New or Reclaimed High-Traffic Epoxy or Polyurethane SM-10 backband at outer edge of 1 x 4 1/2" Low Pai SM-10 backband at outer edge of 1 x 4 1/2" & G Wood Flooring (TBD) New or Reclaimed T & G Wood Flooring (TBD) WM-167 cap over 1 x 6 Low VOC Paint **Master Bedroom** 1 x 6 T High-Traffic Epoxy or Polyurethane SM-10 backband at outer edge of 1 x 4 1/2" SM-10 backband at outer edge of 1 x 4 1/2" Low Y Pa WM-167 cap over 1 x 6 Low VOC Paint Closet 1 x 6 (TBD)

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					an tang 1 Tan tang 1 Tan tang 1		
				<u>.</u>			
	WALLS		CEILING		Ceiling Height	Area +/- (Sq.Ft)	Remarks
-inish	Material	Finish	Material	Finish			1990au
w VOC Paint	1/2-inch gyp. bd.	Low VOC Paint	1/2-inch gyp. bd.	Low VOC Paint	8'-6"	12	
w VOC Paint	1 x 6 horiz. wood (TBD) boards (ptd.) with 1/8" gap between over 1/2-inch gyp. bd.	Low VOC Paint	1/4" thick beadboard (ptd.) over 1/2- inch gyp. bd.; <b>WM-86 wood cove</b> at wall intersection	Low VOC Paint	~ 10'-6" <del>+</del> /-	54	See detail on A-1 for wall material design
w VOC Paint	1/2-inch gyp. bd.	Low VOC Paint	1/2-inch gyp. bd.	Low VOC Paint	Varies: 8'-6" to 10'-0"	217	-
w VOC Paint	1/2-inch gyp. bd.	Low VOC Paint	1/2-inch gyp. bd.	Low VOC Paint	Varies: 8'-6" to 9'-0" +/-	38	1

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