

HISTORIC PRESERVATION COMMISSION

Marc Elrich
County Executive

Robert K. Sutton

Chairman

Date: March 29, 2022

MEMORANDUM

TO: Rabbiah Sabbakhan

Department of Permitting Services

FROM: Dan Bruechert

Historic Preservation Section

Maryland-National Capital Park & Planning Commission

SUBJECT: Historic Area Work Permit #101027 - Partial Demo, New Porch, Deck, and Stairs

The Montgomery County Historic Preservation Commission (HPC) has reviewed the attached application for a Historic Area Work Permit (HAWP). This application was **Approved** at the November 16, 2022 HPC meeting with revisions approved by HPC Staff on March 29, 2023.


The HPC staff has reviewed and stamped the attached construction drawings.


THE BUILDING PERMIT FOR THIS PROJECT SHALL BE ISSUED CONDITIONAL UPON ADHERENCE TO THE ABOVE APPROVED HAWP CONDITIONS AND MAY REQUIRE APPROVAL BY DPS OR ANOTHER LOCAL OFFICE BEFORE WORK CAN BEGIN.


Applicant: Jeff Macmillan & Lucinda Leach Address: 7203 Holly Ave., Takoma Park


This HAWP approval is subject to the general condition that the applicant will obtain all other applicable Montgomery County or local government agency permits. After the issuance of these permits, the applicant must contact this Historic Preservation Office if any changes to the approved plan are made. Once work is complete the applicant will contact Dan Bruechert at 301.563.3400 or dan.bruechert@montgomeryplanning.org to schedule a follow-up site visit.




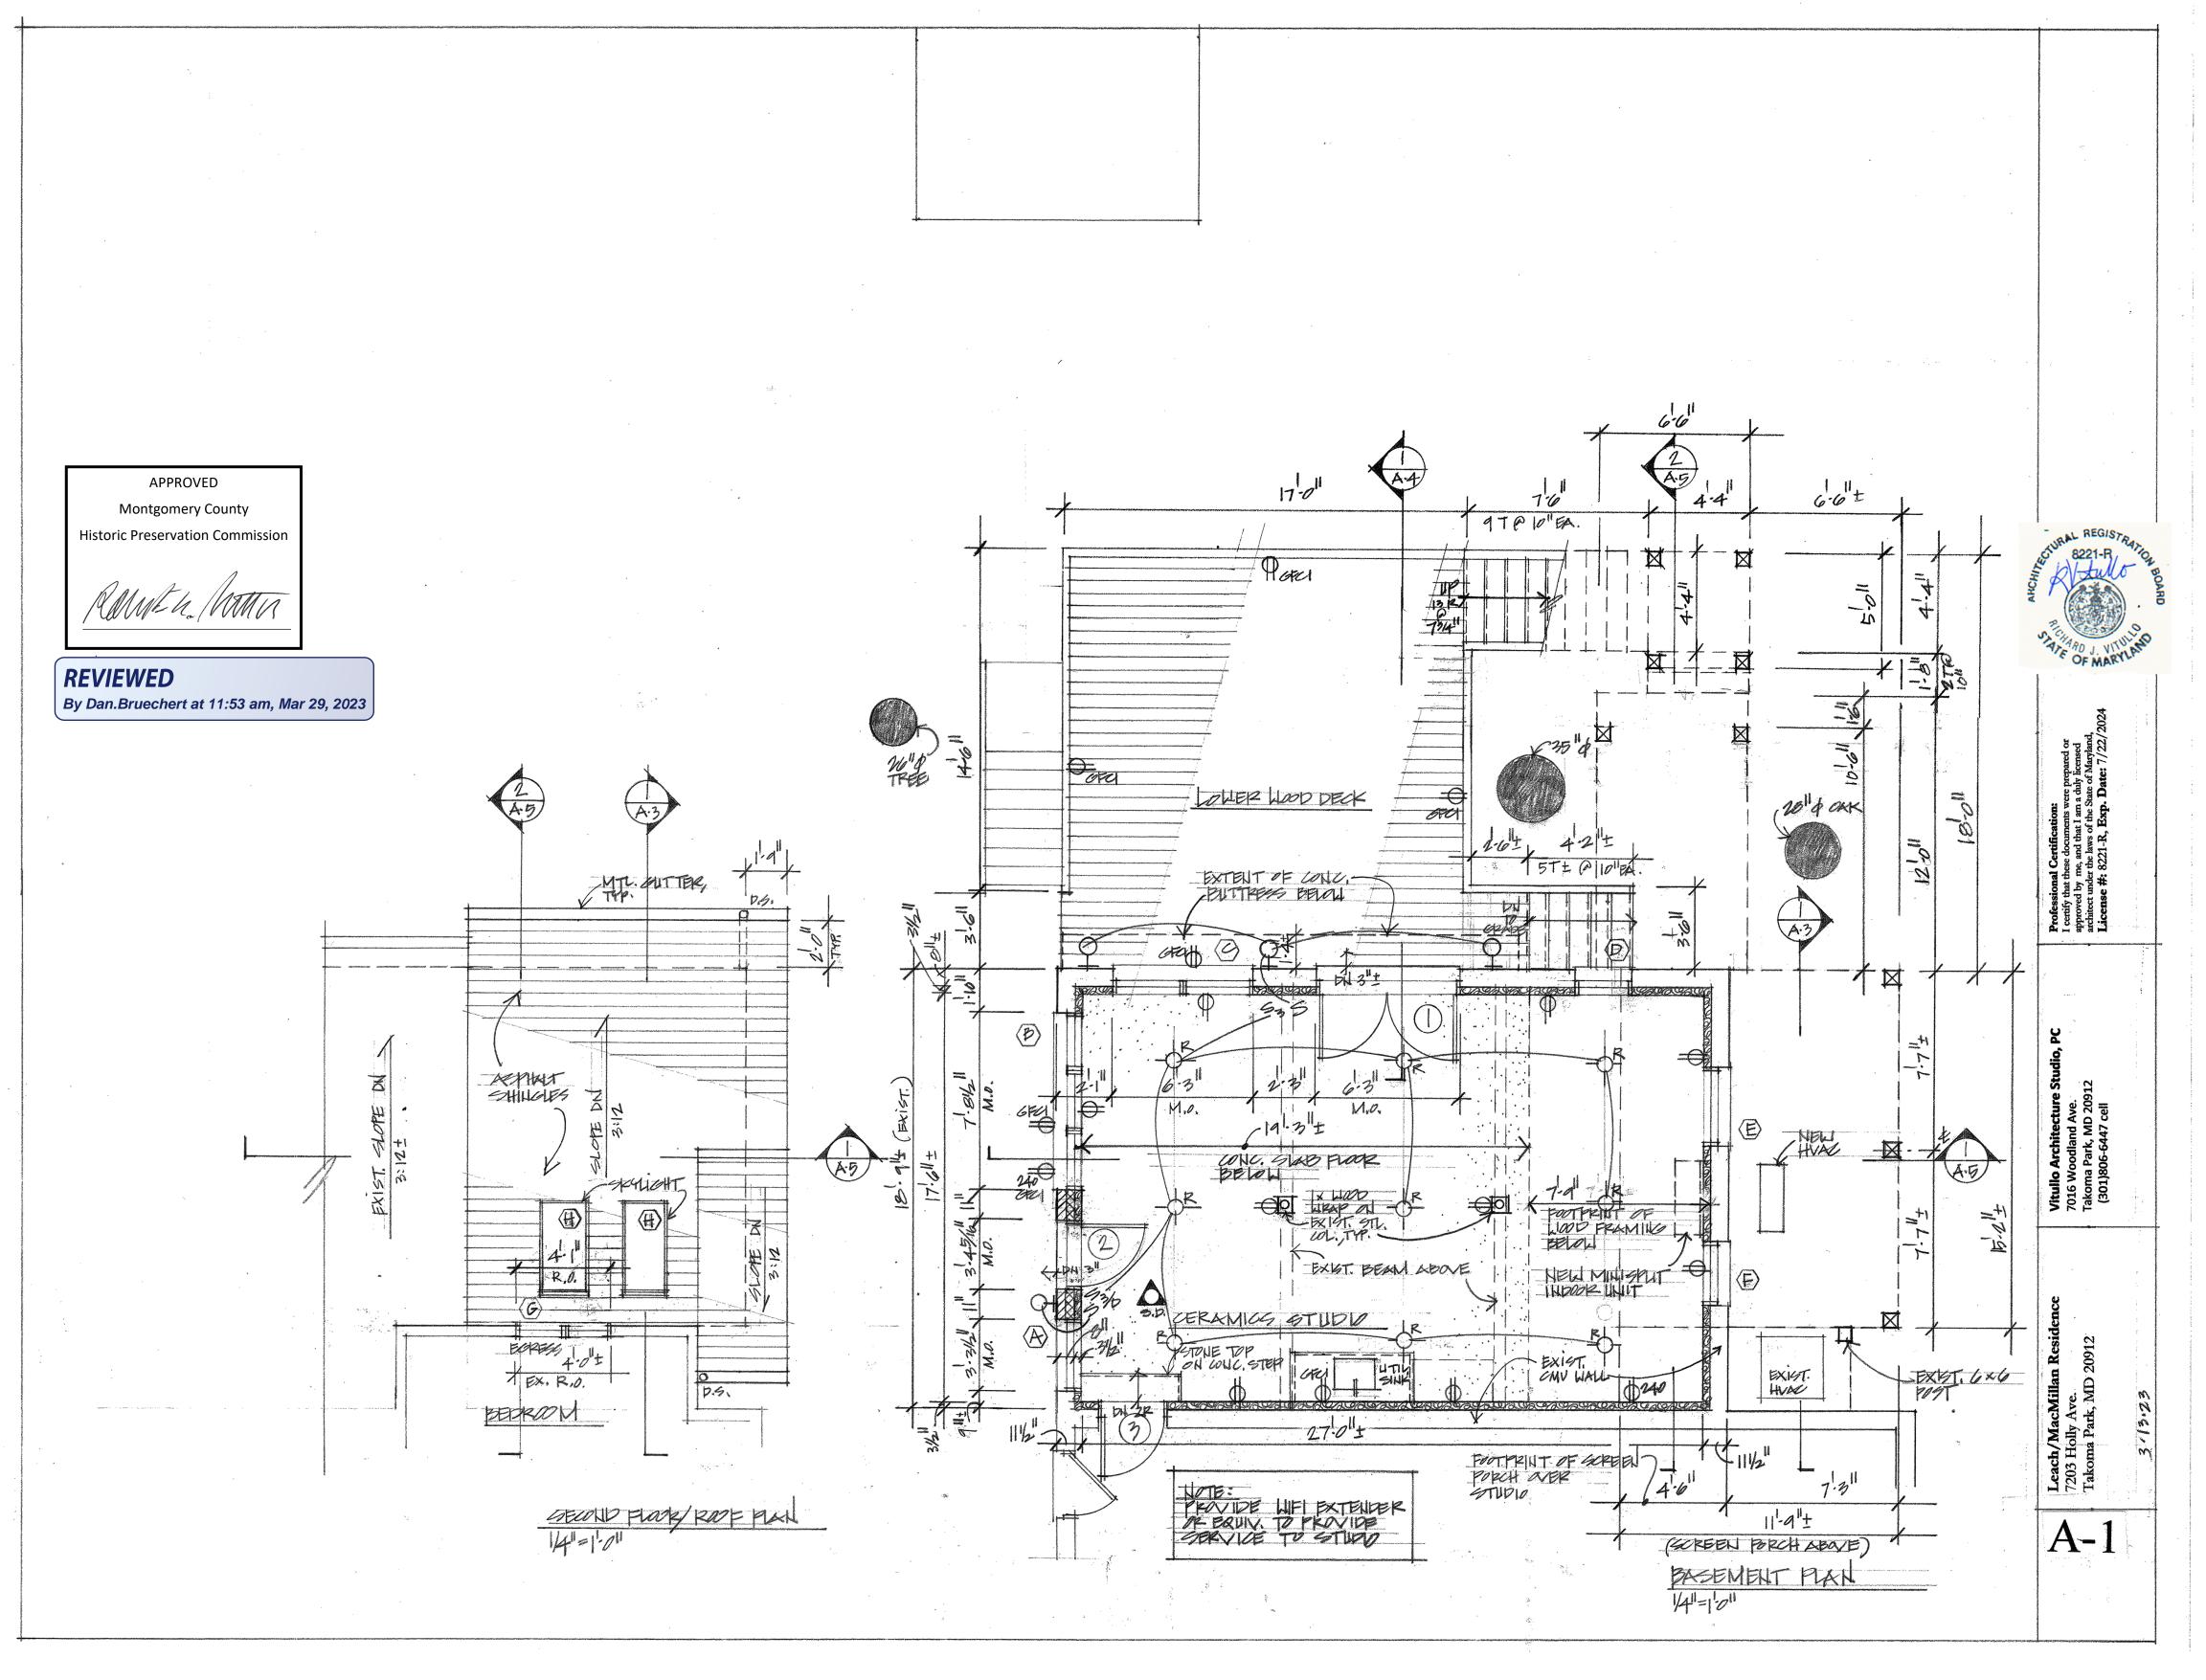

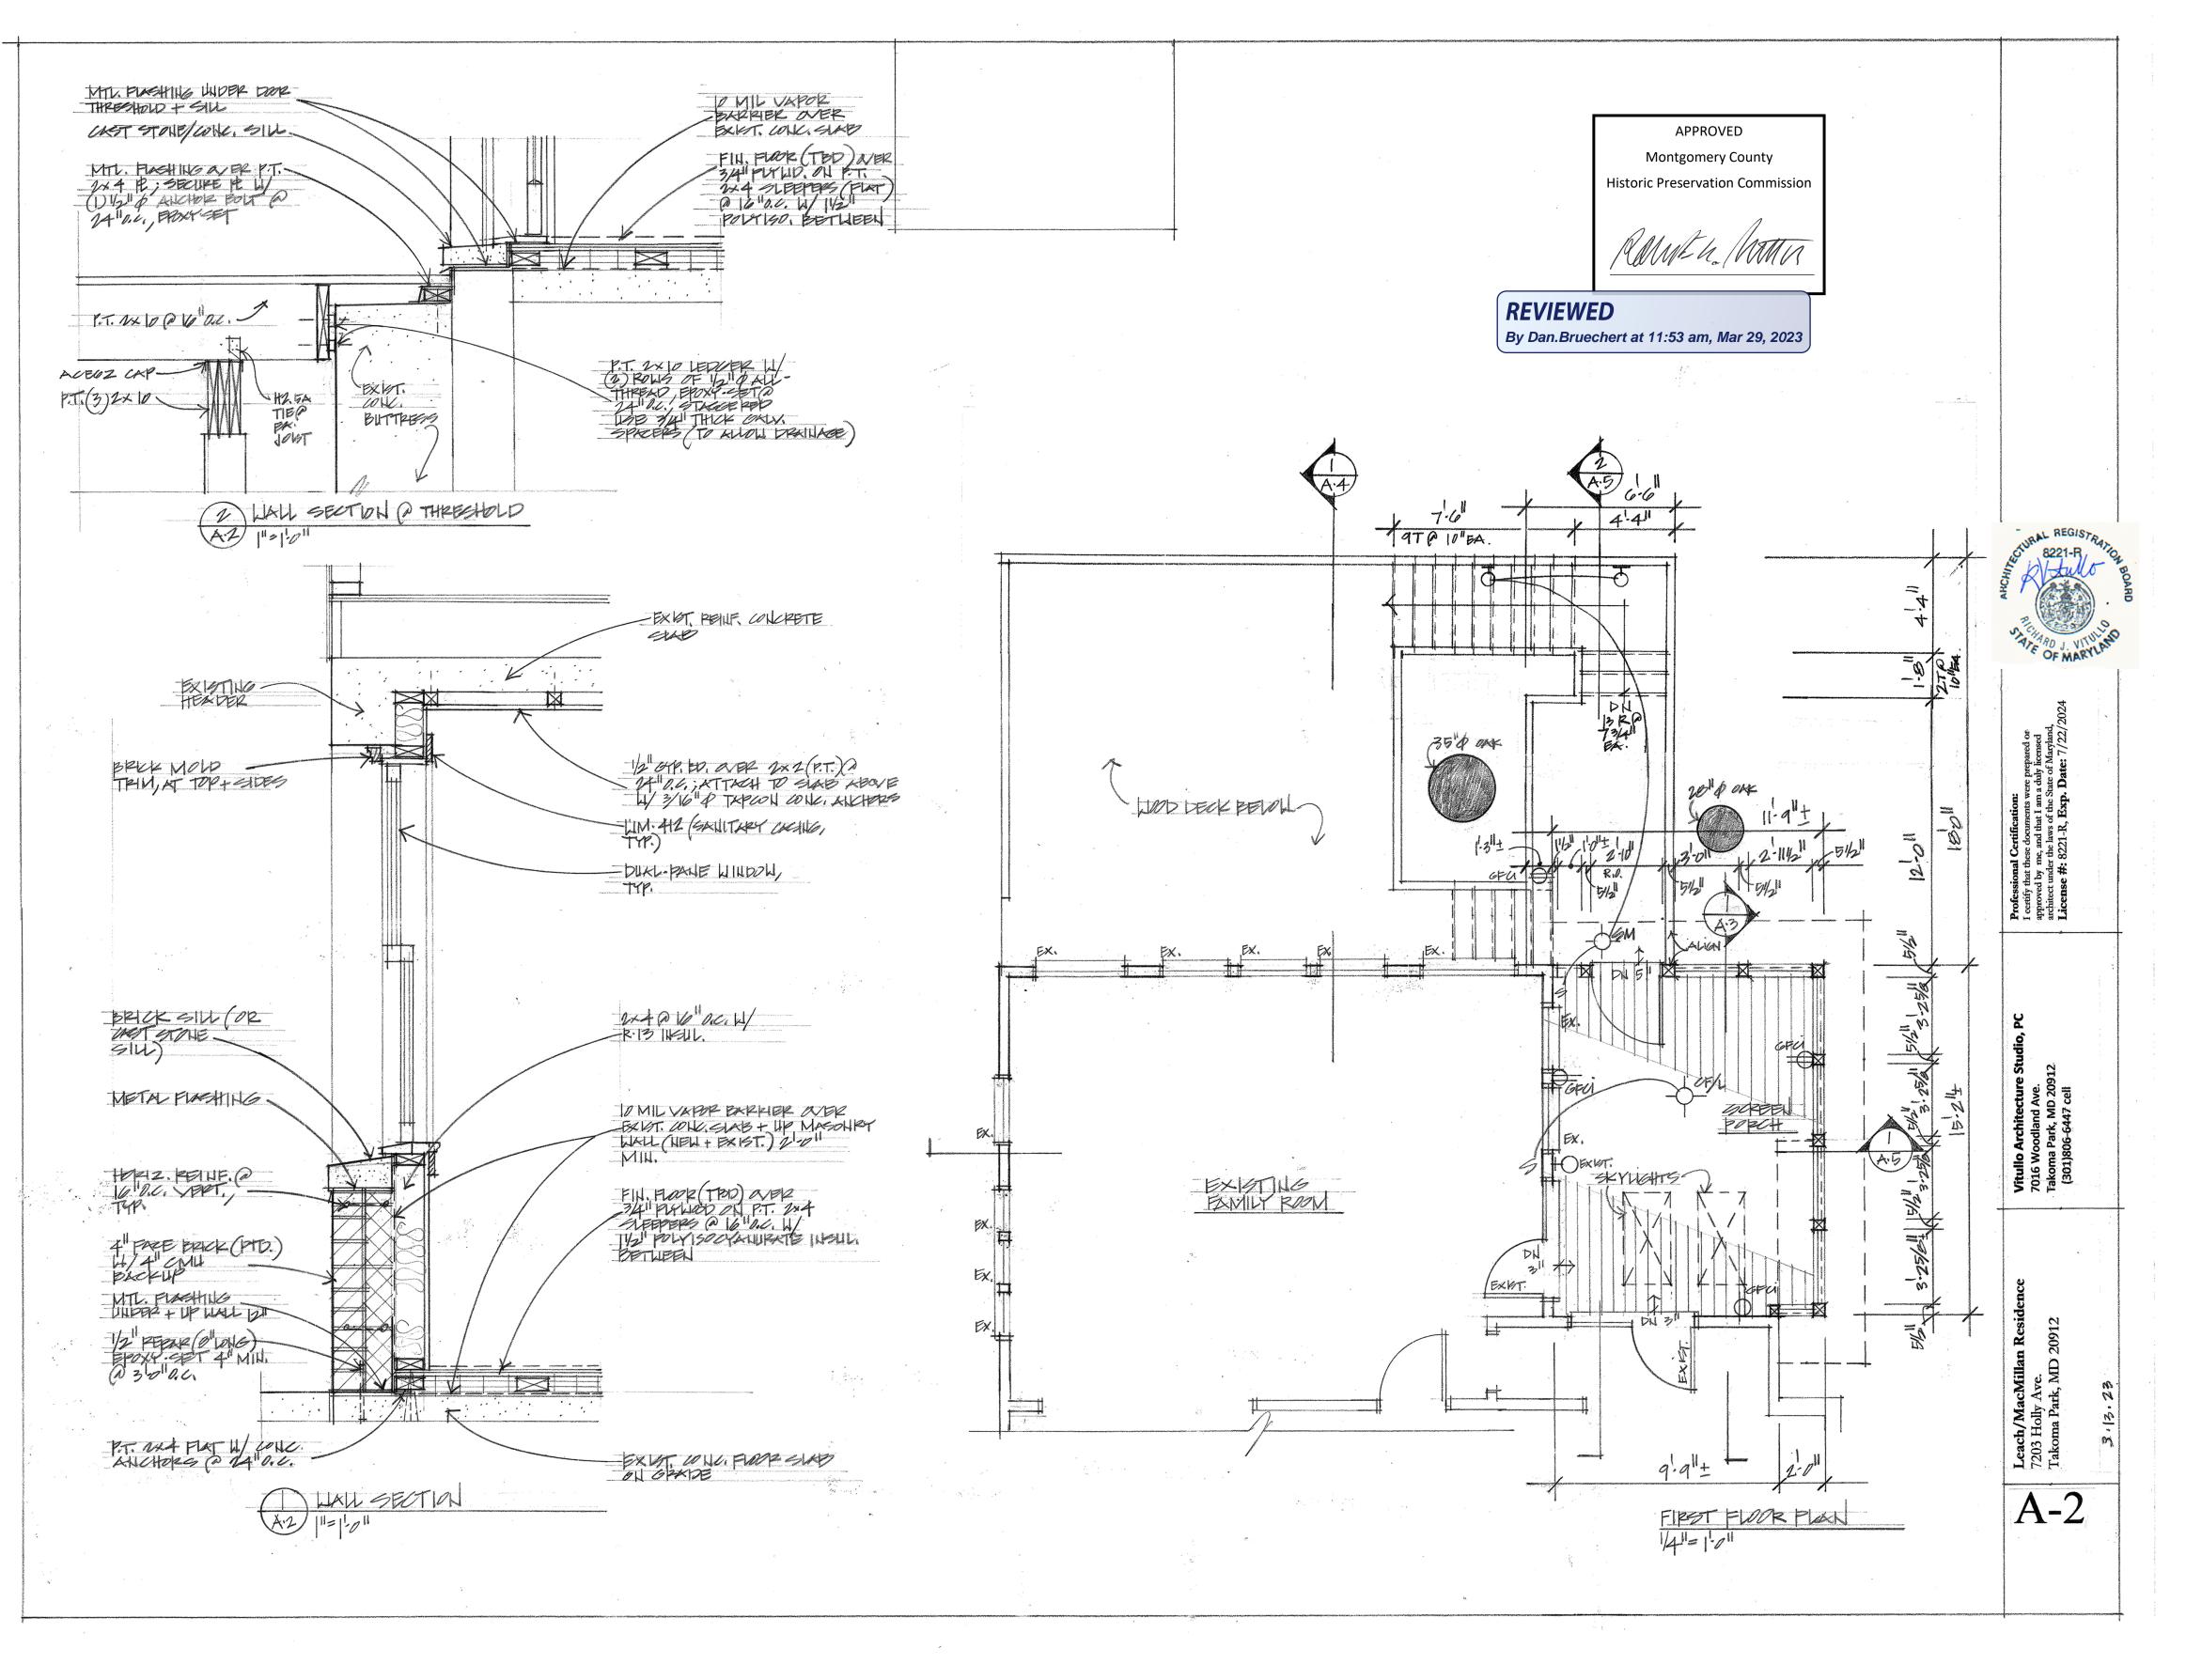

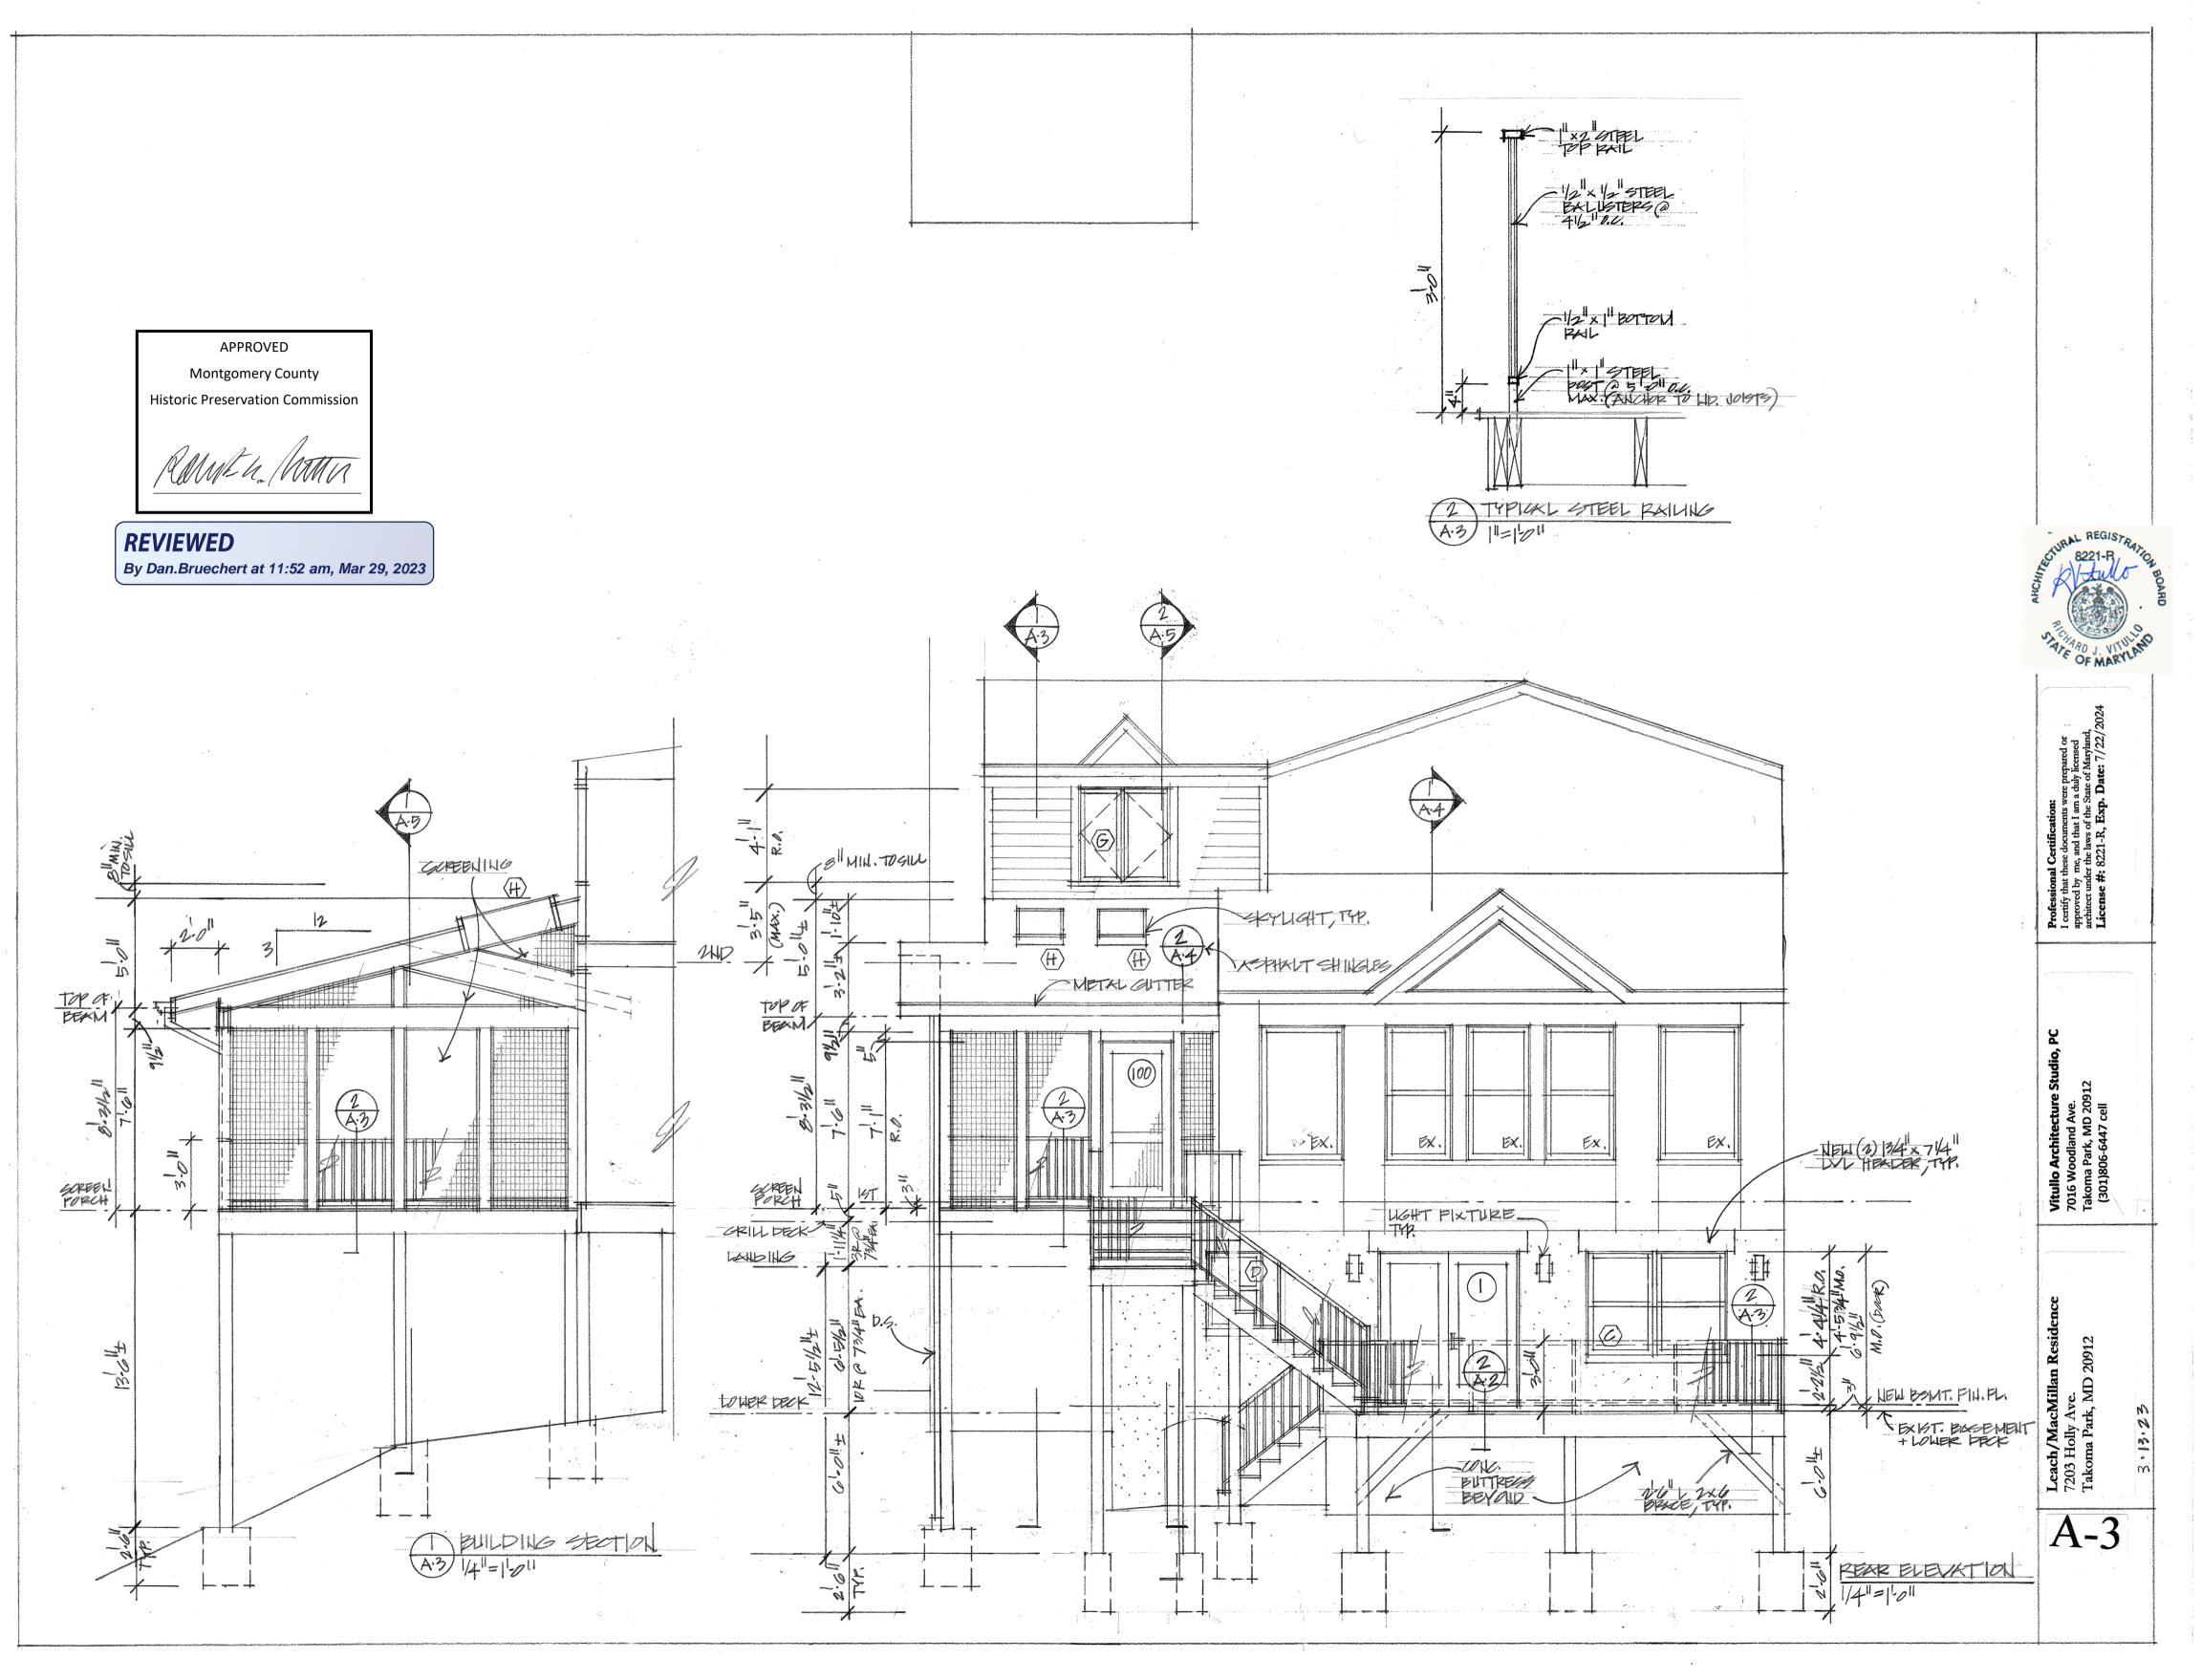

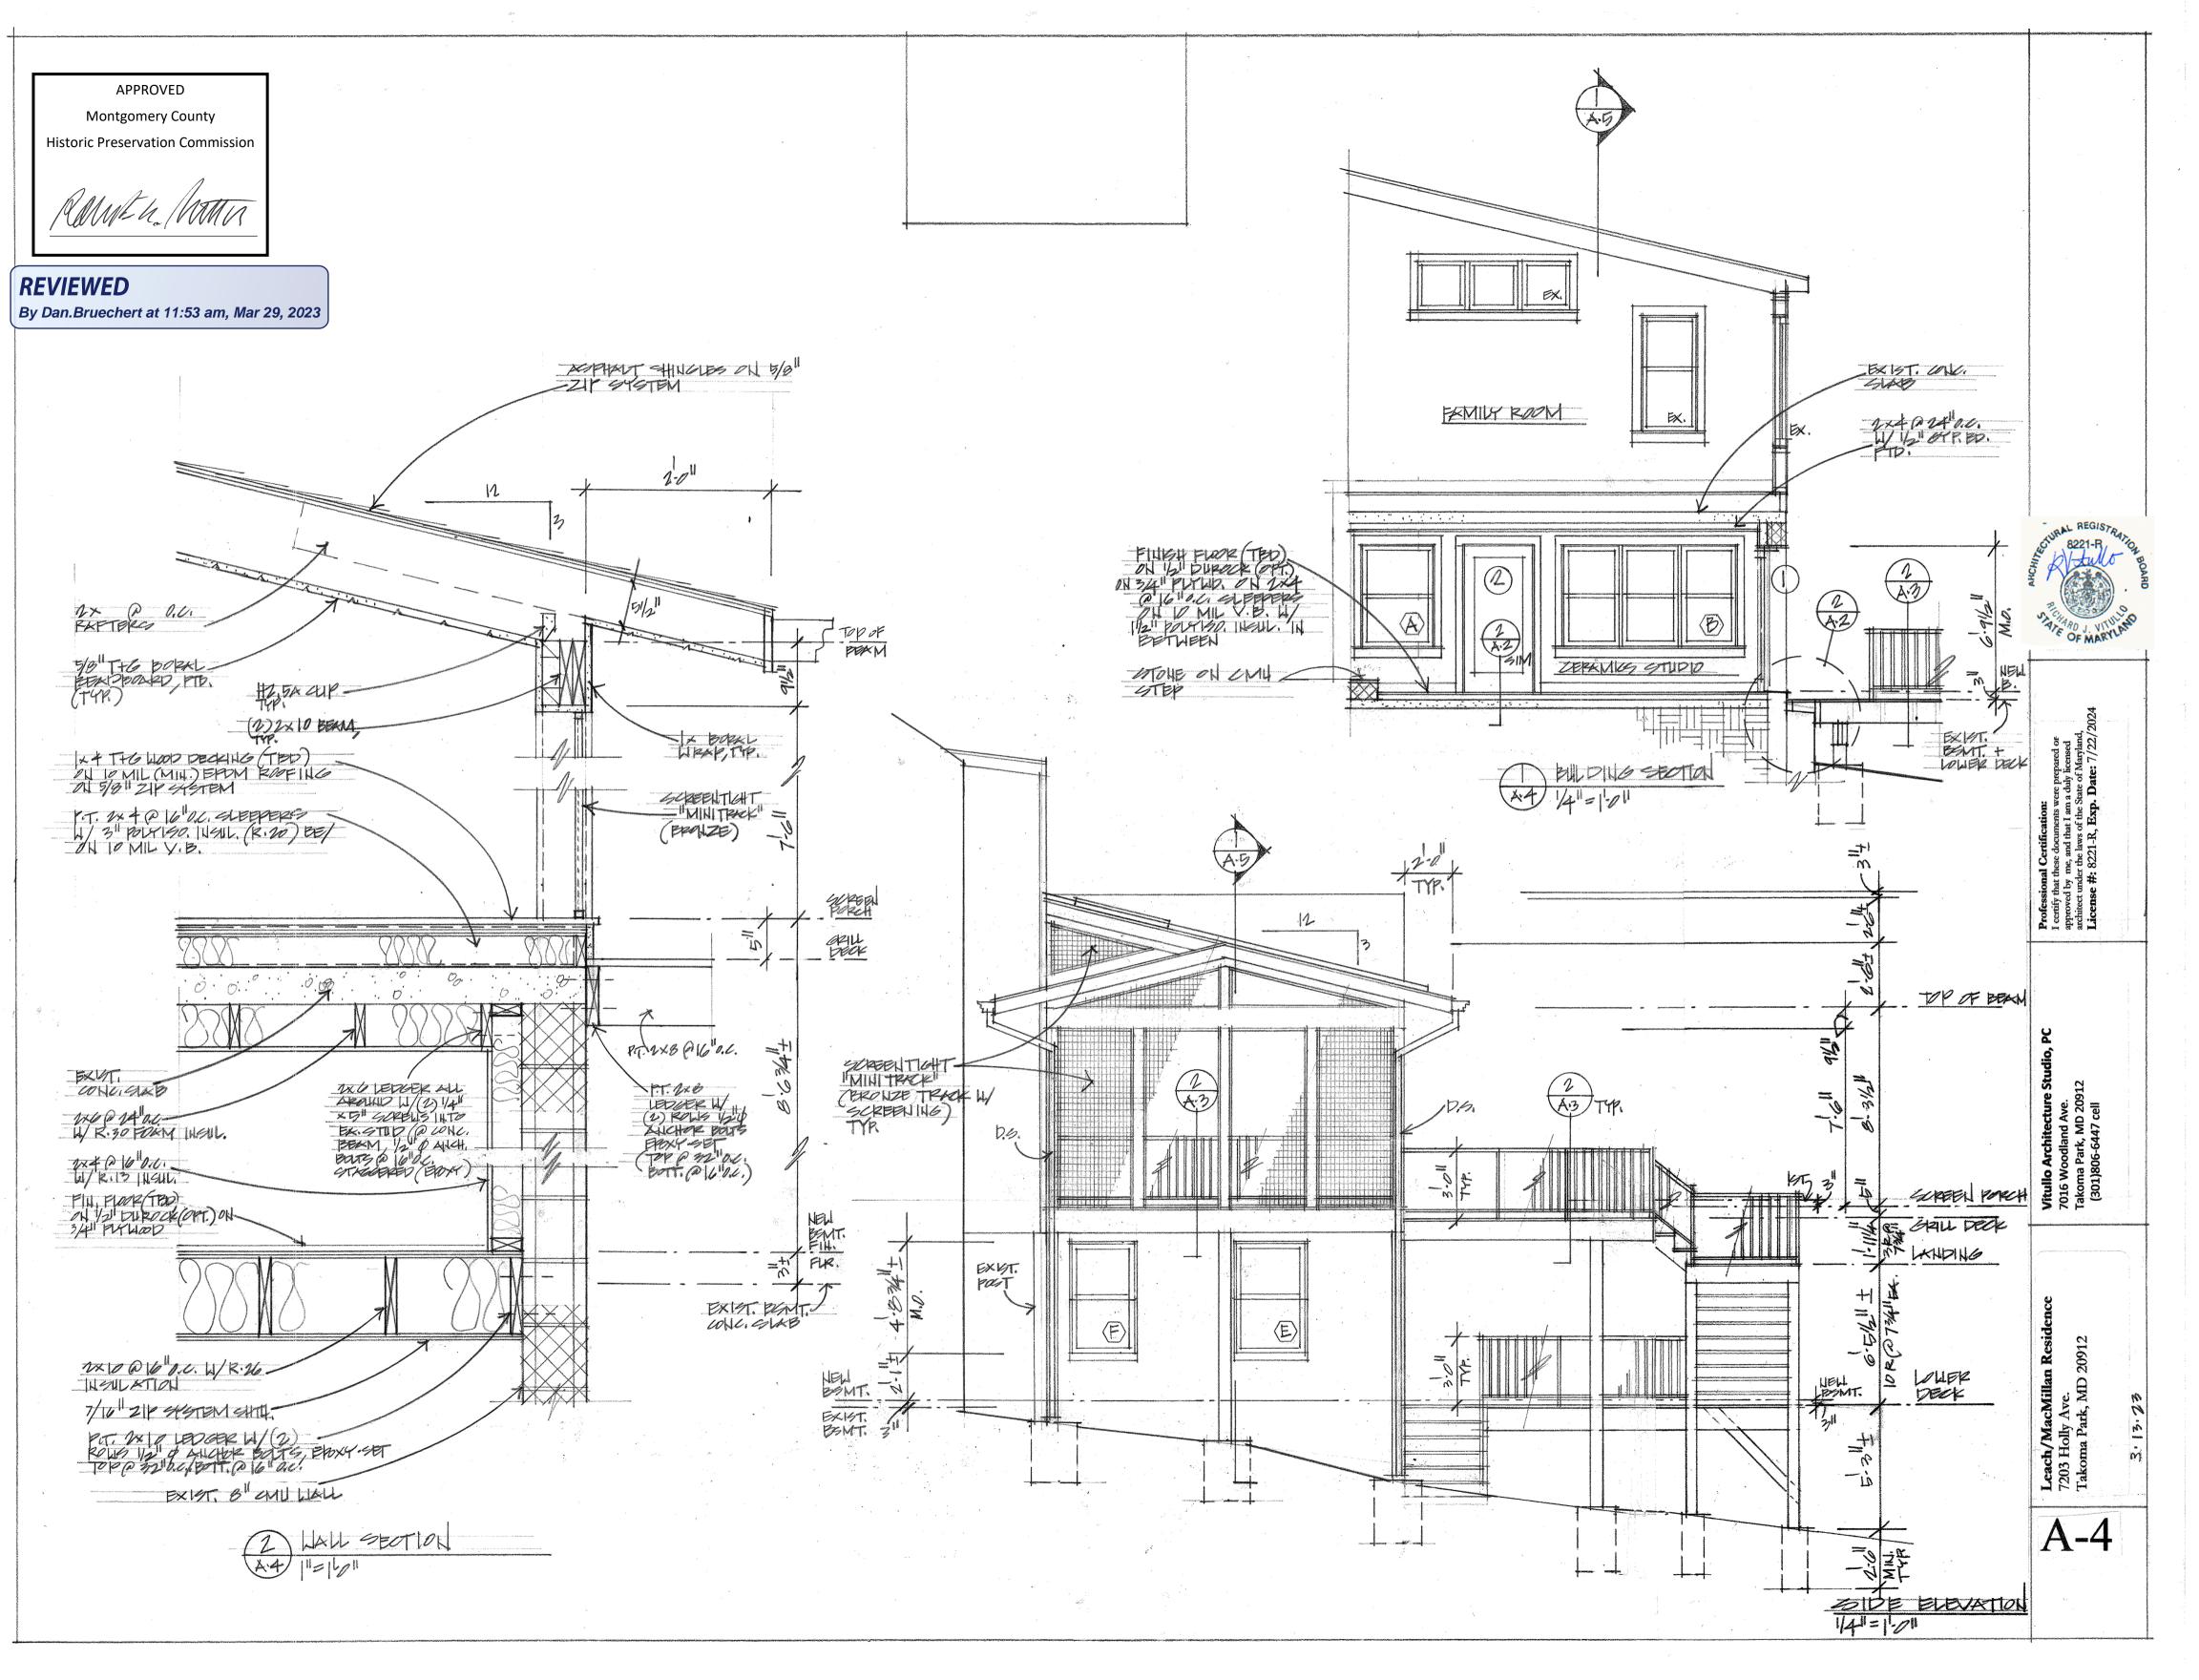

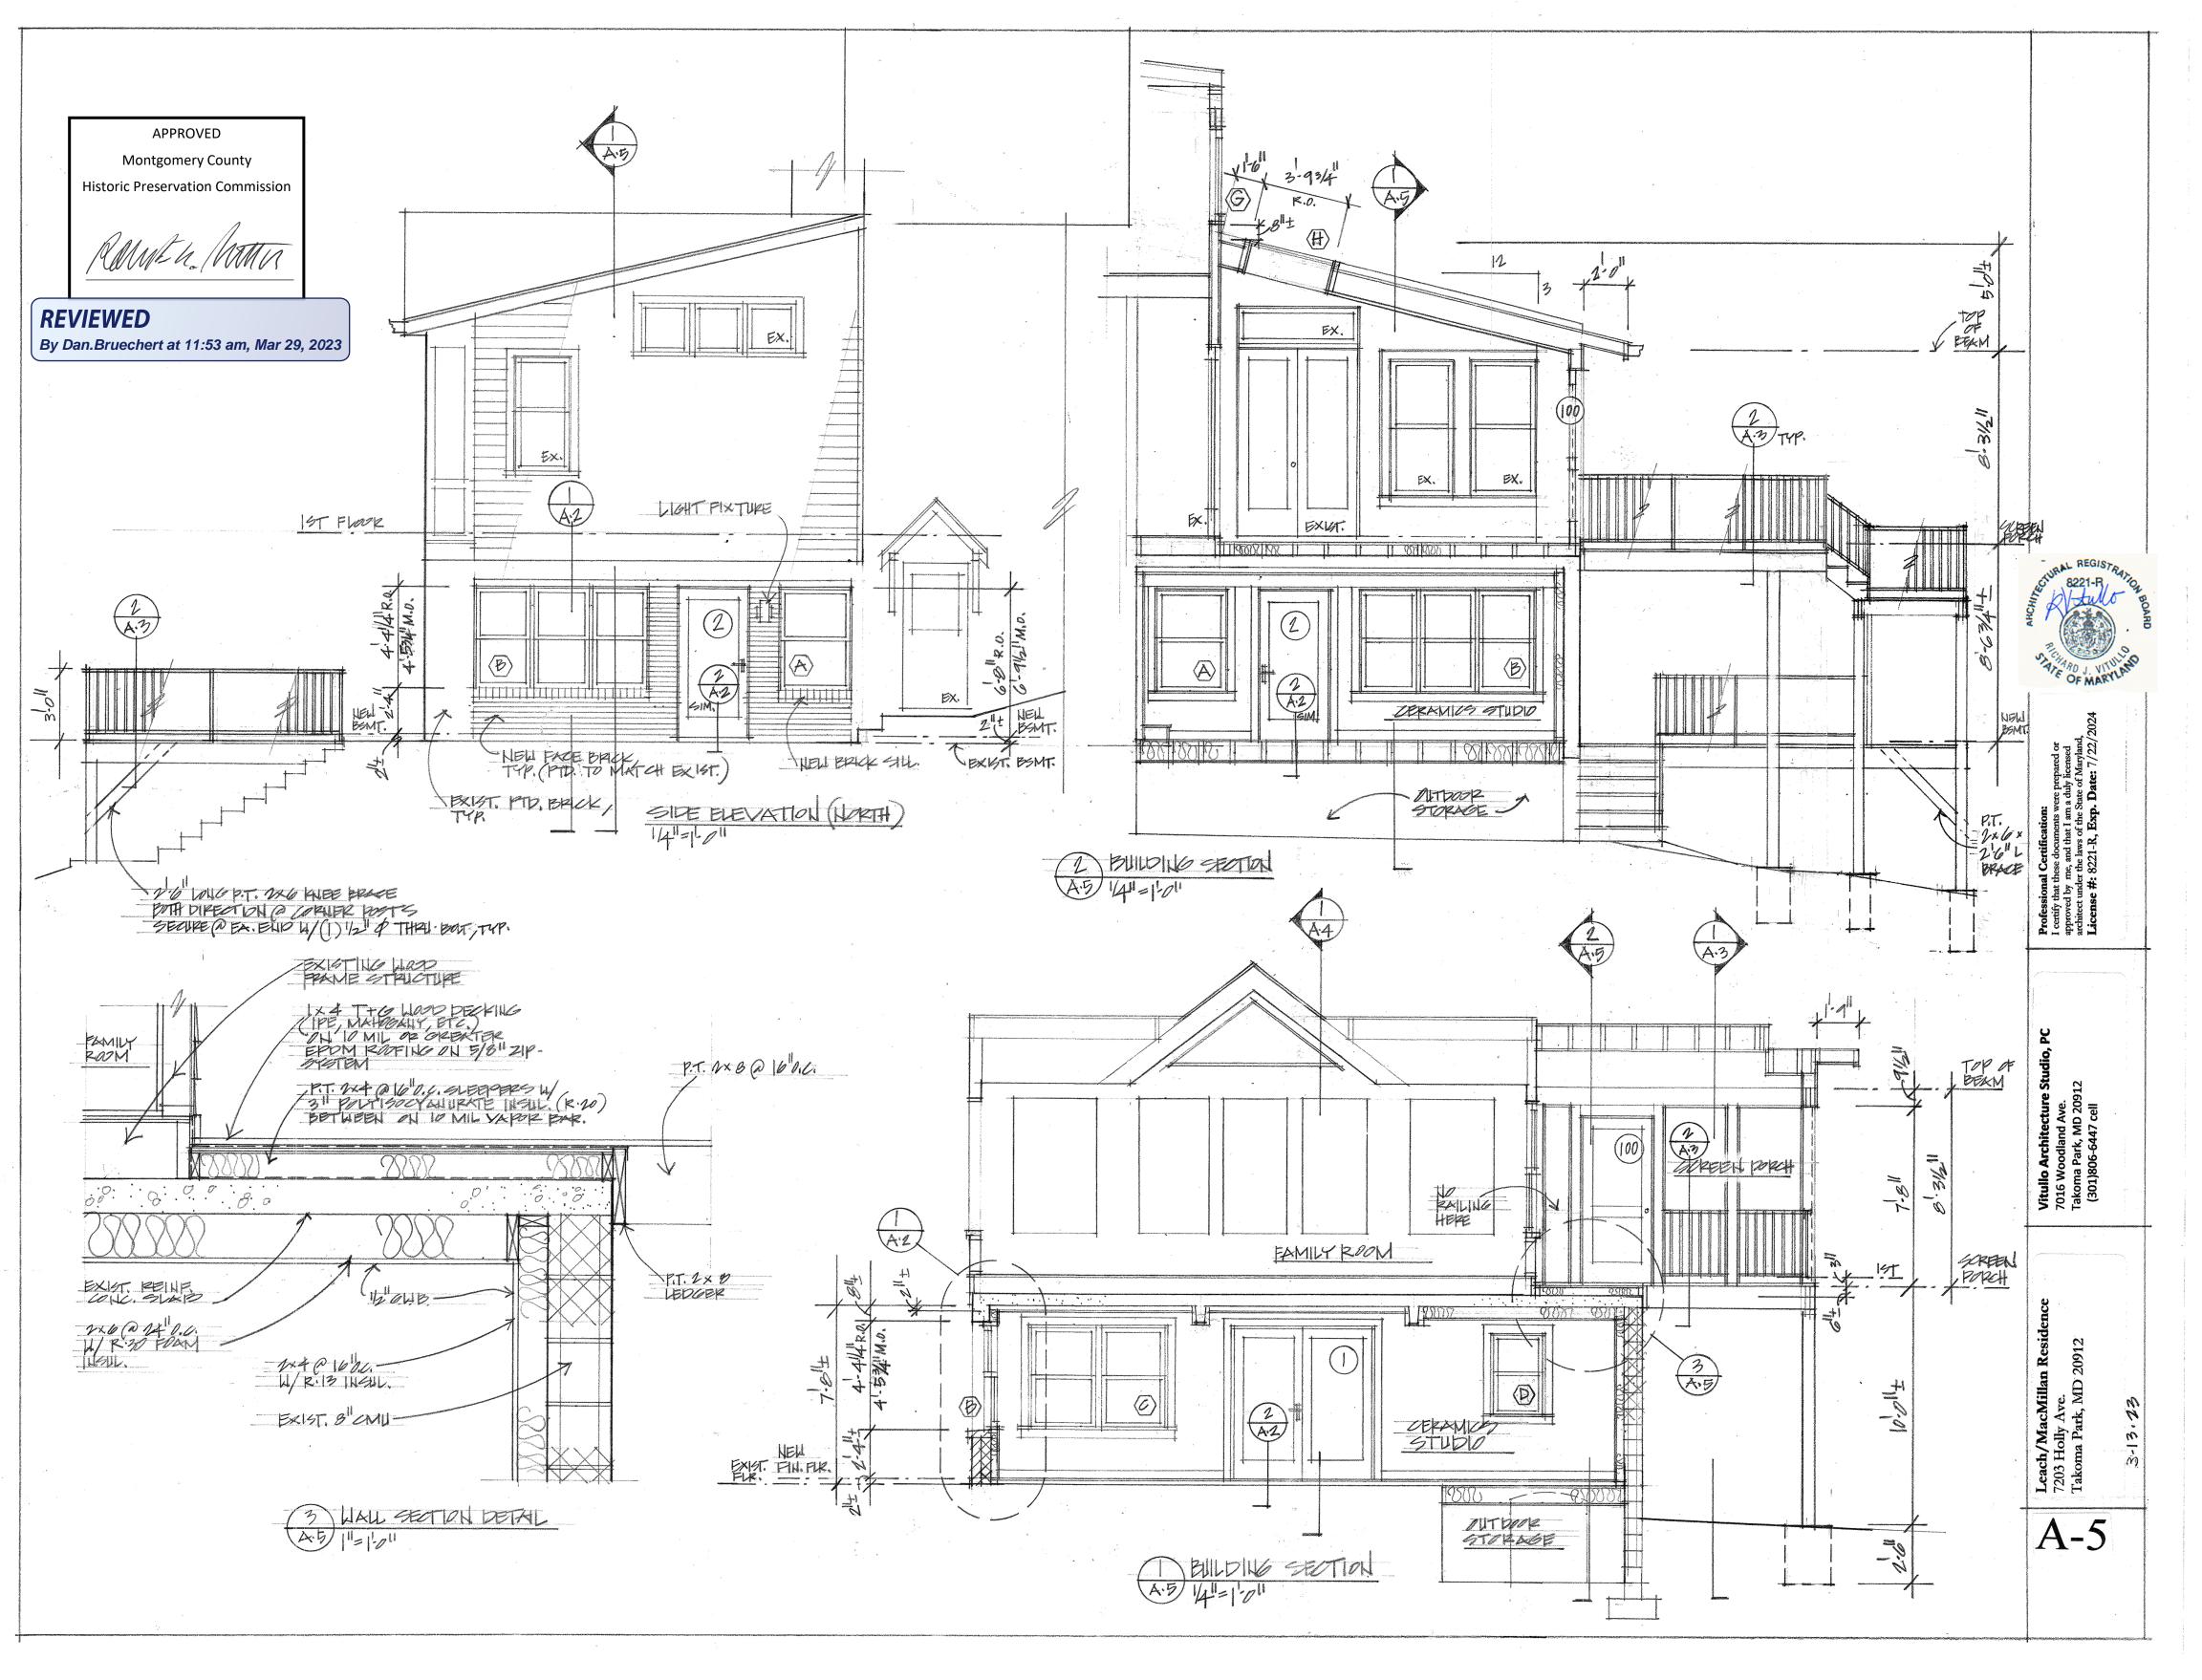

APPROVED

Montgomery County

Historic Preservation Commission

Kame ho Man

REVIEWED

By Dan.Bruechert at 11:51 am, Mar 29, 2023

	WI	NDOW SCHEDU	LE		Manufac	cturer- Windows: Ma	rvin Elev	ate & Ultim	nate Series	Velux	<u> </u>		,,,,,,,,,,,,,,,,,,,,,,,,,,,,,,,,,,,,,				
No.	No. Mfr. No. Height, Unit (R.O.) Width, Unit (R.O.) Jamb Do		Jamb Depth	Window Type/Material	Glazing Type	Grille Structure	Mullion Divisions	Hardware Finish	Screens / Screen Door	Interior Frame Pre-Finish	Exterior Clad Color	SHGC- value	U-value Total Unit	Egress window	Quant.	Remarks	
A	Marvin Elevate ELDH 3652	4'-3 3/4" (4'-4 1/4" R.O./ 4'-5 3/4" M.O.)	2'-11 1/2" (3'-0 1/2" R.O./ 3'-3 1/2" M.O.)	2 x 4 on 8" concrete wall	DOUBLE HUNG / wood interior & fiberglass-clad exterior	7/8" IG Low E2 Argon	none	none	"Satin Nickel"	yes	White	"Stone White"	0.27	0.3		1	Verify all dimensions in field
В	MarvinElevate ELDH 3052 3W	4'-3 3/4" (4'-4 1/4" R.O./ 4'-5 3/4" M.O.)	7'-4 1/2" (7'-5 1/2" R.O./ 7'-8 1/2" M.O.)	2 x 4 on 8" concrete wall	DOUBLE HUNG / wood interior & fiberglass-clad exterior	7/8" IG Low E2 Argon	none	none	"Satin Nickel"	yes	White	"Stone White"	0.27	0.3		1 (3 windows mulled Into 1 unit)	Verify all dimensions in field
C	Marvin Elevate ELDH 3652 2W	4'-3 3/4" (4'-4 1/4" R.O./ 4'-5 3/4" M.O.)	5'-11" (6'-0" R.O./ 6'-3" M.O.)	2 x 4 on 8" concrete wall	DOUBLE HUNG / wood interior & fiberglass-clad exterior	7/8" IG Low E2 Argon	none	none	"Satin Nickel"	yes	White	"Stone White"	0.27	0.3		1 (2 windows mulled into 1 unit)	Verify all dimensions in field
D	Marvin Elevate Custom Replacement	3'-2" +/- M.O. (Verify in Field)	2'-4" +/- M.O. (Verify in Field)	2 x 4 on 8" concrete wall	DOUBLE HUNG / wood interior & fiberglass-clad exterior	7/8" IG Low E2 Argon	none	none	"Satin Nickel"	yes	White	"Stone White"	0.27	0.3		1	Verify all dimensions in field
E	Marvin Elevate Custom Replacement	4'-8 3/4" +/- M.O. (Verify in Field)	3'-4" +/- M.O. (Verify in Field)	2 x 4 on 8" concrete wall	DOUBLE HUNG / wood interior & fiberglass-clad exterior	7/8" IG Low E2 Argon	none	none	"Satin Nickel"	yes	White	"Stone White"	0.27	0.3		1	Verify all dimensions in field
F	Marvin Elevate Custom Replacement	4'-8 3/4" +/- M.O. (Verify in Field)	2'-9 1/2" +/- M.O. (Verify in Field)	2 x 4 on 8" concrete wall	DOUBLE HUNG / wood interior & fiberglass-clad exterior	7/8" IG Low E2 Argon	none	none	"Satin Nickel"	yes	White	"Stone White"	0.27	0.3		1	Verify all dimensions in field
G	Marvin Ultimate UFCAPO 4848	3'-11 1/8" (3'-11 5/8" R.O.) V.I.F.	4'-0" (4'-1" R.O.) V.I.F.	2 x 4 (V.I.F.)	PUSHOUT CASEMENT / wood interior & aluminum-clad exterior	7/8" IG Low E2 Argon	none	none	"Satin Nickel"	yes	White	"Stone White"	0.27	0.3	YES	1	This is only window that is the Marvin "Ultimate" Series
ı	Velux C06	3'-9 3/4" R.O.	1'-9" R.O.	n/a	SKYLIGHT	LowE Argon	none	none	n/a	n/a	White	n/a	0.27	0.3		2	
SUBTOTAL													0.27	0.3		9 units	
	DOOR SCHEDULE					Manufacturer- Doors	: Marvir	Elevate S	eries/ TBD		:						
No.	Mfr. No.	Height, Unit (R.O.)	Width, Unit (R.O.)	Jamb Depth	Door Type / Material	Glazing Type	Grille Structure	Mullion Divisions	Hardware Finish	Screens / Screen Door	Interior Frame Pre-Finish	Exterior Color	SHGC- value	U-value Total Unit	Swing direction (shown from outdside room)	Quant.	Remarks
1	Elevate ELIFD 6065 XX	6'-7 1/2" (6'-8" R.O./ 6'-9 1/2" M.O.)	5'-11" (6'-0" R.O./ 6'-3" M.O.)	2 x 4 on 8" concrete wall	INSWING FRENCH DOOR/ wood interior & fiberglass-clad exterior	3/4" IG Low E2 Argon	none	none	"Satin Nickel"	TBD	White	"Stone White"	0.21	0.3	ХХ	1 Pair	Verify all dimensions in field
2	Elevate ELIFD 3065 XL	6'-7 1/2" (6'-8" R.O./ 6'-9 1/2" M.O.)	3'-0 5/16" (3'-1 5/16" R.O./ 3'-4 5/16" M.O.)	2 x 4 on 8" concrete wall	INSWING FRENCH DOOR/ wood interior & fiberglass-clad exterior	3/4" IG Low E2 Argon	none	none	"Satin Nickel"	TBD	White	"Stone White"	0.21	0.3	XL	1	Verify all dimensions in field
3	TBD	6'-8" (6'-9" R.O.)	2'-6" (2'-8" R.O./ 2'-11" M.O.)	2 x 4 on 8" concrete wall	Solid Wood SWING Door (2-Panel style)	n/a	n/a	n/a	TBD	n/a	TBD	n/a	n/a	n/a	Right Hand	1	Verify all dimensions in field
100	Cobblestone Mill "Riverstone"	2'-8" (2'-10" R.O.)	7'-0" (7'-1" R.O.)	3 1/2" wall	SCREEN DOOR/ Western Red Cedar (1 1/4" thick)	Screening: "Standard Recessed #4375"	Recessed flat	n/a	TBD	n/a	Field-painted	Field- painted	n/a	n/a	Left Hand	1	Screen Door
SUBTOTALS													0.26	0.28		4 units	
TOTALS								l		T	1		0.27 avg.	0.28 avg.	1	13 units	

	FINISH	SCHE	EDULE												
	BASEMENT														
ROOM	FLOORS		BASE/ WAINSCOT		WINDOW / DOOR TRIM				WALLS		CEILING		Ceiling Height	Area +/- (Sq.Ft)	Remarks
	Material	Finish	Material	Finish	Head Material	Jamb Material *	Apron Material *	Finish	Material	Finish	Material	Finish			
Ceramics Studio	Raised Floor (finish TBD) over Exist. Concrete Slab	TBD	TBD	TBD	WM-412 Sanitary Casing	WM-412 Sanitary Casing	WM-412 Sanitary Casing	Low VOC Paint	1/2-inch gyp. bd.	Low VOC Paint	1/2-inch gyp. bd.	Low VOC Paint	7'-0" +/-	460	Box in plumbing pipes from above as minimally as possible
	FIRST FLOOR									,					
ROOM	FLOORS		BASE/ WAINSCOT		WINDOW / DOOR TRIM				WALLS/ POST & BEAM WRAP		CEILING		Ceiling Height	Area +/- (Sq.Ft)	Remarks
	Material	Finish	Material	Finish	Head Material	Jamb Material *	Apron Material *	Finish	Material	Finish	Material	Finish			
Screen Porch	1 x 4 T & G wood decking (material TBD)	TBD	n/a	n/a	n/a	n/a	n/a	n/a	1 x Boral trim	Low VOC Paint	5/8" Boral T & G beadboard	Low VOC Paint	Varies: 8'-2" to 12'-0" +/-	166	

Richard Digitally signed by Richard Vitullo Date: 2023.03.17 09:46:57 -04'00'

to prepared or this licensed to faily licensed to of Maryland,

Frotessional Certuication:

I certify that these documents were prepared or approved by me, and that I am a duly licensed architect under the laws of the State of Maryland,

License #: 8221-R, Exp. Date: 7/22/20

016 Woodland Ave. akoma Park, MD 20912 3011806-6447 cell

Leach/MacMillan Residence 7203 Holly Ave. Takoma Park, MD 20912

A-6

Site Plan

1" = 20'-0"

House/Site Information: Lot: Part of 3 & 4 Block: 6 Plat Book: A Plat No.: 49 Subdivision: Takoma Park Address: 7203 Holly Ave., Takoma Park, MD 20912 Year built: 1923 Zoning: R-60 Historic District: Takoma Park (HAWP approved: 11/16/22)

Project Information:

This house has been designated a "Non-Contributing Resource" within the Takoma Park Historic District. Construct new 1-story Screen Porch addition (at 1st floor level)

N32030 E 100.00

HOLLY AVENUE

and new Wood Deck (at Basement level) at rear of house; wood stair will connect Screen Porch and Wood Deck. Renovate existing Garage into Ceramics Studio.

Residential Code Information: All construction shall be in conformance with the International Residential Code (IRC), 2018 Edition, as Amended by Mont. Co., Reg. 31-19, adopted 5/20/2020. AREA CALCULATIONS

EXISTING: Lot Area: 20,000 s.f. Lot Coverage/Building Area (House): 1703 s.f. % of Lot Coverage: PROPOSED: Lot Coverage/Building Area (Screen Porch) 178 s.f. Total Lot Coverage: 1881 s.f. % of Lot Coverage: 9.4%

TOTAL NET NEW ROOF AREA: 178 s.f. Total renovation S.F., by floor: Garage (Bsmt.): 486 s.f. 1st floor: 0 s.f. 2nd floor: 0 s.f.

TOTAL: 486 s.f. Total new construction S.F., by floor: Wood Deck/Stairs (at Bsmt.): 370 s.f. 1st floor (Screen Porch): 178 s.f. 2nd floor: 0 s.f. TOTAL: 548.s.f. New Rear Screen Porch and Deck Addition/Garage Renovation:

Leach/MacMillan Residence

7203 Holly Avenue, Takoma Park, MD 20912

GENERAL CONSTRUCTION NOTES:

- 1. These drawings are to show only materials and layout of the design; means and methods are to be determined by contractor. The contractor shall fully acquaint him/herself with the conditions relating to construction and labor so that he/she understands the issues relating to the execution of the work.
- 2. Contractor shall provide all materials, labor and equipment and pay all freight charges, taxes, and handling of materials necessary for the full implementation of the work herein described on these drawings unless noted otherwise.
- Contractor to verify all dimensions and assumed conditions in the field; bring any discrepancies, omissions, ambiguities or conflicts to the attention of the architect and owner as soon as possible before proceeding with any of this work in question.
- Contractor to notify architect if any existing pipes, ducts, or structural elements (or any other relevant item) that are revealed by demolition and are scheduled to be removed or re-routed for the new plan are determined to be not easily moved, or
- 5. Contractor to notify architect and/or structural engineer if any existing wood joists, sheathing, studs, etc. are damaged or deteriorated from termites, water, etc.
- 6. All construction will meet or exceed all applicable building and health codes, unless a code modification approval is granted.
- 7. The owner's written authorization will be required before any work is executed or materials ordered that involve a change from the original specifications affecting the
- 8. All plan dimensions on drawings are set to edge of framing members; all finishes are not taken into account unless otherwise noted. If dimension is taken to a finish surface, it shall be noted as "FINISH DIMENSION", "FIN. DIM.", or "CLEAR DIM.".
- 9. Solid blocking required under posts or any bearing from above to solid bearing below; match bearing area of post above to bearing below; cut bearing blocks to minimum 1/16" deeper than joists.
- 10. Install solid blocking in walls for receipt of cabinets, etc., as necessary.
- 11. All wood in contact with masonry/concrete surfaces shall be pressure-treated; install sill gasket underneath all sill plates.
- 12. New doors, windows and hardware, are to be provided and installed by contractor; verify window and door manufacturers' rough opening dimensions prior to framing.
- 13. In all newly exposed existing 2 x 4 furring or walls at exterior, insert insulation in any combination of closed cell foam/rockwool/batts for R-13, minimum
- 14. In all newly exposed existing roof rafters, and/or ceiling joists below rafters, where an R-49 insulation level is impossible to achieve, insert insulation in any combination of closed cell foam/rockwool/batts for R-30, minimum, given that the maximum area for the R-30 insulation shall be limited to 500 sf or 20% of the total insulated ceiling area (See IRC 2015 N1102.2.2). At new exterior walls, (2 x 6), insert insulation to R-
- 15. If house-wrap and or building paper is used, apply and lap in a shingle-fashion so that upper courses lap over lower courses; any window and door flashing is integrated into this system in the same manner. Apply Z-flashing at all heads and apply pan flashing at all sills.
- 16. All new or existing wall surfaces are to be prepared for painting to be smooth and free of cracks, peeling paint, etc.; walls to be primed and painted (2 coats, min.) with color to be selected by owner.
- 17. Any new flooring material (tile, etc.) to be selected by owner, installed by contractor. Make surface smooth and flat for receipt of new flooring.
- 18. Install new hard-wired interconnected AC-powered smoke and CO detectors as per drawings and per code, as necessary.
- 19. All electrical outlets in bath, kitchen (except refrigerator) and at exterior to be ground fault circuit interrupters (GFCI); in all rooms (except kitchens), all-fault circuit interrupters (AFCI) to be installed.
- 20. Upgrade electrical service (as nec.) to provide sufficient power for new fixtures, appliances, etc.
- 21. Electrical switches (dimmers, toggles, etc.), and telephone/modem to be approved by owner, installed by contractor. All decorative light fixtures to be selected by owner, installed by contractor.
- 22. All recessed light enclosures and junction boxes installed in thermal/insulated ceilings === U/C Undercabinet Lights shall be IC-rated for insulation contact and are to be sealed against air infiltration. Seal all openings in box with fire-rated foam (3M Fire Block Foam FB-Foam; meets ASTM E 84 Class 1).

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Indicates existing unit (light or outlet) Duplex Outlet/new

→ A/C Duplex Outlet/new/above counter

GFCI Duplex Outlet/new/GFCI

AFCI Duplex Outlet/new/AFCI

Double Duplex Outlet

Duplex Floor Outlet

≠ 240 Outlet

-G-ef Exhaust Fan

-G-EF/H Exhaust Fan/Heat -9-ef/H/L Exhaust Fan/Heat/Light

-O-cr Ceiling Fan

O cf/L Ceiling Fan/Light

Pendant Light Fixture

Recessed Light Fixture

Recessed Light Fixture/Existing

Recessed Light Fixture/Eyeball Surface Mounted Light Fixture

Wall Mounted Light Fixture/Sconce

Light Fixture /Waterproof

Dr. Dual Flood Light

Data/Telephone Jack Coaxial/Cable TV

Audio Speaker

Switch

SD Switch/Dimmer

Three-way Switch S 3

=== τ Track light

=== P "Plugmold" Power Strip

Smoke & Carbon Monoxide Detectors

Thermostat

Δ

Sheet No. Sheet Title

Cover Site Plan/Project Description/ General Notes/

Electrical & Lighting Legend/ DM-1 Lower & Upper Level Demolition Plans (1/4"=1'-0")/

Demolition Notes

Roof Plan (1/4"=1'-0")/**A-2** First Floor Plan (1/4"=1'-0")/

Wall Sections (1"=1'-0") Exterior Elevation/ Rear (1/4"=1'-0")/

Building Section (Screen Porch) (1/4"=1'-0")/ Railing Detail (1"=1'-0")/

Exterior Elevation/Side (South) (1/4"=1'-0")/Building Section (1/4"=1'-0")/ Wall Section (1"≡1'-0")

Exterior Elevation/Side (North) (1/4"=1'-0")/Building Sections (1/4"≡1'-0")/

Wall Section (1"=1'-0") Window & Door Schedule Finish Schedule

EC-1 Air Barrier, Insulation & Thermal Barrier Schedule and Diagrams

Foundation Plan (1/4"=1'-0")

Lower Deck/Basement Framing Plan (1/4"=1'-0")/

Upper Deck/Roof Framing Plan (1/4"=1'-0")/ Structural Notes & Calculations

REVIEWED By Dan.Bruechert at 11:53 am, Mar 29, 2023



ılıy Ave. Park, MD 20912

COVER