

#### HISTORIC PRESERVATION COMMISSION

Marc Elrich
County Executive

Robert K. Sutton

Chairman

Date: August 15, 2023

#### **MEMORANDUM**

TO: Mitra Pedoeem

Department of Permitting Services

FROM: Dan Bruechert

**Historic Preservation Section** 

Maryland-National Capital Park & Planning Commission

SUBJECT: Historic Area Work Permit #1013352 - Partial Demo and Building Addition

The Montgomery County Historic Preservation Commission (HPC) has reviewed the attached application for a Historic Area Work Permit (HAWP). This application was **Approved** at the December 7, 2022 HPC meeting.

The HPC staff has reviewed and stamped the attached construction drawings.

THE BUILDING PERMIT FOR THIS PROJECT SHALL BE ISSUED CONDITIONAL UPON ADHERENCE TO THE ABOVE APPROVED HAWP CONDITIONS AND MAY REQUIRE APPROVAL BY DPS OR ANOTHER LOCAL OFFICE BEFORE WORK CAN BEGIN.

Applicant: Greg Dalfonzo

Address: 7209 Holly Ave., Takoma Park

This HAWP approval is subject to the general condition that the applicant will obtain all other applicable Montgomery County or local government agency permits. After the issuance of these permits, the applicant must contact this Historic Preservation Office if any changes to the approved plan are made. Once work is complete the applicant will contact Dan Bruechert at 301.563.3400 or dan.bruechert@montgomeryplanning.org to schedule a follow-up site visit.



# APPROVED Montgomery County Historic Preservation Commission


#### **REVIEWED**

By Dan.Bruechert at 9:25 am, Aug 15, 2023

# LEVINE G R O U P

301.585.4848 fax 301.585.4207

8639B 16th Street Ste. 278 Silver Spring, MD 20910

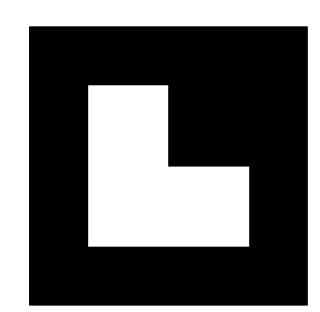

#### **GENERAL NOTES**

NOTE: ALL WORK AND MATERIALS TO CMPLY WITH THE REQUIREMENTS OF THE 2018 IRC, THE MONTGOMERY COUNTY CODE CHAPTER 8- BUILDINGS, AND ALL OTHER APPLICABLE CODES.

- 1. NOTIFY MISS UTILITY 48 HOURS PRIOR TO DIGGING: 1-800-257-7777.
- 2. REGULATORY COMPLIANCE: COMPLY WITH ALL LOCAL CONSTRUCTION CODES AND ZONING ORDINANCES. OBTAIN ALL NECESSARY TRADE AND BUILDING PERMITS, WALL CHECKS, INSPECTIONS, AND CERTIFICATES OF OCCUPANCY.
- 3. CONDITIONS: THOROUGHLY REVIEW FIELD CONDITIONS, DIMENSIONS, AND CONTRACT DOCUMENTS. NOTIFY THE DESIGNER IMMEDIATELY OF CONFLICTS, DEFICIENCIES OR OMISSIONS. REQUEST CLARIFICATION AS NEEDED. DO NOT SCALE THE DRAWINGS. CHANGE ORDERS WILL NOT BE ISSUED DUE TO THE CONTRACTOR'S FAILURE TO REVIEW THE DRAWINGS, SPECS., OR EXISTING CONDITIONS. DEVIATIONS FROM PLANS AND PRODUCT SUBSTITUTIONS MUST BE

APPROVED BY THE OWNER.

- 4. SUPERVISION: CONTRACTOR IS RESPONSIBLE FOR SUPERVISION, COORDINATION AND SCHEDULING OF EACH SUBCONTRACTOR AND SUPPLIER. PROJECT MUST PROCEED IN A TIMELY AND WORKMANLIKE MANNER. REQUIRE ALL SUBCONTRACTORS & INSTALLERS TO INSPECT AREAS TO RECEIVE WORK AND CONDITIONS UNDER WHICH WORK IS TO BE PERFORMED AND TO REPORT TO CONTRACTOR ANY UNSATISFACTORY CONDITIONS. CHANGE ORDERS WILL NOT BE ISSUED DUE TO CONTRACTOR'S FAILURE TO REVIEW AND COORDINATION OF SUBCONTRACTORS.
- 5. SITE CONTROLS: CONTRACTOR IS SOLELY RESPONSIBLE FOR JOB SITE SAFETY. PROVIDE TEMPORARY PEDESTRIAN AND VEHICULAR BARRIERS AS REQUIRED TO PROTECT WORKERS AND PUBLIC. MAINTAIN JOB SITE NEAT AND FREE FROM ACCUMULATION OF TRASH AND BUILDING MATERIAL WASTE.
- 6. PRODUCTS: FURNISH ITEMS SPECIFIED AND INSTALL PER MANUFACTURER'S INSTRUCTIONS. INSPECT DELIVERIES FOR COMPLIANCE WITH SPECIFIED PRODUCT, MATERIAL AND QUANTITY. STORE IN ACCORDANCE WITH MANUFACTURER'S INSTRUCTIONS.
- 7. TEMPORARY PROTECTION: PROVIDE ADEQUATE TEMPORARY PROTECTION AGAINST WEAR FOR ALL NEW AND EXISTING CONSTRUCTION. REPAIR, PATCH, PAINT, ETC.. ALL AREAS WHERE NEW CONSTRUCTION DAMAGES EXISTING CONDITIONS. ALL LANDSCAPING DESIGNATED TO REMAIN OR REASONABLE BEYOND LIMITS OF OPERATIONS TO BE PROTECTED FROM DAMAGE.
- 8. SEDIMENT CONTROL: PRIOR TO EXCAVATION AND THROUGHOUT COURSE OF WORK, PROVIDE CONTROL MEASURES AS NECESSARY TO PREVENT SEDIMENT DISCHARGE BEYOND THE PROPERTY LINES. MEASURES SHALL BE FOLLOWED BY ALL STATE AND LOCAL COUNTY REQUIREMENTS. MAINTAIN SEDIMENT CONTROL FEATURES UNTIL LANDSCAPING IS IN PLACE AND STABILIZED.
- 9. DEFECTIVE WORK: PROMPTLY CORRECT WORK REJECTED BY DESIGNER OR FOUND NOT IN COMPLIANCE WITH THE CONTRACT, INCLUDING DEFECTIVE WORK DISCOVERED AFTER THE DATE OF SUBSTANTIAL COMPLETION.


# RASKIN LIBRARY

# 7209 Holly Ave, Takoma Park, MD 20912

SHEET

**NUMBER** 

E-001

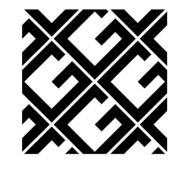

### GROSSMUELLER'S

DESIGN

5236 44th Street NW #3 Washington, DC 20015 O 202.537.0060 Grossmuellers.com

	SHEET LIST
SHEET NUMBER	SHEET NAME
G-001	COVER
S-001	FOUNDATION PLAN
S-002	FIRST FLOOR FRAMING PLAN
S-003	SECOND FLOOR FRAMING PLAN
S-200	STRUCTURAL NOTES & DETAILS
S-201	STRUCTURAL DETAILS
S-202	STRUCTURAL DETAILS
S-203	STRUCTURAL NOTES

5205	SINOCIONALINOILS
AD-001	BASEMENT DEMOLITION
AD-002	FIRST FLOOR DEMOLITION
AD-003	DEMO ELEVATION
AD-004	DEMO ELEVATION
AD-005	DEMO ELEVATION
AD-006	DEMO ELEVATION
A 001	DACEMENT DI ANI

A-001	BASEMENT PLAN
A-002	FIRST FLOOR PLAN
A-004	PROPOSED ELEVATION
A-005	PROPOSED ELEVATION
A-006	PROPOSED ELEVATION
A-007	PROPOSED ELEVATION
A-008	WINDOW AND DOOR
	SCHEDULE
A-O10	SECTIONS
A-O 1 1	SECTIONS
A-012	MAIN STAIR DETAILS
A-013	SMALL STAIR DETAIL
A-014	FINISH SCHEDULE

E-002	FIRST FLOOR ELECTRICAL PLAN
M-001	BASEMENT MECHANICAL PLAN

SHEET LIST

SHEET NAME

BASEMENT ELECTRICAL PLAN


REVISION	<u>DATE</u>
CONTRACT	7.5.23
PERMIT	7.24.23


#### SCOPE OF WORK

Underpin existing basement, relocate basement bathroom, new rear screened porch.

Drawings, specifications, and all other instruments of service are and shall remain the property of Grosmuellers Design Consultants, Inc. whether the projects for which they are made are executed or not. This is an original design and may not be used or copied under penalty of law.



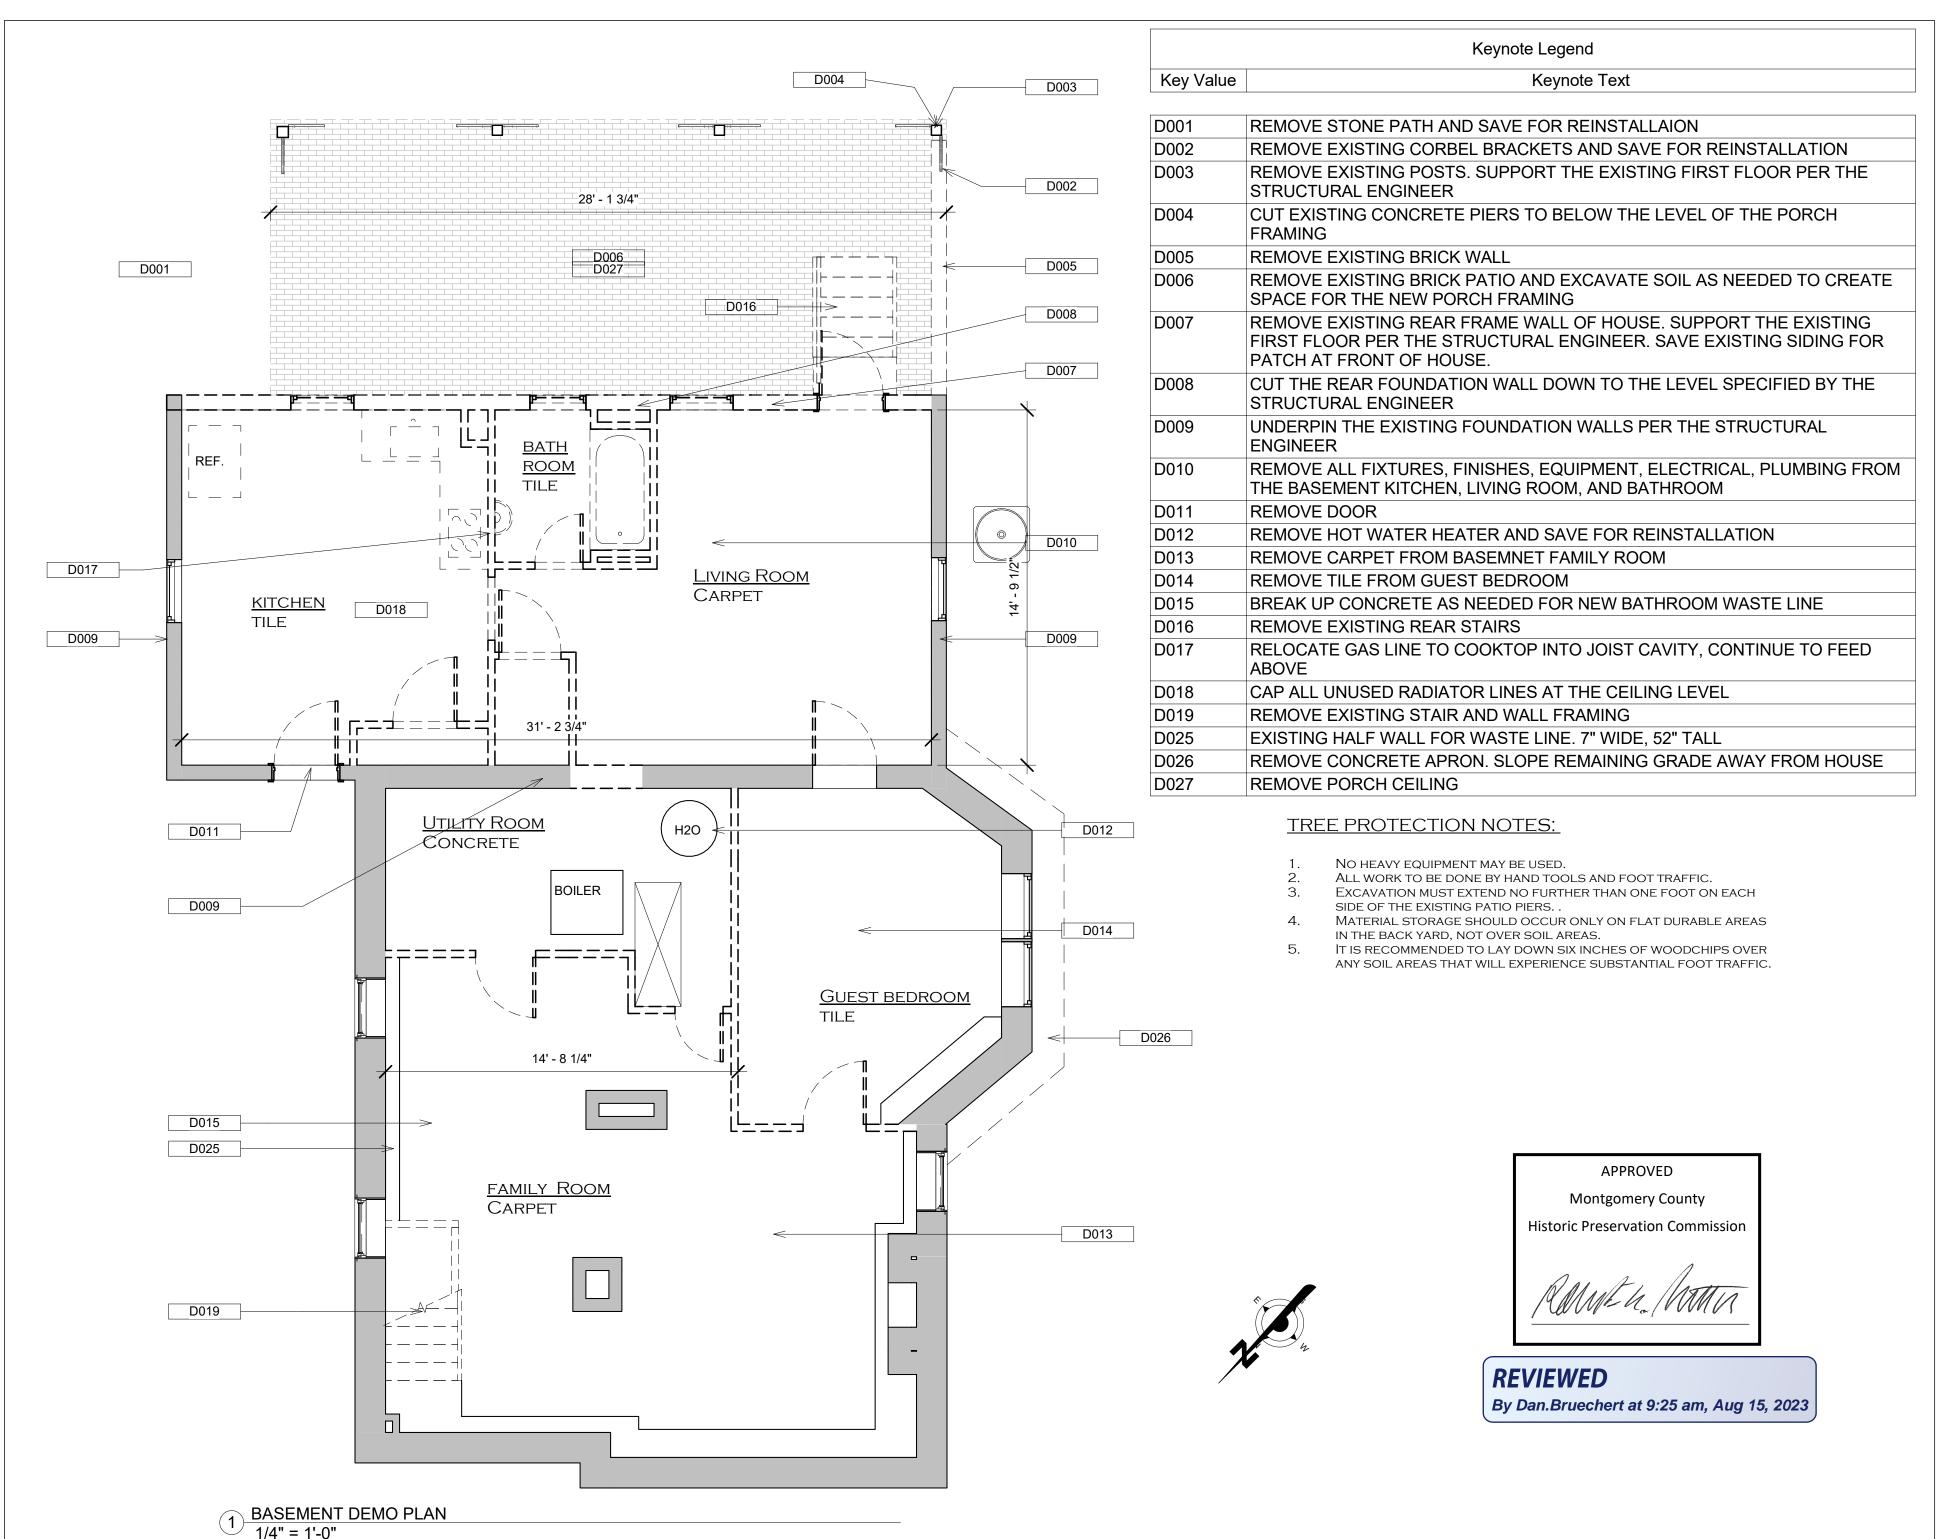

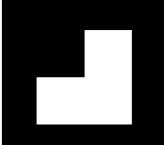

The lodas, designs and arrangements bepresented thereby are and shall remain the roperty of the architect. No part thereof shall excepted, disclosed to others or used in onnection with any work or project or by any ther person for any purpose other than for he specific project for which they have been

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ARCHITECTS+ BUILDERS
301.585.4848

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301.585.4848 fax 301.585.4207 8639B 16th Street Ste. 278

Phase CONTRACT

Date JULY 24, 2023


Scale 1/4" = 1'-0"

Drawn By Author

Revision

Raskin Library 7209 Holly Ave, Takoma Park, MD 20912

BASEMENT DEMOLITION

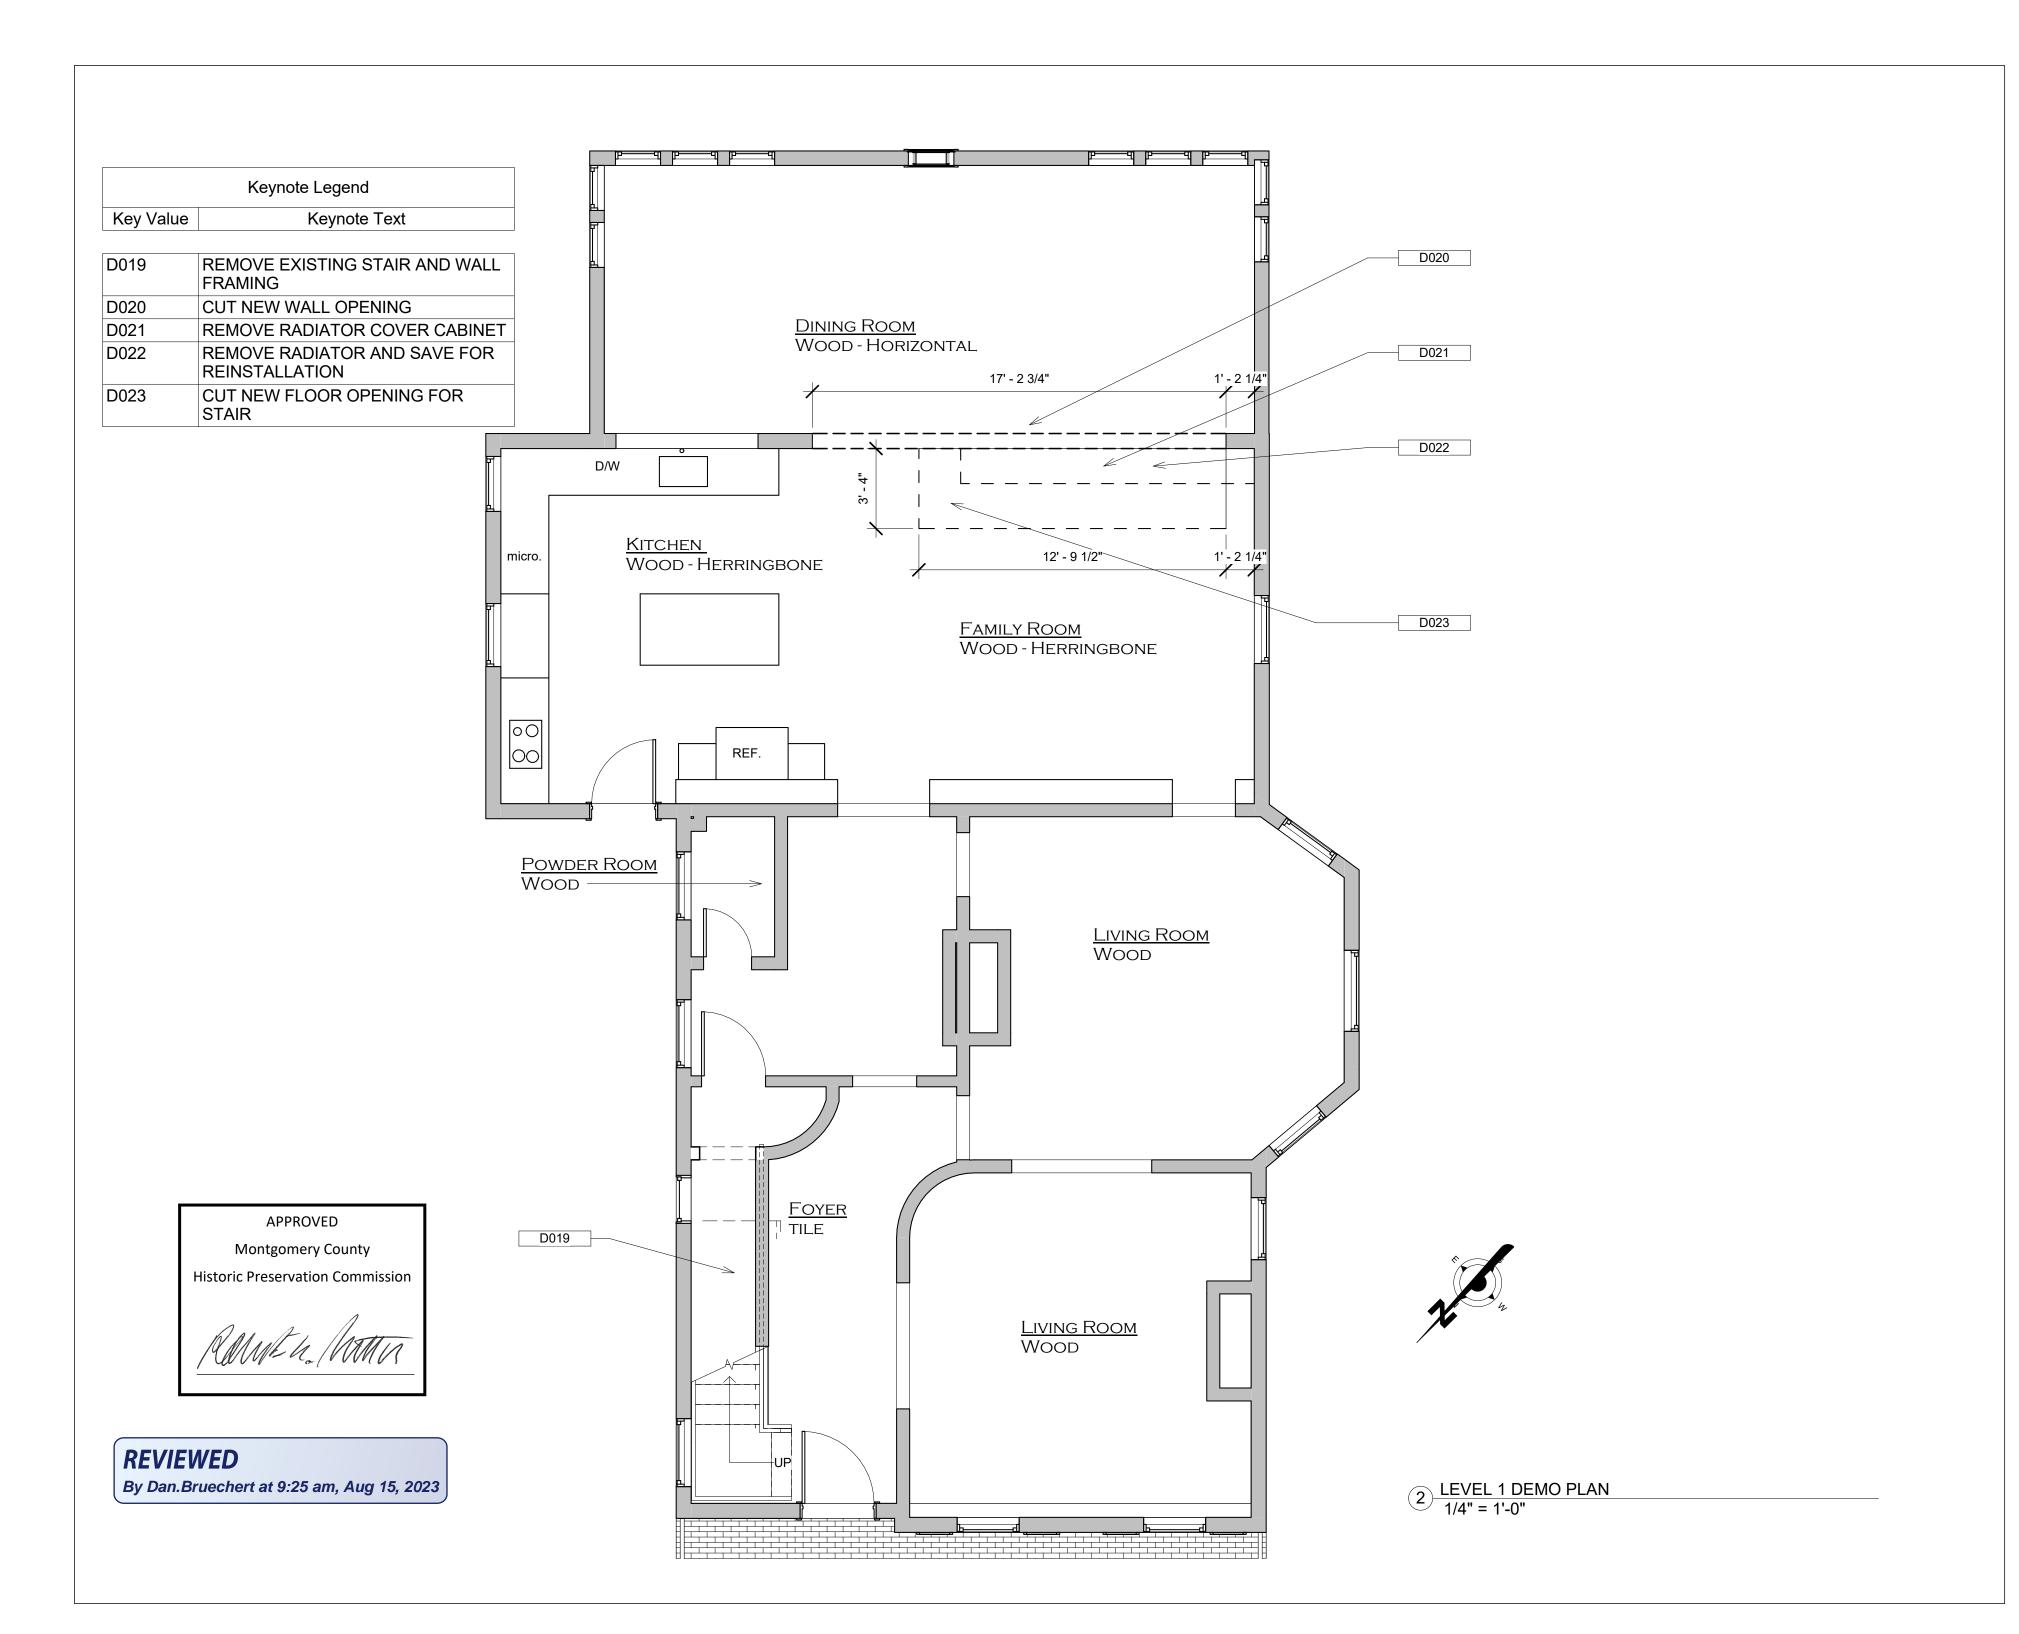




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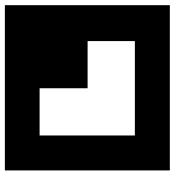
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7209 Holly Ave, Takoma Park, MD
20912

FIRST FLOOR DEMOLITION





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ARCHITECTS+ BUILDERS 301.585.4848 tax 301.585.4207
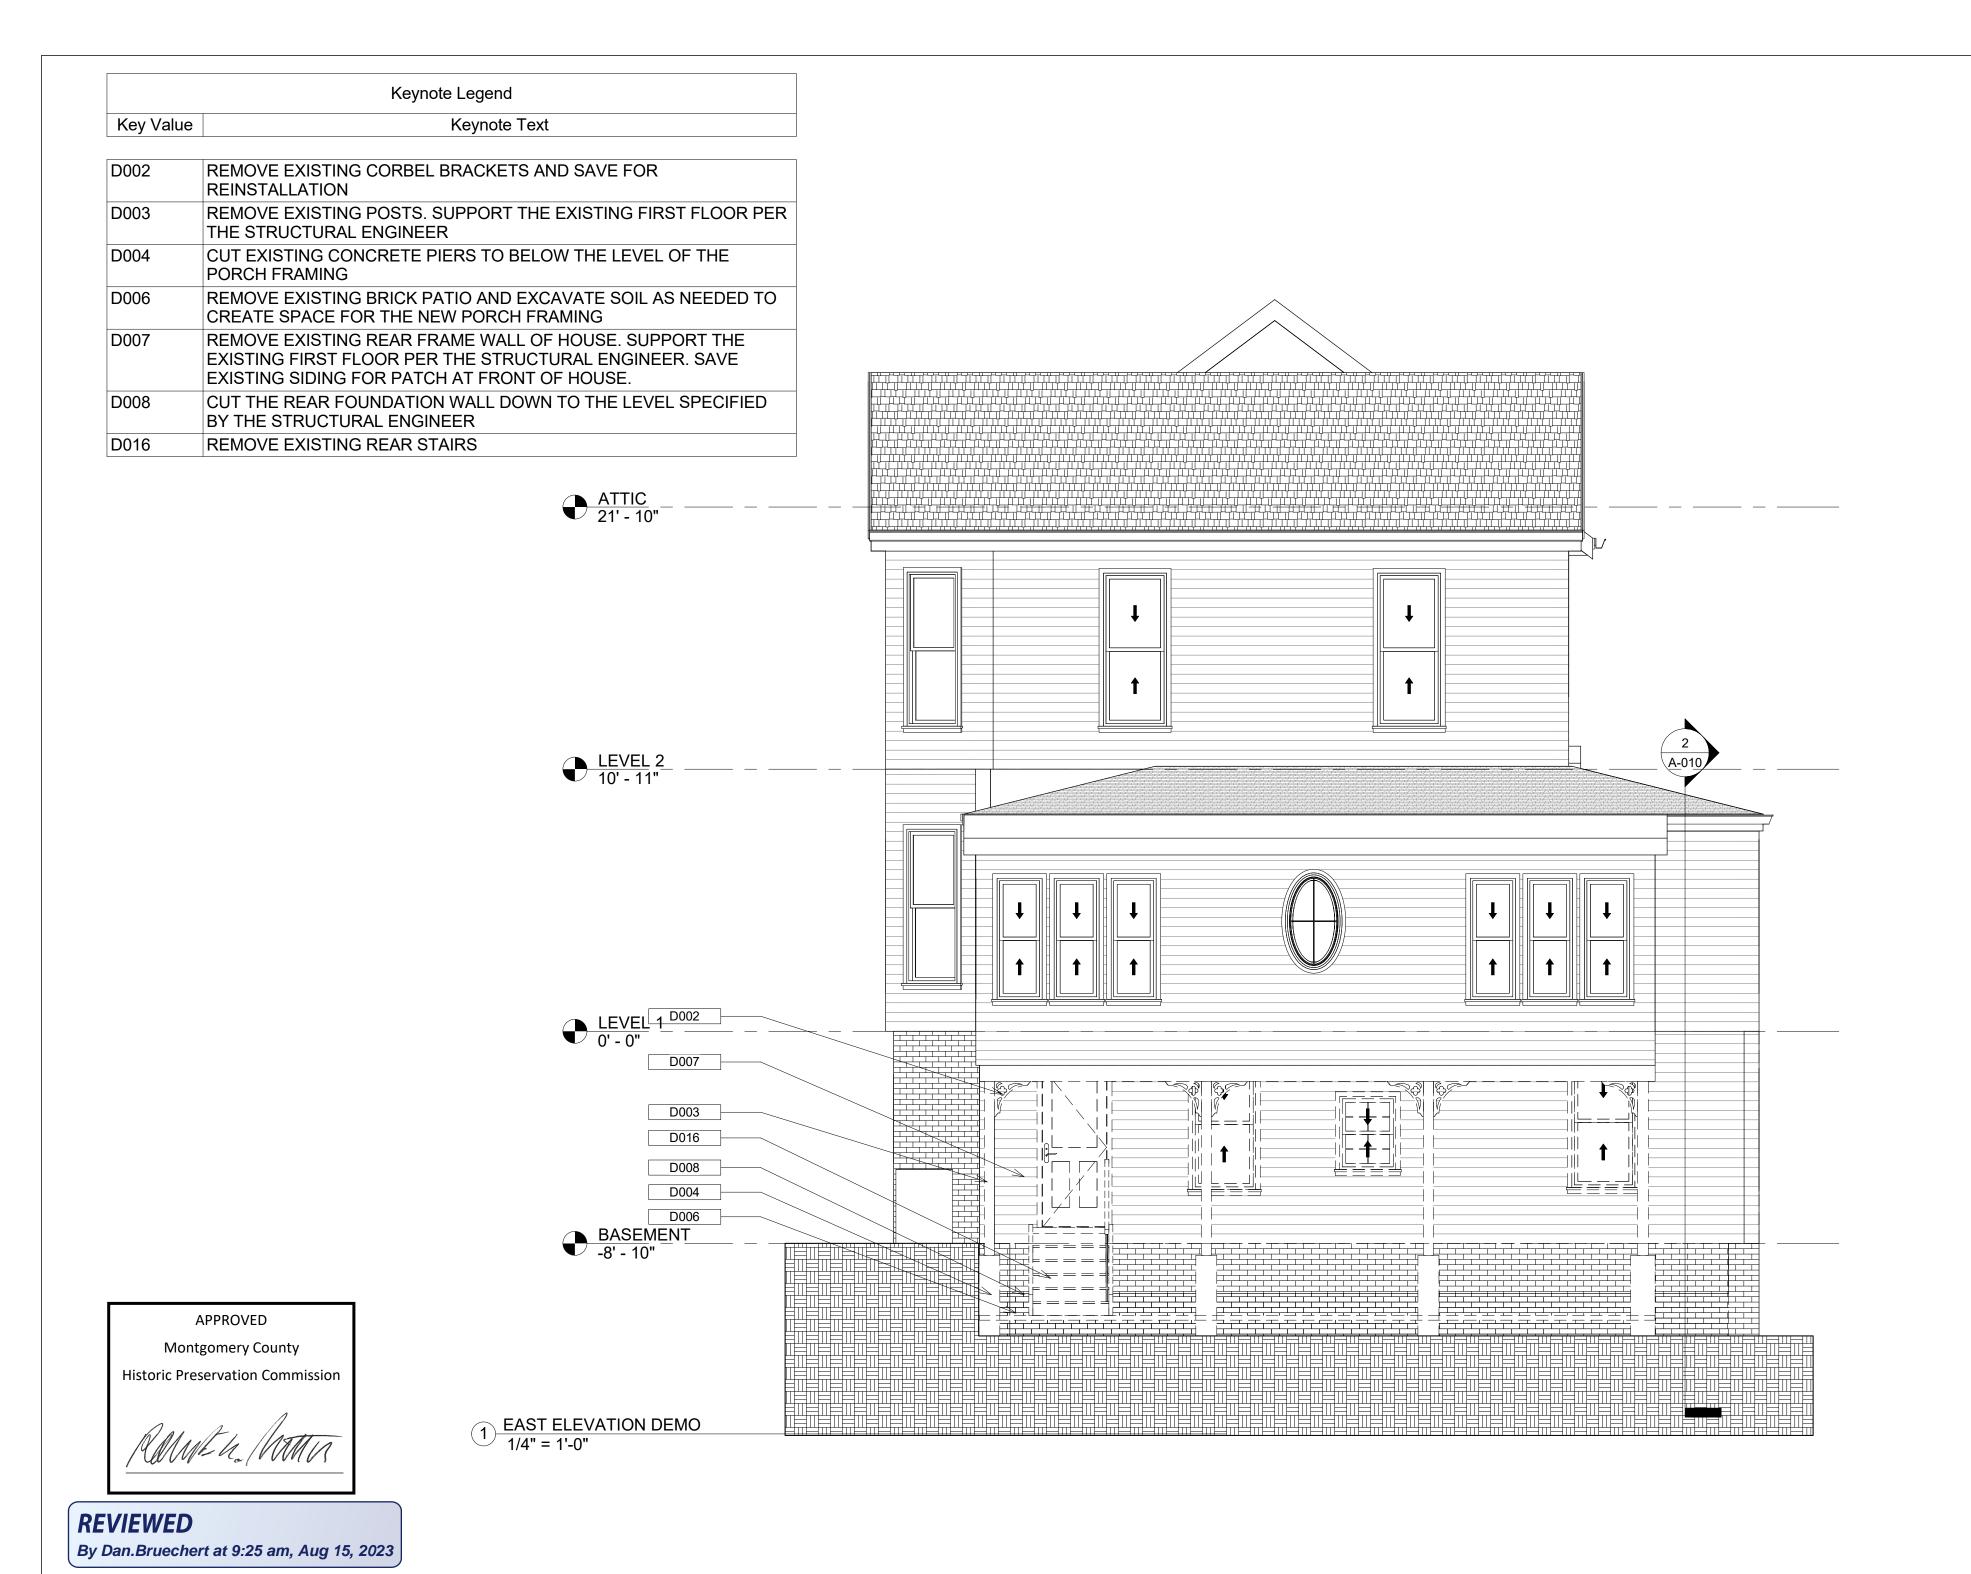
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 CONTRACT


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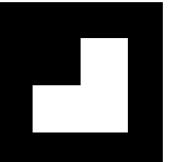
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 Author

Raskin Library
7209 Holly Ave, Takoma Park, MD
20912

DEMO ELEVATION



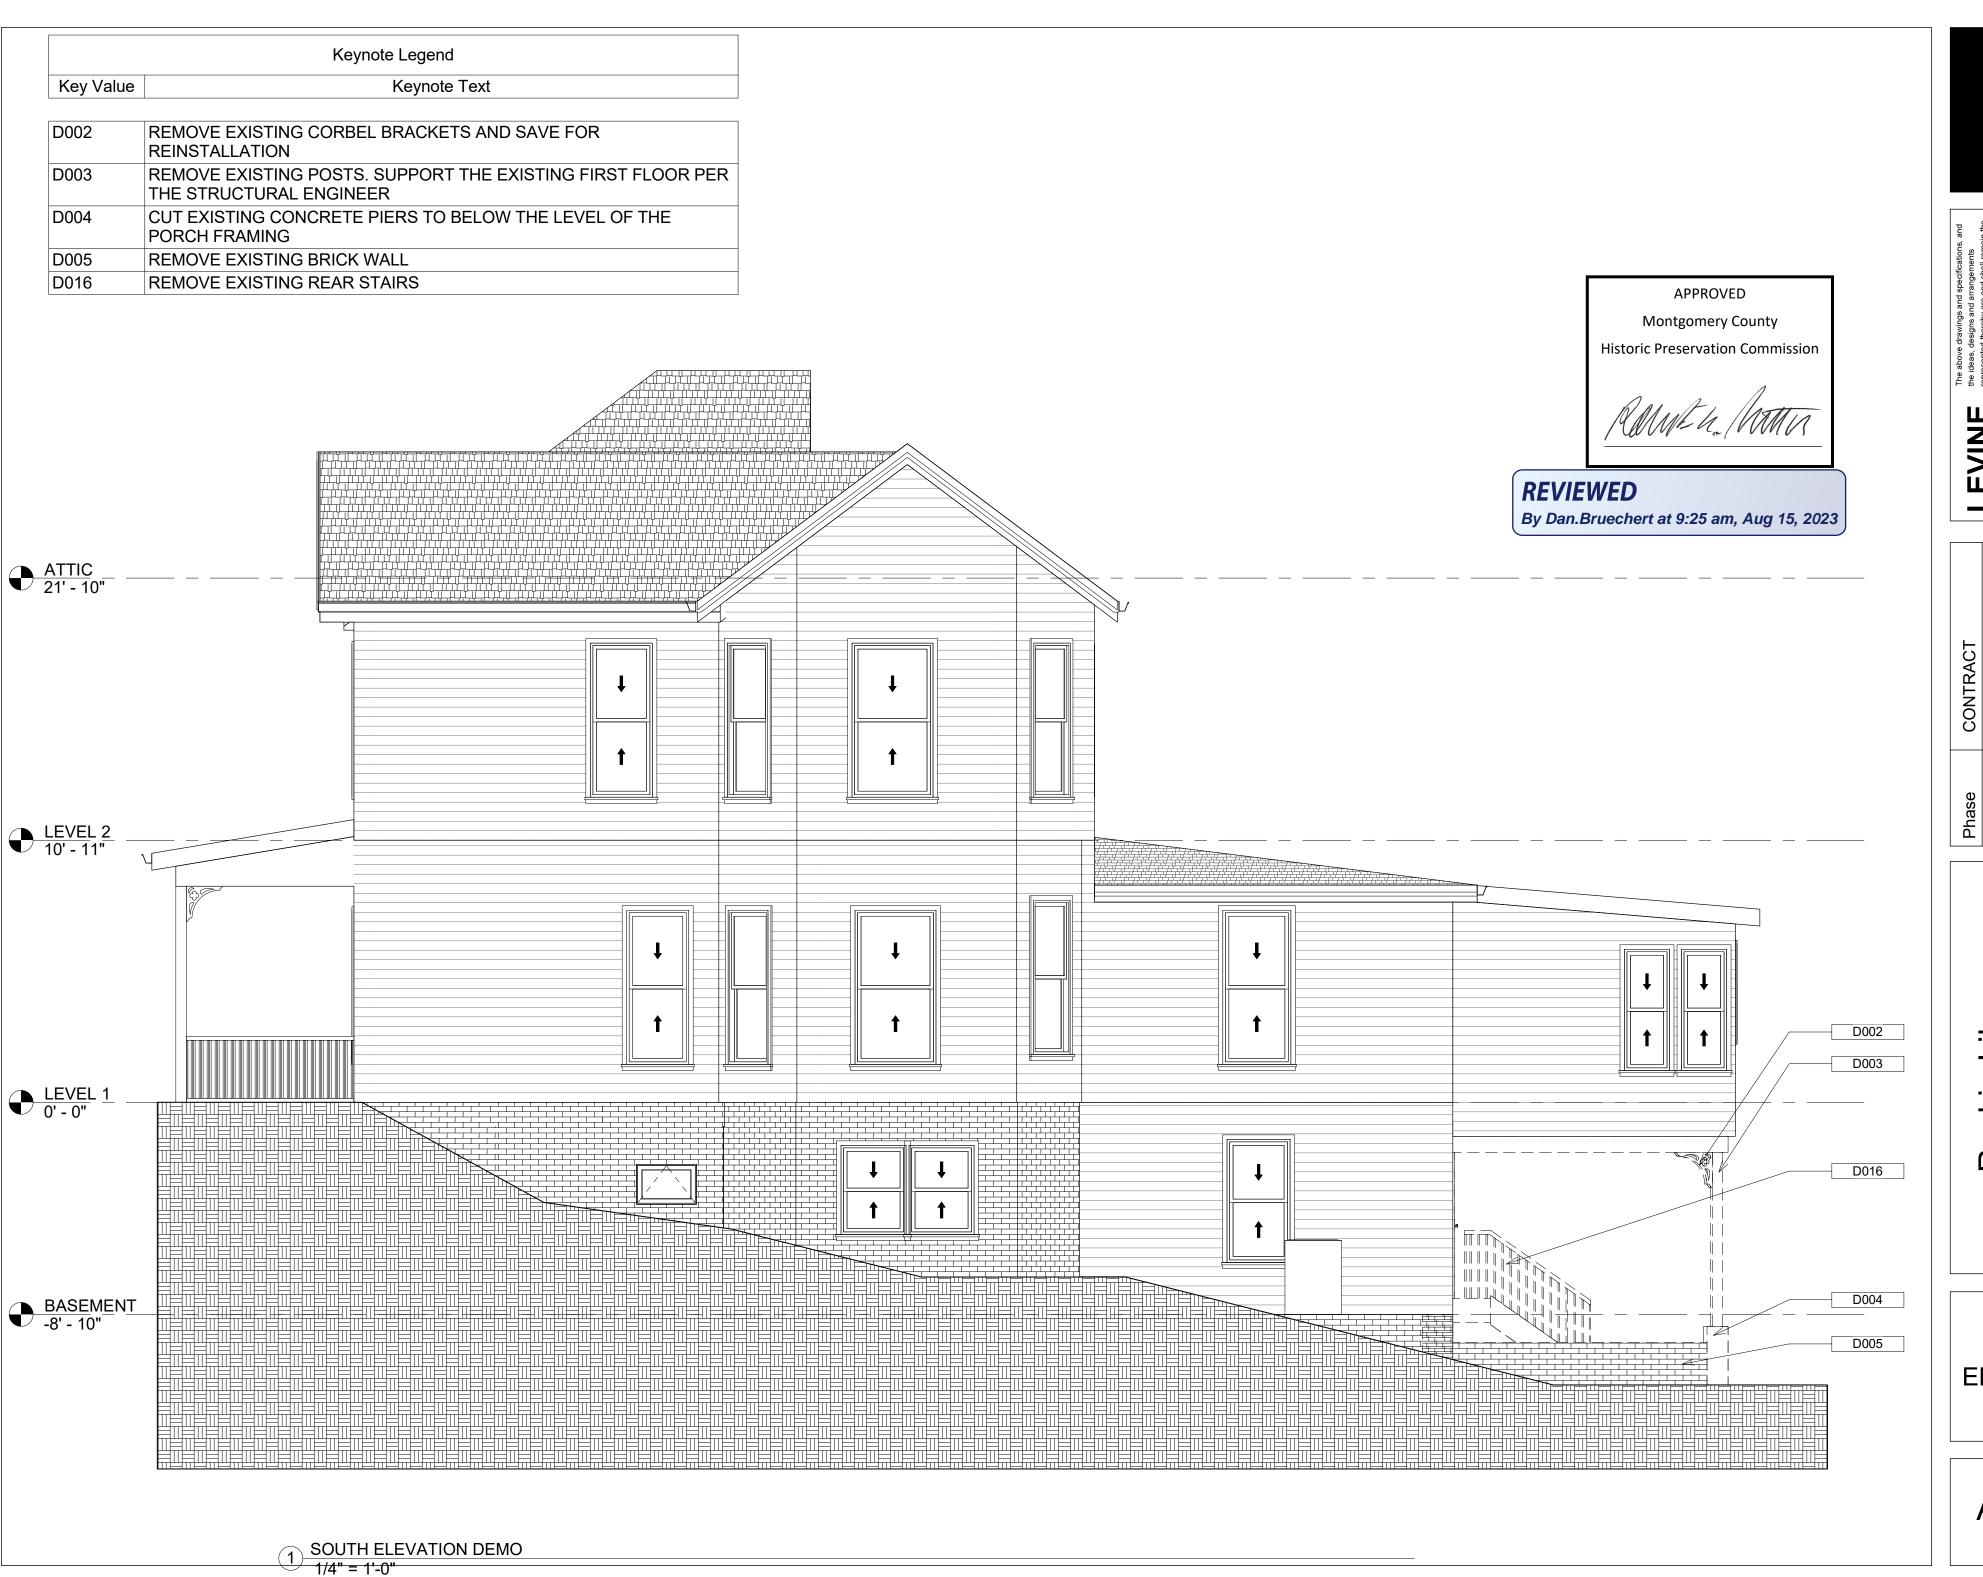

CONTRACT JULY 24, 2023 1/4" = 1'-0" Author Drawn By Scale Date

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DEMO **ELEVATION** 

	Keynote Legend
Key Value	Keynote Text



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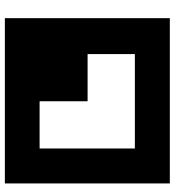
Montgomery County

Historic Preservation Commission

REVIEWED

By Dan.Bruechert at 9:26 am, Aug 15, 2023

1 WEST ELEVATION DEMO
1/4" = 1'-0"




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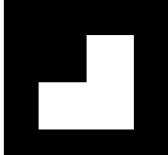
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Phase	CONTRACT
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DEMO ELEVATION





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ARCHITECTS+ BUILDERS 301.585.4848 fax 301.585.4207

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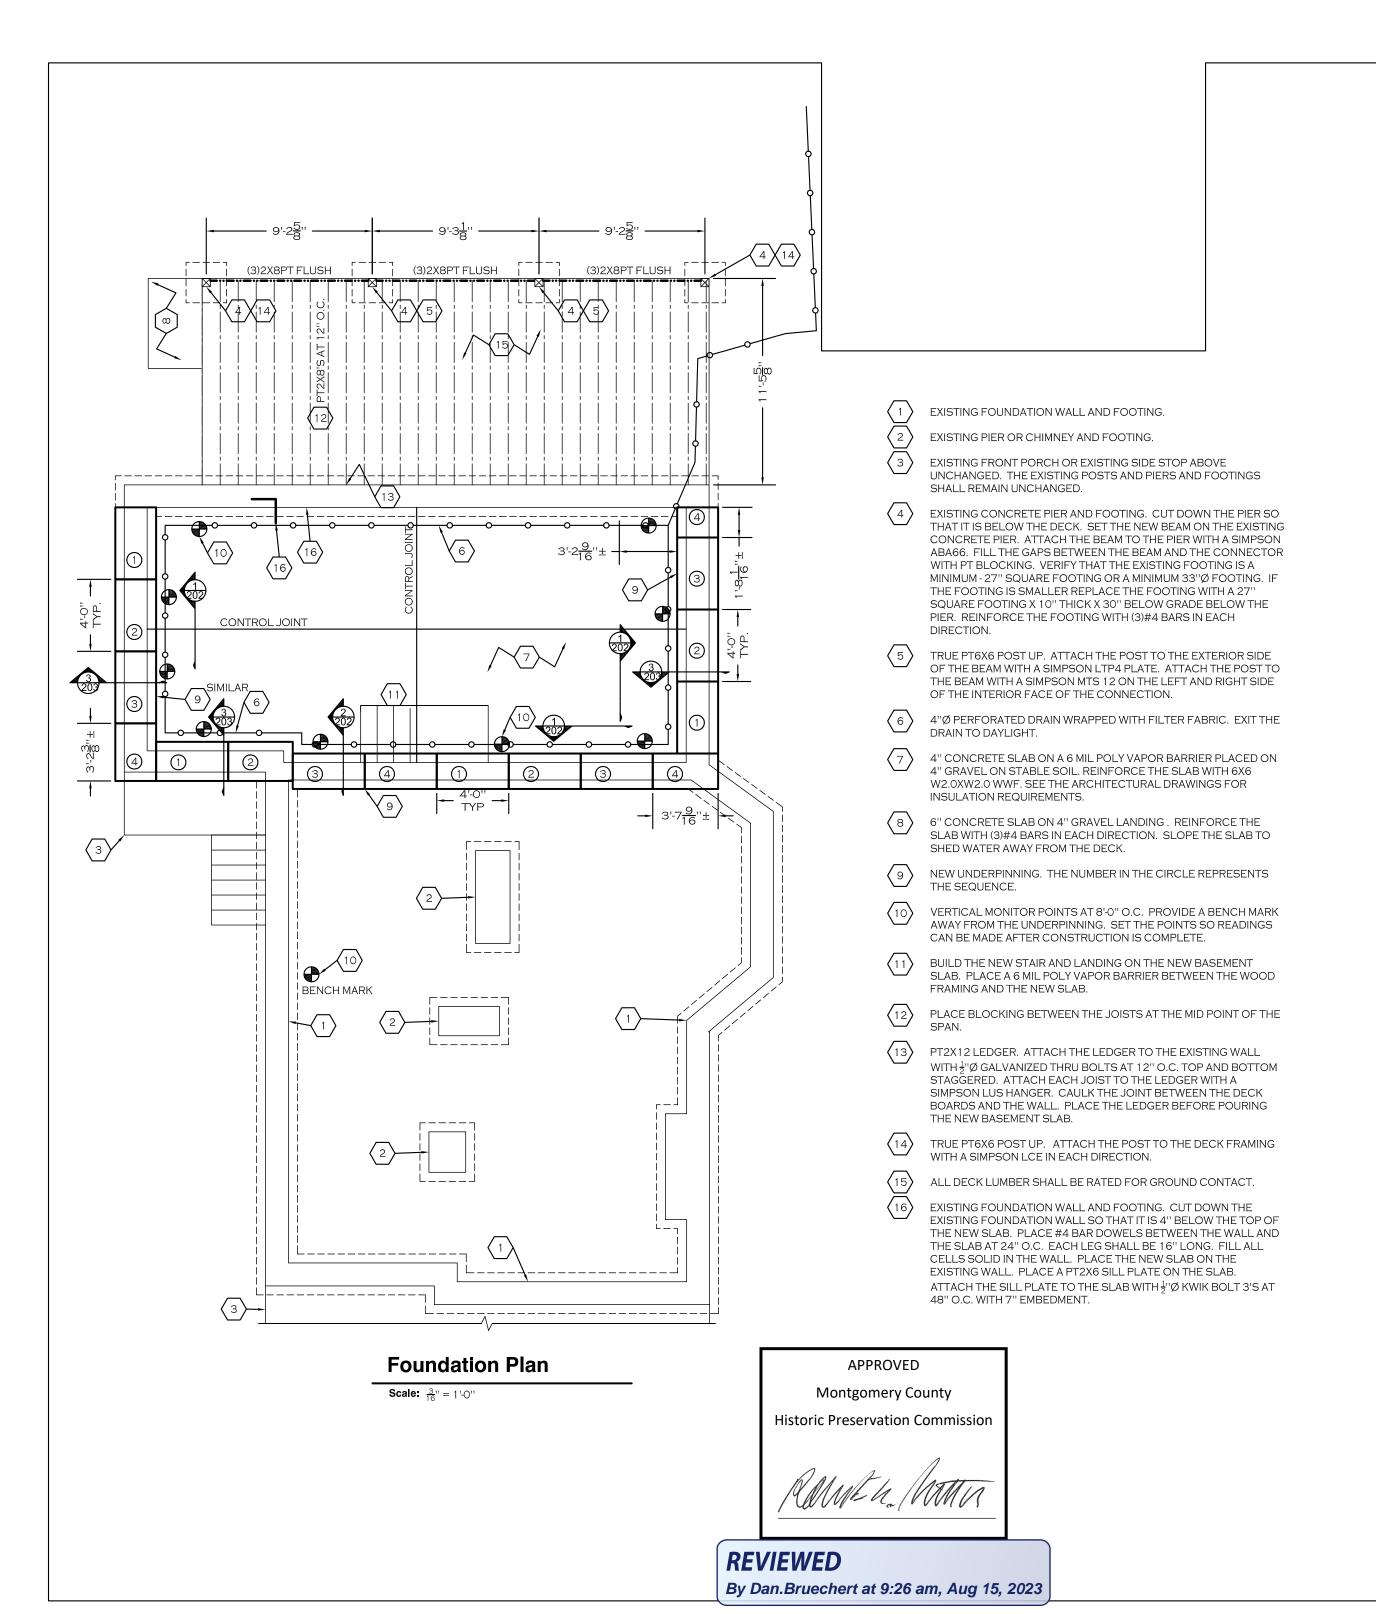
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 Author
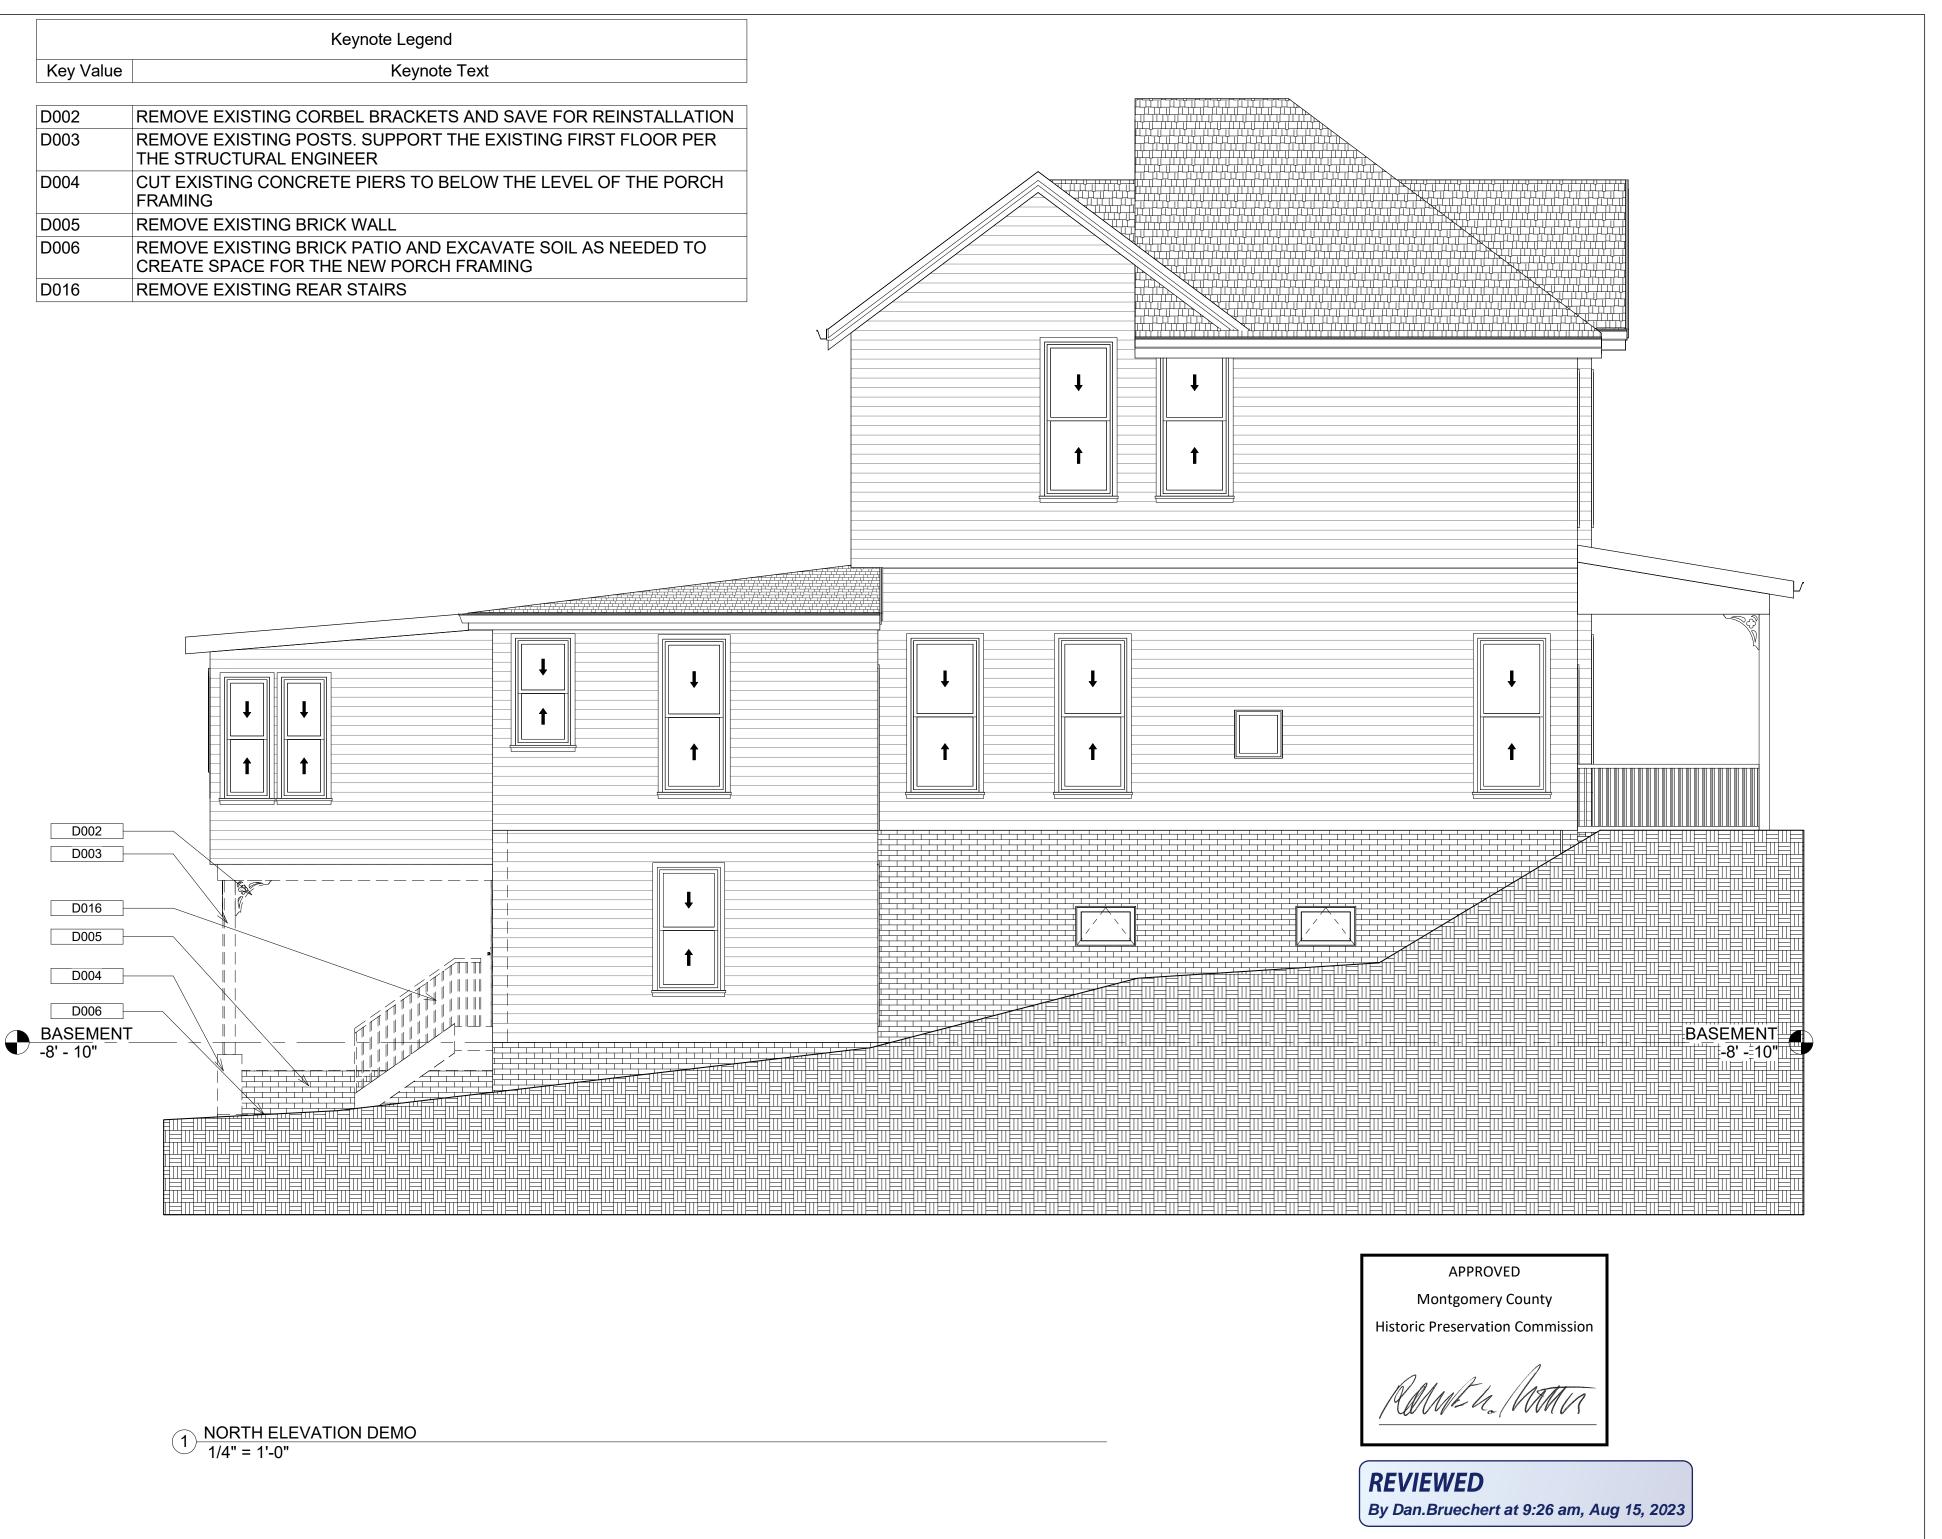
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20912

DEMO ELEVATION



#### FRAMING NOTES:

- 1. THE BOTTOM OF ALL FOOTINGS SHALL BE 30" MINIMUM BELOW GRADE.
- 2. ALL HEADERS ARE ASSUMED TO BE SUPPORTED BY A DOUBLE JACK AND SINGLE KING STUD, UNLESS NOTED OTHERWISE.
- 3. PROVIDE SQUASH BLOCKING AS NEEDED BELOW ALL POSTS, COLUMNS, AND MULTIPLE STUDS.
- 4. ATTACH ALL QUADRUPLE AND QUINTUPLE BEAMS TOGETHER WITH 2 ROWS OF ½ "Ø BOLTS AT 16" O.C. STAGGERED.
- 5. CONTRACTOR SHALL PROVIDE TEMPORARY SHORING DURING CONSTRUCTION AS NEEDED FOR THE EXISTING STRUCTURAL ELEMENTS THAT WILL REMAIN.
- 6. ALL NAILS USED FOR EXTERIOR APPLICATIONS SHALL BE RING SHANK
- 7. ALL NAILS, HANGERS, BOLTS, AND SCREWS EXPOSED TO THE EXTERIOR SHALL BE GALVANIZED.
- 8. ALL LUMBER EXPOSED TO EXTERIOR CONDITIONS SHALL BE TREATED
- SOUTHERN PINE #2.


  9. ALL SLAB CONCRETE SHALL HAVE A 28 DAY COMPRESSIVE STRENGTH OF
- 4500PSI AND HAVE 6%±1% AIR ENTRAINMENT.
  10. WHEN ATTACHING EXISTING JOISTS TO FLUSH BEAMS USE OVERSIZED SIMPSON LUS HANGERS. ADD BLOCKING AS NEEDED TO FILL THE GAPS BETWEEN THE JOIST AND THE HANGER.
- 11. THE CONTRACTOR SHALL SURVEY ALL EXPOSED MASONRY IN THE HOME AND POINT ANY DETERIORATED JOINT THAT IS DISCOVERED AND REPLACE ANY DETERIORATED BRICKS OF BLOCKS.
- ANY DETERIORATED BRICKS OR BLOCKS.

  12. TYPICAL JOIST HANGER SHALL BE A SIMPSON LUS HANGER.
- 13. TYPICAL POST TO BEAM CONNECTOR SHALL BE A SIMPSON LPC ON EACH SIDE
- 14. TYPICAL POST TO FLOOR PLATE CONNECTOR SHALL BE A SIMPSON L30 ON EACH SIDE OF THE POST.
- 15. TYPICAL STRINGER TO FRAMING CONNECTOR SHALL BE A SIMPSON MTS 15
- 16. TYPICAL DIMENSIONAL BEAM TO BEAM HANGER SHALL BE A SIMPSON HU
- 17. TYPICAL LVL TO LVL BEAM HANGER SHALL BE A SIMPSON HHUS.

  18. SEE THE MONTGOMERY COUNTY TYPICAL DECK DETAILS FOR ITEMS.
- 18. SEE THE MONTGOMERY COUNTY TYPICAL DECK DETAILS FOR ITEMS NOT SHOWN ON THESE PLANS SUCH AS GUARD RAILS, STAIRS, LEDGER BOARD ATTACHMENTS ETC . . .
- 19. USE TYPE "N" LIME BASED MORTAR FOR ALL WORK ON THE EXISTING MASONRY WALL. USE CLAY BRICKS THAT MATCH THE STRENGTH AND POROSITY OF THE EXISTING WALL.
- 20. PLACE A DOUBLE JOIST BELOW ALL WALLS THAT ARE PARALLEL TO THE FLOOR FRAMING. ALTERNATE: PLACE BLOCKING BETWEEN THE JOISTS BELOW THE WALLS AT 16" O.C.

#### UNDERPINNING NOTES

- 1.CONTRACTOR SHALL CONDUCT A SURVEY OF THE HOME BEFORE CONSTRUCTION BEGINS. THE SURVEY SHALL DOCUMENT ANY EXISTING CRACKING IN THE STRUCTURE AND ANY EXISTING FLOOR SLOPING OR OTHER DEFECTS IN THE STRUCTURE.
- CALL MISS UTILITY (800)257-7777 BEFORE ANY EXCAVATION BEGINS.
   PRIOR TO UNDERPINNING: EXAMINE THE EXISTING MASONRY WALLS AND POINT ANY DETERIORATED MORTAR JOINTS AND REPLACE ANY DETERIORATED BRICKS.
- 4. ESTABLISH A MONITORING SYSTEM TO MEASURE VERTICAL MOVEMENT IN THE FOUNDATION WALL. THE SYSTEM SHOULD BE SET UP SO THAT MEASUREMENTS CAN BE TAKEN ONCE EVERY 8 FEET. MEASUREMENTS SHOULD BE TAKEN ON A DAILY BASIS DURING CONSTRUCTION. IF VERTICAL SETTLEMENT IN EXCESS OF ½" IS RECORDED, PLACE TEMPORARY SHORING, STOP WORK AND CONTACT STRUCTURAL ENGINEER OF RECORD (SER) SO THAT THE UNDERPINNING CAN BE INSPECTED TO DETERMINE THE CAUSE OF THE MOVEMENT AND DESIGN TEMPORARY SHORING AND REVISE THE UNDERPINNING DESIGN AS NEEDED.
- 5. DO NOT EXCAVATE FOR THE NEW BASEMENT UNTIL THE UNDERPINNING IS COMPLETE.
- 6. PROVIDE TEMPORARY SHORING PER OSHA REGULATIONS FOR ALL PITS DEEPER THEN 4'-0".
- 7. EXCAVATE AND POUR THE UNDERPINNING FOOTINGS PER THE SEQUENCE SHOWN ON THE PLANS. EXCAVATE UNDERPINNING PITS MARKED SEQUENCE 1 FIRST. POUR THE FOOTING AND ALLOW THE CONCRETE TO SET FOR A MINIMUM OF 24 HOURS. ONCE THE CONCRETE HAS SET, PLACE DRY PACK BETWEEN THE UNDERPINNING AND EXISTING FOOTING. FOLLOW THE MANUFACTURES RECOMMENDATIONS FOR ALLOWABLE SET TIME IN DRY PACK. ONCE DRY PACK HAS SET EXCAVATE THE PITS MARKED SEQUENCE 2 AND REPEAT THE SAME PROCESS AS IN SEQUENCE 1. ALLOW DRY PACK TO SET PER THE MANUFACTURES RECOMMENDATIONS AND REPEAT PROCESS FOR SEQUENCE 3-4. ONCE THE UNDERPINNING IS COMPLETE THE NEW BASEMENT CONSTRUCTION MAY PROCEED.

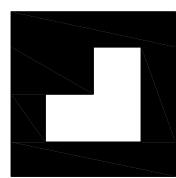

is above drawings and specifications, and ideas, designs and arrangements essented thereby are and shall remain the borty of the architect: No part thereof shall copied, disclosed to others or used in nection with any work or project or by any ar person for any purpose other than for specific project for which they have been ared and developed without the written

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Phase Permit

Date Feb 16. 2023

Scale As Noted

Drawn By GAD

Revision


Raskin Library 7209 Holly Ave, Takoma Park, M 20912

FOUNDATION PLAN

S001



Professional Certification. I hereby certify that these documents were prepared or approved by me, and that I am a duly licensed professional engineer under the laws of the State of Maryland, License No. 25427, Expiration Date: 7/17/24.

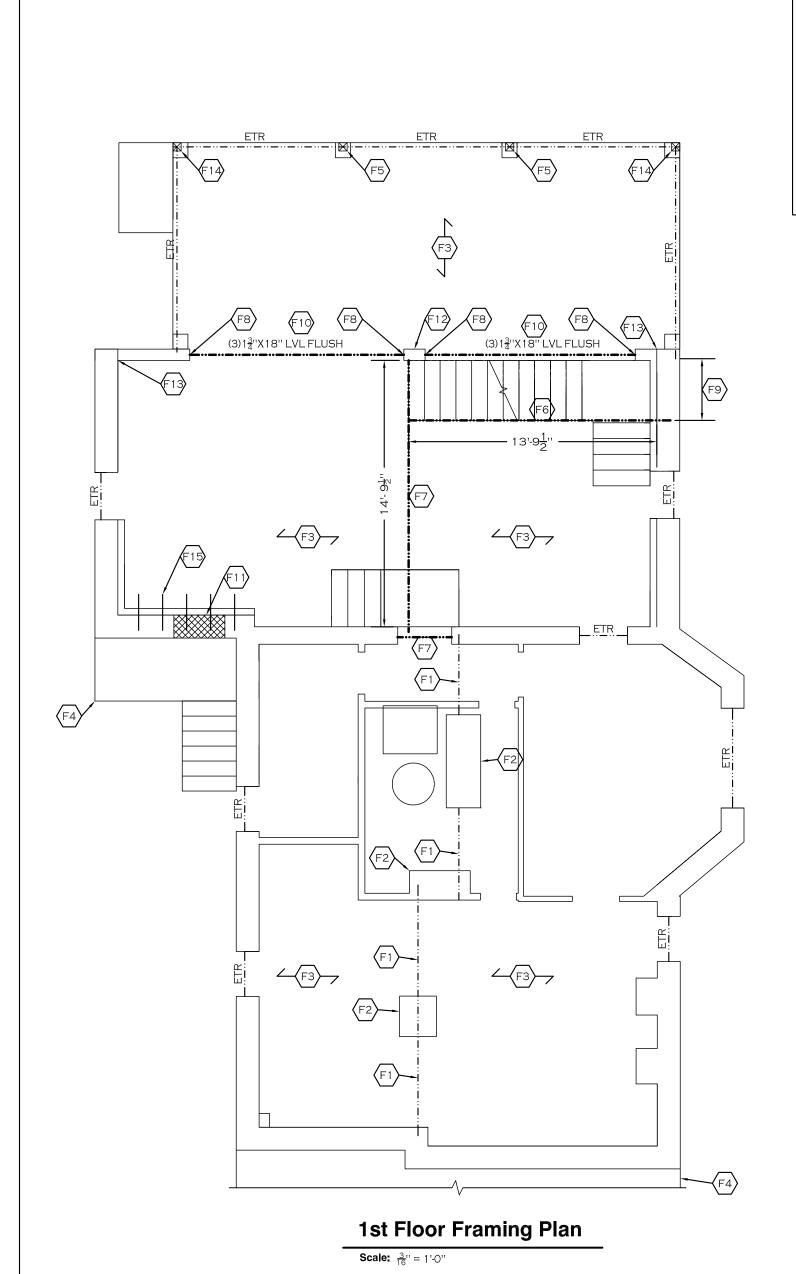

EXISTING BEAM.

EXISTING PIER OR CHIMNEY

EXISTING 1ST FLOOR FRAMING. SISTER ANY DAMAGED JOIST THAT IS FOUND WITH A 2X10 OR A DOUBLE 2X8.

EXISTING FRONT PORCH AND SIDE STOOP UNCHANGED.

REPLACE THE EXISTING POST WITH A TRUE 6X6 WOOD POST. ATTACH THE POST TO THE EXISTING BEAM WITH A SIMPSON LTP4 PLATE ON THE EXTERIOR SIDE AND A SIMPSON MTS 12 ON THE LEFT AND RIGHT SIDE OF THE INTERIOR FACE.

FLUSH QUADRUPLE LVL HEADER. RIP THE HEADER TO MATCH THE HEIGHT OF THE EXISTING FLOOR JOISTS. THE MINIMUM HEIGHT OF THE HEADER SHALL BE  $9\frac{1}{4}$ ".

FLUSH TRIPLE LVL HEADER OR BEAM. RIP THE HEADER TO MATCH THE HEIGHT OF THE EXISTING FLOOR JOISTS. THE MINIMUM HEIGHT OF THE LVL SHALL BE  $9\frac{1}{4}$ ".

SET THE HEADER ON A DOUBLE JACK STUD AND SINGLE KING

VERIFY THAT THE EXISTING SILL PLATE IS A 6X6 AND THAT IT IS CONTINUOUS AT THE NEW STAIR OPINING TO PROVIDE LATERAL STABILITY FOR THE TOP OF THE EXISTING WALL.

ALTERNATE BEAM 1 - 1"X12" STEEL FLITCH BEAM BETWEEN TWO  $1\frac{3}{4}$ "X1 $1\frac{7}{8}$ " LVL'S. SEE THE FRAMING ELEVATION FOR THE BOLTING PATTERN BETWEEN THE LVL'S AND THE STEEL PLATE. ALTERNATE BEAM 2 - W8X48 STEEL BEAM.

INFILL THE EXISTING WALL WITH SOLID CMU. USE CMU THAT MATCHES THE WIDTH OF THE EXISTING WALL. ATTACH THE NEW CMU TO THE EXISTING WALL WITH METAL TIES AT 16" O.C. CAULK THE JOINT BETWEEN THE NEW WALL AND THE EXISTING WALL WITH WATERSTOP RX BY CETCO.

REBUILD THE REAR WALL WITH 2X6 STUDS AT 16" O.C. CONTINUOUS FROM THE SILL PLATE TO THE EXISTING 1ST FLOOR

ATTACH THE 1ST STUD TO THE EXISTING WALL WITH  $\frac{1}{4}$ "Ø SIMPSON TITEN SCREWS AT 12" O.C. AT THE EXISTING MASONRY WALL AND (2)#10 SCREWS AT 6" O.C. AT THE EXISTING WOOD WALL.

REPLACE THE EXISTING POST WITH A TRUE 6X6 WOOD POST. ATTACH THE POST TO THE EXISTING FRAMING WITH A SIMPSON LCE IN EACH DIRECTION.

PLACE SOLID BLOCKING AT 16" O.C. IN THE 1ST BAY.

#### APPROVED

Montgomery County

**Historic Preservation Commission** 




#### **REVIEWED**

By Dan.Bruechert at 9:26 am, Aug 15, 2023

#### FRAMING NOTES:


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- 4. ATTACH ALL QUADRUPLE AND QUINTUPLE BEAMS TOGETHER WITH 2 ROWS OF ½"Ø BOLTS AT 16" O.C. STAGGERED.
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- 8. ALL LUMBER EXPOSED TO EXTERIOR CONDITIONS SHALL BE TREATED
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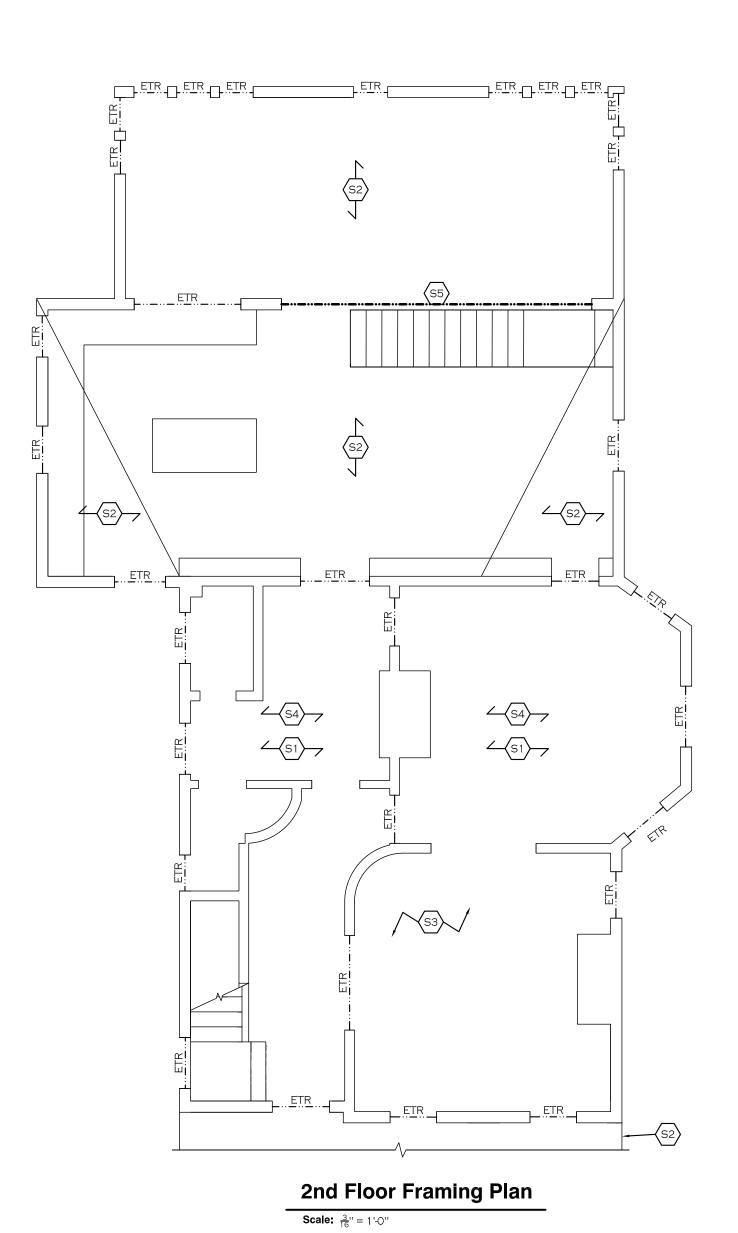


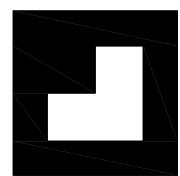Phase	Permit
Date	Feb 16. 2023
Scale	As Noted
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Revision	

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1ST FLOOR FRAMING PLAN



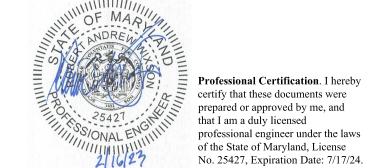

 $\overline{\mathfrak{z}_{1}}$  EXISTING 2ND FLOOR FRAMING UNCHANGED.

EXISTING ROOF FRAMING UNCHANGED.

EXISTING HIP ROOF AND GABLE ROOF FRAMING ABOVE

UNCHANGED.

EXISTING ATTIC FRAMING ABOVE UNCHANGED.

NEW DROPPED 1"X9" STEEL FLITCH BEAM BETWEEN TWO 1½"X9½ LVL'S. SEE THE FRAMING ELEVATION FOR THE BOLTING PATTERN BETWEEN THE STEEL PLATE AND THE LVL'S. WHEN APPLICABLE, ATTACH THE EXISTING RAFTERS TO THE NEW BEAM WITH A SIMPSON H2.5A HURRICANE TIE.

APPROVED

Montgomery County

Historic Preservation Commission

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REVIEWED

By Dan.Bruechert at 9:26 am, Aug 15, 2023

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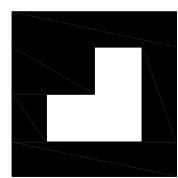
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  9. ALL SLAB CONCRETE SHALL HAVE A 28 DAY COMPRESSIVE STRENGTH OF
- 4500PSI AND HAVE 6%±1% AIR ENTRAINMENT.
- 10. WHEN ATTACHING EXISTING JOISTS TO FLUSH BEAMS USE OVERSIZED SIMPSON LUS HANGERS. ADD BLOCKING AS NEEDED TO FILL THE GAPS BETWEEN THE JOIST AND THE HANGER.
- 11. THE CONTRACTOR SHALL SURVEY ALL EXPOSED MASONRY IN THE HOME AND POINT ANY DETERIORATED JOINT THAT IS DISCOVERED AND REPLACE
- ANY DETERIORATED BRICKS OR BLOCKS.

  12. TYPICAL JOIST HANGER SHALL BE A SIMPSON LUS HANGER.
- 13. TYPICAL POST TO BEAM CONNECTOR SHALL BE A SIMPSON LPC ON EACH
- TYPICAL POST TO FLOOR PLATE CONNECTOR SHALL BE A SIMPSON L30 ON EACH SIDE OF THE POST.
- 15. TYPICAL STRINGER TO FRAMING CONNECTOR SHALL BE A SIMPSON MTS 15
- ON EACH SIDE.

  16. TYPICAL DIMENSIONAL BEAM TO BEAM HANGER SHALL BE A SIMPSON HU
- 16. TYPICAL DIMENSIONAL BEAM TO BEAM HANGER SHALL BE A SIMPSON MAX
- 17. TYPICAL LVL TO LVL BEAM HANGER SHALL BE A SIMPSON HHUS.
  18. SEE THE MONTGOMERY COUNTY TYPICAL DECK DETAILS FOR ITEMS NOT SHOWN ON THESE PLANS SUCH AS GUARD RAILS, STAIRS, LEDGER BOARD ATTACHMENTS ETC . . .
- 19. USE TYPE "N" LIME BASED MORTAR FOR ALL WORK ON THE EXISTING MASONRY WALL. USE CLAY BRICKS THAT MATCH THE STRENGTH AND POROSITY OF THE EXISTING WALL.
- 20. PLACE A DOUBLE JOIST BELOW ALL WALLS THAT ARE PARALLEL TO THE FLOOR FRAMING. ALTERNATE: PLACE BLOCKING BETWEEN THE JOISTS BELOW THE WALLS AT 16" O.C.



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301.585.4848 fax 301.585.420 9466 GEORGIA AVE SUITE 95


Phase	Permit
Date	Feb 16, 2023
Scale	As Noted
Drawn By	GAD
Revision	

# Raskin Library 209 Holly Ave, Takoma Park, Ml 20912

2ND FLOOR FRAMING PLAN

S003

Professional Certification. I hereby certify that these documents were prepared or approved by me, and that I am a duly licensed professional engineer under the laws of the State of Maryland, License No. 25427, Expiration Date: 7/17/24.

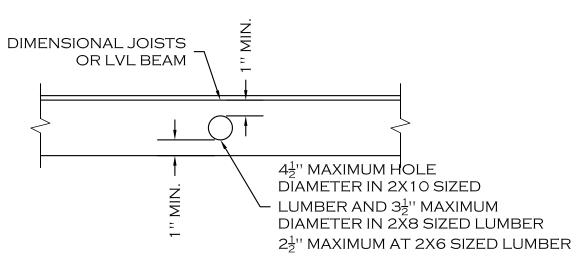

#### Typical Detail at Floor Joist/LVL Beam Holes

**Scale:**  $\frac{3}{4}$ " = 1 -0"

#### **Structural Notes**

- All work and materials to comply with the requirements of the 2018 IBC and IRC codes as revised by Montgomery County
- Codes: the following design standards are applicable by reference:
- TMS 402-2016 Building Code Requirements for Masonry Structures. AWC NDS -2018 - Wood Frame Construction Manuel for One and Two Family Dwellings. ACI 318-14 Building Code Requirements for Reinforced Concrete
- AISC 360-16 Specifications for Steel Buildings. Foundations: footings, underpinning and slab on grades are designed to bear on native soil type SM or SC with an allowable bearing pressure of 2000 psf. A qualified
- soil-bearing inspector prior to placement of concrete shall verify all bearing values. Structural steel:
- A. All structural steel, including detail material shall conform to ASTM A572 Fy = 50ksi, U.N.O.
- B. All structural tubing shall conform to ASTM A500, grd.B
- C. All steel pipe shall be ASTM A53, type E or S, grade B
- D. All welders shop and field, shall be certified. Use E70xx electrodes only.
- E. All steel exposed to weather and exterior masonry support shall receive one shop coat of corrosion-inhibiting primer.
- F. Detailing, fabrication and erection shall be in accordance with AISC. Adequately brace all steel against lateral loads during erection.
- G. All exterior structural steel shall receive rust preventative paint.
- H. Connections:
- I. All beam connections shall be simple shear connections, U.N.O. Where no reaction is provided, the beam shall be assumed to carry 120 % of the allowable uniform load in Kips for beams laterally supported, as given in the AISC steel construction manual.
- II. Except as noted, all fasteners shall be 3/4" diameter ASTM A325 bolts, designed to act in bearing type connections with threads included.
- Lumber:
  - A. Lumber shall be SPF #2 with a min. Fb = 875psi Min. Fv = 135psi and min. E =
  - B. LVL and PSL shall have a min. Fb = 2850psi; Fv = 285psi; E = 2,000,000psi.
  - C. Floor decking shall be 3/4" APA rated decking. Roof decking shall be 5/8" APA rated decking. Wall sheathing shall be  $\frac{1}{2}$ " APA rated sheathing. Glue and screw the floor
  - D. Interior wood walls shall be 2x4 studs at 16" O.C. and exterior walls shall be 2x6 studs at 16" O.C. with a double top plate and single bottom plate. Provide solid blocking at the midheight of each wall and at a minimum of 48" O.C. vertically.
  - E. Provide double joists under all walls that run parallel to floor framing.
  - F. Nail all multiple members together per the manufacturer's recommendations and at a minimum use 2-10d nails at 6" O.C. stagger sides that nails are driven from.
  - G. Provide bridging at center of all joist spans Exceeding 8'-0" and at 1/3 points of all joist spans exceeding 16'-0". Provide solid blocking at all bearing points on top of walls or beams.
  - H. Provide solid blocking below all wood posts.
  - I. All posts shall have Simpson Cap and Base Plates typ.
  - J. All joists shall have Simpson Hangers where applicable.
  - K. Glue all multiple studs together. Nail together with 2-10d nails at 3" O.C. Stagger the sides of the studs that the nails are driven from.
  - L. All lumber in contact with masonry or concrete or within in 8" of soil shall be pressure treated. All lumber to conform to IRC R317 and R318 for protection against corrosion and termite damage.
  - M. All lumber shall be kiln dried. Store lumber on site in such a manner as to prevent the seepage of water into the wood.
  - N. Wood Lintels shall be as follows:
    - Opening < 3'-0" 2-2x6 3'-0" < Opening < 5'-0" - 2-2x8 5'-0"< Opening ≤ 8'-0" - 2-2x10 Greater than 8'-0" - See plans

- Fasteners:
- A. All prefabricated angles, bearing plates, and joist hangers shall be installed per the manufacturer recommendations.
- B. Follow the manufacturer recommendations for setting epoxy bolts.
- C. Expansion bolts shall be rawl power studs.
- A. Masonry construction shall be in conformance with the applicable sections of TMS 402-2016, "Building Code Requirements for Masonry Structures."
- B. Concrete masonry units shall be hollow load bearing units (ASTM C90) grade n-1 with a net strength of 2000psi and F'm - 1500psi.
- C. All joints to be filled solid with mortar.
- D. Mortar to comply with ASTM C270 (type M or S).
- E. Provide corrugated masonry ties between brick facia and wood walls or cmu walls at 16" O.C. in each direction.
- F. Provide 9ga truss style joint reinforcement @ 16" O.C. vertically.
- G. Lintels shall be as follows:
  - Opening  $\leq 3'-0" L4x3\frac{1}{2}x\frac{1}{4}LLV/4"$  of wall 3'-0" < Opening  $\leq$  7'-0" - L6x3 $\frac{1}{2}$ x $\frac{5}{16}$  LLV/ 4" of wall.
- Opening > 7'-0" See Plan 8. Cast in place concrete:
- A. Concrete construction shall be in conformance with the applicable sections of ACI 318-14, "Part 3 - Construction Requirements."
- B. Concrete shall have a minimum compressive strength at 28 days of 3000psi, UNO (unless noted otherwise).
- C. All concrete shall be placed with a slump of 4"  $(+\frac{1}{2}")$
- D. All concrete shall be normal weight, UNO.
- E. All concrete exposed to weather shall have 6% +1% entrained air.
- F. Contractor shall pour extra concrete to account for the deflection of the formwork to provide a flat finished surface.
- G. Concrete cover for reinforcement shall be:
  - Columns and beams Slabs Footings
- Reinforcement:
- A. Reinforcing bars shall be deformed bars conforming to ASTM A615, grade 60
- B. Welded wire fabric (wwf) shall conform to ASTM a185. Lap edges of wire fabric at least 6" in each direction.
- 10. Dimensions: The contractor shall field verify all dimensions prior to fabrication of structural components.
- 11. Coordination: The contractor shall coordinate all sleeves, duct openings and holes between trades. Any conduits or pipes embedded in concrete must be in accordance with ACI 318-14, chapter 6. Where sleeves are closely spaced in a group, the group shall be treated as an opening and reinforced accordingly. Submit drawings showing all opening sizes and locations for the approval by the structural engineer.

#### Dead Loads:

SPF #2 -	25 PCF
½ Decking -	1.7 PSF
¾" Decking -	2.5 PSF
Asphalt Shingles -	2.5 PSF
Slate Shingles -	15 PSF
½" Drywall -	2.2 PSF
Insulation -	1.5 PSF
Siding -	2.0 PSF
CMU -	87 PCF
Brick -	130 PCF
LIVE LOADS:	
DECK:	40PSF
ATTIC:	20PSF
FLOOR:	40PSF
BALCONY	60PSF
BEDROOM	40PSF
ROOF:	30PSF
WIND LOADS	
WIND SPEED:	Vult = 115mph; Vasd = 89mph
WIND LOAD IMPORTANCE FACTOR:	1.0
WIND EXPOSURE FACTOR:	В
WIND DESIGN PRESSURE:	11PSF
SNOW LOADS:	
GROUND SNOW LOAD (PG):	30PSF
FLAT ROOF SNOW LOAD(PF):	30PSF
SNOW EXPOSURE FACTOR (CE):	0.9
SNOW IMPORTANCE FACTOR (I):	1.0
Deflection Limitations:	
Rafters:	L/240
Interior Walls and Partitions:	H/180
Floors and Plastered Ceilings:	L/360
All Other Structural Members:	L/240
Ext. Walls with plaster or stucco finishes:	L/360
Ext. Walls - Wind Loads with Brittle Finishes:	L/240
Ext. walls - Wind Loads with Flexible Finishes:	L/120
SEISMIC DESIGN DATA:	
SEISMIC IMPORTANCE FACTOR (Ie):	1.0

SPECTRAL RESPONSE ACCELERATIONS:

SPÉCTRAL RESPONSE COEFFICIENTS:

SEISMIC DESIGN CATEGORY:

SEISMIC COEFFICIENT (Cs):

ANALYSIS PROCEDURE:

SEISMIC SITE CLASSIFICATION:

SEISMIC MODIFICATION FACTOR (R):

(Sds):

(Sd1):

BASE SHEAR:

BASIC SFRS:

20.0%

8.0%

33%


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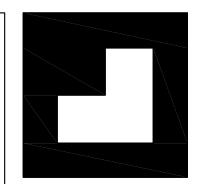
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LIGHT FRAMED WALLS

18.7%



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APPROVED

Montgomery County

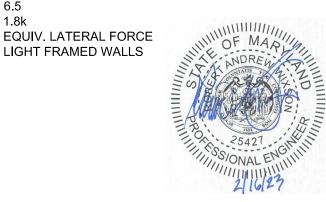**Historic Preservation Commission** 


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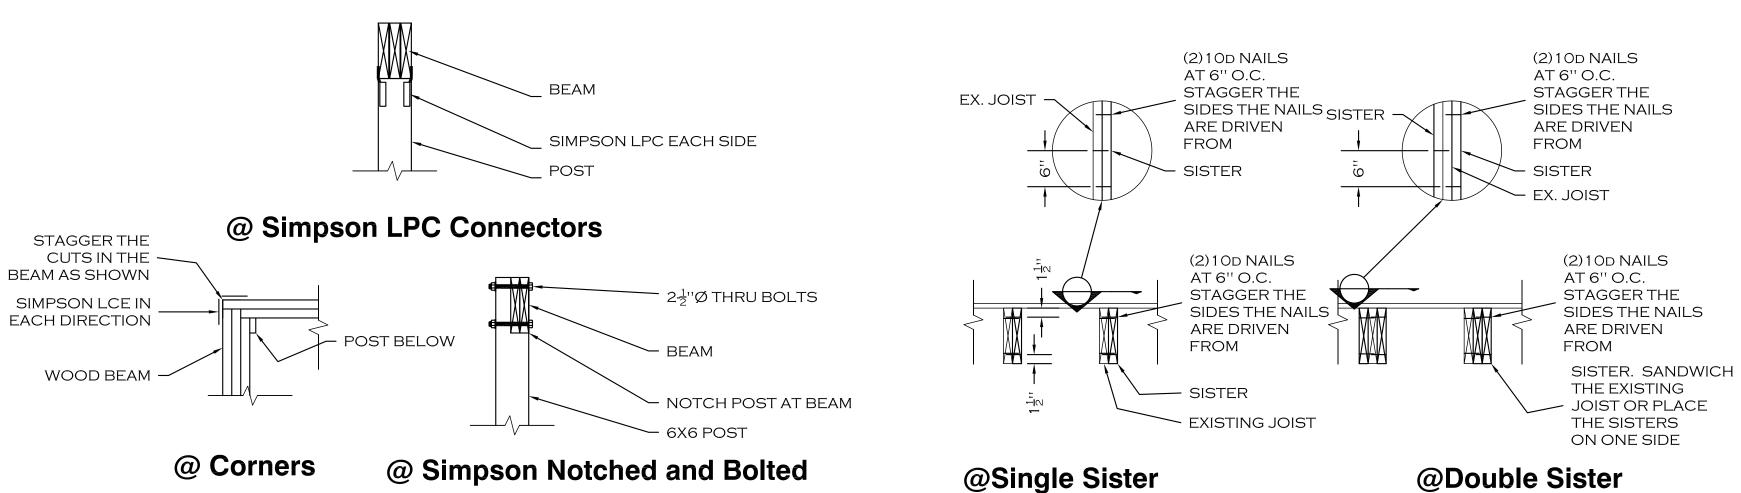
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STRUCTURAL NOTES AND DETAILS






#### Typ. Wood Post To Beam Details

**Scale:**  $\frac{3}{4}$ " = 1'-0"
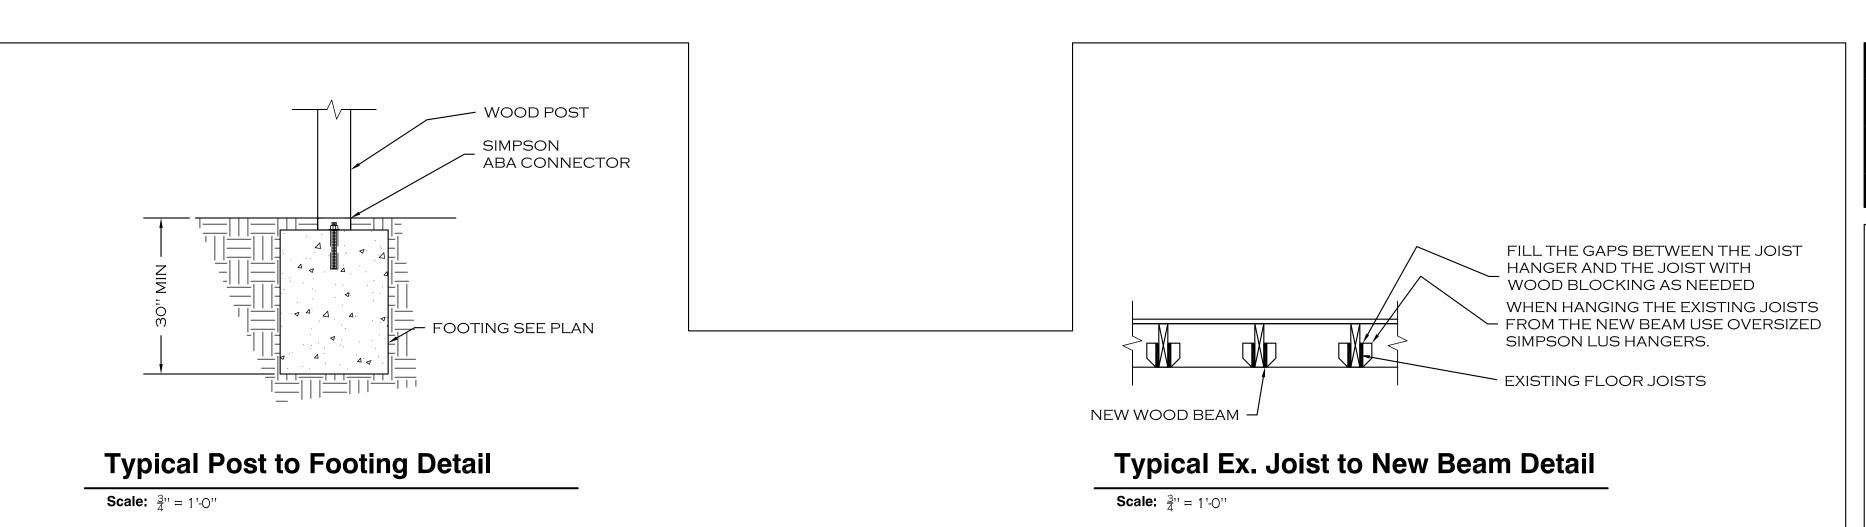
# Typical Sistering Details Scale: NTS

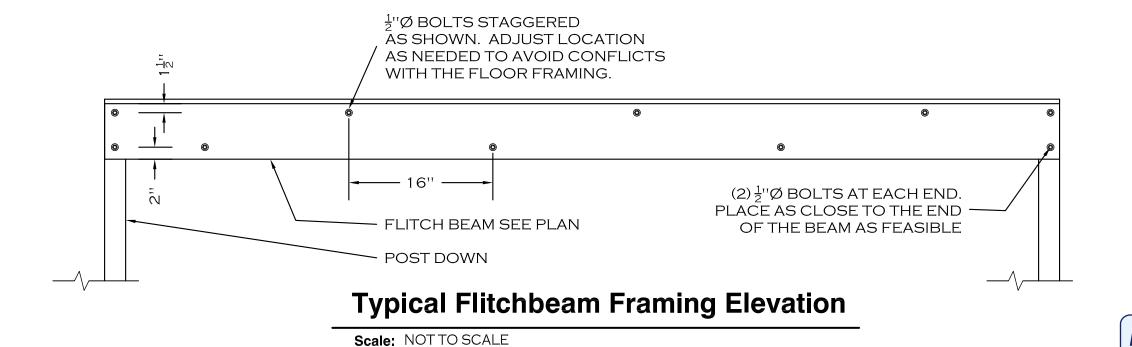

APPROVED

Montgomery County

Historic Preservation Commission

REVIEWED

By Dan.Bruechert at 9:26 am, Aug 15, 2023



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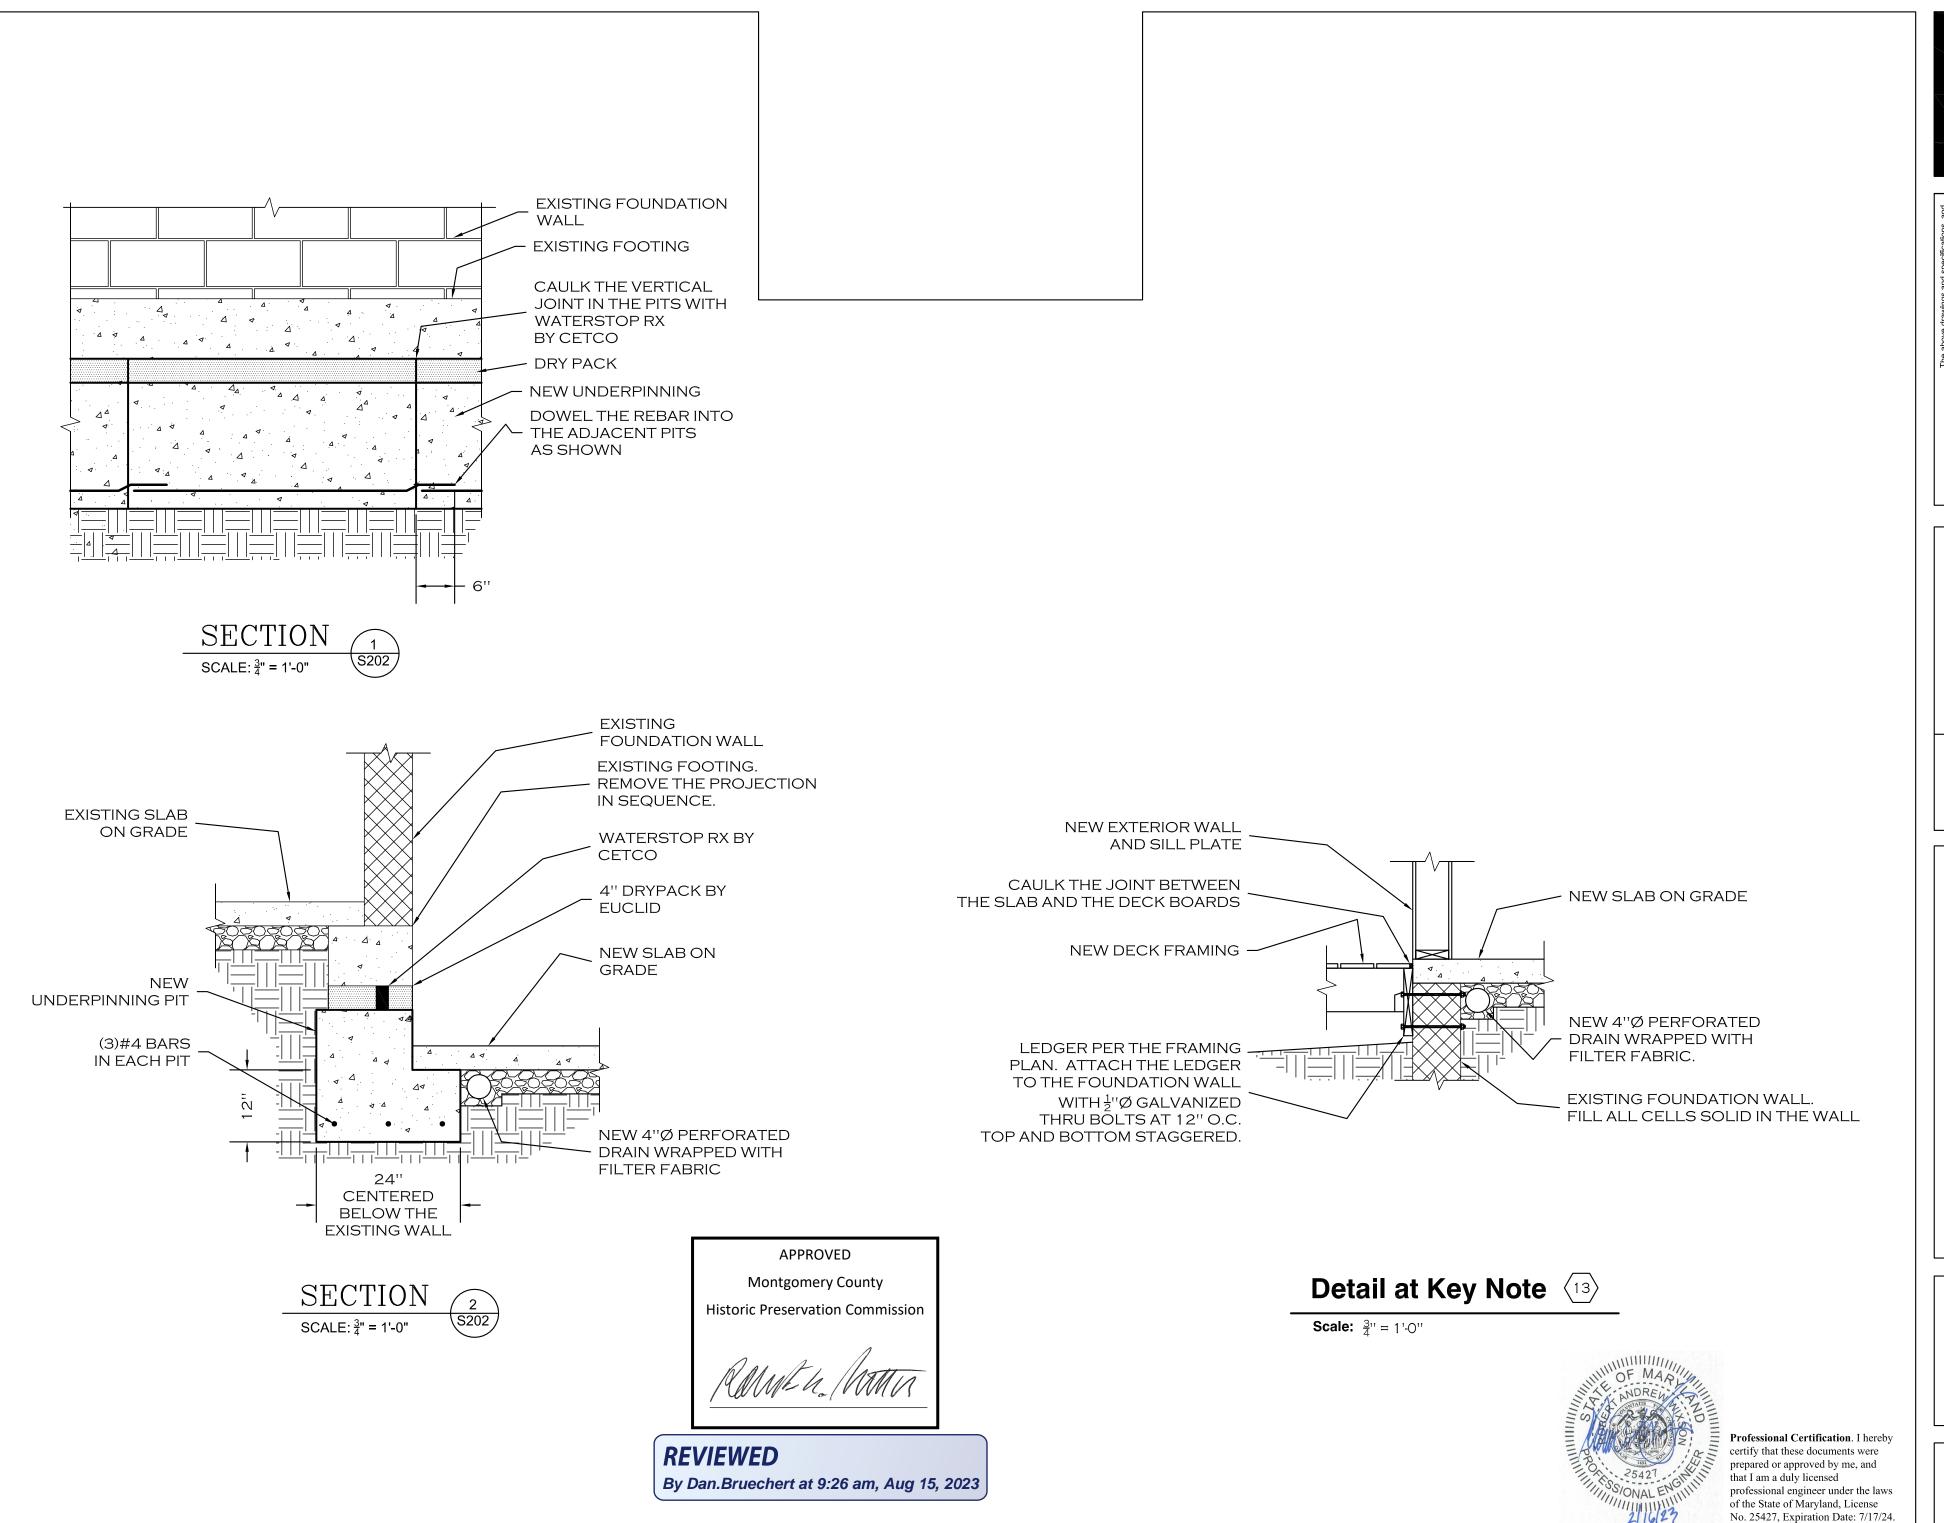
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Revision

Raskin Library '209 Holly Ave, Takoma Park, MD 20912

STRUCTURAL DETAILS



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Raskin Library


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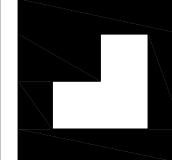
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STRUCTURAL DETAILS





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STRUCTURAL DETAILS

	Keynote Legend	7
Key Value	Keynote Text	
		_

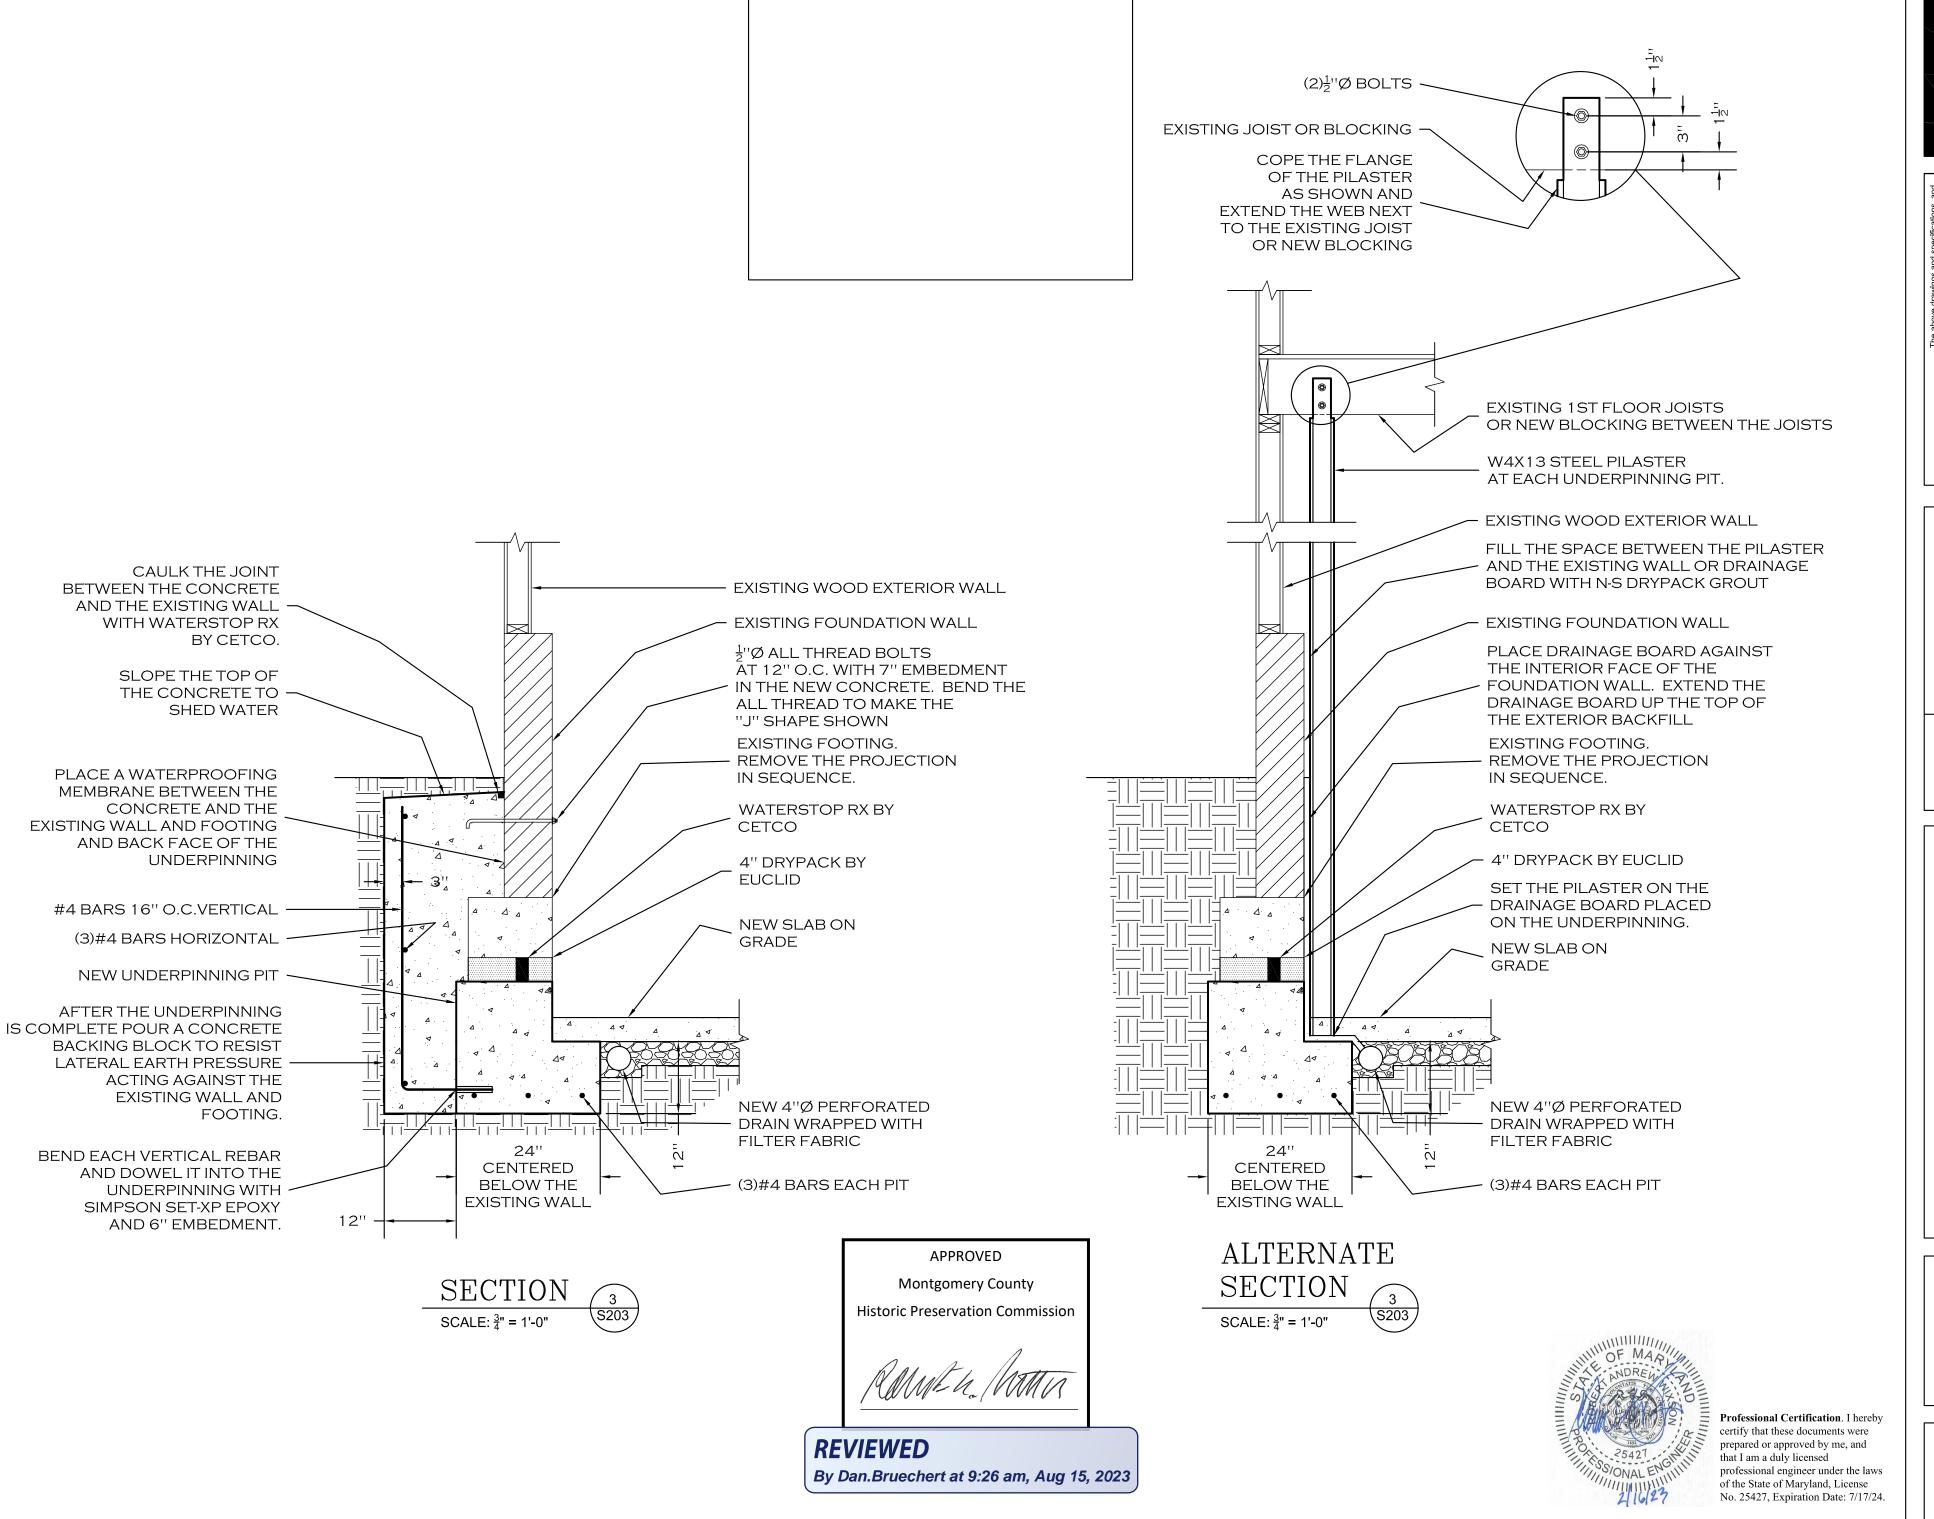A001	PORCH FRAMING TO HAVE 4" AIR GAP AND 2" LOOSE GRAVEL
A002	NEW 1X BEADED T&G CEILING, COLOR TBD
A003	NEW 6X6 COLUMN. ATTACHMENT PER STRUCTURAL ENGINEER
A004	NEW AZEK COMPOSITE COLUMN WRAP AT ALL COLUMNS
A005	FALSE COLUMNS TO ATTACH SCREENS WHERE PORCH MEETS HOUSE
A006	NEW INSECT SCREENING. PANELS TO FILL OPENING WITH NO MULLIONS
A007	NEW 36"x81" LARSEN 360-48 HINGED PREMIUM SCREEN DOOR, WHITE ALUMINUM, STANDARD SCREEN.
800A	NEW WOOD DECKING, SPECIES TBD. LAY INSECT SCREENING BETWEEN THE DECKING AND THE FRAMING.
A009	REINSTALL EXISTING CORBELL BRACKETS
A010	RELOCATE HOSE BIB
A011	NEW 2X6 REAR WALL OF HOUSE. INSULATE TO R20 W/ OPEN CELL SPRAY FOAM
A013	NEW CLOSED RISER STAIR. SEE STAIR DETAILS ON SHEET A013
A014	FRAME SIDE AND FRONT EXTERIOR WALLS OF LIBRARY WITH NEW 2X4 FRAMING TO INSIDE OF EXPOSED FOUNDATION WALL, CREATING AN AIR GAP BETWEEN THE NEW FRAMING AND THE EXISING WOOD FRAME WALL. INSULATE NEW WALL ASSEMBLY TO R20 W/ OPEN CELL SPRAY FOAM INSULATION.
A015	ALIGN EDGE OF WALL WITH EDGE OF CHIMNEY
A030	NEW DRY STACK RETAINING WALL TO MITIGATE CHANGE IN GRADE. REGRADE AREA TO DIRECT WATER AWAY FROM HOUSE AND NEW DECK
A031	NEW CEILING/FLOOR FRAMING AT EXISTING STAIR OPENING. PATCH DRYWALL AS NEEDED.
A032	INFILL WALL AND PATCH SIDING AT DOOR OPENING. USE EXISTING SIDING FROM REAR WALL OF BASEMENT IF POSSIBLE.
A033	INFILL MASONRY WALL WITH NEW FRAMING
A034	NEW GWB AT ALL WALLS OF GUEST BEDROOM
A035	NEW 2X4 FRAMING W/ NEW GWB


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**Montgomery County** 

**Historic Preservation Commission** 

By Dan.Bruechert at 9:26 am, Aug 15, 2023

**REVIEWED** 



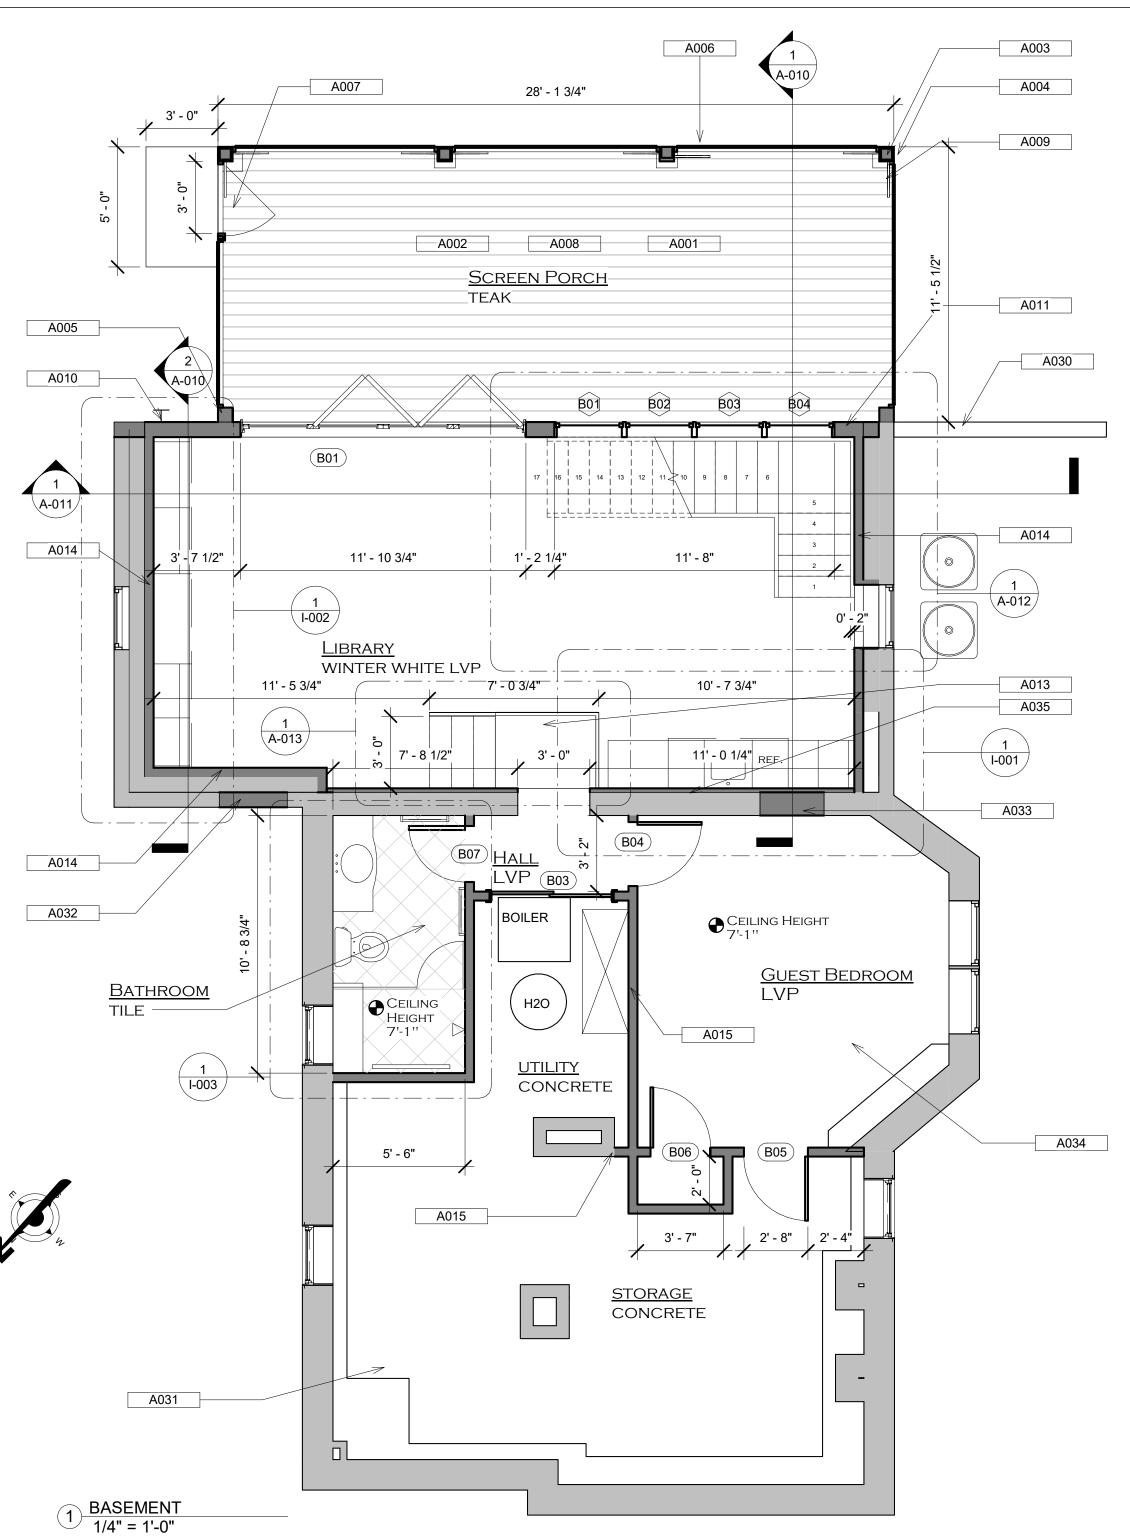

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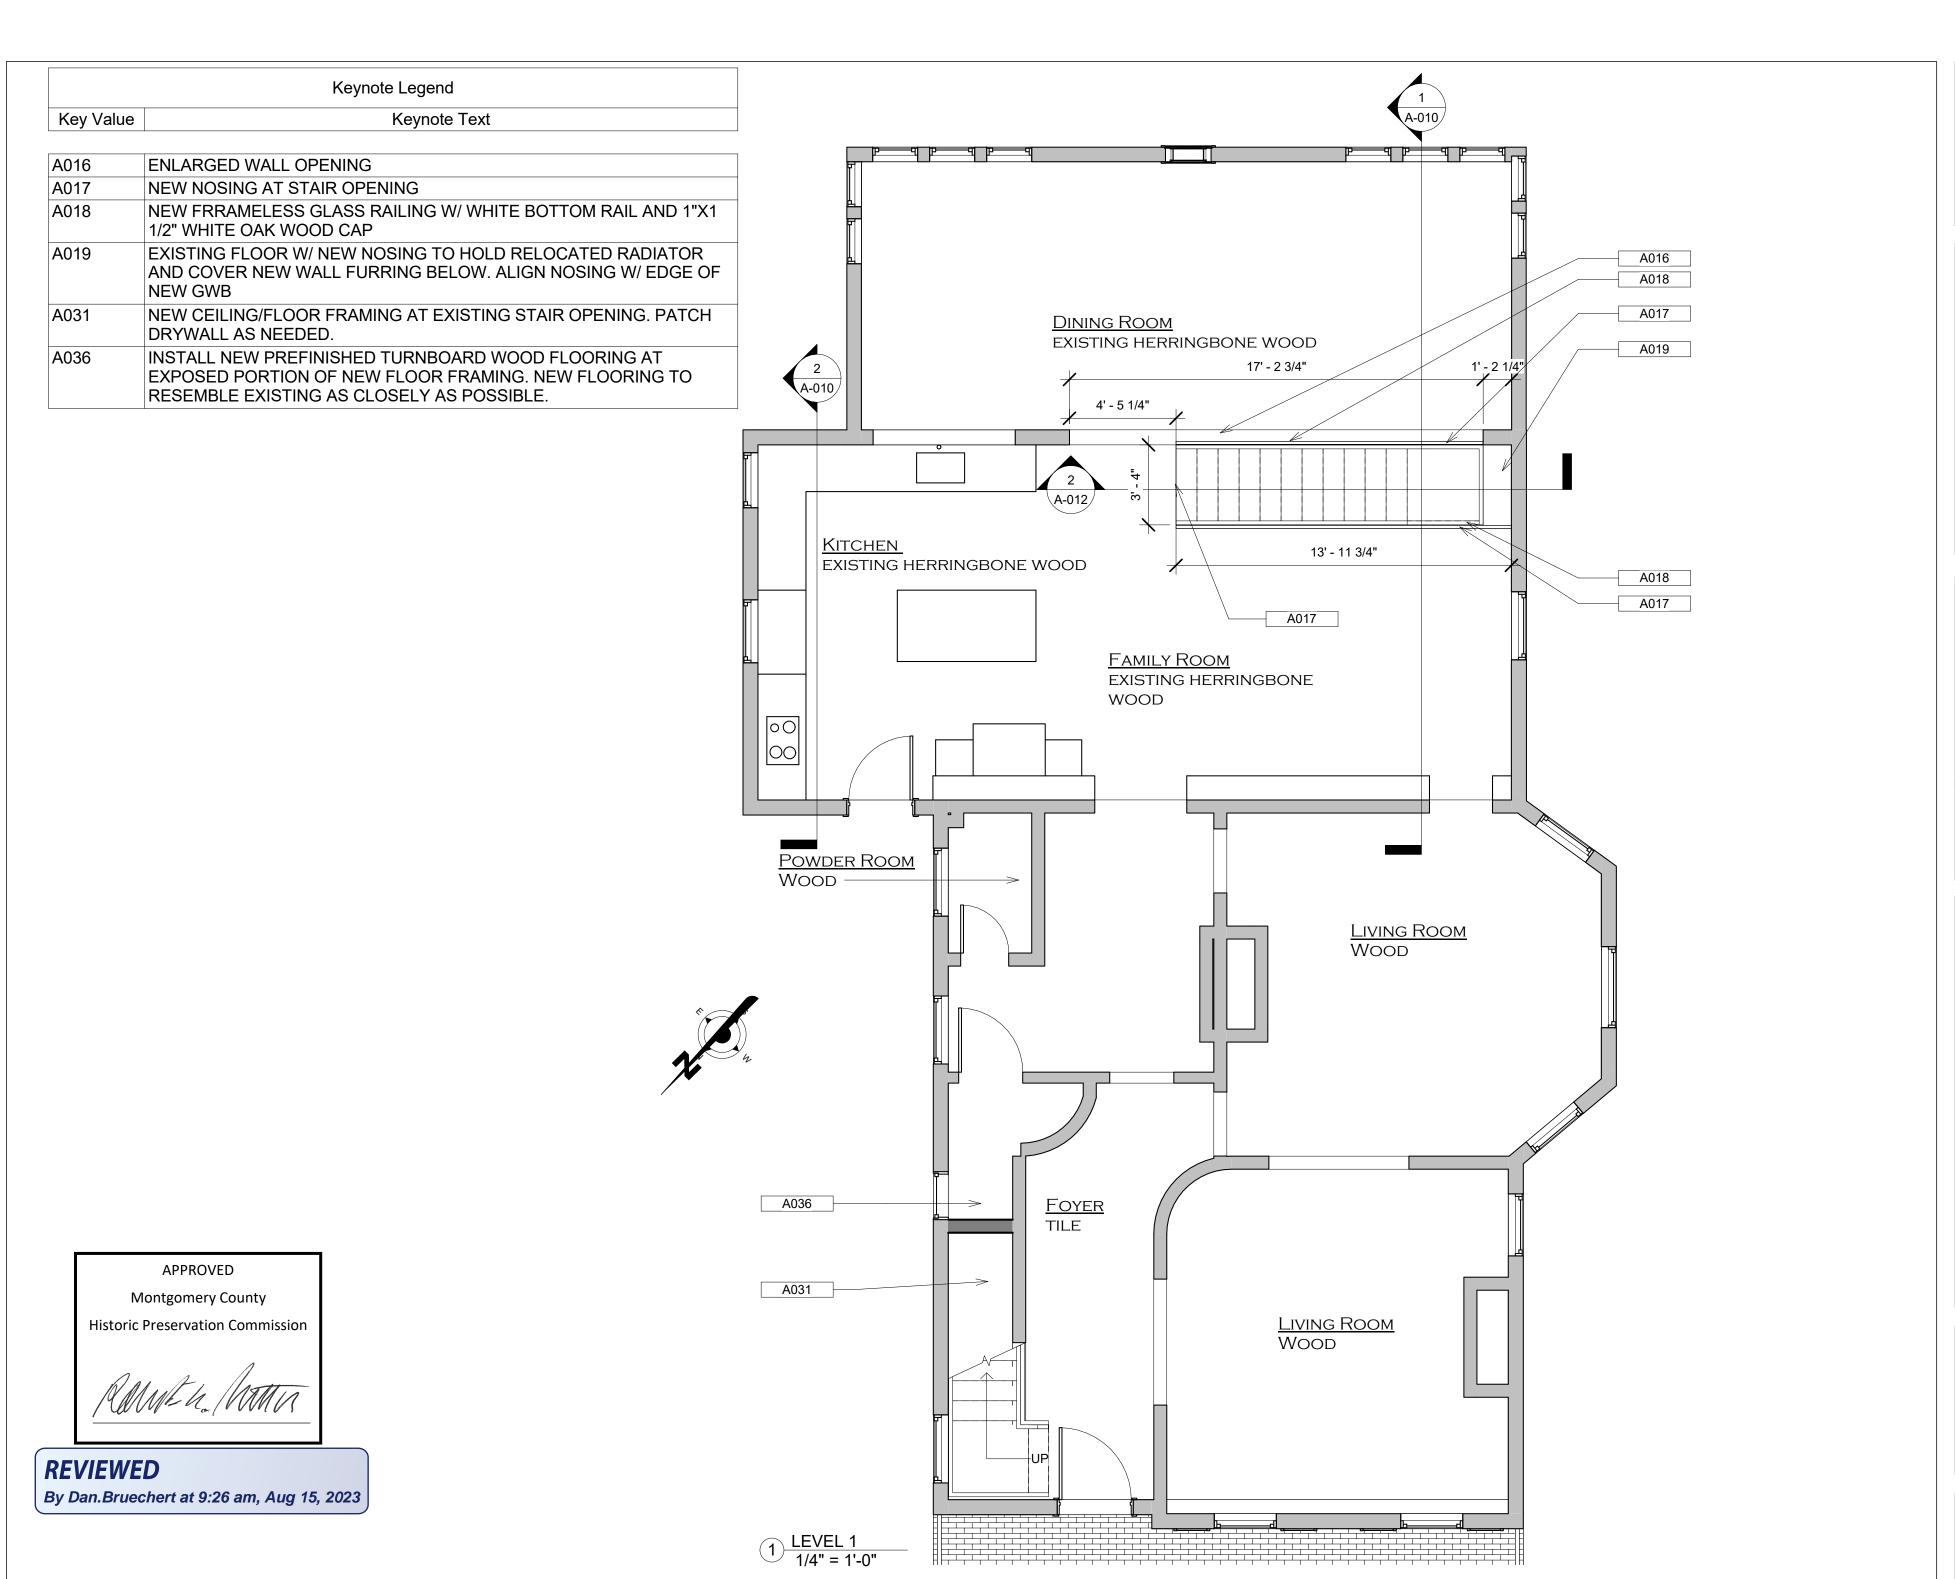
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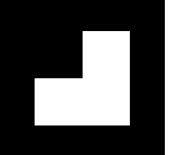
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BASEMENT PLAN






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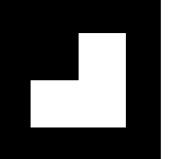
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FIRST FLOOR PLAN






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Phase	Date	Scale	Drawn By	Revision

MD Park, skin Library Ave, Takoma F 20912 Ra **7209 Holly** 

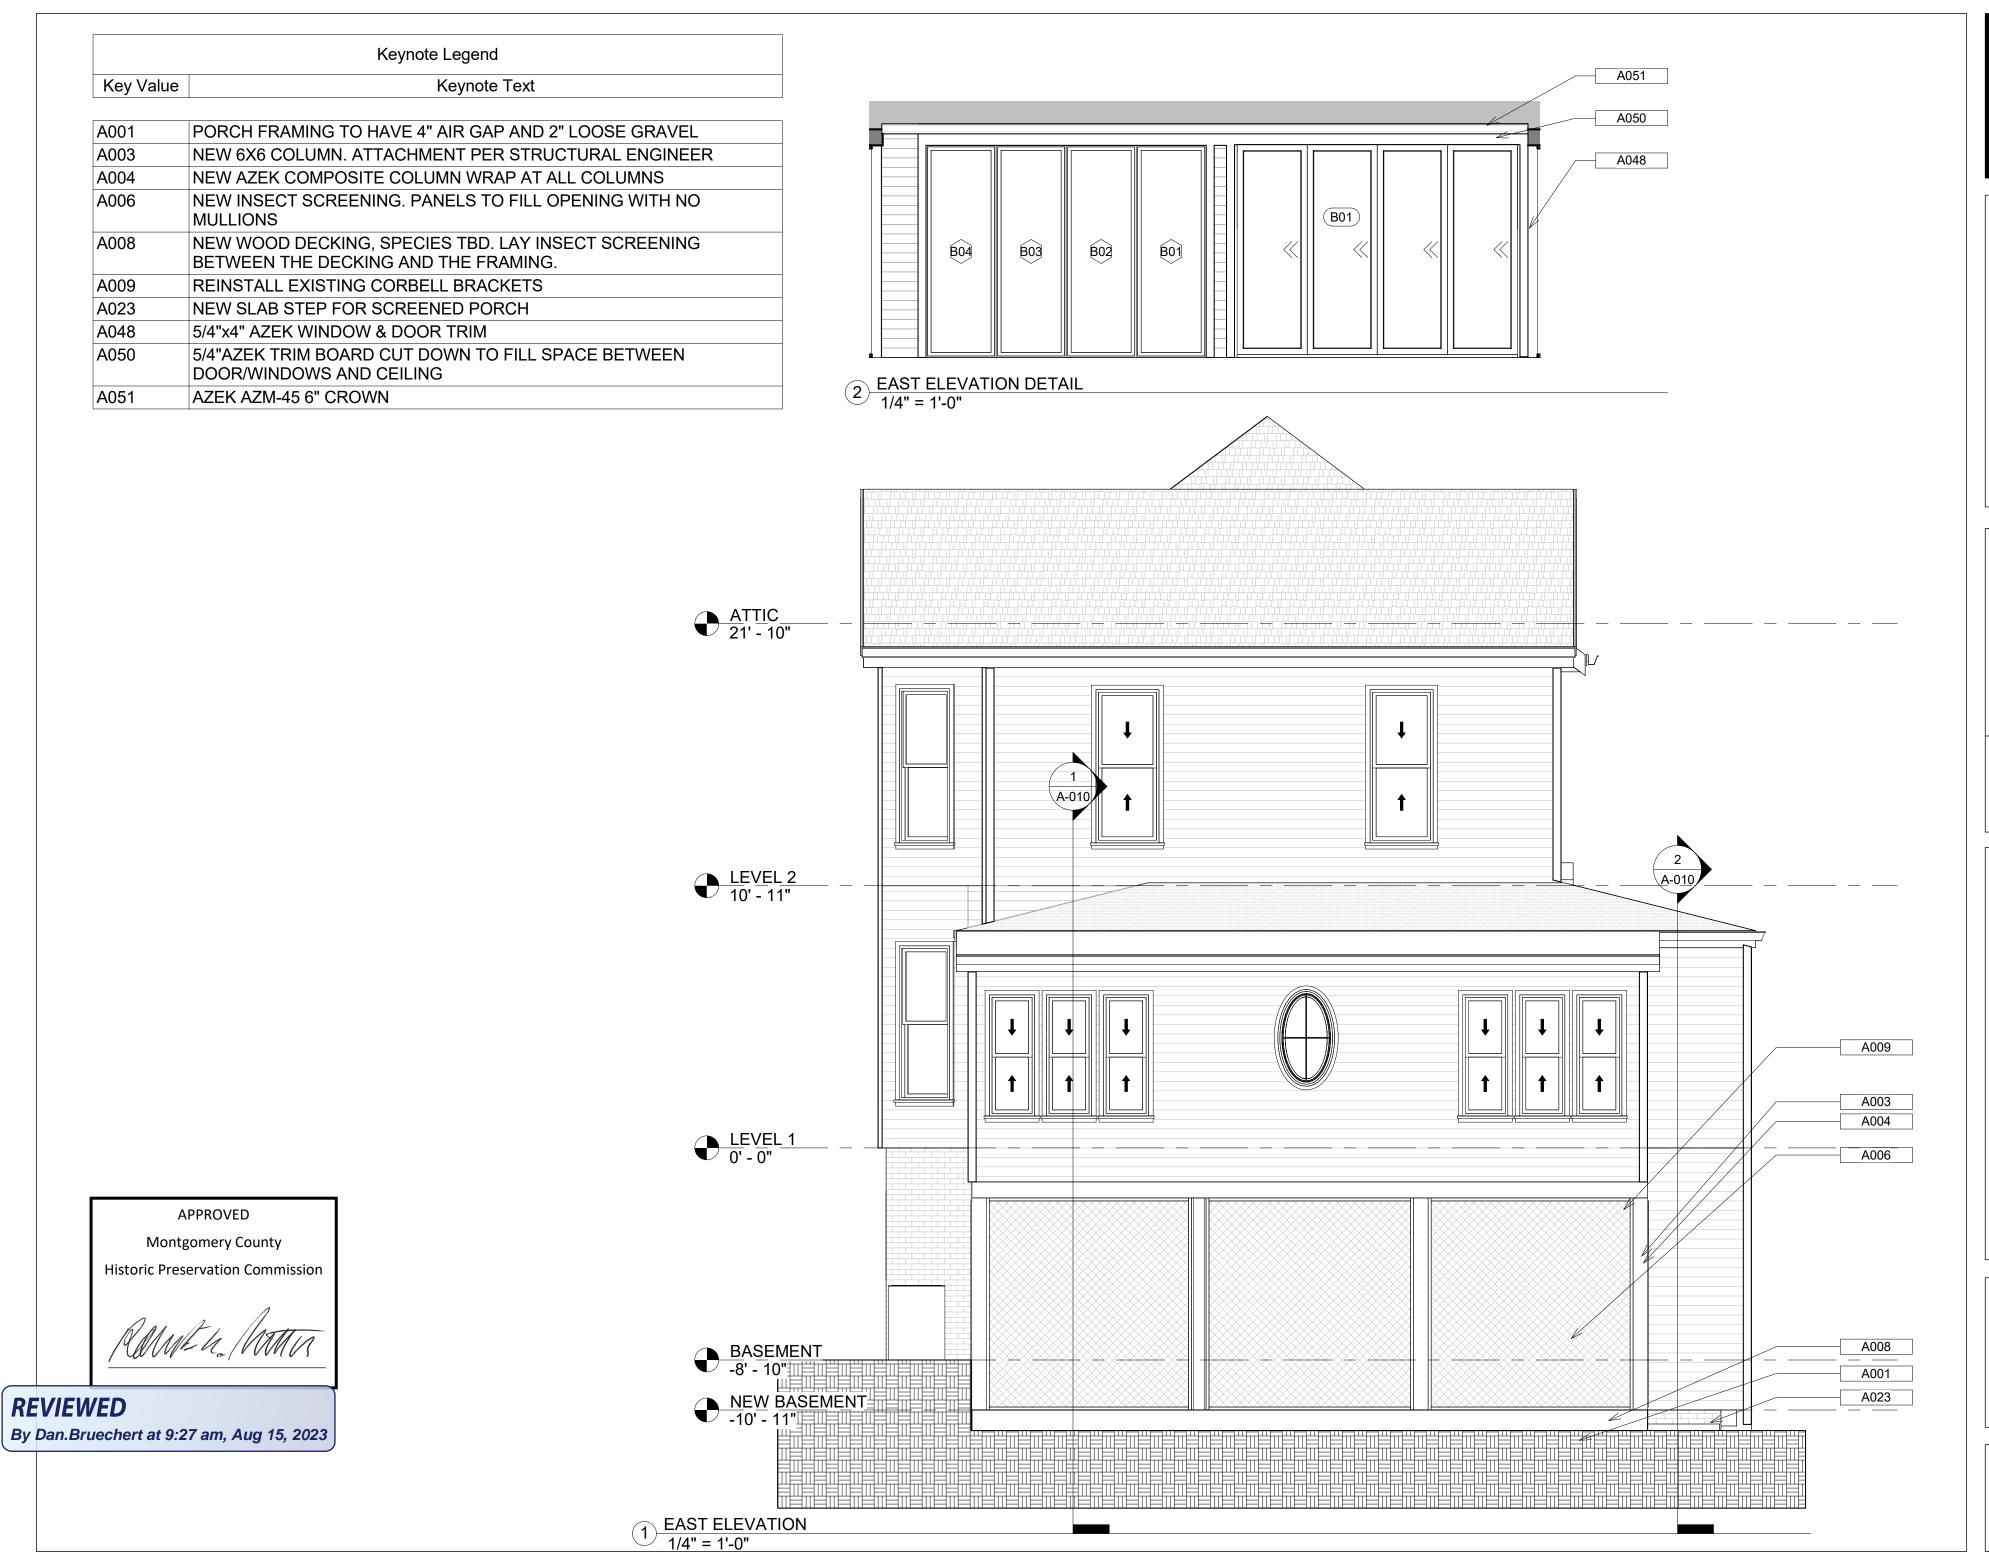PROPOSED **ELEVATION** 

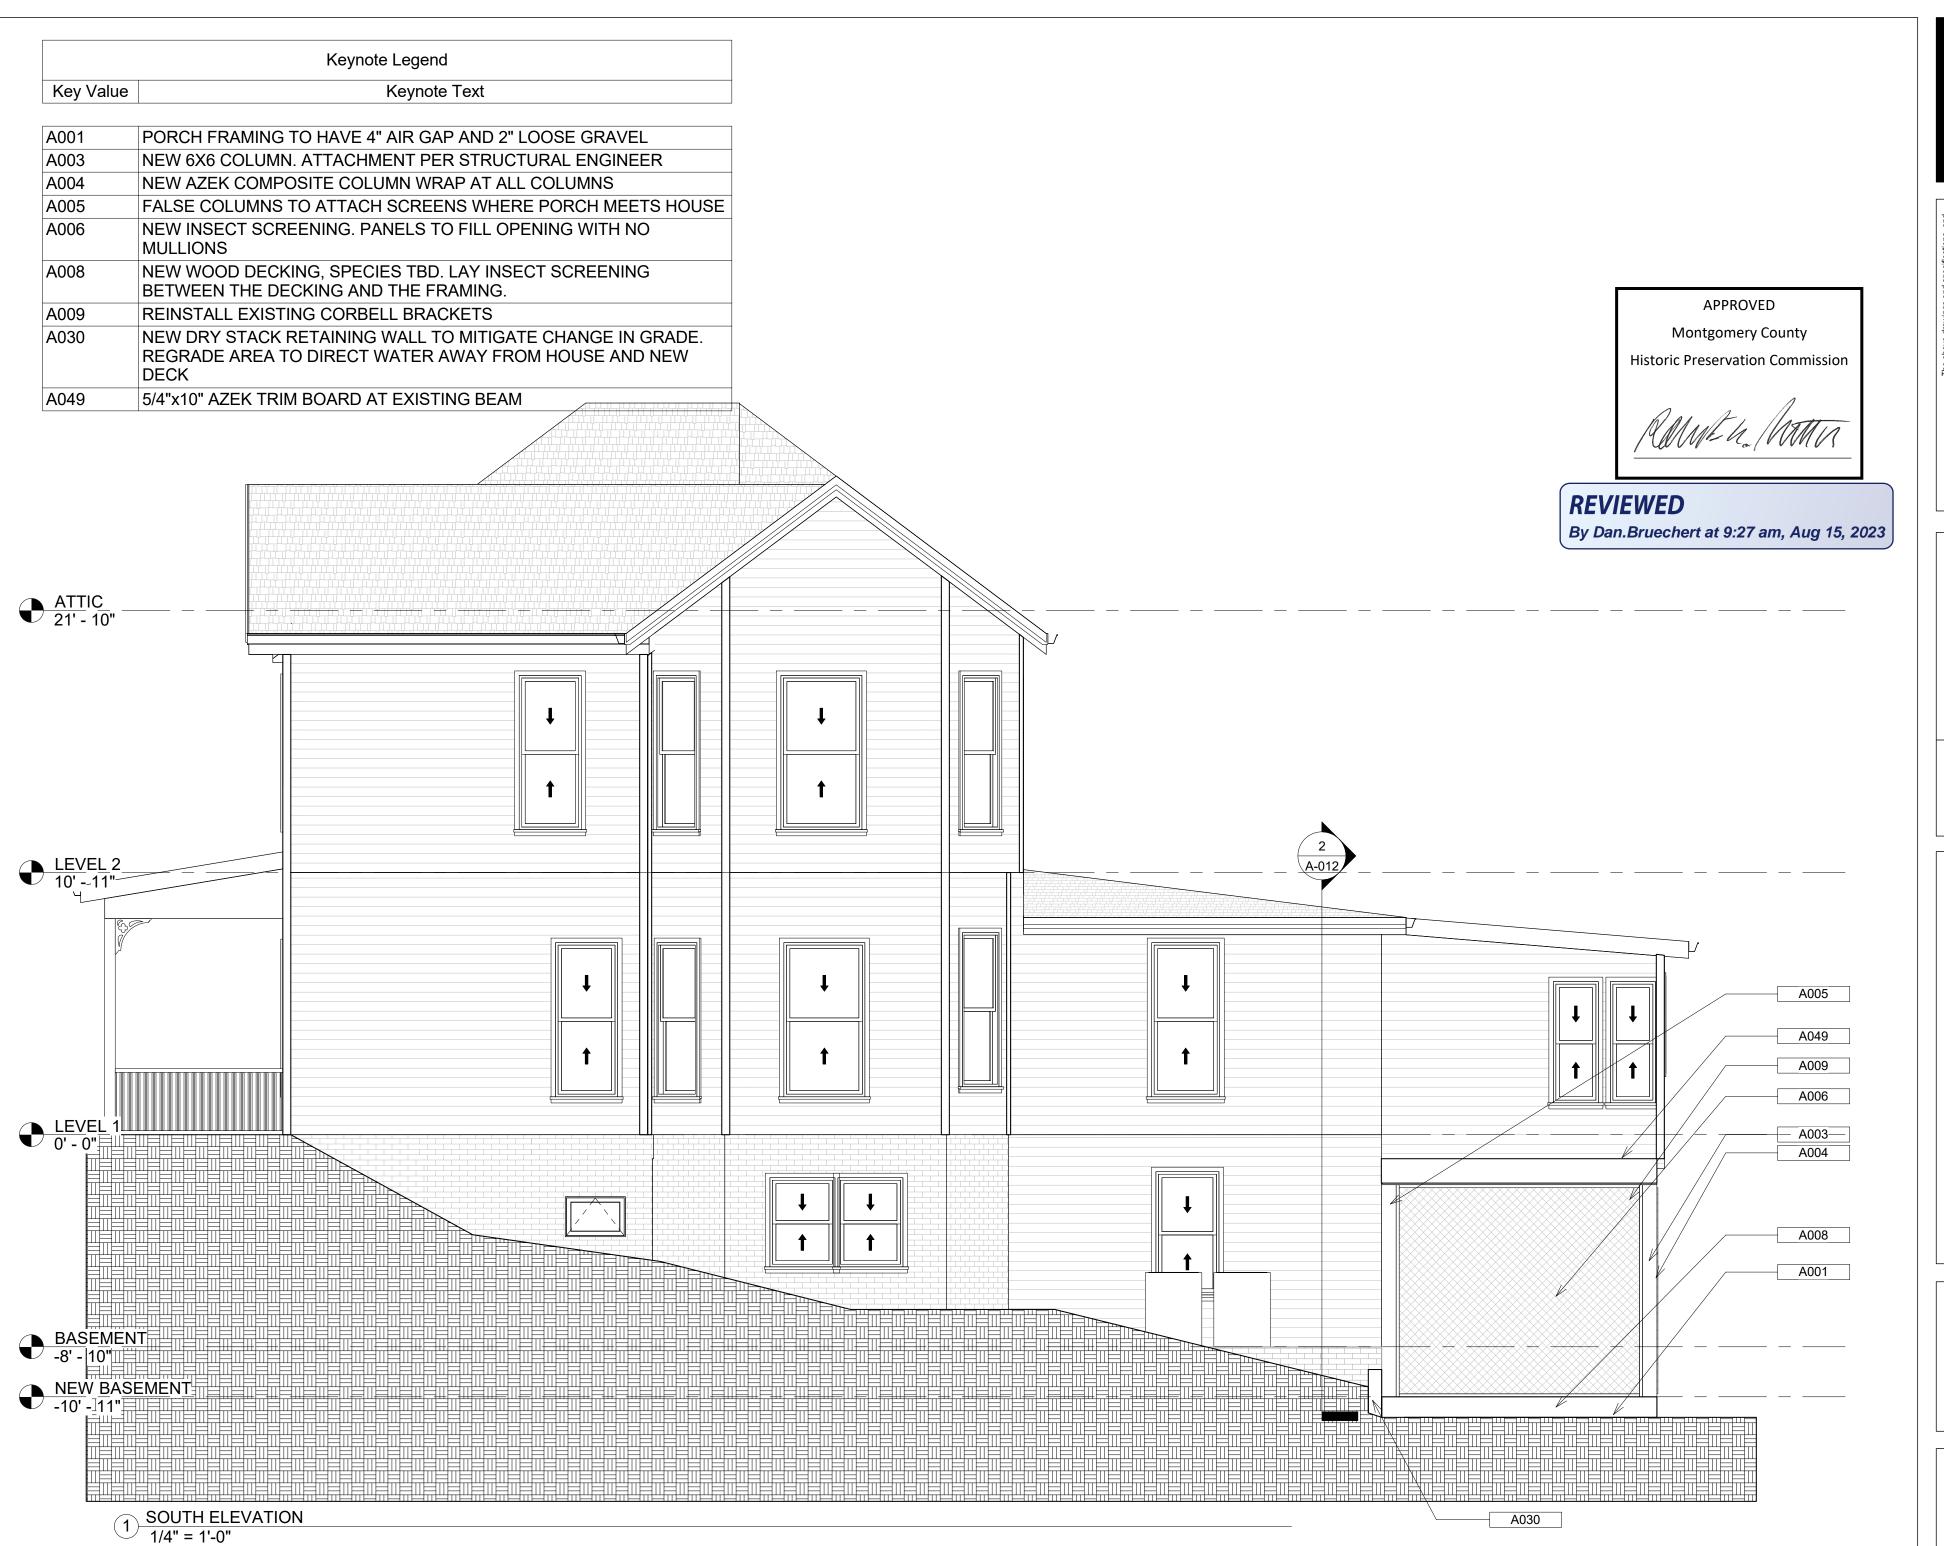



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> MD Park, skin Library Ave, Takoma F 20912 Ra 7209 Holly

**PROPOSED ELEVATION** 

Keynote Legend

Key Value


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By Dan.Bruechert at 9:27 am, Aug 15, 2023



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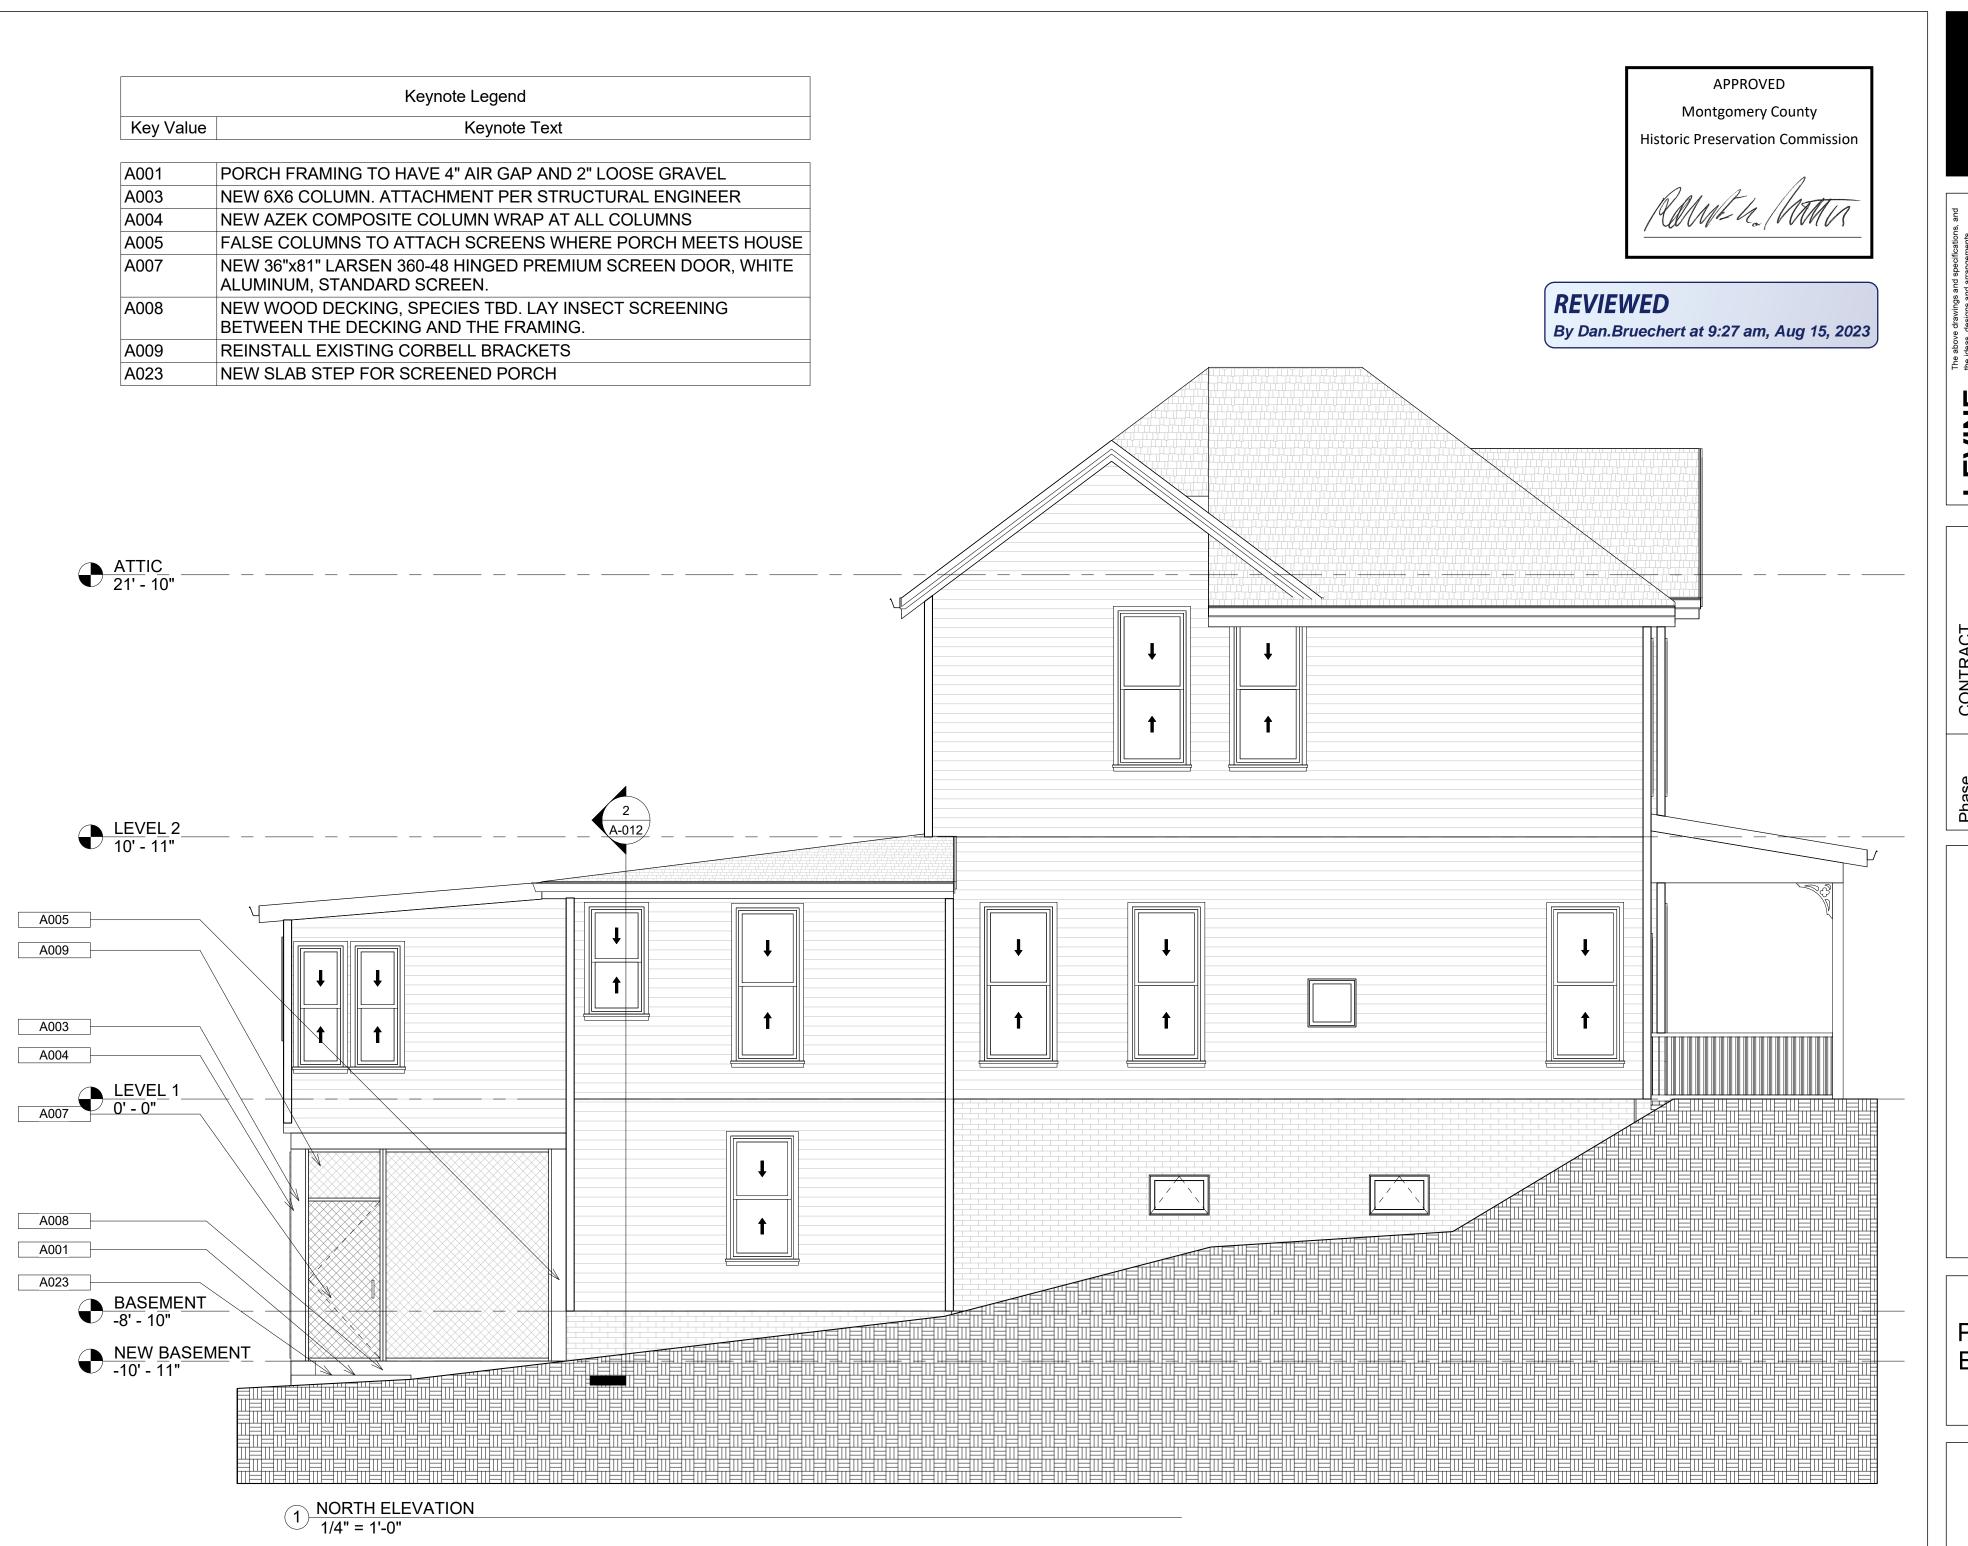
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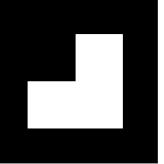
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fax 301.585.4207
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PROPOSED ELEVATION



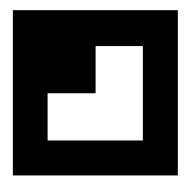


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> MD Ave, Takoma Park, 20912 skin Library Ra **7209 Holly**

PROPOSED **ELEVATION** 

Window Schedule														
Mark	Type Mark	Window Location	Width	Height	Sill Height	Type Comments	Manufacturer	Model	Finish	HARDWARE	U SHG Value C	Egress	Tempered	GRILLS
B01	Α	LIBRARY	2' - 11"	8' - 10"	0' - 0"	FIXED	WEATHERSHEILD	PREMIUM SERIES	WHITE	N/A		No		
B02	Α	LIBRARY	2' - 11"	8' - 10"	0' - 0"	FIXED	WEATHERSHEILD	PREMIUM SERIES				No		
B03	A	LIBRARY	2' - 11"	8' - 10"	0' - 0"	FIXED	WEATHERSHEILD	PREMIUM SERIES				No		
B04	A	LIBRARY	2' - 11"	8' - 10"	0' - 0"	FIXED	WEATHERSHEILD	PREMIUM SERIES				No		



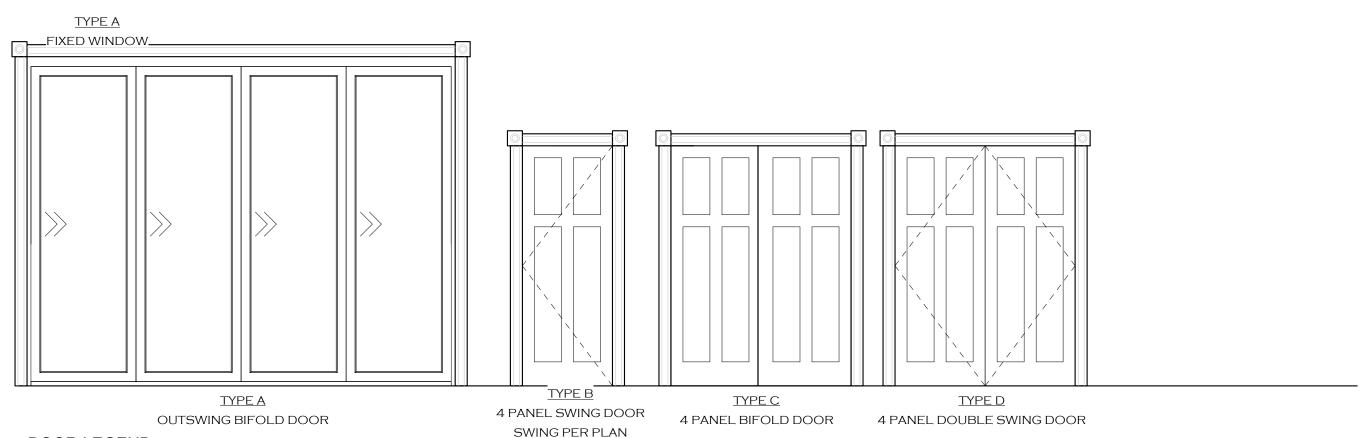


<u>DOOR LEGEND</u> 3/8" = 1'-0"

PER WEATHERSHIELD, THE PREMIUM SERIES DOORS MEET OR EXCEED THE AIR INFILTRATION STANDARD OF >.3CFM/FT2

# CONTEMPORARY BI-FOLD DOOR (8623) Vertical Section - Standard Sill - 3-1/4" Bottom Rail

Door Schedule																	
Mark	Type Mark	Location	Type Comments	Swing	Width	Height	Thickness	Manufacturer	Model	Door Finish	Hardware Manufacturer	Handle Type	Handle Model	Handle Finish	U Factor	SHGC-	Notes
B01	A	LIBRARY	BI-FOLD DOOR	RIGHT OUTSWING	11' - 10 3 21/32"	9' - 1 11/16"	0' - 6 9/16"	Weather Shield Mfg, Inc.	BI-Fold Doors (8618)	UNSTAINED PINE/ WHITE	WEATHERSHEIL D	INTEGRAL	ASHLAND SQUARE	BRIGHT BRASS			
B03	С	HALL	BYPASS DOOR	N/A	5' - 0"	6' - 8"	0' - 1 3/8"	MASONITE	4 PANEL ALTERNATE 4 (C422)	WHITE	EMTEK	DOOR PULL	ROUND FLUSH DOOR PULL 2011US4	SATIN BRASS			SQUARE STICKING
B04	В	BEDROOM	SWING DOOR	LEFT	2' - 8"	6' - 8"	0' - 1 3/8"	MASONITE	4 PANEL ALTERNATE 4 (C422)	WHITE	EMTEK	PRIVACY	WINDSOR KNOB W/ MODERN RECTANGULAR BACKPLATE	SATIN BRASS			SQUARE STICKING
B05	В	BEDROOM	SWING DOOR	LEFT	2' - 8"	6' - 8"	0' - 1 3/8"	MASONITE	4 PANEL ALTERNATE 4 (C422)	WHITE	EMTEK	PRIVACY	WINDSOR KNOB W/ MODERN RECTANGULAR BACKPLATE	SATIN BRASS			SQUARE STICKING
B06	В	BEDROOM	SWING DOOR	N/A	2' - 6"	6' - 8"	0' - 1 3/8"	MASONITE	C55 - 5 EQUAL PANEL	WHITE	EMTEK	DUMMY WITH BALL CATCH	WINDSOR KNOB W/ MODERN RECTANGULAR BACKPLATE	SATIN BRASS			SQUARE STICKING
B07	В	BATHROOM	SWING DOOR	RIGHT	2' - 4"	6' - 8"	0' - 2"	MASONITE	4 PANEL ALTERNATE 4 (C422)	WHITE	EMTEK	PRIVACY	WINDSOR KNOB W/ MODERN RECTANGULAR BACKPLATE	SATIN BRASS			SQUARE STICKING

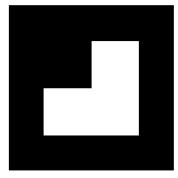

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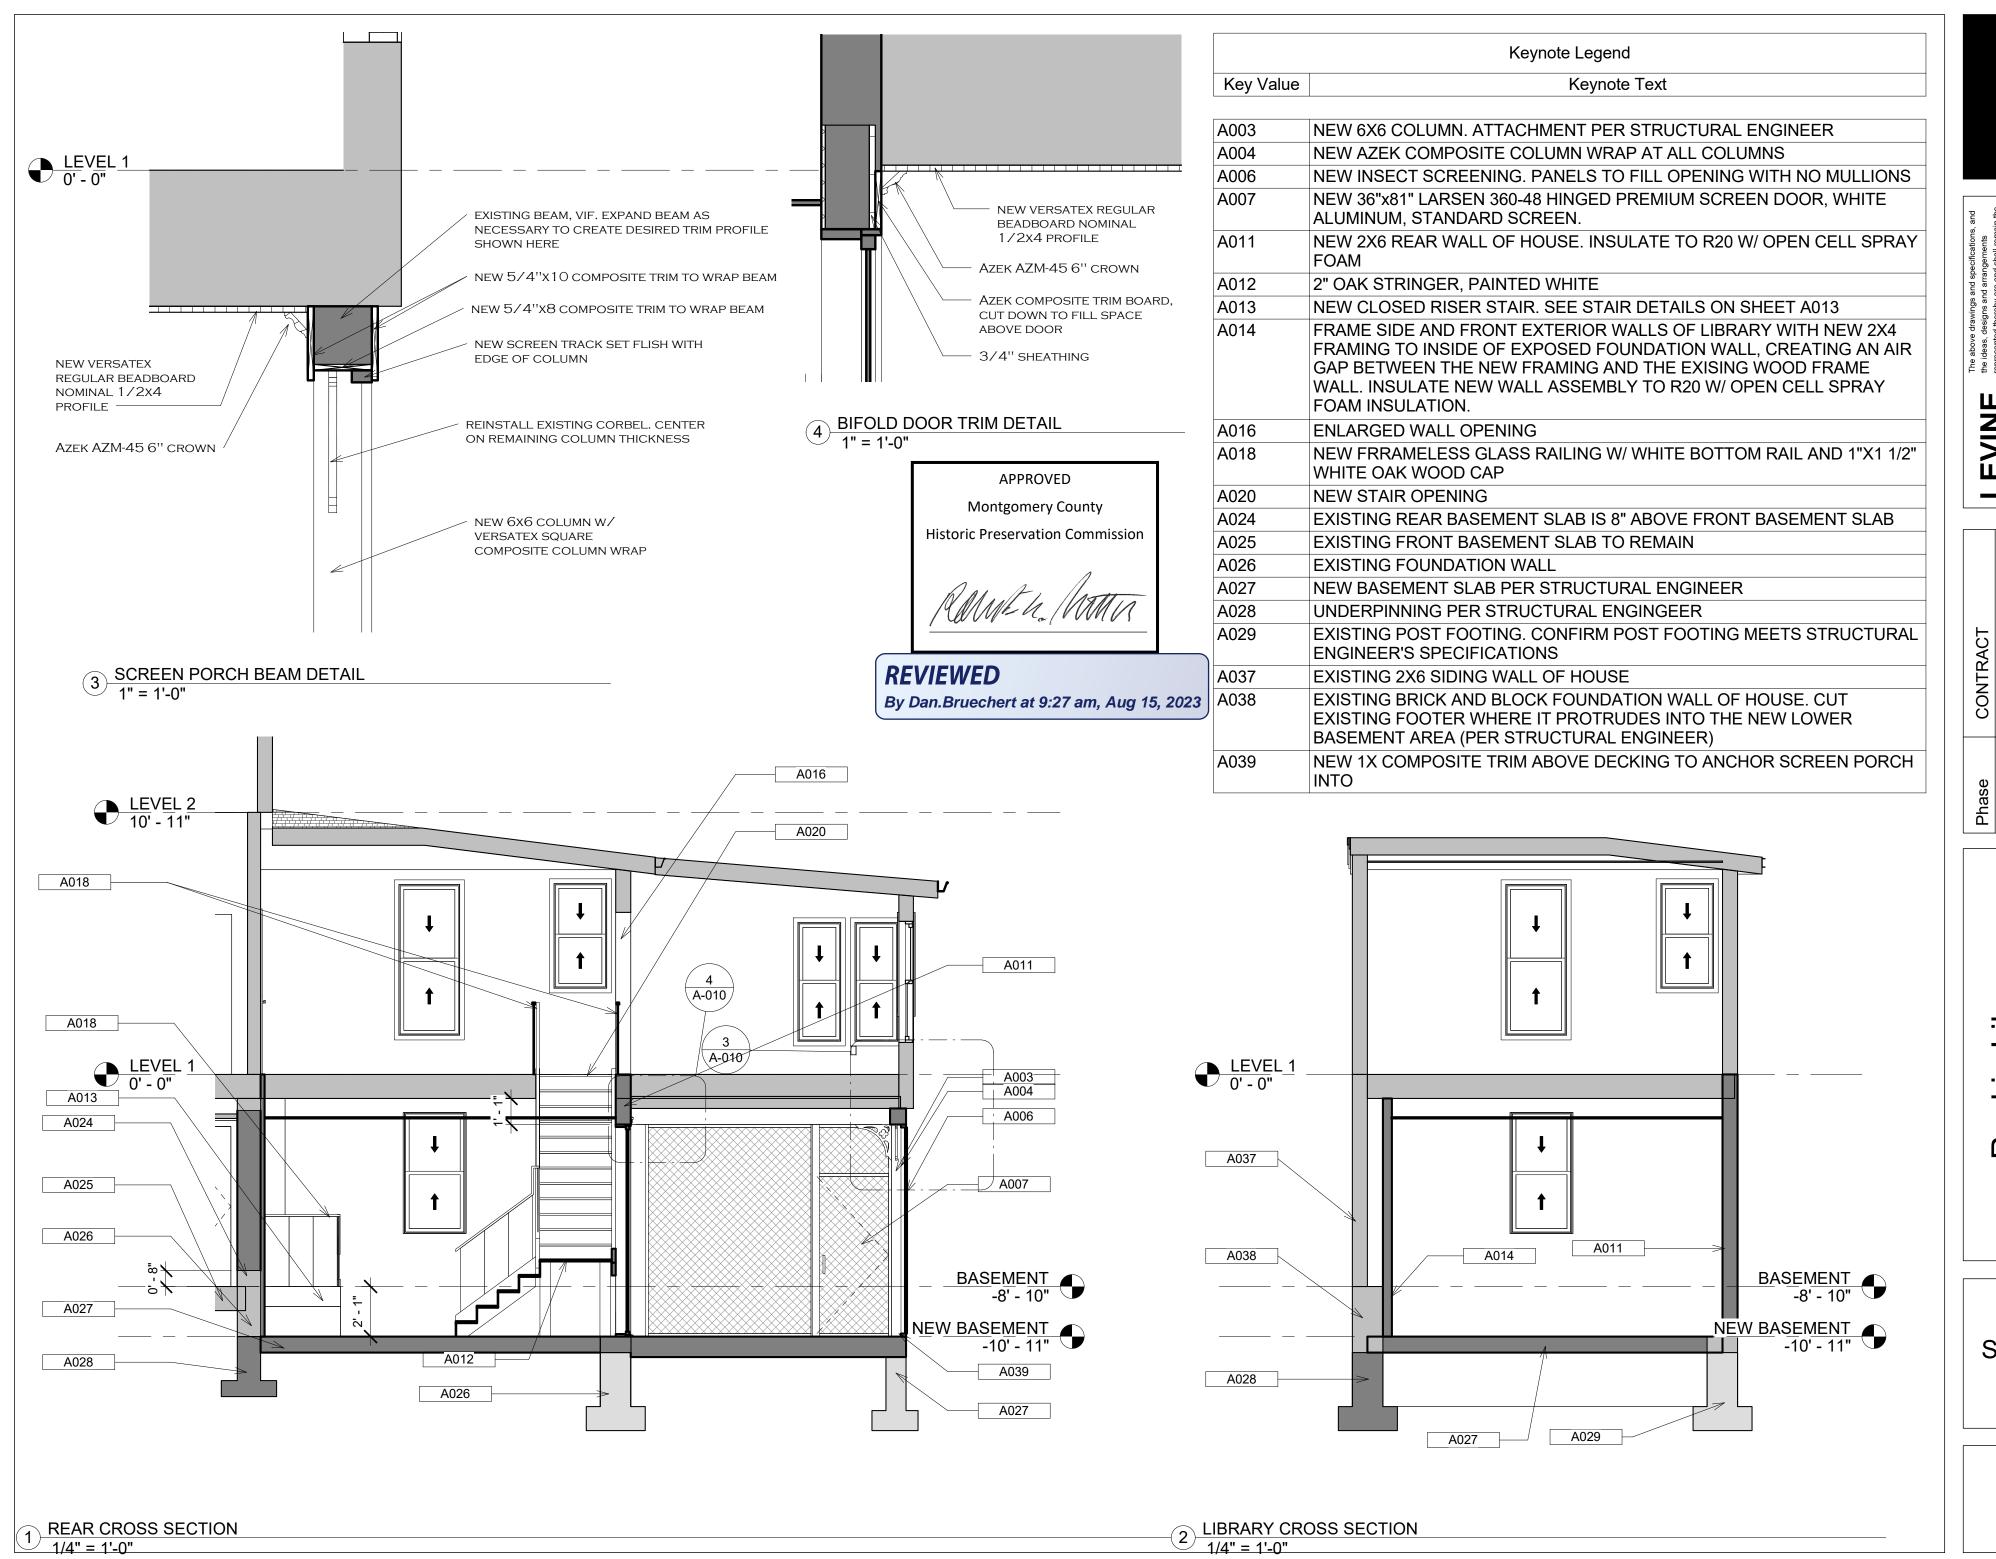
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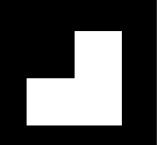
ARCHITECTS + BUILDERS 301.585.4848 fax 301.585.4207 8639B 16th Street Ste 278

Phase	CONTRACT
Date	JULY 24, 2023
Scale	3/8" = 1'-0"
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Revision	

Raskin Library 7209 Holly Ave, Takoma Park, MD 20912

WINDOW AND DOOR SCHEDULE





LEVINE GROUP 24, 2023 As indicated

Author

JULY

B Drawn Scale Date MD ark, Д skin Library , Takoma l 20912 Ave, 20 Ra 209 Holly


**SECTIONS** 


	Keynote Legend						
Key Value Keynote Text							
A014	FRAME SIDE AND FRONT EXTERIOR WALLS OF LIBRARY WITH NEW 2X4 FRAMING TO INSIDE OF EXPOSED FOUNDATION WALL, CREATING AN AIR GAP BETWEEN THE NEW FRAMING AND THE EXISING WOOD FRAME WALL. INSULATE NEW WALL ASSEMBLY TO R20 W/ OPEN CELL SPRAY FOAM INSULATION.						
A016	ENLARGED WALL OPENING						
A017	NEW NOSING AT STAIR OPENING						
A018	NEW FRRAMELESS GLASS RAILING W/ WHITE BOTTOM RAIL AND 1"X1 1/2" WHITE OAK WOOD CAP						
A019	EXISTING FLOOR W/ NEW NOSING TO HOLD RELOCATED RADIATOR AND COVER NEW WALL FURRING BELOW. ALIGN NOSING W/ EDGE OF NEW GWB						
A020	NEW STAIR OPENING						
A026	EXISTING FOUNDATION WALL						
A027	NEW BASEMENT SLAB PER STRUCTURAL ENGINEER						
A028	UNDERPINNING PER STRUCTURAL ENGINGEER						



#### REVIEWED

By Dan.Bruechert at 9:28 am, Aug 15, 2023

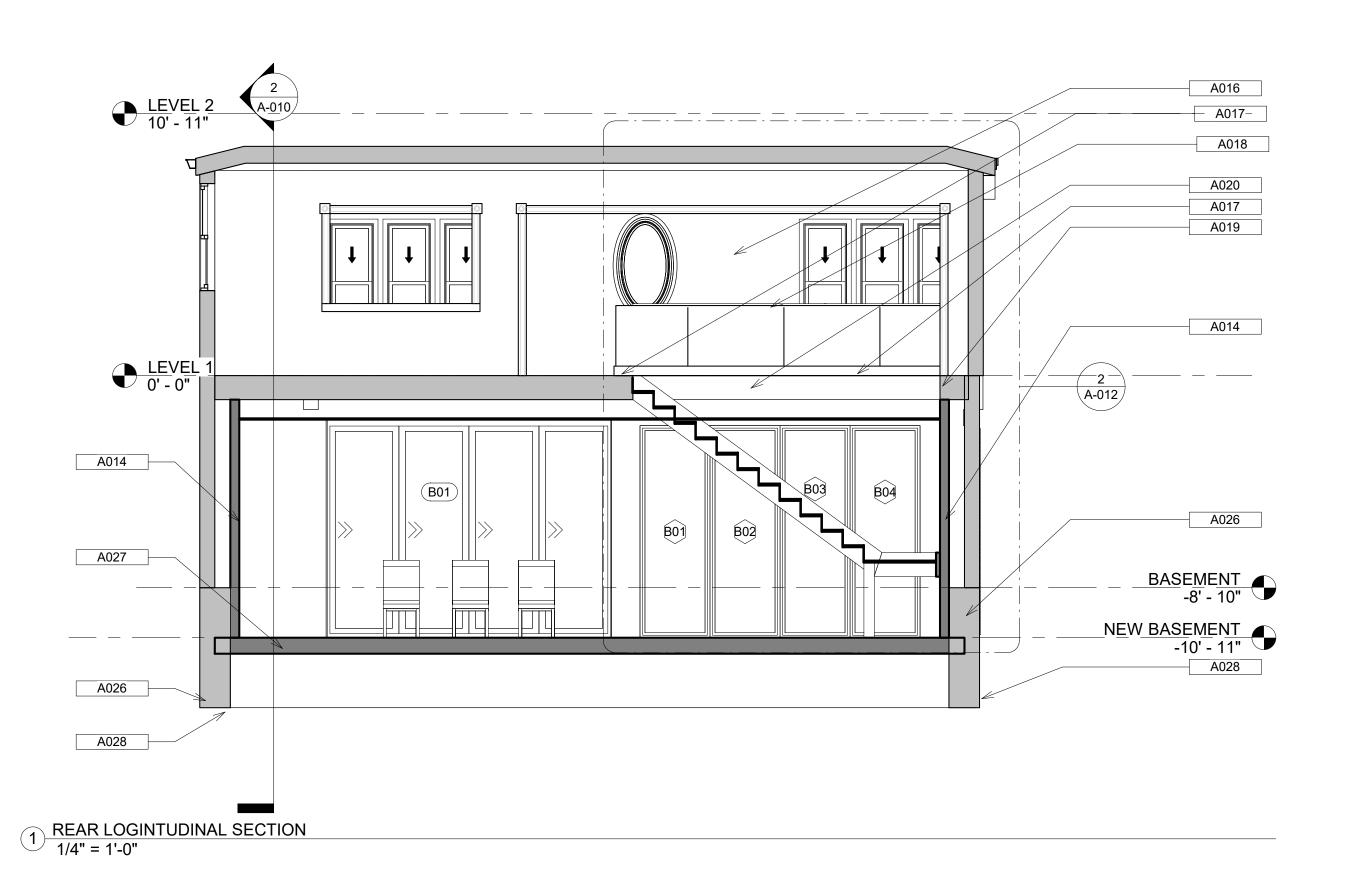


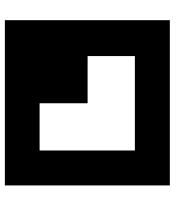


Phase Date Scale Drawn By	CONTRACT	JULY 24, 2023	1/4" = 1'-0"	Author	
	Phase	Date	Scale	Drawn By	Revision

7209 Holly Ave, Takoma Park, MD 20912 skin Library Ra

SECTIONS

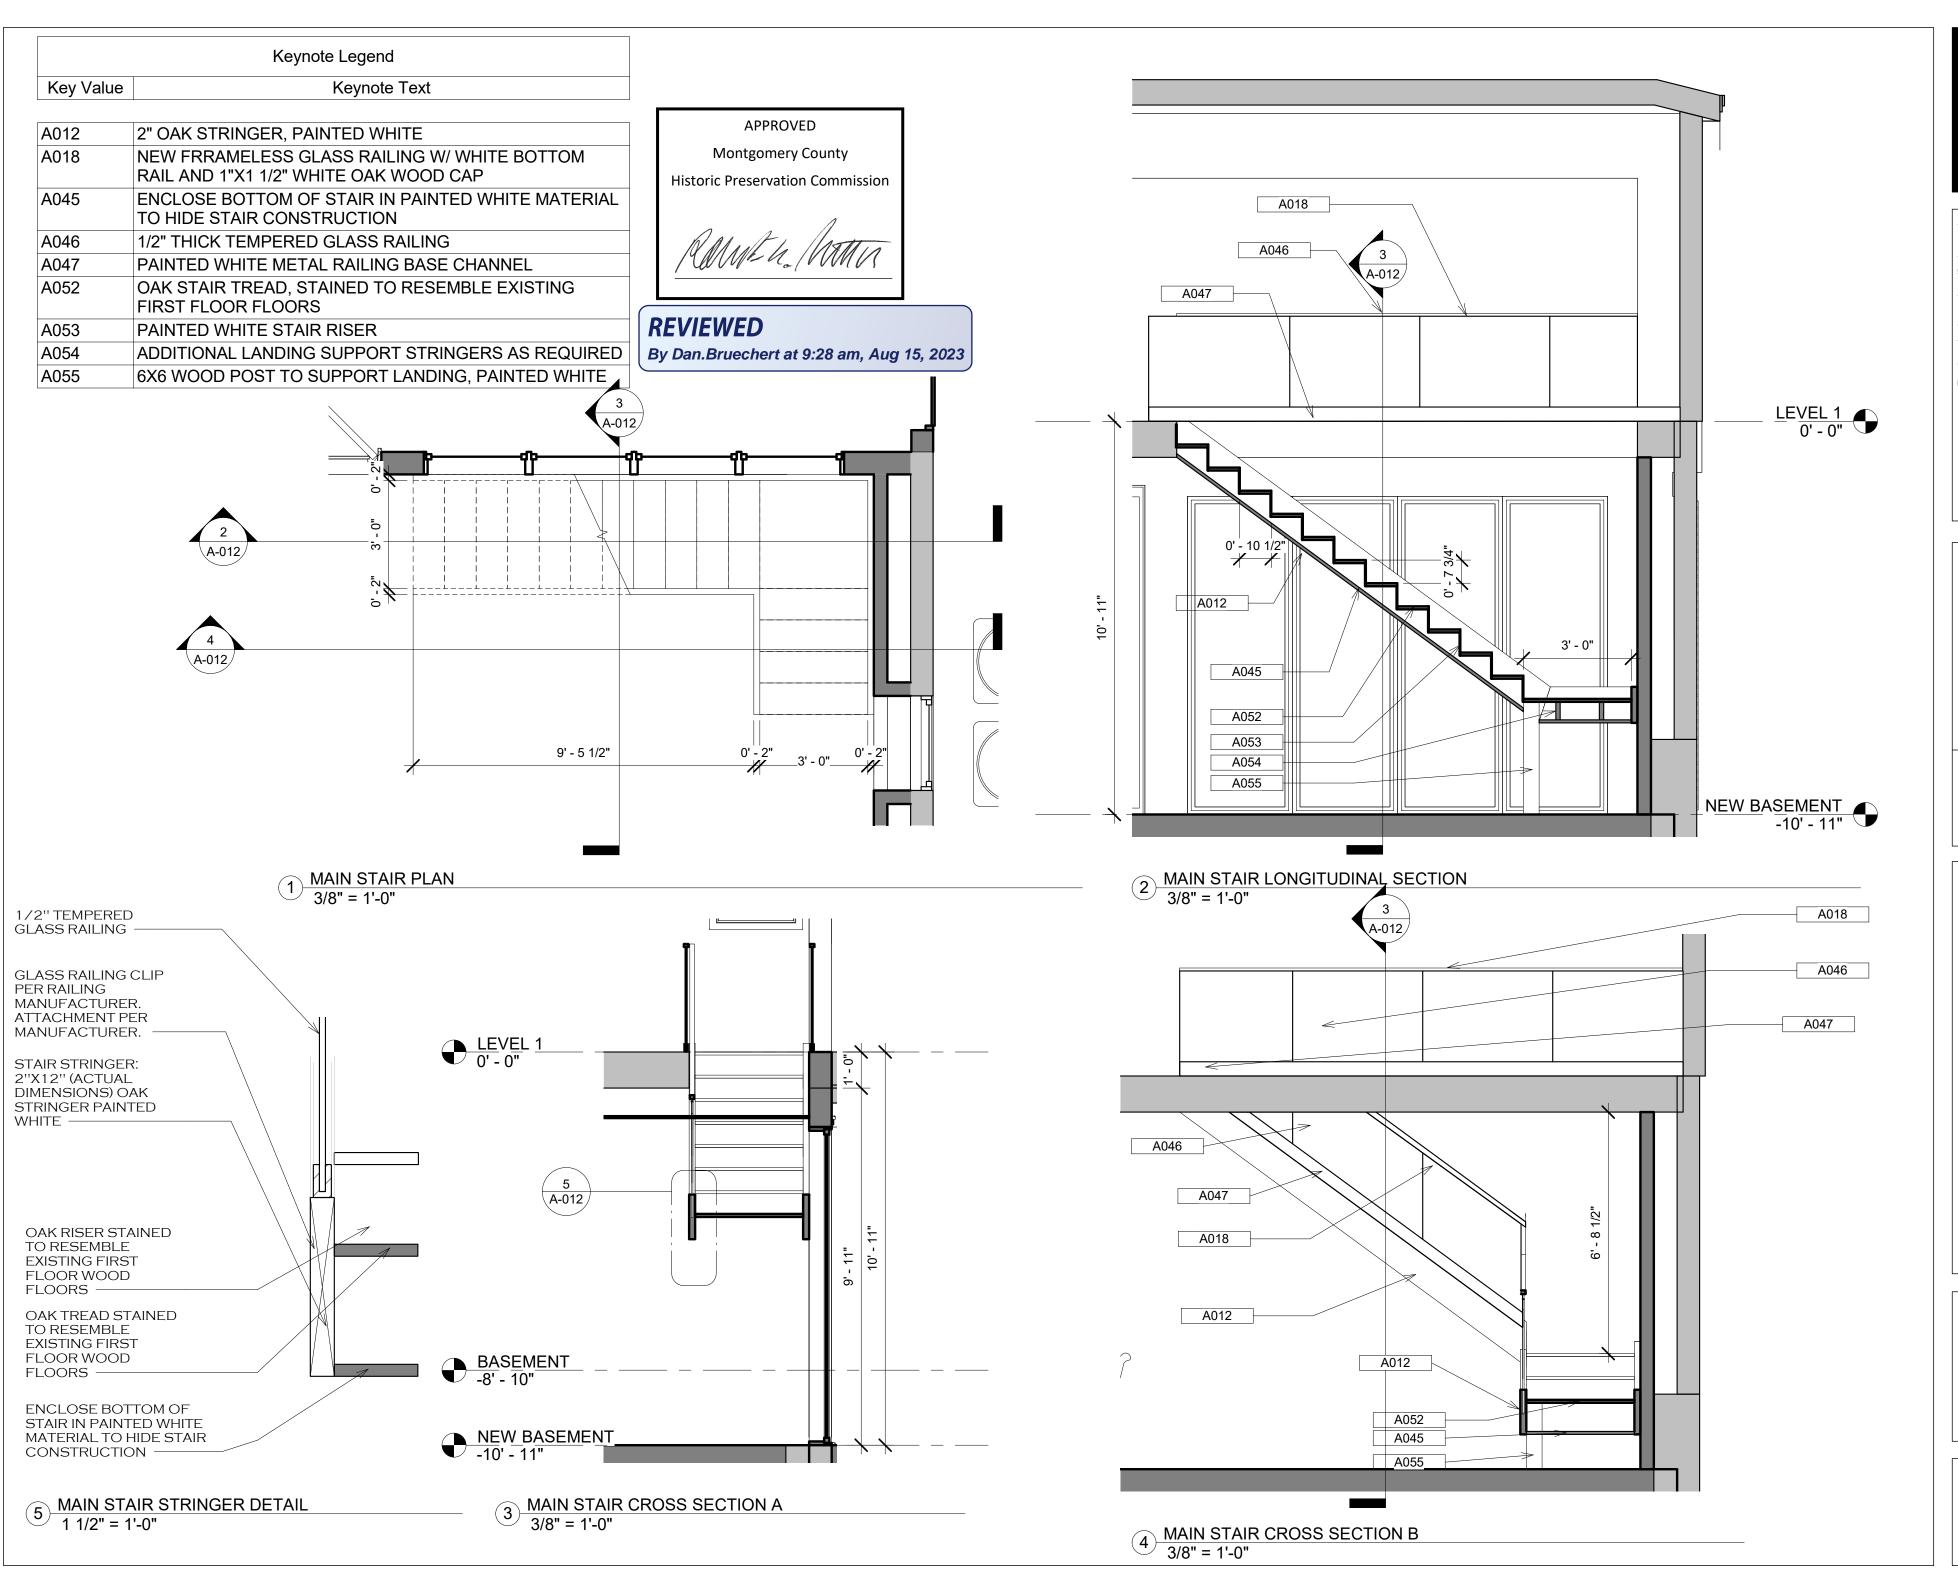

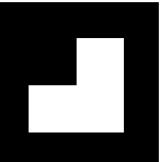


LEVINE GROUP

JULY 24, 2023 CONTRACT As indicated Author Drawn By Scale Date


> MD Park, skin Library Ave, Takoma F 20912 Ra Holly 209

MAIN **STAIR DETAILS** 


Keynote Legend					
Key Value	Keynote Text				
A018	NEW FRRAMELESS GLASS RAILING W/ WHITE BOTTOM RAIL AND 1"X1 1/2" WHITE OAK WOOD CAP				
A040	WHITE OAK STAIR TREAD. STAIN TO MATCH EXISTING FIRST FLOOR HARDWOODS.				
A041	NEW 2X4 WALL FRAMING BELOW LANDING				
A042	NEW 2X8 FRAMED LANDING W/ WHITE OAK FLOORING				
A043	NEW 2" PAINTED STAIR STRINGER				
A044	NEW CARRIAGE STYLE STAIR SUPPORT				
A045	ENCLOSE BOTTOM OF STAIR IN PAINTED WHITE MATERIAL TO HIDE STAIR CONSTRUCTION				
A046	1/2" THICK TEMPERED GLASS RAILING				
A047	PAINTED WHITE METAL RAILING BASE CHANNEL				

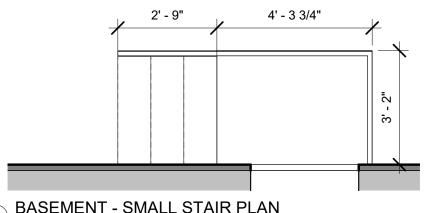


1 BASEMENT - SMALL STAIR PLAN 3/8" = 1'-0"

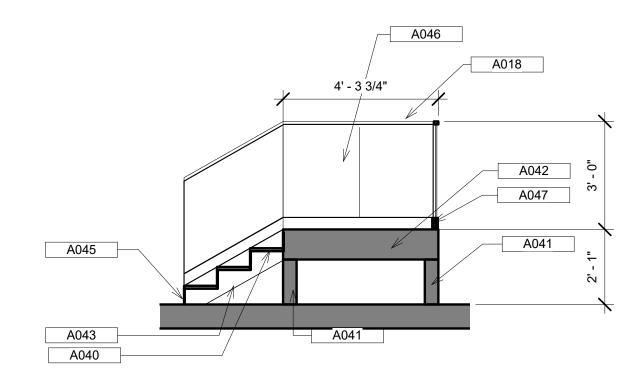

2 SMALL STAIR LONGITUDINAL SECTION 3/8" = 1'-0"

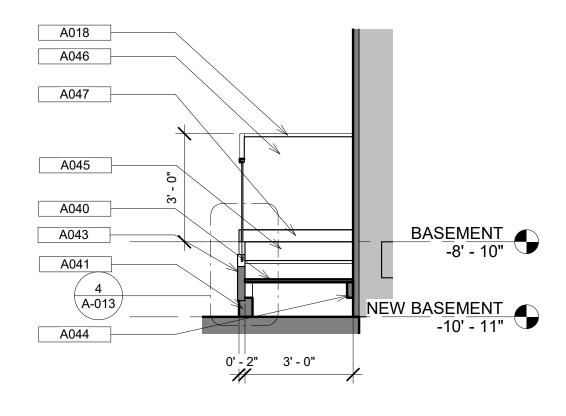

3 SMALL STAIR CORSS SECTION 3/8" = 1'-0"

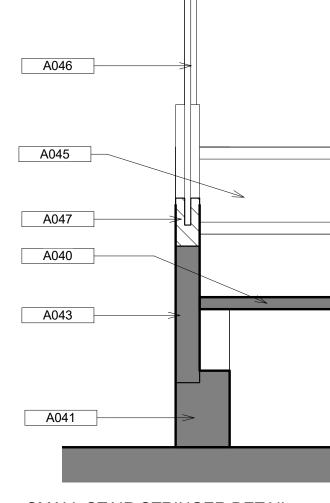

4 SMALL STAIR STRINGER DETAIL 1 1/2" = 1'-0"



REVIEWED

By Dan.Bruechert at 9:28 am, Aug 15, 2023

he above drawings and specifications, and he ideas, designs and arrangements epresented thereby are and shall remain the roperty of the architect. No part thereof shall so copied, disclosed to others or used in connection with any work or project or by any wher person for any purpose other than for he specific project for which they have been

Phase	CONTRACT
Date	JULY 24, 2023
Scale	As indicated
Drawn By	Author
Revision	

Raskin Library 7209 Holly Ave, Takoma Park, MD 20912

> SMALL STAIR DETAIL

	Room Finish Schedule					
Room and Room Number	Location	Material	Manufacturer	ltem/Model #	Finish:	Comments:
	Floor	LVP	Matthews and Parlo	LXP100	LP01	
	Base	Pine	TW Perry	VMM-618P	Semi-gloss, color tbd	Confirm style resembles existing molding
	Shoe	Oak	Flooring subcontractor	N/A	Stain to resemble floors	
	North Wall	New 1	/2" drywall on new p	artitions	Matte, color tbd	
LIBRARY	East Wall	New 1	/2" drywall on new pa	artitions	Matte, color tbd	
	South Wall	New 1	/2" drywall on new pa	artitions	Matte, color tbd	
	West Wall	New 1	/2" drywall on new pa	artitions	Matte, color tbd	
	Ceiling		New 1/2" drywall		Matte, ceiling white	
	Door Casing	Pine	TW Perry	SM-7	Semi-gloss, color tbd	Confirm style resembles existing molding
	Plinth	Pine	TW Perry	Custom	Semi-gloss, color	Custom plinth to resemble existing
	Rosette	Pine	TW Perry	SM-20	Semi-gloss, color	Confirm style resembles existing molding
	Window Casing	Pine	TW Perry	SM-7	Semi-gloss, color	Confirm style resembles existing molding
	Window Stool	Pine	TW Perry	WM-121	Semi-gloss, color	Confirm style resembles existing molding
	Floor	Tile	Mosaic Tile Co			See I-003 for details
BATHROOM	Base	Pine	TW Perry	WM-618P	Semi-gloss, color	Confirm style resembles existing molding
	Shoe	N/A	N/A	N/A	N/A	morang
	North Wall	New drywall on new partitions, new tile per I-003			Matte, color TBD	See I-003 for details
	East Wall	New 1/2" drywal on new partitions			Matte, color tbd	
	South Wall	New drywall on new partitions, new tile per I-003			Matte, color tbd	
	West Wall	New tile per I-003			See I-003	See I-003 for details
	Ceiling		New 1/2" drywall		Matte, ceiling white	
	Door Casing	Pine	TW Perry	SM-7	Semi-gloss, color	Confirm style resembles existing molding
	Plinth	Pine	TW Perry	Custom	Semi-gloss, color	
	Rosette	Pine	TW Perry	SM-20	Semi-gloss, color	Confirm style resembles existing molding
	Window Casing	Pine	TW Perry	SM-7	Semi-gloss, color	
	Window Stool	Pine	TW Perry	WM-121	Semi-gloss, color	Confirm style resembles existing molding
	Floor	LVP	Matthews and Parlo	LXP100	LP01	moung
HALL	Base	Pine	TW Perry	WM-618P	Semi-gloss, color	
	Shoe	Oak	Flooring	N/A	tbd Stain to resemble	molding
	North Wall	New 1/2" drywall on new partitions			floors  Matte, color tbd	
	East Wall	New 1/2" drywall on new partitions			Matte, color tbd	
	South Wall	New 1/2" drywall on new partitions			Matte, color tbd	
	West Wall				Matte, color tbd	
	Ceiling	New 1/2" drywall on new partitions  New 1/2" drywall			Matte, ceiling	
	Door Casing	Pine	TW Perry	SM-7	white Semi-gloss, color	Confirm style resembles existing
	Plinth	Pine	TW Perry	Custom	tbd Semi-gloss, color	molding  Custom plinth to resemble existing
	Rosette	Pine	TW Perry	SM-20	tbd Semi-gloss, color	Confirm style resembles existing
	Window Casing	Pine	TW Perry	SM-7	tbd Semi-gloss, color	molding Confirm style resembles existing
		100 to 27 00 gg/s			tbd Semi-gloss, color	molding  Confirm style resembles existing
	Window Stool	Pine	TW Perry	WM-121	tbd	molding

GUEST BEDROOM  GUEST BEDROOM  Ce  Door  Pi  Ro  Windo  Windo  STORAGE ROOM  Ce  Door	Base Shoe th Wall st Wall with Wall eiling r Casing Plinth posette bw Casing low Stool Floor Base Shoe th Wall st Wall with Wall st Wall eiling	New 1/ New 1/ New 1/ Pine Pine Pine Pine Pine Pine Pine Pine	Matthews and Parlo  TW Perry  Flooring subcontractor  /2" drywall on new p  /2" drywall on new p  /2" drywall on new p  New 1/2" drywall  TW Perry  TW Perry	artitions	LP01  Semi-gloss, color tbd  Stain to resemble floors  Matte, color tbd  Semi-gloss, color tbd	Confirm style resembles existing molding  Confirm style resembles existing molding  Custom plinth to resemble existing molding  Confirm style resembles existing molding  Confirm style resembles existing molding  Confirm style resembles existing molding  Paint using concrete paint
GUEST BEDROOM  GUEST BEDROOM  West Cast Door Plants of the property of the pro	Shoe th Wall st Wall uth Wall eiling r Casing Plinth posette ow Casing low Stool Floor Base Shoe th Wall st Wall uth Wall st Wall	Oak  New 1/  New 1/  New 1/  Pine  N/A	Flooring subcontractor  /2" drywall on new p  New 1/2" drywall  TW Perry	N/A artitions artitions artitions artitions  SM-7 Custom SM-20 SM-7 WM-121	tbd  Stain to resemble floors  Matte, color tbd  Matte, ceiling white  Semi-gloss, color tbd  Matte, color TbD	Confirm style resembles existing molding  Custom plinth to resemble existing molding  Confirm style resembles existing molding  Confirm style resembles existing molding  Confirm style resembles existing molding
GUEST BEDROOM  GUEST BEDROOM  Wes  Ce  Door  Pi  Ro  Windo  Windo  STORAGE ROOM  STORAGE ROOM  Ce  Door	th Wall st Wall uth Wall eiling r Casing Plinth osette ow Casing low Stool Floor Base Shoe th Wall st Wall uth Wall st Wall	New 1/ New 1/ New 1/ New 1/ Pine Pine Pine Pine Pine Pine Pine Pine	subcontractor  /2" drywall on new p  New 1/2" drywall  TW Perry	artitions artitions artitions artitions artitions  SM-7  Custom  SM-20  SM-7  VWM-121	floors  Matte, color tbd  Matte, color tbd  Matte, color tbd  Matte, color tbd  Matte, ceiling white  Semi-gloss, color tbd  Matte, color tbd  Matte, color TBD	molding  Custom plinth to resemble existing  Confirm style resembles existing molding  Confirm style resembles existing molding  Confirm style resembles existing molding  molding
GUEST BEDROOM  West Ce Door Pi Ro Windo Windo  STORAGE ROOM  Eas Sout  STORAGE ROOM  Ce Door	st Wall with Wall eiling r Casing Plinth posette ow Casing ow Stool Floor Base Shoe th Wall st Wall with Wall set Wall	New 1/ New 1/ New 1/ Pine Pine Pine Pine Pine Pine Pine Pine	/2" drywall on new p New 1/2" drywall TW Perry	artitions artitions artitions  SM-7 Custom SM-20 SM-7 WM-121	Matte, color tbd  Matte, color tbd  Matte, color tbd  Matte, color tbd  Matte, ceiling white  Semi-gloss, color tbd  Matte, color TbD	molding  Custom plinth to resemble existing  Confirm style resembles existing molding  Confirm style resembles existing molding  Confirm style resembles existing molding  molding
GUEST BEDROOM  Wes  Ce  Door  Pi  Ro  Window  Window  STORAGE ROOM  STORAGE ROOM  Ce  Door	ath Wall eiling r Casing Plinth posette by Casing low Stool Floor Base Shoe th Wall st Wall ath Wall	New 1/ New 1/  Pine Pine Pine Pine Pine Pine Pine And Concrete Pine N/A	/2" drywall on new p /2" drywall on new p New 1/2" drywall TW Perry	artitions  SM-7  Custom  SM-20  SM-7  WM-121	Matte, color tbd  Matte, color tbd  Matte, ceiling white  Semi-gloss, color tbd  Matte, color TBD	molding  Custom plinth to resemble existing  Confirm style resembles existing molding  Confirm style resembles existing molding  Confirm style resembles existing molding  molding
BEDROOM  West Ce Door Pi Ro Windo Windo  Windo  STORAGE ROOM  Ce Door	est Wall eiling r Casing Plinth posette ow Casing low Stool Floor Base Shoe th Wall st Wall eith Wall	Pine Pine Pine Pine Pine Pine Pine N/A	72" drywall on new p New 1/2" drywall TW Perry TW Perry TW Perry TW Perry TW Perry TW Perry	SM-7 Custom SM-20 SM-7 WM-121	Matte, color tbd  Matte, ceiling white  Semi-gloss, color tbd  Matte, color TBD	molding  Custom plinth to resemble existing  Confirm style resembles existing  molding  Confirm style resembles existing  molding  Confirm style resembles existing  molding
BEDROOM  West Ce Door Pi Ro Windo Windo  Windo  STORAGE ROOM  Ce Door	eiling r Casing Plinth posette ow Casing low Stool Floor Base Shoe th Wall st Wall st Wall	Pine Pine Pine Pine Pine Pine Pine N/A	72" drywall on new p New 1/2" drywall TW Perry TW Perry TW Perry TW Perry TW Perry TW Perry	SM-7 Custom SM-20 SM-7 WM-121	Matte, ceiling white Semi-gloss, color tbd Matte, color TBD	molding  Custom plinth to resemble existing  Confirm style resembles existing  molding  Confirm style resembles existing  molding  Confirm style resembles existing  molding
Ce Door Pi Ro Windo Windo Windo  STORAGE ROOM  Ce Door	eiling r Casing Plinth posette ow Casing low Stool Floor Base Shoe th Wall st Wall st Wall	Pine Pine Pine Pine Pine Pine Pine  Existing concrete Pine N/A	New 1/2" drywall TW Perry TW Perry TW Perry TW Perry TW Perry TW Perry	SM-7 Custom SM-20 SM-7 VWM-121	Matte, ceiling white Semi-gloss, color tbd Matte, color TBD	molding  Custom plinth to resemble existing  Confirm style resembles existing  molding  Confirm style resembles existing  molding  Confirm style resembles existing  molding
Door Pi Ro Windo Windo  Windo  STORAGE ROOM  Ce Door	Plinth  posette  pw Casing  low Stool  Floor  Base  Shoe  th Wall  st Wall  st Wall	Pine Pine Pine Existing concrete Pine	TW Perry TW Perry TW Perry TW Perry TW Perry TW Perry	Custom  SM-20  SM-7  WM-121  WM-618P	Semi-gloss, color tbd Matte, color TBD	molding  Custom plinth to resemble existing  Confirm style resembles existing  molding  Confirm style resembles existing  molding  Confirm style resembles existing  molding
Pi Ro Window Window Window Window  Window  Window  Fi  B  S  Nort  Eas  Soul  STORAGE ROOM  Ce  Door	Plinth  posette  pw Casing  low Stool  Floor  Base  Shoe  th Wall  st Wall  st Wall	Pine Pine Pine Existing concrete Pine	TW Perry TW Perry TW Perry TW Perry  TW Perry	Custom  SM-20  SM-7  WM-121  WM-618P	Semi-gloss, color tbd Semi-gloss, color tbd Semi-gloss, color tbd Semi-gloss, color tbd Matte, color TBD	Custom plinth to resemble existing Confirm style resembles existing molding Confirm style resembles existing molding Confirm style resembles existing molding
STORAGE ROOM  STORAGE ROOM  Ce Door	osette  ow Casing  low Stool  Floor  Base  Shoe  th Wall  st Wall  st Wall	Pine Pine Existing concrete Pine N/A	TW Perry TW Perry TW Perry  TW Perry	SM-20 SM-7 WM-121	Semi-gloss, color tbd Semi-gloss, color tbd Semi-gloss, color tbd Matte, color TBD	Confirm style resembles existing molding  Confirm style resembles existing molding  Confirm style resembles existing molding
Windo Windo Windo Windo Fi  B  S  Nort  Eas Sout STORAGE ROOM Ce Door	ow Casing  low Stool  Floor  Base  Shoe  th Wall  st Wall  st Wall	Pine Pine Existing concrete Pine N/A	TW Perry  TW Perry  TW Perry	SM-7 WM-121 WM-618P	Semi-gloss, color tbd Semi-gloss, color tbd Matte, color TBD	molding  Confirm style resembles existing molding  Confirm style resembles existing molding
Windo Windo Fi  B  S  Nort  Eas  Soul  STORAGE ROOM Ce  Door	low Stool Floor Base Shoe th Wall st Wall st Wall	Pine Existing concrete Pine N/A	TW Perry TW Perry N/A	WM-121 WM-618P	Semi-gloss, color tbd  Matte, color TBD	molding  Confirm style resembles existing molding
STORAGE ROOM  Ce Door	Floor  Base  Shoe  th Wall  st Wall  st Wall	Existing concrete Pine N/A	TW Perry	VVIVI-618P	tbd Matte, color TBD	molding
STORAGE ROOM  Ce  Door	Base Shoe th Wall st Wall uth Wall	Pine N/A	N/A			Paint using concrete paint
STORAGE ROOM  Ce Door	Shoe  th Wall  st Wall  ith Wall	N/A	N/A			TOTAL STATE OF ANY OWN CONTROL OF A STATE OF
STORAGE ROOM Ce	th Wall st Wall uth Wall	100/2017 ft	occupations.	NI/A	tbd	Confirm style resembles existing molding
STORAGE ROOM Ce	st Wall uth Wall	New 1/	Existing to remain	IN/A		
STORAGE ROOM  Ce  Door	ith Wall	New 1/	355			
STORAGE ROOM Ce	st Wall		New 1/2" drywall on new partitions			
ROOM Wes		Existing to remain			Matte, color tbd	
Ce	eilina	Existing to remain			Matte, color tbd	
	5	Existing	to remain, patch as	s needed	Matte, ceiling white	
P	r Casing	Pine	TW Perry	SM-7	Semi-gloss, color tbd	Confirm style resembles existing molding
	Plinth	Pine	TW Perry	Custom	Semi-gloss, color tbd	
Ro	osette	Pine	TW Perry	SM-20	Semi-gloss, color	Confirm style resembles existing molding
Windo	ow Casing	Pine	TW Perry	SM-7	Semi-gloss, color	Confirm style resembles existing molding
Windo	low Stool	Pine	TW Perry	WM-121	Semi-gloss, color	Confirm style resembles existing molding
F	loor	ETR	ETR	ETR	ETR	New nosing at new stair. Finish to resemble existing floors.
	Base	Pine	TW Perry	WM-618P	Semi-gloss, color	Confirm style resembles existing
s	Shoe	Oak	Flooring	N/A	Stain to resemble	molding
100.00	th Wall		subcontractor ETR		floors	
	st Wall	New 1/2" drywall on new partitions			ETR	
ALoss	2010 Section 10	ETR			#1.4(#95520	
FAMILY	ıth Wall	ETR			ETR	
ROOM	st Wall	Patch ceiling as needed			Matte, color tbd  Matte, ceiling	
Ce	eiling	P	atch ceiling as need	led	white Semi-gloss, color	Confirm style resembles existing
Door	r Casing	Pine	TW Perry	SM-7	tbd	molding
P	Plinth	Pine	TW Perry	Custom	Semi-gloss, color tbd	Custom plinth to resemble existing
Ro	osette	Pine	TW Perry	SM-20	Semi-gloss, color tbd	Confirm style resembles existing molding
Windo	ow Casing	Pine	TW Perry	SM-7	Semi-gloss, color tbd	Confirm style resembles existing molding
Windo	low Stool	Pine	TW Perry	WM-121	Semi-gloss, color tbd	Confirm style resembles existing molding
E	Floor	ETR	ETR	ETR	ETR	
В	Base	Pine	TW Perry	WM-618P	Semi-gloss, color tbd	Confirm style resembles existing molding
s	Shoe	Oak	Flooring subcontractor	N/A	Stain to resemble floors	
Nort	th Wall		ETR		ETR	
Eas	st Wall	ETR			ETR	
Soul	ıth Wall	ETR			ETR	
DIMINIO -	st Wall	Patch ceiling as needed			Matte, color tbd	
DINING Wes		Patch ceiling as needed  New 1/2" drywall		Matte, ceiling		
ROOM Wes	eiling		TW Perry	SM-7		Confirm style resembles existing
ROOM Ce	eiling r Casing	Pine		102.00000000	tbd	
ROOM Ce	-	Pine Pine	TW Perry	Custom	Semi-gloss, color	molding
ROOM Ce Door	r Casing Plinth	Pine	-		Semi-gloss, color tbd Semi-gloss, color	molding  Custom plinth to resemble existing  Confirm style resembles existing
ROOM Ce Door Pi	r Casing	909(0900)	TW Perry TW Perry	Custom SM-20 SM-7	Semi-gloss, color tbd	molding  Custom plinth to resemble existing

specifications, and rangements and shall remain the No part thereof shall there or used in c or project or by any oose other than for nich they have been without the written without the written dispersions shall stence and rictions.

The above drawings and specification in the above drawings and stranger the deas, designs and arranger represented thereby are and shorperty of the architect No part be copied, disclosed to others on the any work or process.

LEVINE
GROUP
ARCHITECTS + BUILDERS
301.585.4848
fax 301.585.4207
8639B 16th Street
Ste. 278
Silver Spring, MD 20910

Phase CONTRACT

Date JULY 24, 2023

Scale

Drawn By GAD

Revision

Raskin Library 7209 Holly Ave, Takoma Park, MD 20912

FINISH SCHEDULE

A-014


APPROVED


Montgomery County

Historic Preservation Commission

By Dan.Bruechert at 9:28 am, Aug 15, 2023

REVIEWED

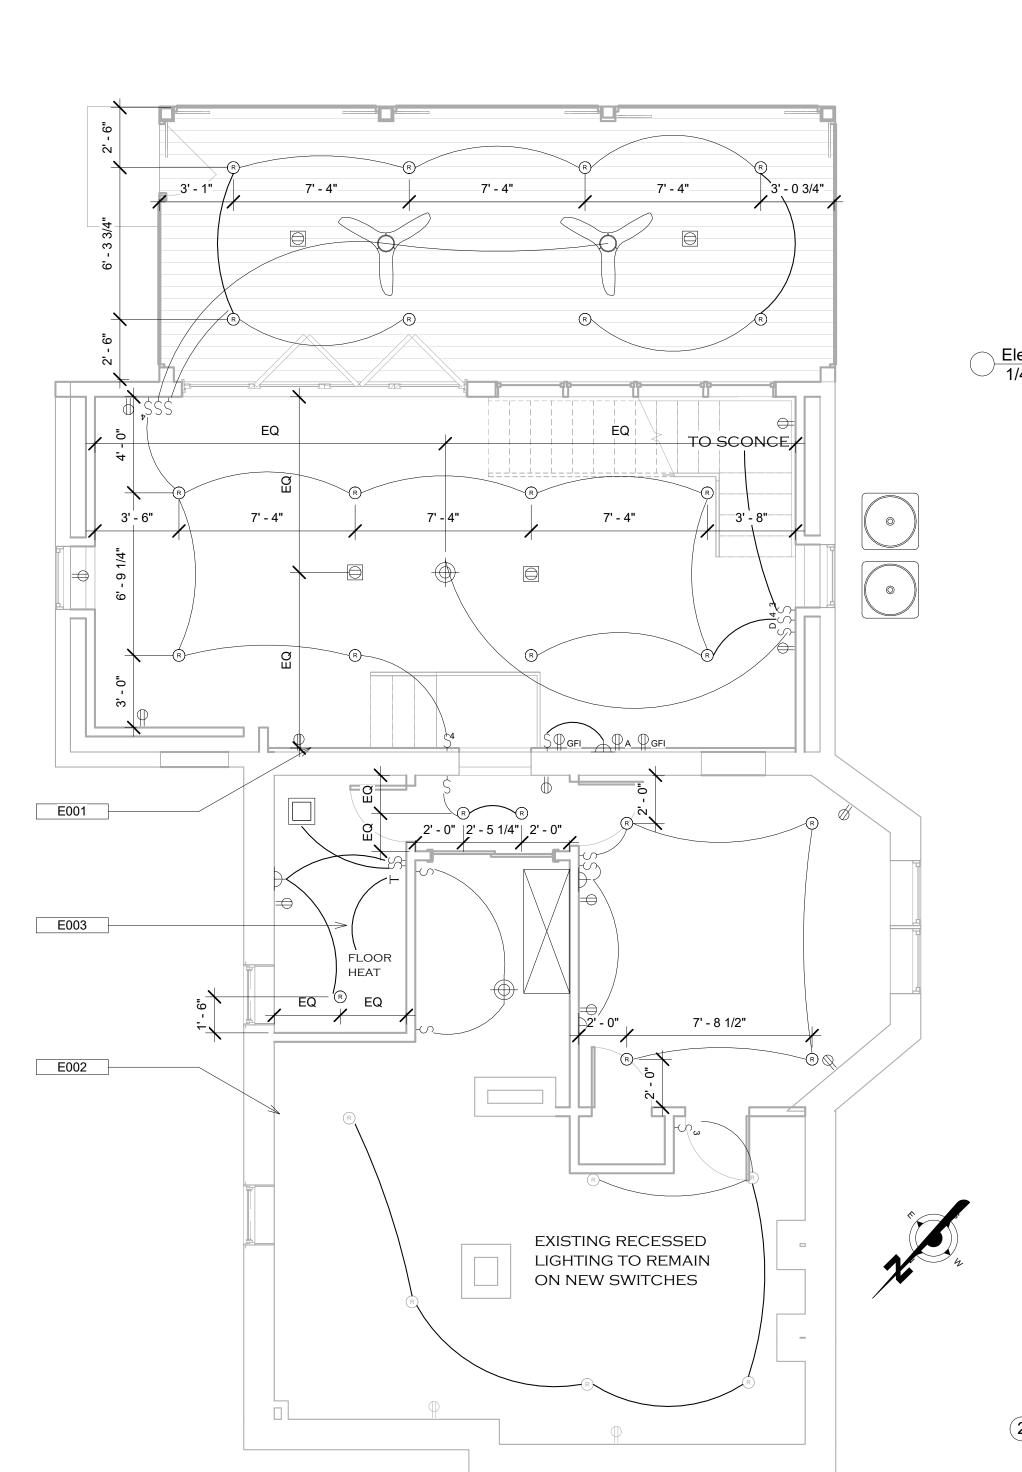

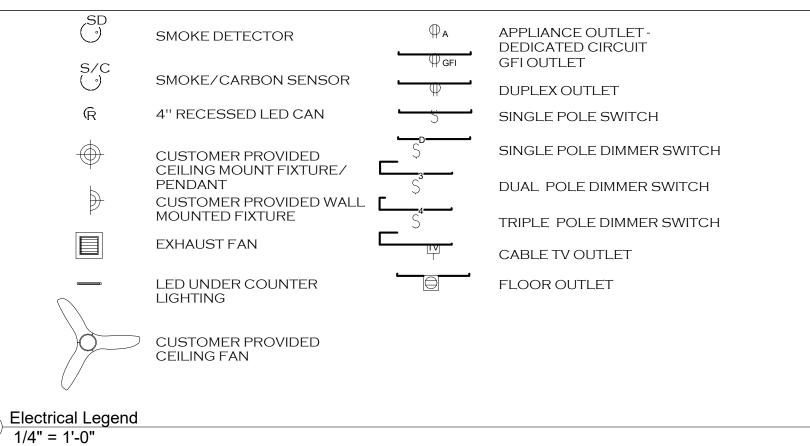

	Keynote Legend
Key Value	Keynote Text
E001	RELOCATE EXISTING SUB PANEL HERE
E002	2 EXISTING ELECTRICAL PANELS TO REMAIN
E003	NEW HEATED ELECTRIC FLOOR MAT

NOTES

1. ALL IC RATED LIGHTING FIXTURES TO BE SEALED AT HOUSING/INTERIOR AND LABELED TO INDICATE LESS THAN OR
EQUAL TO 2.0 CFM LEAKAGE AT 75PA
2. MORE THAN 85% OF ALL FIXTURES SHALL USE HIGH EFFICENCY
LED BULBS



2 BASEMENT ELECTRICAL 1/4" = 1'-0"


LEVINE GROUP


CONTRACT	JULY 24, 2023	1/4" = 1'-0"	Author	
Phase	Date	Scale	Drawn By	Revision

MD Д skin Library Ave, Takoma I 20912 Ra **7209 Holly** 

**BASEMENT** ELECTRICAL **PLAN** 

E-001

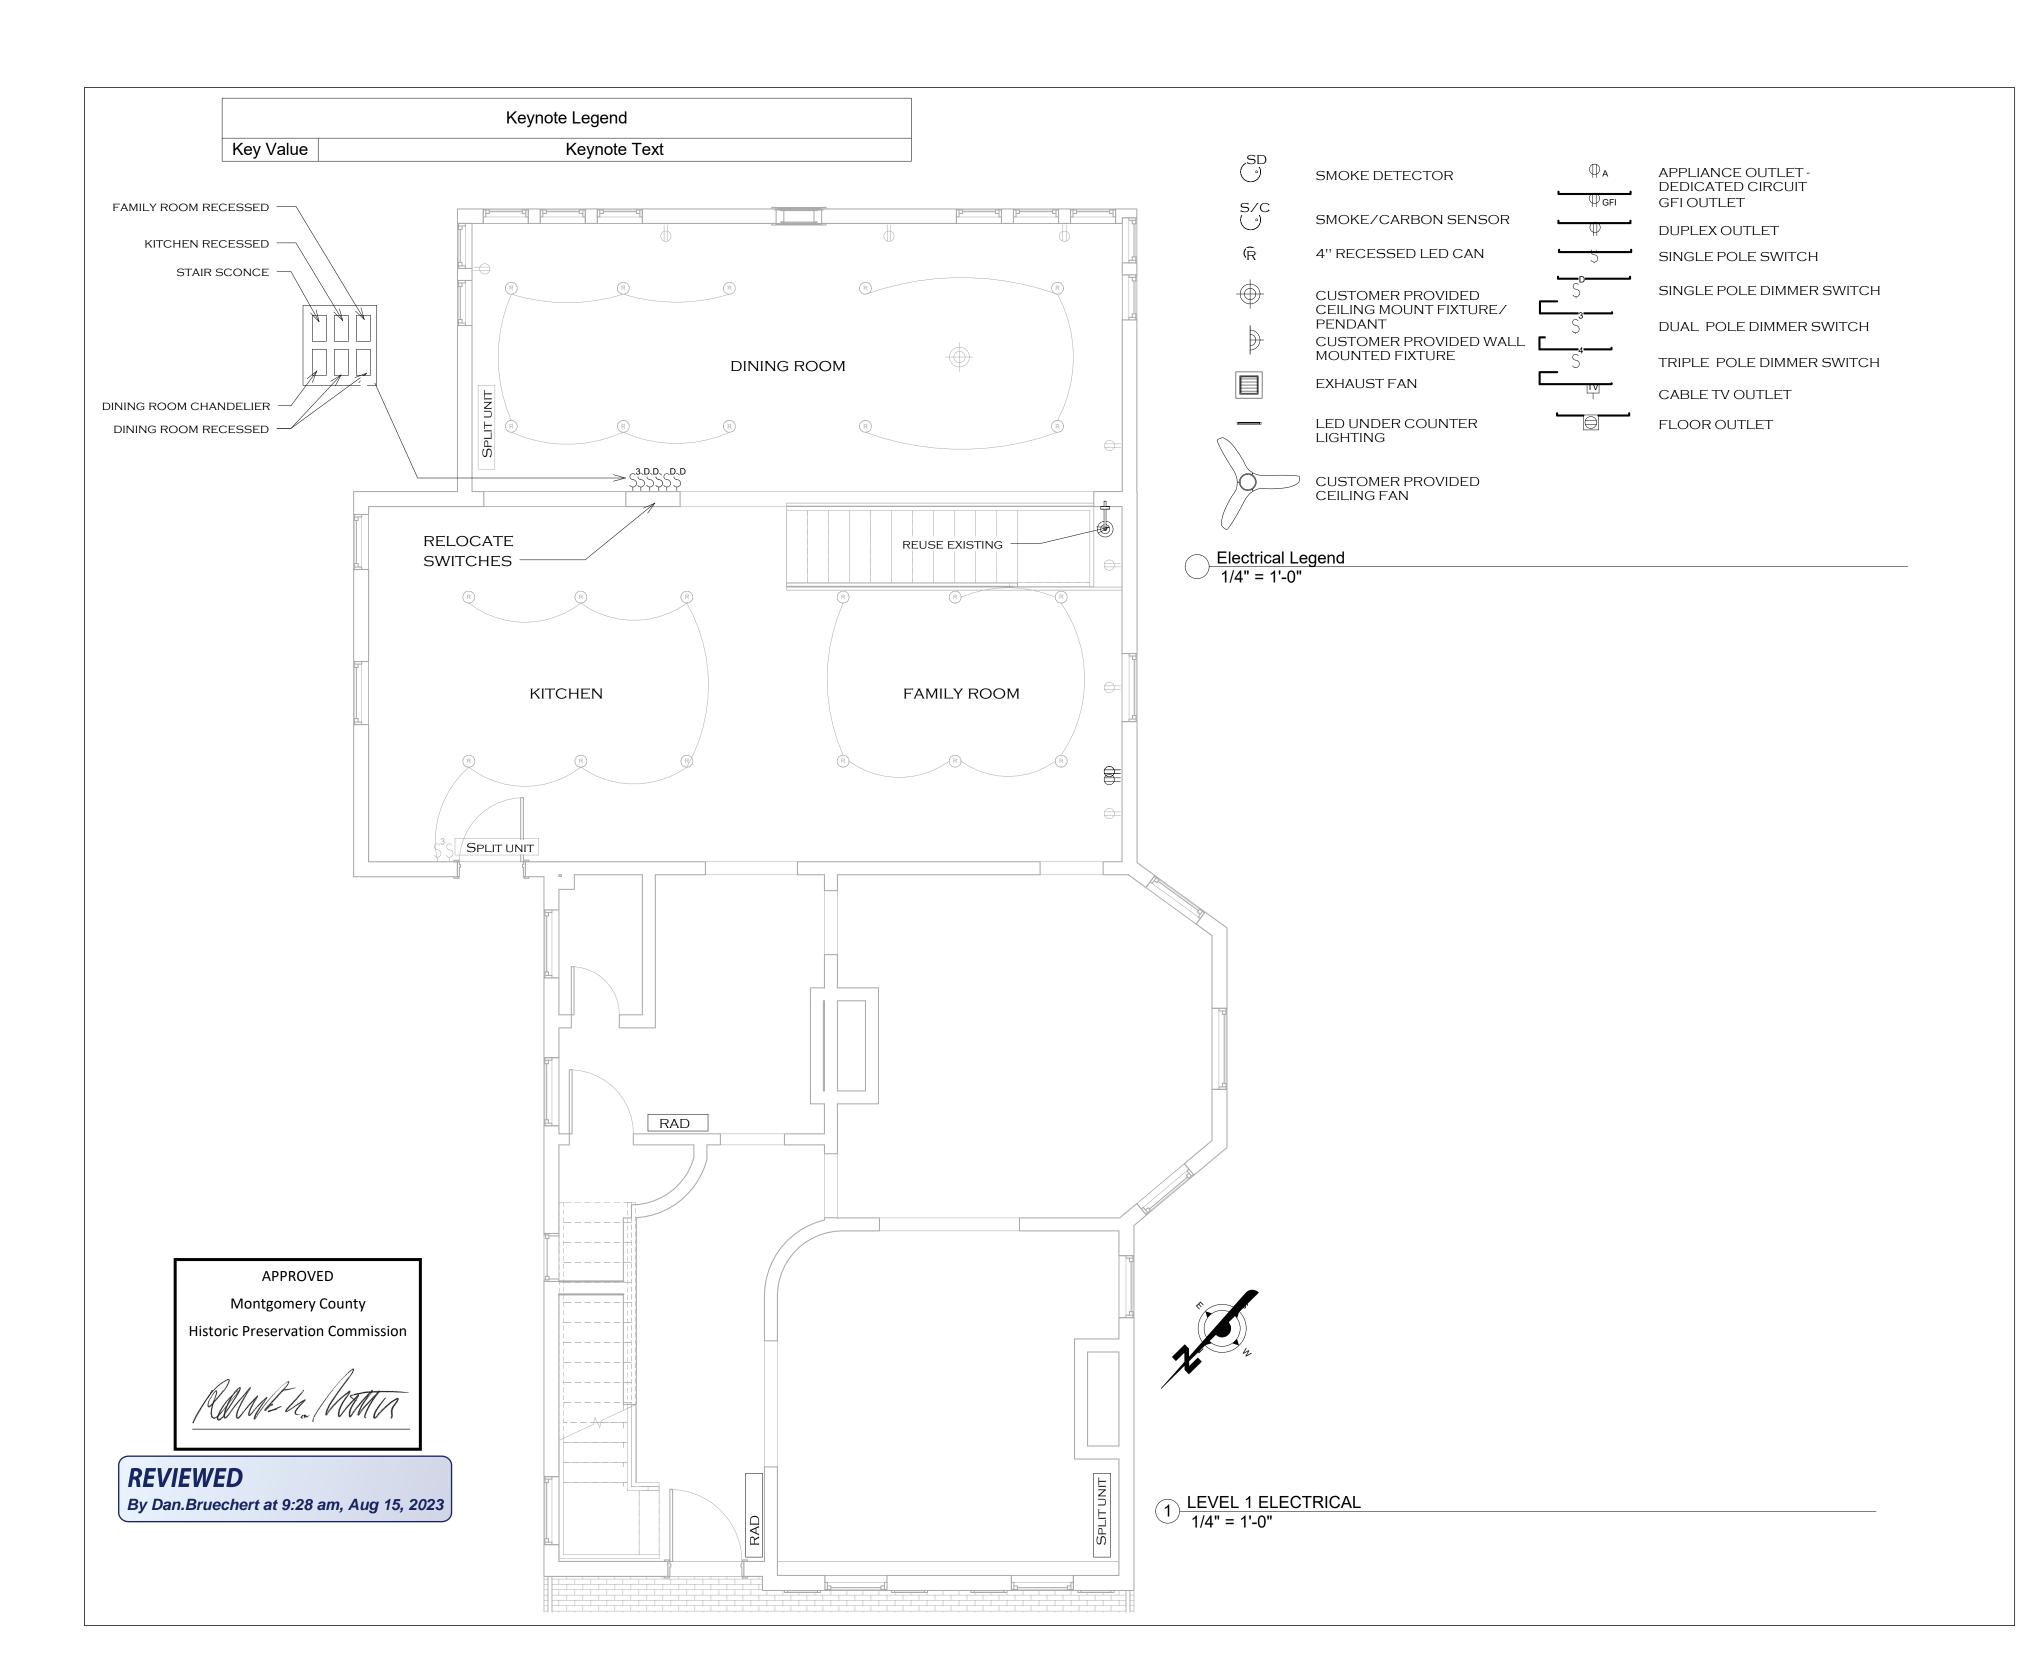

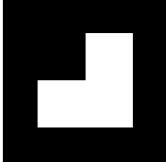

ove trainings and specifications, and as, designs and arrangements inted thereby are and shall remain the yof the architect. No part thereof shall ed, disclosed to others or used in ton with any work or project or by any erson for any purpose other than for offic project for which they have been diffic project for which they have been

Propresented thereby are and shall properly of the architect. No part in property of the architect. No part in property of the architect or onnection with any work or project on which they the specific project for which they prepared and developed without 1

301.585.4848 fax 301.585.4207 8639B 16th Street

CONTRACT	JULY 24, 2023	1/4" = 1'-0"	GAD	
Phase	Date	Scale	Drawn By	Revision

Raskin Library 7209 Holly Ave, Takoma Park, MD 20912

FIRST FLOOR ELECTRICAL PLAN

E-002

- Notes:

  1. Building Cavities are not used as ducts or plenums.
- 2. Automatic gravity dampers are installed on all outdoor air intakes and exhausts per
- 3. All Mechanical ventilation system fans not part of tested and listed HVAC equipment meet efficacy and air flow limits.
- 4. Manufacturers Manuals for mechanical and water heating systems are provided and shall remain on site.
- 5. All joints & seams to be sealed per iecc 403.2.2
  6. This project is required to submit at final inspection a whole-building blower door test showing a passing rating of <= 5 Air Changes per Hour at a Pressure of 50 Pascal. A written report of the results of the test shall be signed by the party conducting the test and provided to the code official upon request.</li>
- 7. The whole house mechanical ventilation system shall provide outdoor air at a continuous rate of not less than 75 CFM as determined by table M1505.4.3(1) of the IRC
- 8. All HVAC piping carrying fluids >105° or >55° to receive R-3 spray foam insulation 9. Total duct leakage to be less than 8cfm/ 100SF with AHU installed 10. Programmable thermostats to be installed for each system

- 11. Ducts in the attic shall be insulated to R8 or greater12. Air handlers shall have a manufacturer's designation for an air leakage of no more than 2 percent of the design air flow rate.
- 13. Piping insulation exposed to weather shall be protected from damage14. Fuel gas lighting systems shall not have continuously burning pilot lights.


#### **HVAC EQUIPMENT INFORMATION**


PLEASE SEE MANUAL J & SUPPORTING DOCUMENTS FOR HVAC EQUIPMENT & INFORMATION

- (2) Panasonic WhisperCeiling™ Fan Quiet, Spot Ventilation Solution, 110 CFM
- (1) STAINLESS GE Designer Wall Hood, 36"
- Up to 600 cfm, make up air provided

	Keynote Legend
Key Value	Keynote Text

MO	01	EXISTING CONDENSOR UNIT
MO	02	NEW CONDENSOR UNIT
MO	03	NEW CEILING MOUNTED HVAC CASSETTE
MO	04	NEW WALL MOUNTED HVAC CASSETTE

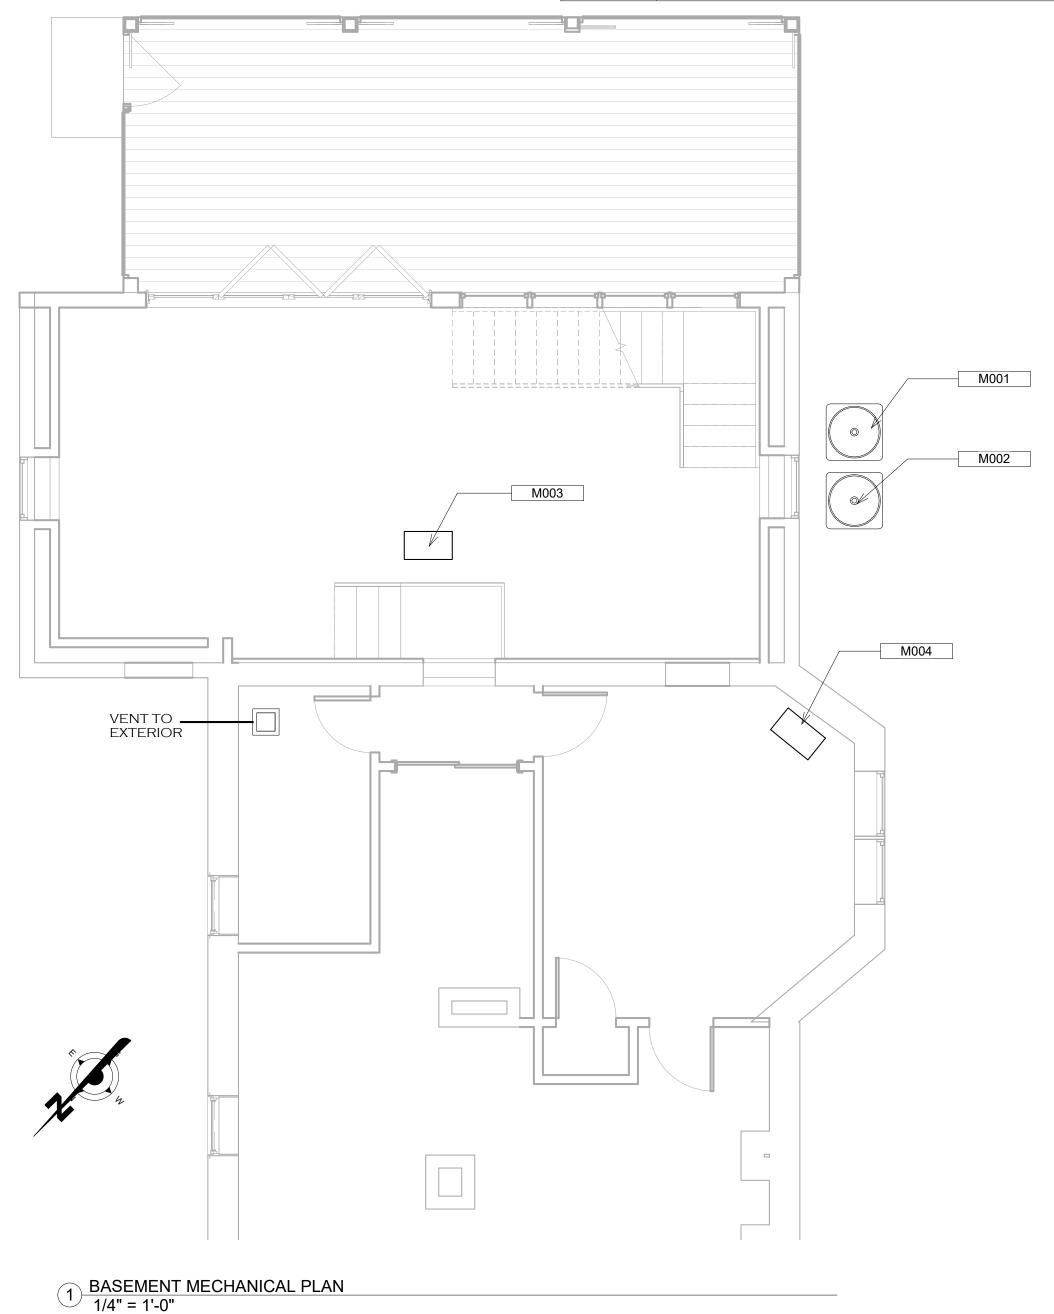

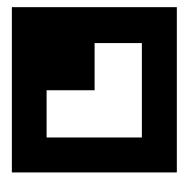

CONTRACT JULY 24, 2023 1/4" = 1'-0" Author Drawn By Date Scale

> MD Park, skin Library Ave, Takoma F 20912 Ra **7209 Holly**

**BASEMENT** MECHANICAL PLAN

M-001

## **REVIEWED**

By Dan.Bruechert at 9:28 am, Aug 15, 2023

**APPROVED** 

**Montgomery County Historic Preservation Commission**