

HISTORIC PRESERVATION COMMISSION

Marc Elrich
County Executive

Robert K. Sutton

Chairman

Date: April 6, 2023

MEMORANDUM

TO: Rabbiah Sabbakhan, DPS Director

Dan Bruechert

FROM: Historic Preservation Section

Maryland-National Capital Park & Planning Commission

Historic Area Work Permit #1023017 - Garage ADU Conversion

SUBJECT:

The Montgomery County Historic Preservation Commission (HPC) has reviewed the attached application for a Historic Area Work Permit (HAWP). This application was **Approved** at the March 23, 2022 HPC meeting with revisions approved at the March 22, 2023 HPC meeting.

The HPC staff has reviewed and stamped the attached construction drawings.


THE BUILDING PERMIT FOR THIS PROJECT SHALL BE ISSUED CONDITIONAL UPON ADHERENCE TO THE ABOVE APPROVED HAWP CONDITIONS AND MAY REQUIRE APPROVAL BY DPS OR ANOTHER LOCAL OFFICE BEFORE WORK CAN BEGIN.


Applicant: Pat Hanrahan

Address: 7421 Cedar Ave., Takoma Park


This HAWP approval is subject to the general condition that the applicant will obtain all other applicable Montgomery County or local government agency permits. After the issuance of these permits, the applicant must contact this Historic Preservation Office if any changes to the approved plan are made. Once work is complete the applicant will contact Dan Bruechert at 301563.3400 or dan.bruechert@montgomeryplanning.org to schedule a follow-up site visit.



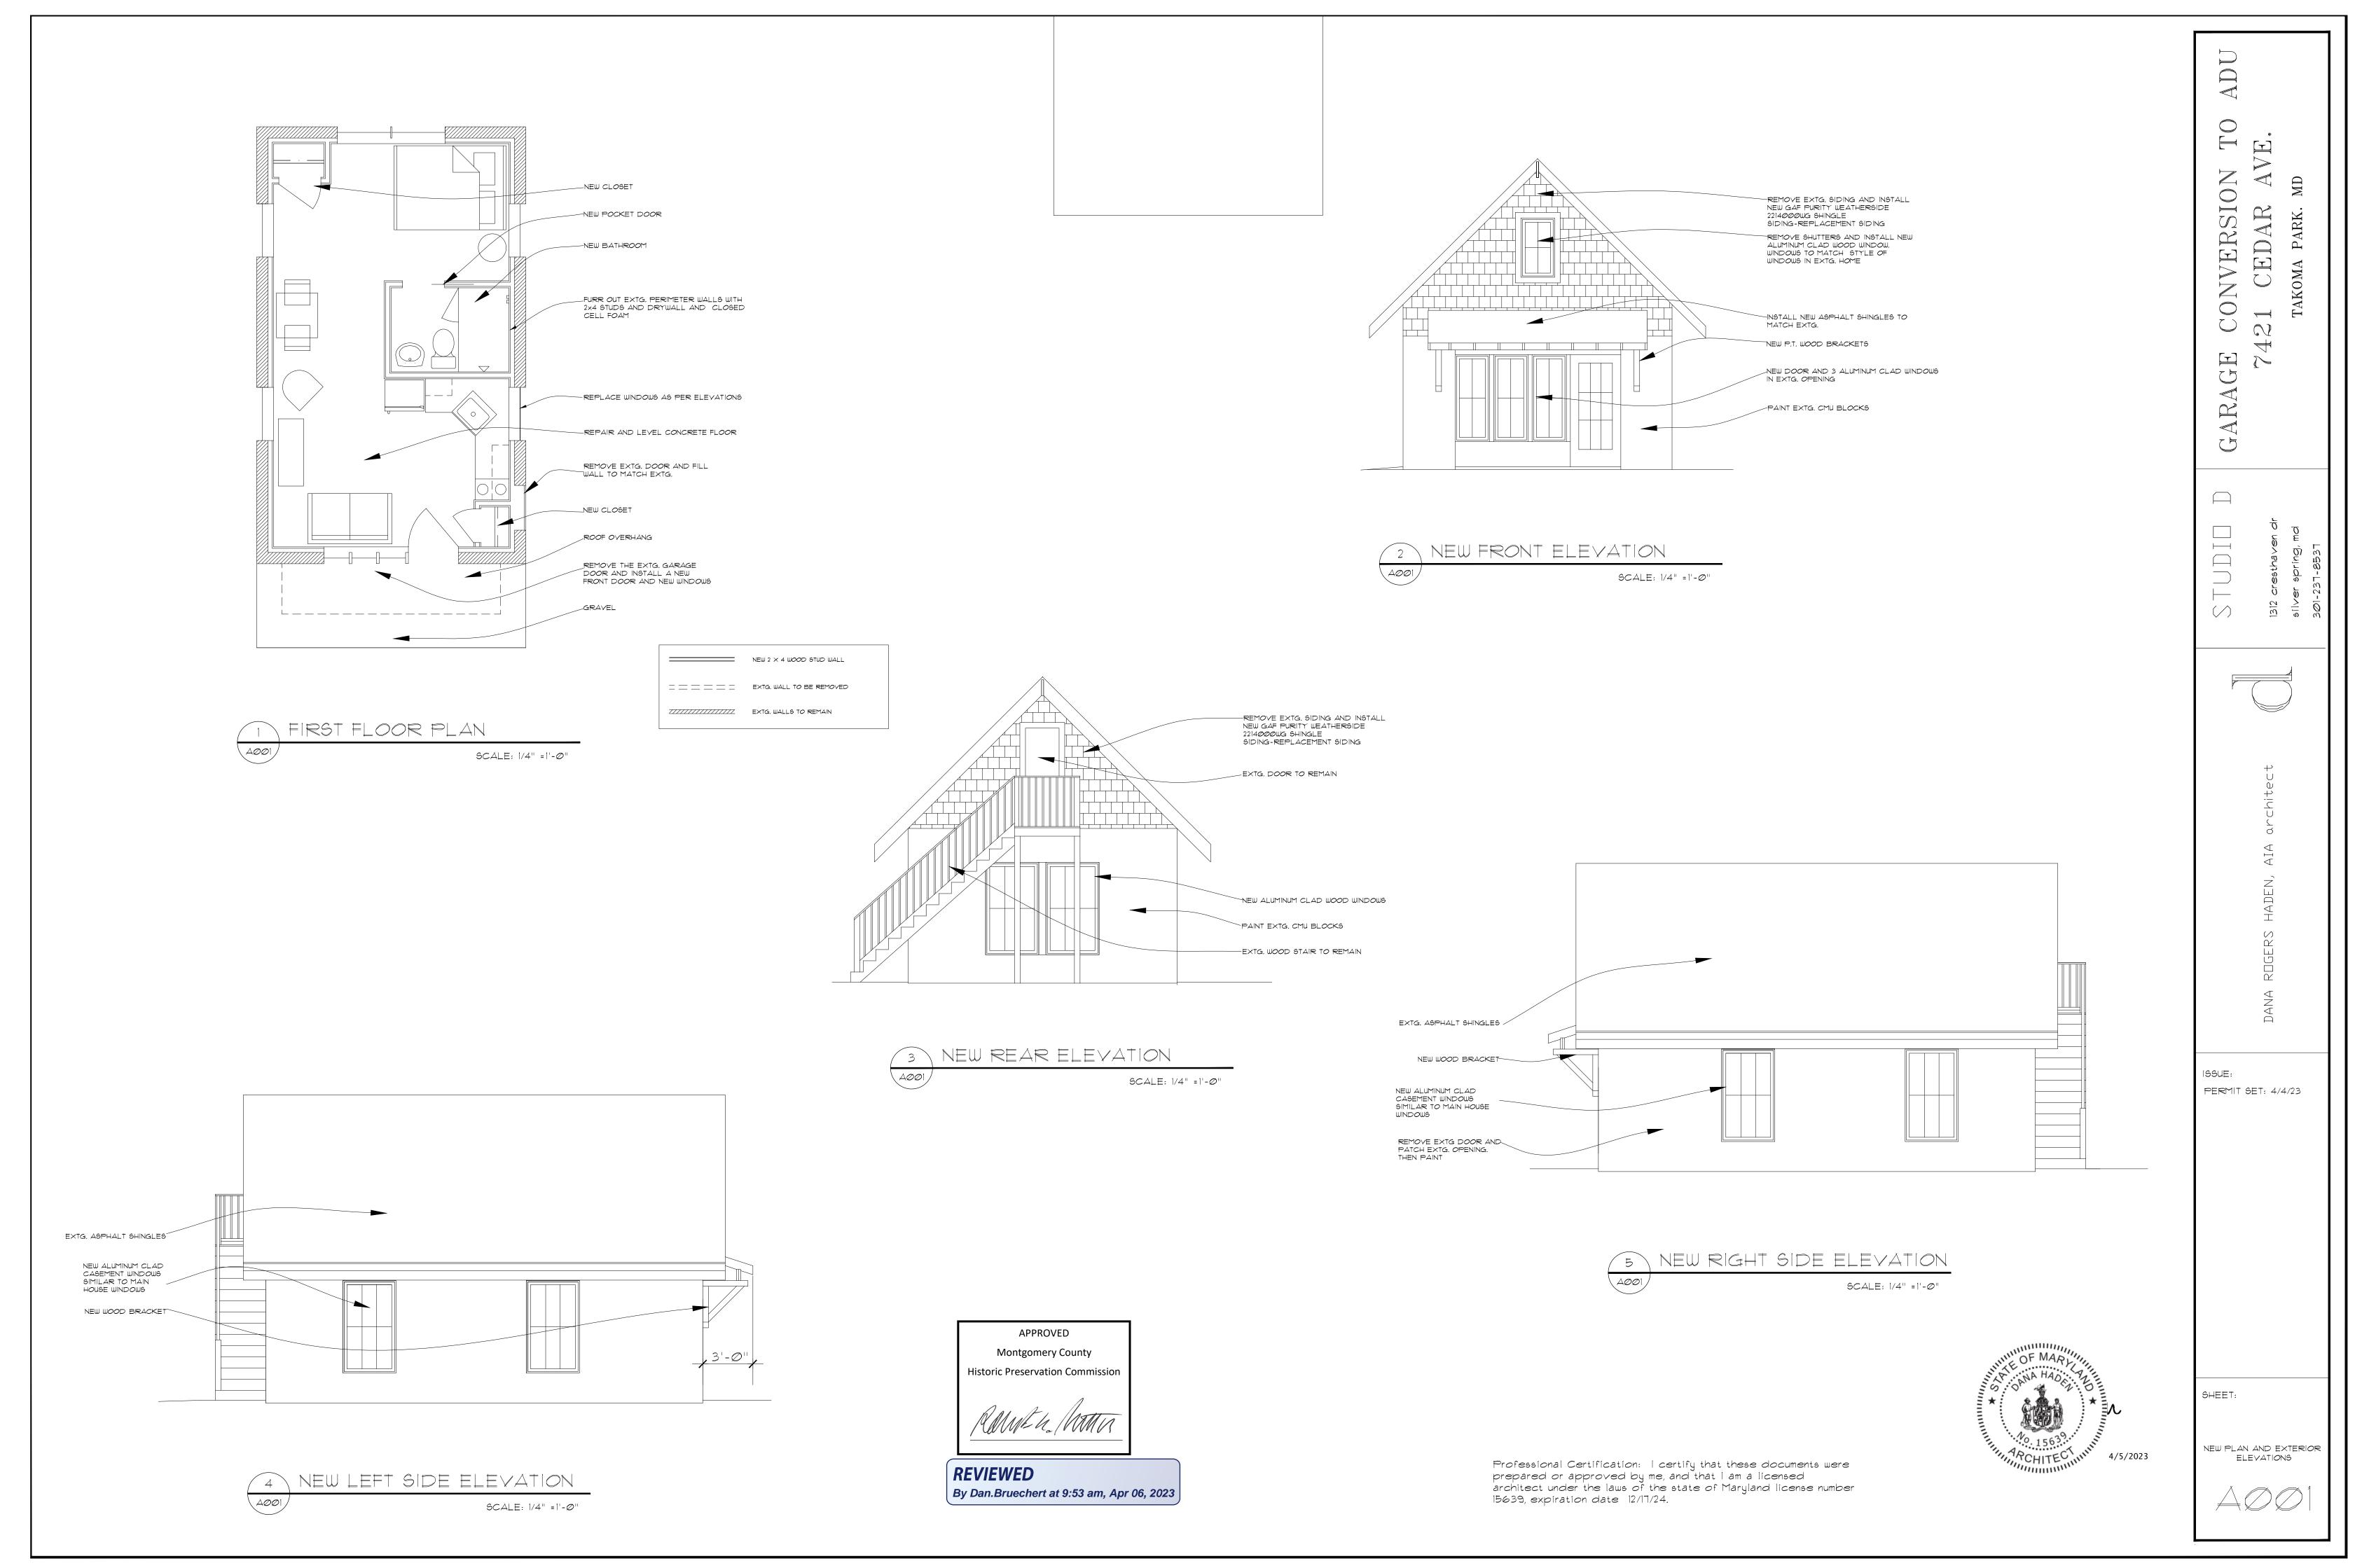


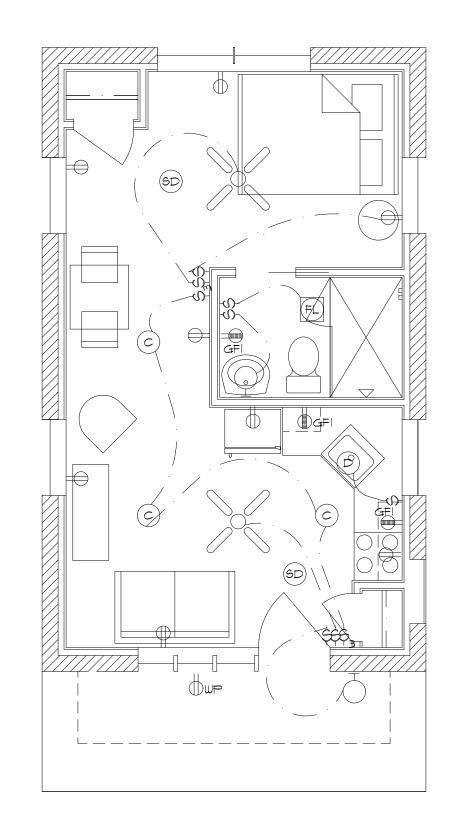


ELECTRICAL LEGEND	
\Rightarrow	120 V DUPLEX RECEPTACLE 18" A.F.F.
	120 V DUPLEX RECEPTACLE 48" A.F.F.
⊕ GFI	GROUND FAULT INTERRUPTOR RECEPTACLE
	WATER PROOF FIXTURE
	SPECIAL PURPOSE CONNECTION
	CEILING MOUNTED LIGHT FIXTURE
(c)	RECESSED CAN LIGHT
P	PENDANT LIGHT
H	WALL MOUNTED LIGHT FIXTURE
\$	SWITCH
\$3	3 WAY SWITCH
F	EXHAUST FAN
(SD)	SMOKE DETECTOR
FL	FAN/LIGHT FIXTURE

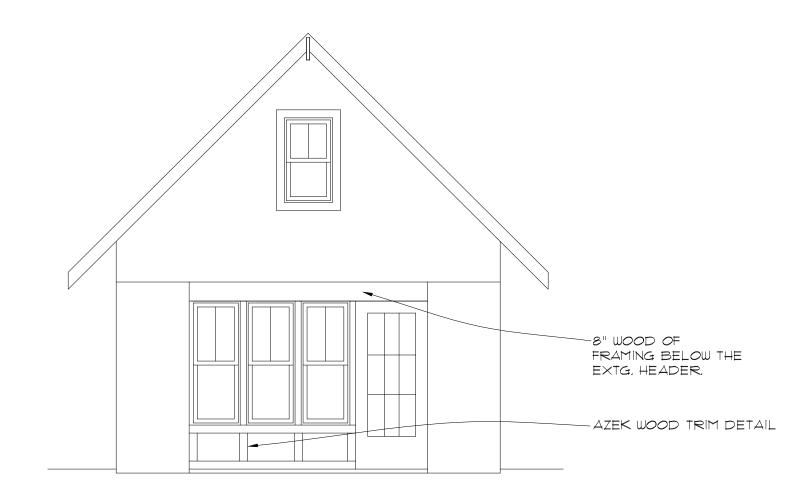



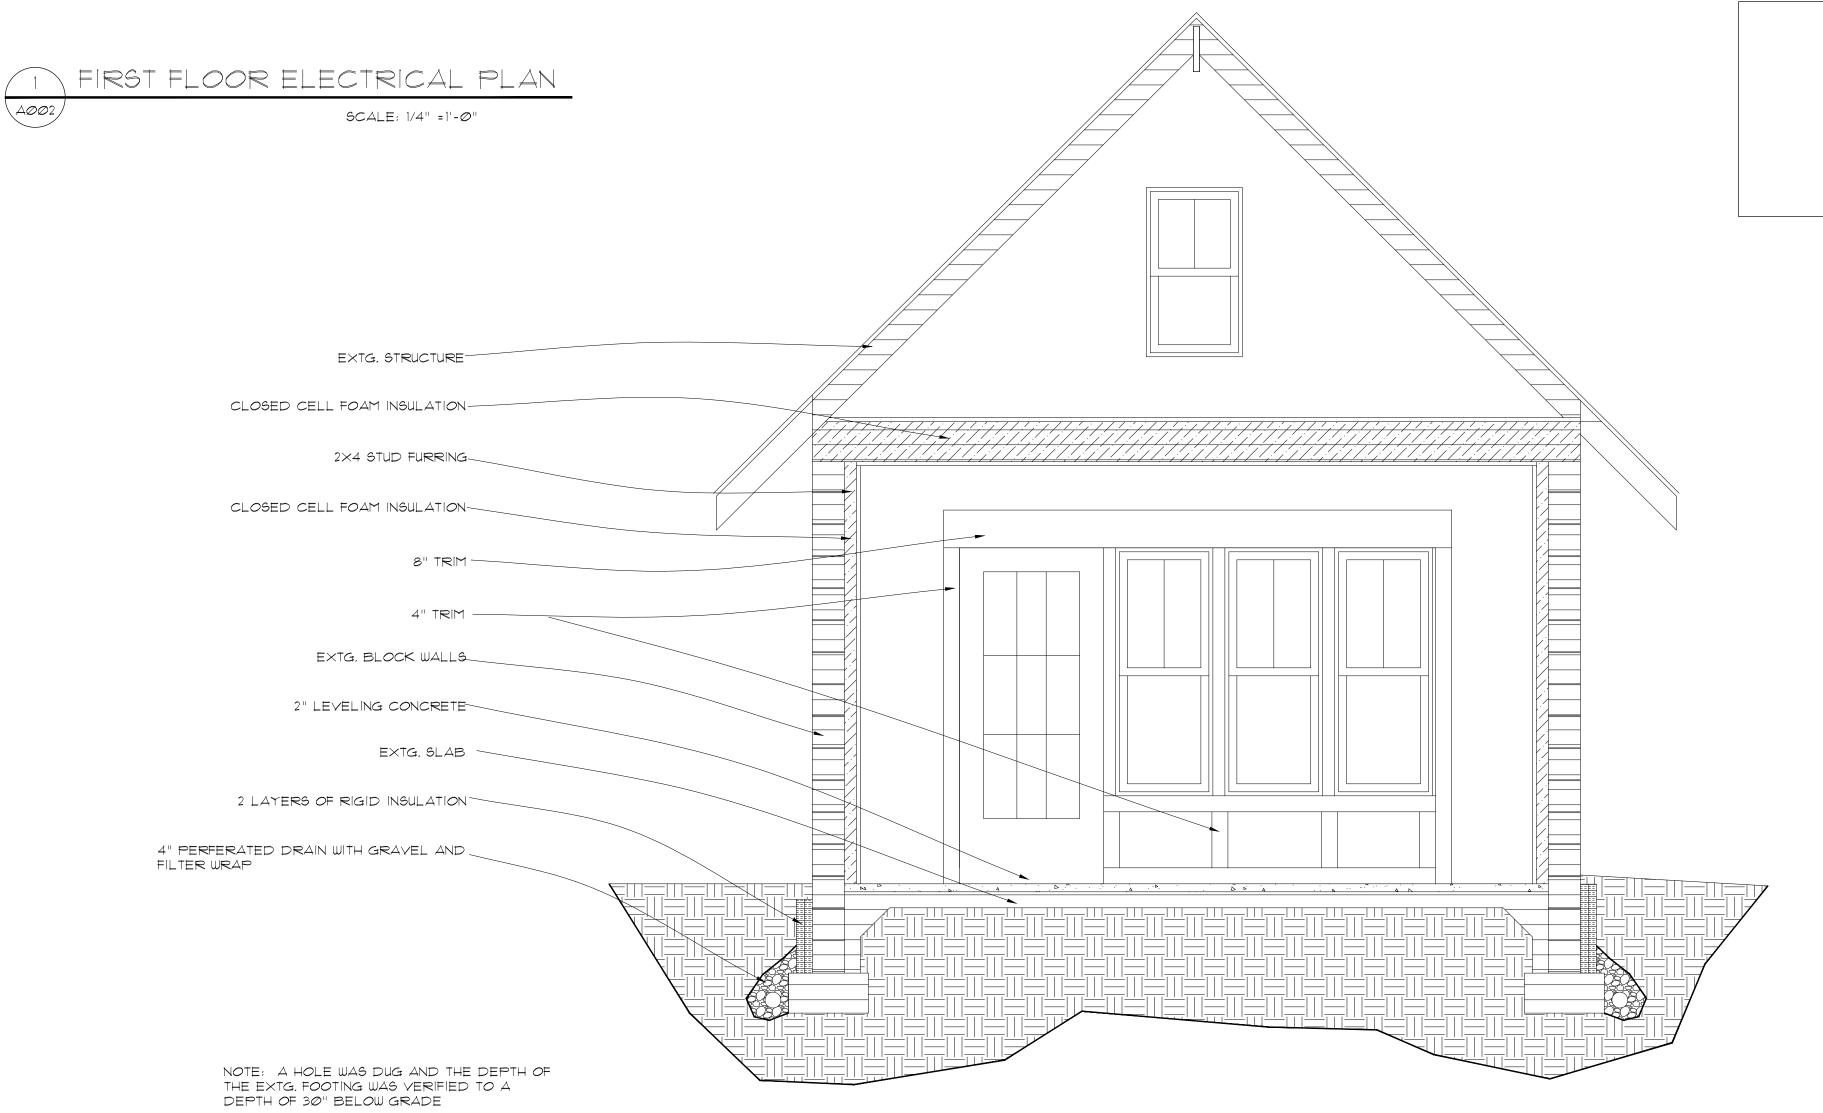

SCALE: 1/4" =1'-0"

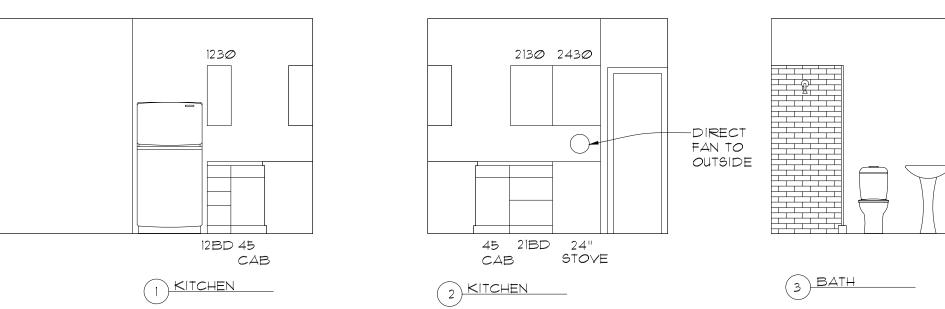







Professional Certification: I certify that these documents were prepared or approved by me, and that I am a licensed architect under the laws of the state of Maryland license number 15639, expiration date 12/17/24.

GARAGE CONVERSION TO A 7421 CEDAR AVE.

312 cresthaven dr silver spring, md

RDGERS HADEN, AIA architect

ISSUE: PERMIT SET: 4/4/23

SHEET:

ELECT. PLAN, SECTION, DOOR DETAIL, INT. ELEV

A002

GARAGE CONVERSION TO ADU 7421 CEDAR AVE.

TAKOMA PARK, MD

ZONING INFORMATION

LOT: 6 BLOCK: 86 TAKOMA PARK, MONTGOMERY COUNTY, MD

GENERAL NOTES

ALL MATERIAL AND WORK SHALL BE ACCOMPLISHED IN ACCORDANCE WITH MONTGOMERY COUNTY AND THE 2018 IRC BUILDING CODE.

WIND LOAD: 90 MPH W/ 3 SECOND GUSTS.

THE CONTRACTOR SHALL OBTAIN PERMITS FOR CONSTRUCTION AND INSPECTIONS OF WORK.

THE CONTRACTOR SHALL VERIFY ALL BUILDING DIMENSIONS AND NOTIFY THE ARCHITECT OF ANY DISCREPANCIES BEFORE PROCEEDING WITH THE WORK. THE CONTRACTOR SHALL INFORM THE ARCHITECT OF CONDITIONS WHICH MAY AFFECT THE CONSTRUCTION AS SHOWN.

THE CONTRACTOR SHALL PROVIDE WORKMAN EXPERIENCED IN THEIR TRADE AND ALL WORK SHALL CONFORM TO THE ACCEPTED STANDARDS OF THE INDUSTRY. THE CONTRACTOR AND ALL SUB-CONTRACTORS SHALL BE LEGALLY REGISTERED IN MARYLAND.

THE CONTRACTOR AND SUB-CONTRACTORS SHALL CLEAN THE SITE OF DUST AND DEBRIS DAILY AFTER WORK IS COMPLETED. ALL EFFORTS SHALL BE MADE TO KEEP DUST FROM OCCUPIED ROOMS OF THE HOUSE. THE HOUSE SHALL BE LEFT IN A SPOTLESS CONDITION AFTER FINAL COMPLETION OF THE WORK.

DO NOT SCALE THE DRAWINGS. DIMENSIONAL DISCREPANCIES AND QUESTIONS SHALL BE DIRECTED TO THE ARCHITECT.

DO NOT STACK BUILDING MATERIALS IN SUCH A MANNER THAT WOULD CREATE CONCENTRATED LOADS ON THE EXISTING STRUCTURE.

ALL EXISTING AREAS AFFECTED BY THE NEW WORK SHALL BE RESTORED TO MATCH EXISTING

THE CONSTRACTOR SHALL FURNISH ALL MATERIALS, LABOR AND EQUIPMENT REQUIRED FOR THE FULL PERFORMANCE OF THE WORK HEREIN, UNLESS SPECIFICALLY NOTED OTHERWISE.

THE GENERAL CONTRACTOR SHALL GIVE HIS PERSONAL SUPERVISION TO THE WORK AND HAVE A RESPONSIBLE FOREMAN CONTINUALLY ON THE SITE TO ACT FOR HIM. THE CONTRACTOR AND ALL SUB-CONTRACTORS SHALL COOPERATE WITH ALL TRADES SO AS TO FACILITATE THE GENERAL PROGRESS OF THE WORK, EACH TRADE SHALL AFFORD ALL OTHER TRADES EVERY REASONABLE OPPORTUNITY FOR THE INSTALLATION OF THEIR WORK.

THE CONTRACTOR AND ALL SUB-CONTRACTORS SHALL CARRY WORKMAN'S COMPENSATION INSURANCE AND ANY OTHER INSURANCES AS REQUIRED BY LAW.

OWNER AND THE CONTRACTOR IN WRITING PRIOR TO PROCEEDING WITH THE WORK.

ALL DIMENSIONS ARE TO ROUGH FRAMING UNLESS OTHERWISE NOTED.

ALL FRAMING MATERIAL SHALL BE INSTALLED INACCORDANCE WITH THE FOLLOWING LIVE LOAD DESIGN STRENGTHS:

ROOF- 3ØPSF FLOORS- 40PSF

WOOD STUDS (2x4 @ 16" O.C.)- NO. 3 STANDARD STUD GRADE LUMBER OR EQUIVALENT.

ALL JOISTS SHALL HAVE MINIMUN BEARING OF 1 1/2" ON WOOD OR STEEL AND NOT LESS THAN

WALL FRAMING: UNLESS NOTED OTHERWISE 2x4 STUDS @ 16" O.C. WITH DOUBLE STUDS AT OPENING, 3 FULL MEMBERS @ CORNERS, DOUBLE PLATES FOR BEARING PARTITIONS. 3" ON MASONRY.

ALL WOOD IN CONTACT WITH EXTERIOR WALLS BELOW GRADE OR CONCRETE SLABS ON GRADE (SILLS, PLATES, SLEEPERS) SHALL BE PRESSURE TREATED. ALL EXTERIOR WOOD SHALL BE PRESSURE TREATED OR APPROVED FOR EXTERRIOR USE.

FOOTINGS: BOTTOMS OF ALL FOOTINGS SHALL EXTEND 1'-0" MIN. INTO UNDISTURBED SOIL AND WHERE SUBJECT TO FROST ACTION AT LEAST 2'-6" BELOW FINISHED GRADE. FOOTINGS SHALL EXTEND BELOW ELEVATIONS SHOWN WHERE NECESSARY TO REACH THE SOIL BEARING VALUE OF 2,000 PSF.

ALL ASSEMBLIES AND MATERIALS SHALL BE INSTALLED IN ACCORDANCE WITH THE MANUFACTURER'S SPECIFICATION.

USE APPROVED METAL (KANT-SAG) OR EQUIVALENT CONNECTORS FOR ALL STRUCTURAL LUMBER CONNECTIONS.

ALL OPENINGS THROUGH ROOF OR WALLS SHALL BE THOROUGHLY SEALED AND FLASHED.

INTERIOR TRIM AND DOOR FRAMES: INSTALL TRIM TO MATCH EXTG. AROUND DOORS AND WINDOWS (INTERIOR) WOOD SHALL BE SECURED WITH FINE FINISH NAILS AND GLUED WHERE REQUIRED TO ASSURE PERMANENT TIGHT JOINTS. SET WOOD BASE AFTER FINISH FLOOR IS IN PLACE.

GUTTERS AND DOWNSPOUTS: ALUMINUM SYSTEM + SIZE, SHAPE AND COLOR TO MATCH EXISTING.

INSTALL SPLASH BLOCKS AT EACH DOWNSPOUT.

CAULKING AND SEALANTS: APPLY DAP ACRYLIC LATEX CAULK WITH SILICONE OVER POLYETHYLENE FOAM BACKING. MAXIMUM JOINT DEPTH 1/2"

ELECTRICAL AND RECEPTACLE OUTLETS: CONTRACTOR SHALL FURNISH AND INSTALL DUPLEX OUTLETS AS SHOWN ON DRAWINGS. PROVIDE ADDITIONAL CAPACITY ONCIRCUITS FOR FUTURE OUTLETS TO BE INSTALLED BY OWNER. PROVIDE DEDICATED CIRCUITS SIZED AS REQUIRED BY EQUIPMENT MANUFACTURER.

CONTRACTOR SHALL FURNISH AND INSTALL ALL LIGHT FIXTURES, WIRING, AND SWITCHES AS INDICATED.

INSTALL R-38 BATT INSULATION IN THE CEILING OF 2ND FLOOR IN NEW ROOF TRUSSES INSTALL R-21 BATT INSULATION IN THE 2x6 STUD WALL

***MECHANICAL WORK AND DRAWINGS TO BE SUPPLIED BY MECHANICAL CONTRACTOR.

INSTALL R-21 BATT INSULATION IN THE REST OF THE NEW EXTERIOR 2x6 WALLS.

LIST OF DRAWINGS

SHEET TITLE

ZONING INFORMATION, GENERAL NOTES, LIST OF DRAWINGS, SITE PLAN.

EXTG. PLANS AND ELEVATIONS

NEW FLOOR PLAN AND 4 ELEVATIONS ELECT. PLAN., EXT. DOOR ELEV., INT. DETAILS, SECTION

> APPROVED Montgomery County **Historic Preservation Commission**

REVIEWED By Dan.Bruechert at 9:53 am, Apr 06, 2023

15'-0" 3'-Ø" GARAGE DRIVEWAY 36" DEEP OVERHANG ROOF 13'-10" 17'-0'' ACCESSORY BUILDING SIDE STREET SETBACK - 15' 7421 FRAME HOME

CEDAR AVE



TWO VARIANCES WERE APPROVED BY THE ZONING BOARD ON DECEMBER 14. ONE VARIENCE WAS FOR THE SETBACK AND ONE WAS FOR THE NEW PORTICO COVERING THE ENTRANCE.




Professional Certification: I certify that these documents were prepared or approved by me, and that I am a licensed architect under the laws of the state of Maryland license number 15639, expiration date 12/17/24.



IST OF DRAWINGS SITE PLAN

 \vdash

PERMIT SET: 4/4/23

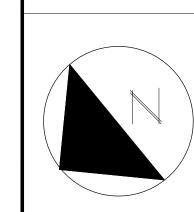

SHEET: ZONING INFORMATION

GENERAL NOTES

