

#### HISTORIC PRESERVATION COMMISSION

Marc Elrich
County Executive

Robert Sutton
Chairman

Date: July 21, 2021

#### **MEMORANDUM**

TO: Mitra Pedoeem

Department of Permitting Services

FROM: Dan Bruechert

Historic Preservation Section

Maryland-National Capital Park & Planning Commission

SUBJECT: Historic Area Work Permit # 942304 - Building Addition, Accessory Structure, and hardscape/

landscape alteration

The Montgomery County Historic Preservation Commission (HPC) has reviewed the attached application for a Historic Area Work Permit (HAWP). This application was **approved** by the HPC at the March 24, 2021 HPC meeting.

The HPC staff has reviewed and stamped the attached construction drawings.

THE BUILDING PERMIT FOR THIS PROJECT SHALL BE ISSUED CONDITIONAL UPON ADHERENCE TO THE ABOVE APPROVED HAWP CONDITIONS AND MAY REQUIRE APPROVAL BY DPS OR ANOTHER LOCAL OFFICE BEFORE WORK CAN BEGIN.

Applicant: Lacy Rice

Address: 7315 Brokeville Rd., Chevy Chase

This HAWP approval is subject to the general condition that the applicant will obtain all other applicable Montgomery County or local government agency permits. After the issuance of these permits, the applicant must contact this Historic Preservation Office if any changes to the approved plan are made. Please contact Dan Bruechert at 301.563.3400 or dan.bruechert@montgomeryplanning.org with any additional comments or questions.



# (1) Rear - Perpective View

APPROVED

Montgomery County

**Historic Preservation Commission** 

By Dan.Bruechert at 12:06 pm, Jul 21, 2021

**REVIEWED** 

# **APPLICABLE CODES**

IRC 2018 W/ LOCAL AMENDMENTS

NFPA-101 / 2018 W/ LOCAL AMENDMENTS

NFPA NATIONAL ELECTRICAL CODE / 2014 W/ LOCAL AMENDMENTS

INTERNATIONAL MECHANICAL CODE / 2018 W/ LOCAL AMENDMENTS

INTERNATIONAL PLUMBING CODE / 2018 W/ LOCAL AMENDMENTS

IECC 2018 W/ LOCAL AMENDMENTS

### **SQUARE FOOTAGE**

(PER SQUARE FOOTAGE -METHOD FOR CALCULATING: ANSI Z765-2003)

#### **STATEMENT OF FINISHED SQUARE FOOTAGE:**

FINISHED SQUARE FOOTAGE CALCULATIONS FOR THIS HOUSE WERE MADE BASED ON PLAN DIMENSIONS ONLY AND MAY VARY FROM THE FINISHED SQUARE FOOTAGE OF THE HOUSE AS BUILT.

EXISTING	<u>G</u>	PROPOS	<u>ED</u>
BASEMENT (UNFINISHED)	1086.5 S.F.	BASEMENT (FINISHED) (UNFINISHED)	782.5 S.F. 304 S.F.
FIRST FLOOR	1730 S.F.	FIRST FLOOR	1878 S.F.
SECOND FLOOR	1130 S.F.	SECOND FLOOR	1764.5 S.F.
THIRD FLOOR (FINSHED) (UNFINISHED)	317 S.F. 80 S.F	THIRD FLOOR	491 S.F.
TOTAL FINISHED AREA	3,177 S.F.	TOTAL FINISHED AREA	4,916 S.F.

**GENERAL NOTES** 

ALL WORK SHALL COMPLY WITH THE 2018 EDITION OF THE INTERNATIONAL RESIDENTIAL CODE (IRC), THE 2018 EDITION

OF THE INTERNATIONAL ENERGY CONSERVATION CODE AND

ANY INCONSISTENCIES FOUND BETWEEN THE DRAWINGS AND

THEMSELVES SHALL BE REPORTED TO THE ARCHITECT. ANY WORK DONE WITHOUT NOTIFICATION OF THE ARCHITECT WILL

WHEN MULTIPLE SPECIFICATIONS ARE GIVEN, CONTRACTOR SHOULD ASSUME MORE EXPENSIVE OPTION FOR PRICING

ANY SUBSTITUTIONS IN MATERIALS, FINISHES OR FIXTURES FROM THE SPECIFICATIONS OF THE DRAWINGS SHALL BE SUBMITTED IN WRITING DURING THE BID PROCESS FOR

ALL OTHER APPLICABLE CODES, REGULATIONS &

ALL WORK SHALL BE COMPLETED BY EXPERIENCED

EXISTING CONDITIONS OR BETWEEN THE DRAWINGS

BE AT THE CONTRACTOR'S RISK AND EXPENSE.

DRAWINGS ARE TO BE READ AND NEVER SCALED.

ALL METAL FLASHING INSTALLATIONS PER SMACNA.

FOLLOW INDUSTRY GUIDELINES & REGULATIONS FOR SELECTION, APPLICATION AND INSTALLATION OF EACH

ONE YEAR WARRANTY SHALL BEGIN AT SUBSTANTIAL

FIELD VERIFY ALL DIMENSIONS BEFORE BEGINNING THE

THE CONTRACTORS SHALL BE REQUIRED TO MAKE PROPER

PARTIALLY INDICATED TO AVOID NEEDLESS REPETITION FOR

AND COMPLETE WORK WHICH IS SHOWN SINGLE OR

THE SAKE OF BREVITY AND FOR REASONS OF CLARITY.

BASIS, SUPPORT OR FINISH FOR THE WORK WHICH IS SHOWN ON THE DRAWINGS WHETHER OR NOT THE SAME IS

PROTECT ALL JOBSITE CONDITIONS NOT SPECIFICALLY

THE CONTRACTOR SHALL MAINTAIN THE JOBSITE FREE AND

PURPOSES AND NOTIFY ARCHITECT.

OWNER AND ARCHITECT APPROVAL.

AFFECTED BY THE WORK.

COMPLETION.

CLEAR OF TRASH & DEBRIS.

SPECIFICALLY MENTIONED.

**LOCATION MAP** 

# **SCOPE OF WORK**

#### **BASEMENT**:

- ADD NEW BEDROOM AND CLOSET ADD BATHROOM AND REC SPACE

#### MAIN LEVEL:

- REAR ADDITION TO INCLUDE KITCHEN, FAMILY ROOM, MUD ROOM

CREATE POWDER ROOM AT PREVIOUS KITCHEN LOCATION

#### SECOND LEVEL:

- REAR ADDITION TO CREATE PRIMARY SUITE, LAUNDRY ROOM AND ENSUITE BATH FOR EXISTING BEDROOM. PRIMARY SUITE TO INCLUDE BEDROOM, BATHROOM AND WALK-IN CLOSETS. -RENOVATE EXISTING HALL BATH

# **DRAWING LIST**

SHEET TITLE	SHEET NUM.
Cover Sheet	A000
Site Plan	CIV100
Existing and Demolition Plans	A100
Existing and Demolition Plans	A101
Existing and Demolition Plans	A102
Existing Elevations	A103
Proposed Plans	A200
Proposed Plans	A201
Proposed Plans	A202
Proposed Plans	A203
Proposed Plans	A204
Elevations	A300
Elevations	A301
Sections	A400
Sections	A401
Sections	A402
Electrical Plans	E100
Electrical Plans	E101
Electrical Plans	E102
Thermal and Energy Plans	EC100
Structural Notes and Details	S100
Structural Plans	S101
Structural Plans	S102
Structural Plans	S103
Structural Plans	S104

#### S104

CONTRACTORS SHALL FURNISH AND INSTALL ALL WORK AND MATERIALS AS MAY BE PROPER AND SUITABLE PREPARATION

## **CONTACT INFORMATION**

S105

S106

S107

#### **OWNER:**

Structural Plans

Wind Bracing Plans

Wind Bracing Plans

LACY RICE 7315 BROOKVILLE ROAD CHEVY CHASE, MD 20815

#### **ARCHITECT:**

MCD STUDIO, LLC 4948 ST. ELMO AVENUE, SUITE 304

BETHESDA, MD 20814 CONTACT: MATT MCDONALD PHONE: 301-215-7277

#### **STRUCTURAL ENGINEER:**

PHONE: 301-215-7277

APAC ENGINEERING, INC 2110 SEMINARY ROAD SILVER SPRING, MD 20910 CONTACT: ROBERT WIXSON

### **BUILDING DATA**

R-60 **ZONING:** 

NORTH

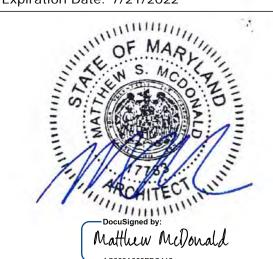
USE: RESIDENTIAL - SINGLE FAMILY DETACHED

SEE SITE PLAN FROM CAS ENGINEERING FOR ADDITIONAL SITE DATA

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#### **Architect's Professional Certification**

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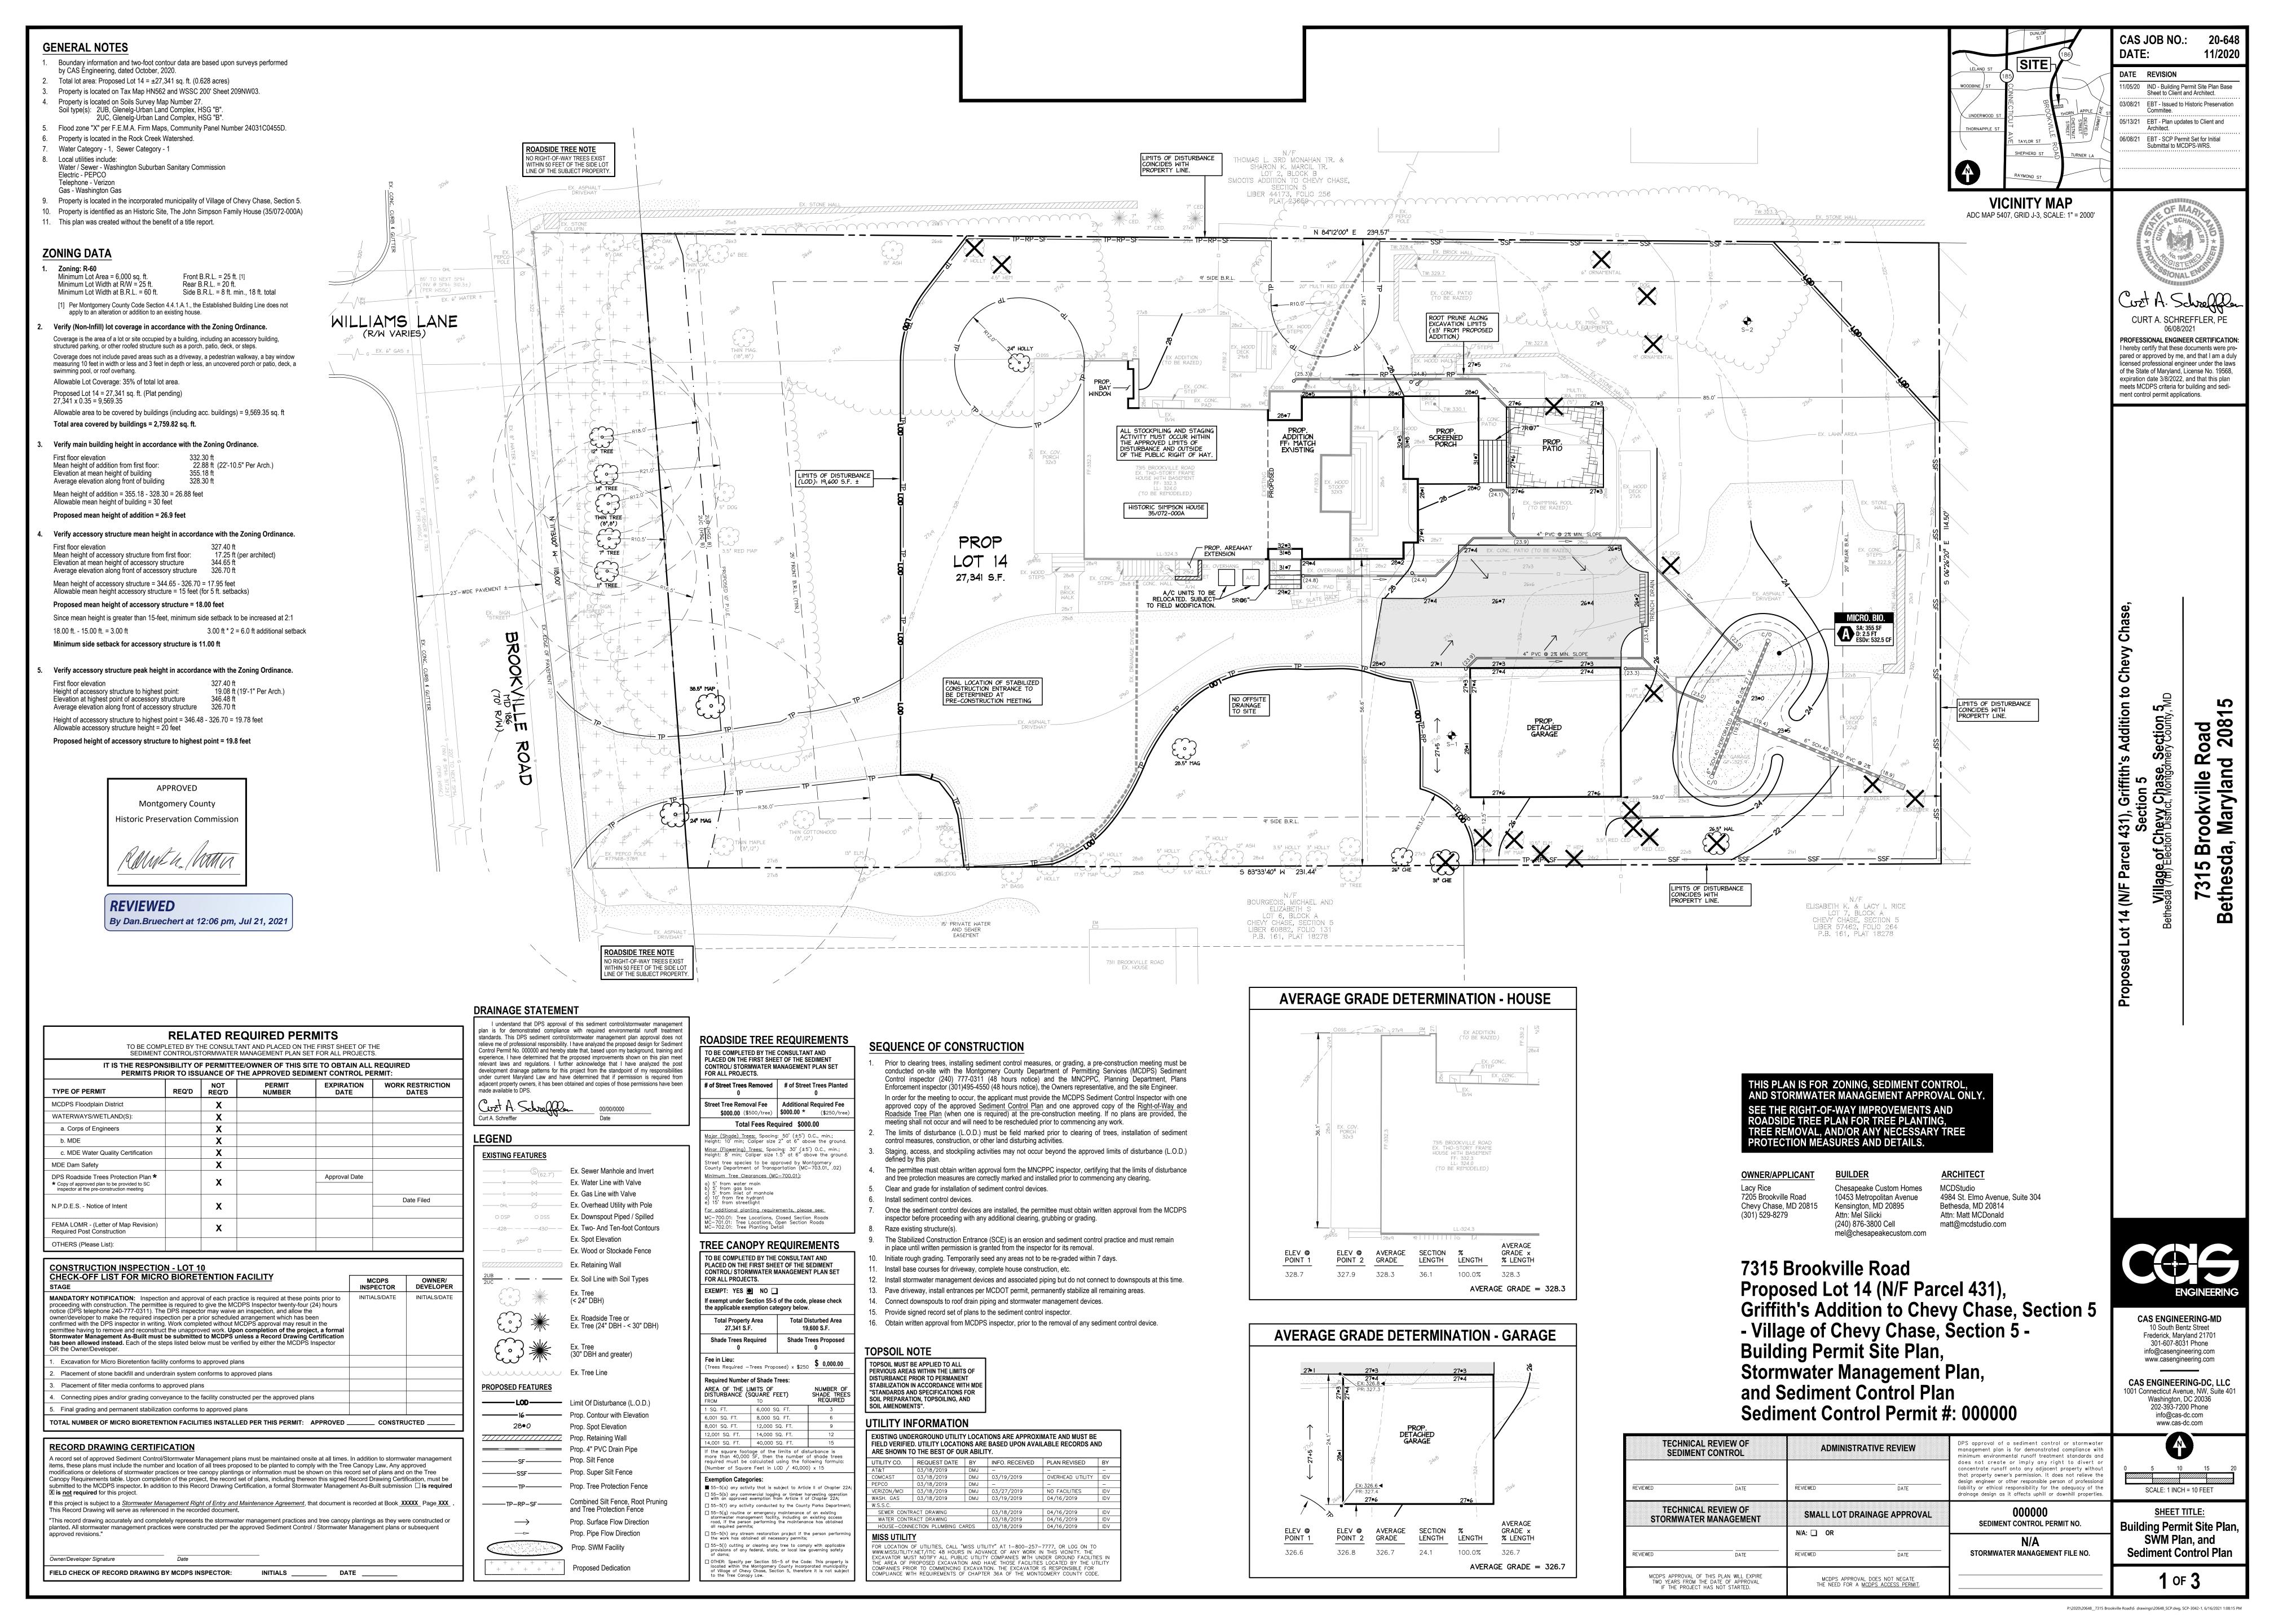
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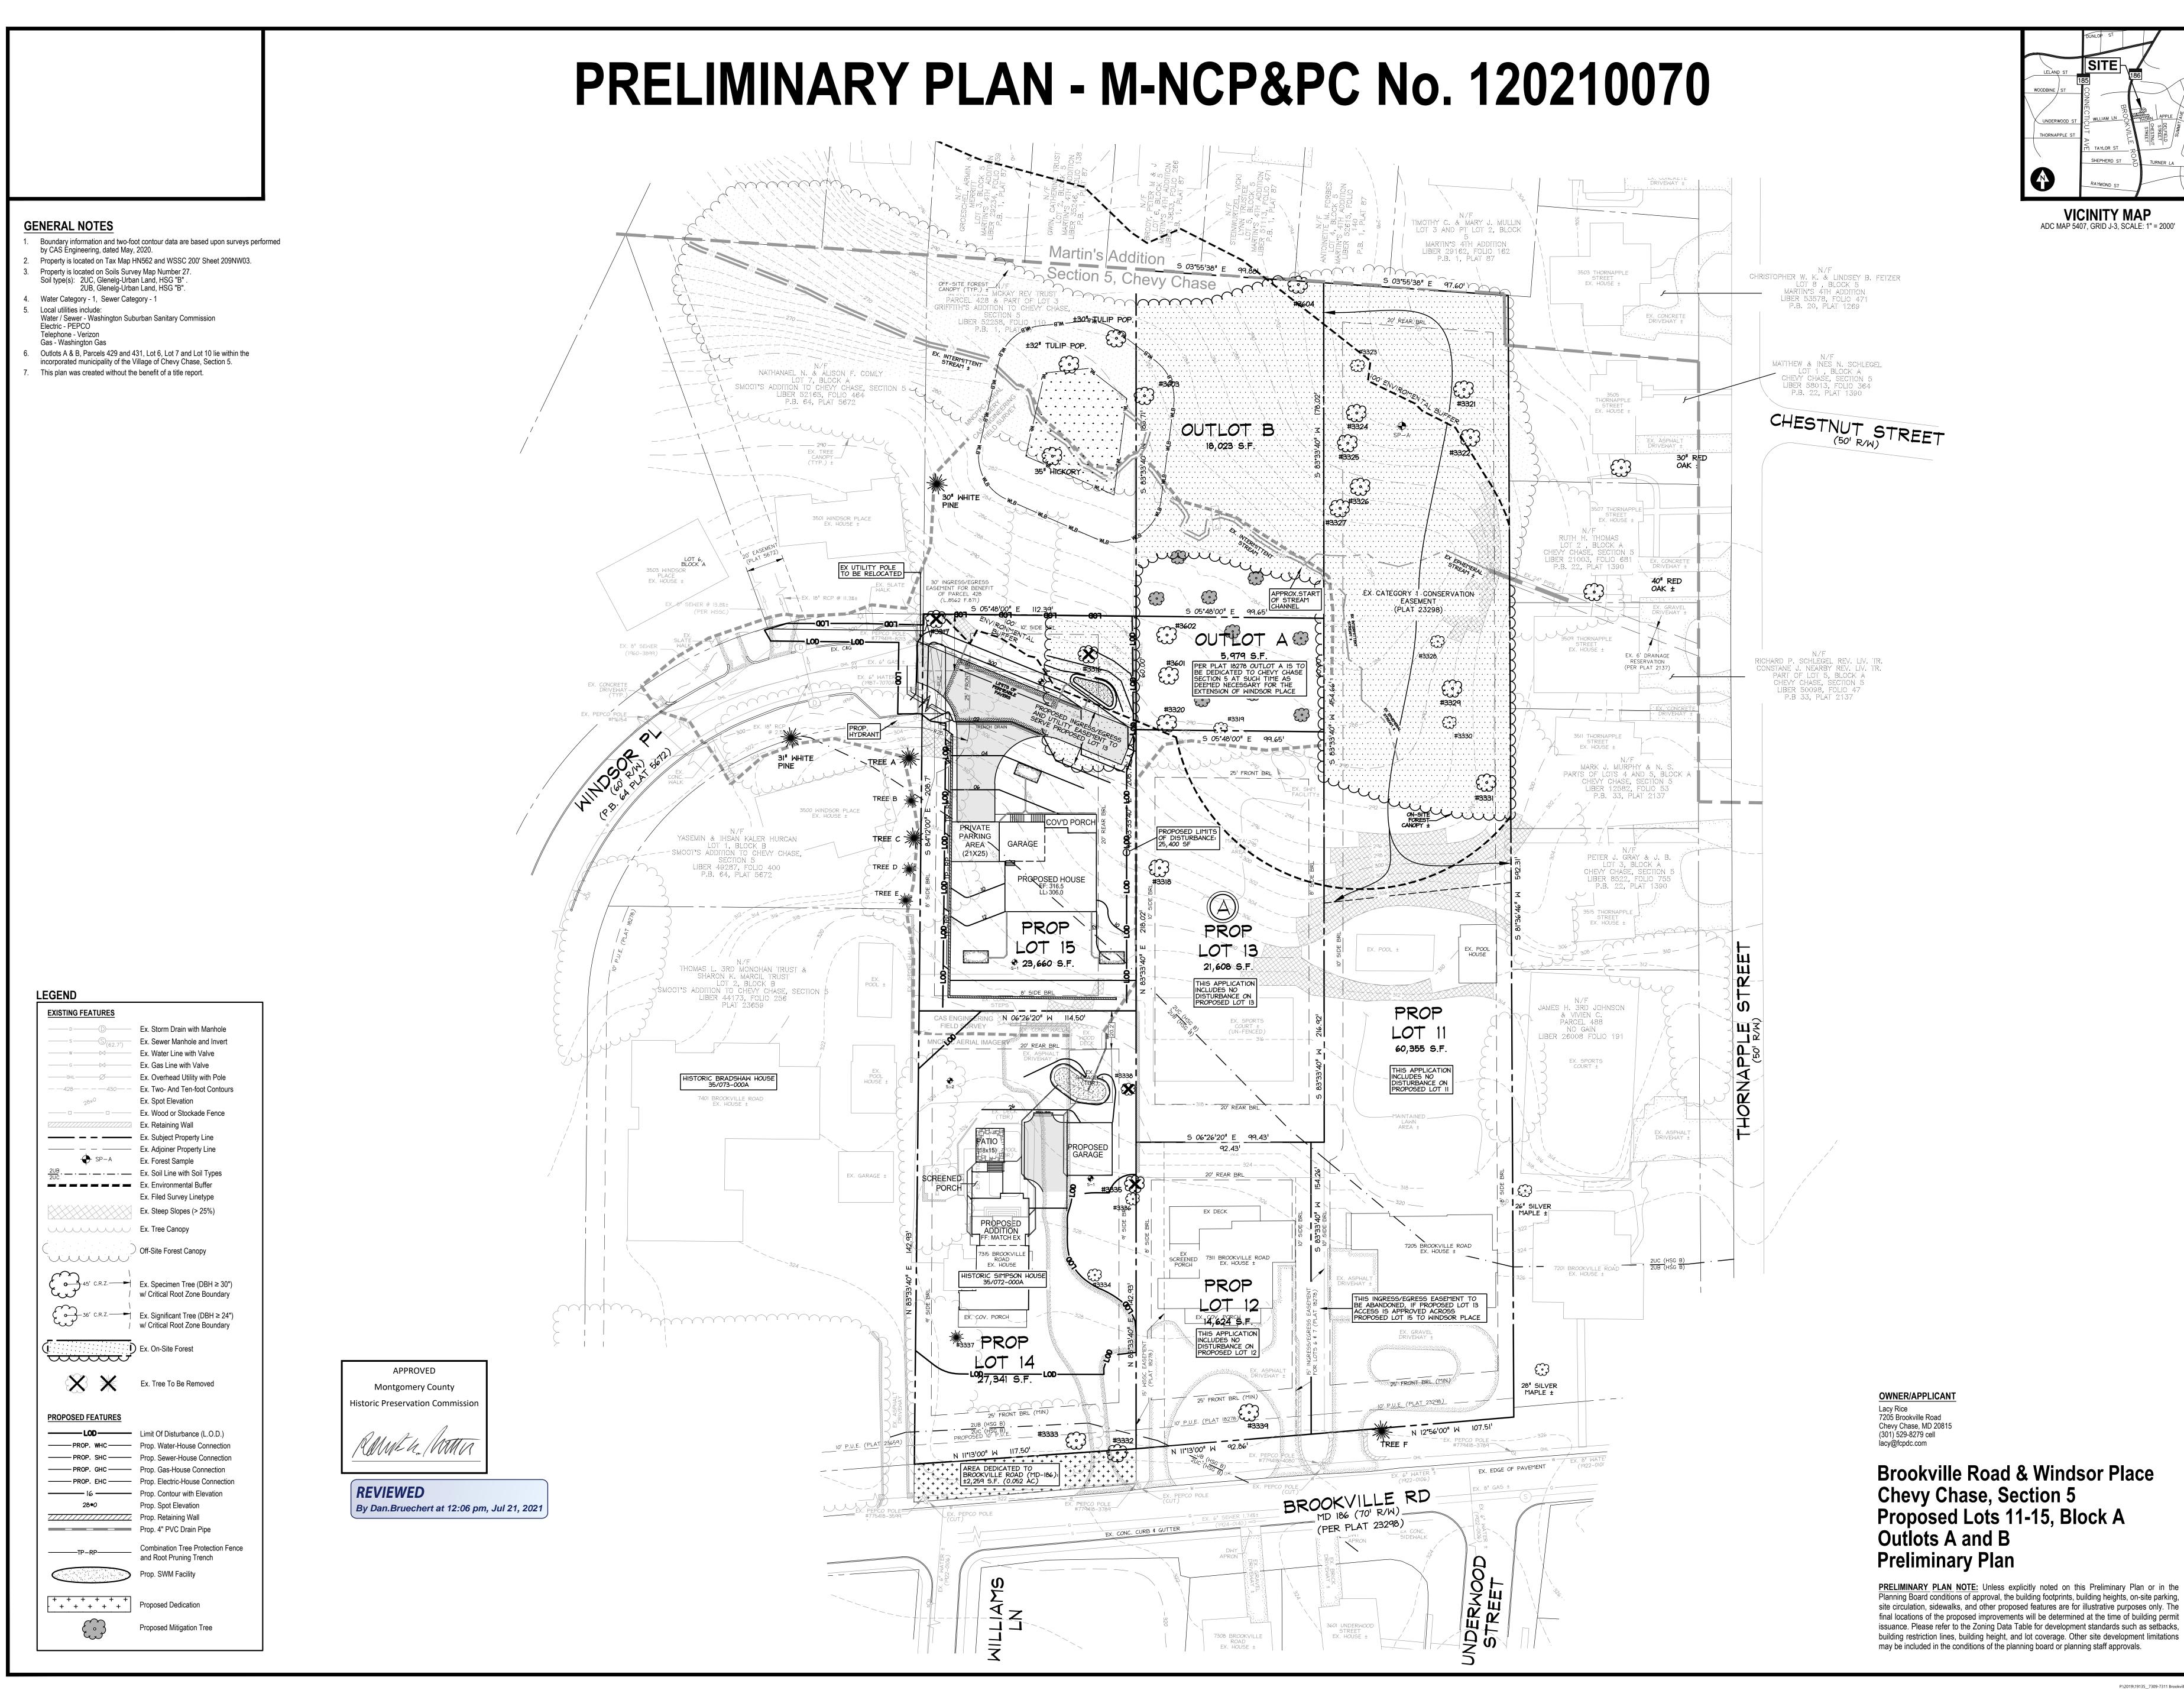
20-043

Project Number: Client Name: Lacy Rice Project Status: As Built Conditions Preliminary Design ☐ Design Development Permit Submission Construction Documents Construction Administration Drawing Issue Date: 5-25-2021 Client Approval: **Revision Schedule** Date

Drawn by: MM Checked by: Scale: 1/4" = 1'-0" Sheet Name:

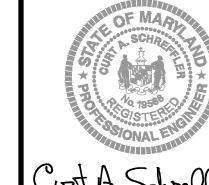
**Cover Sheet** 





DATE REVISION 11/04/20 EBT - Initial Preliminary Plan 12/04/20 EBT - Final Preliminary Plan submittal 06/11/21 EBT- Post DRC Submittal, Revised

**VICINITY MAP** ADC MAP 5407, GRID J-3, SCALE: 1" = 2000'



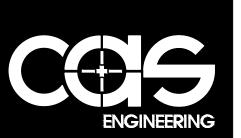
CURT A. SCHREFFLER, PE

of the State of Maryland, License No. 19568, expiration date 3/8/2022, and that this plan meets MCDPS criteria for building and sedi-

ment control permit applications.

**TAX MAP: HN562** WSSC: 209NW03

Outl 2747



**CAS ENGINEERING-MD** 10 South Bentz Street Frederick, Maryland 21701 301-607-8031 Phone info@casengineering.com www.casengineering.com

CAS ENGINEERING-DC, LLC 1001 Connecticut Avenue, NW, Suite 401 info@cas-dc.com www.cas-dc.com

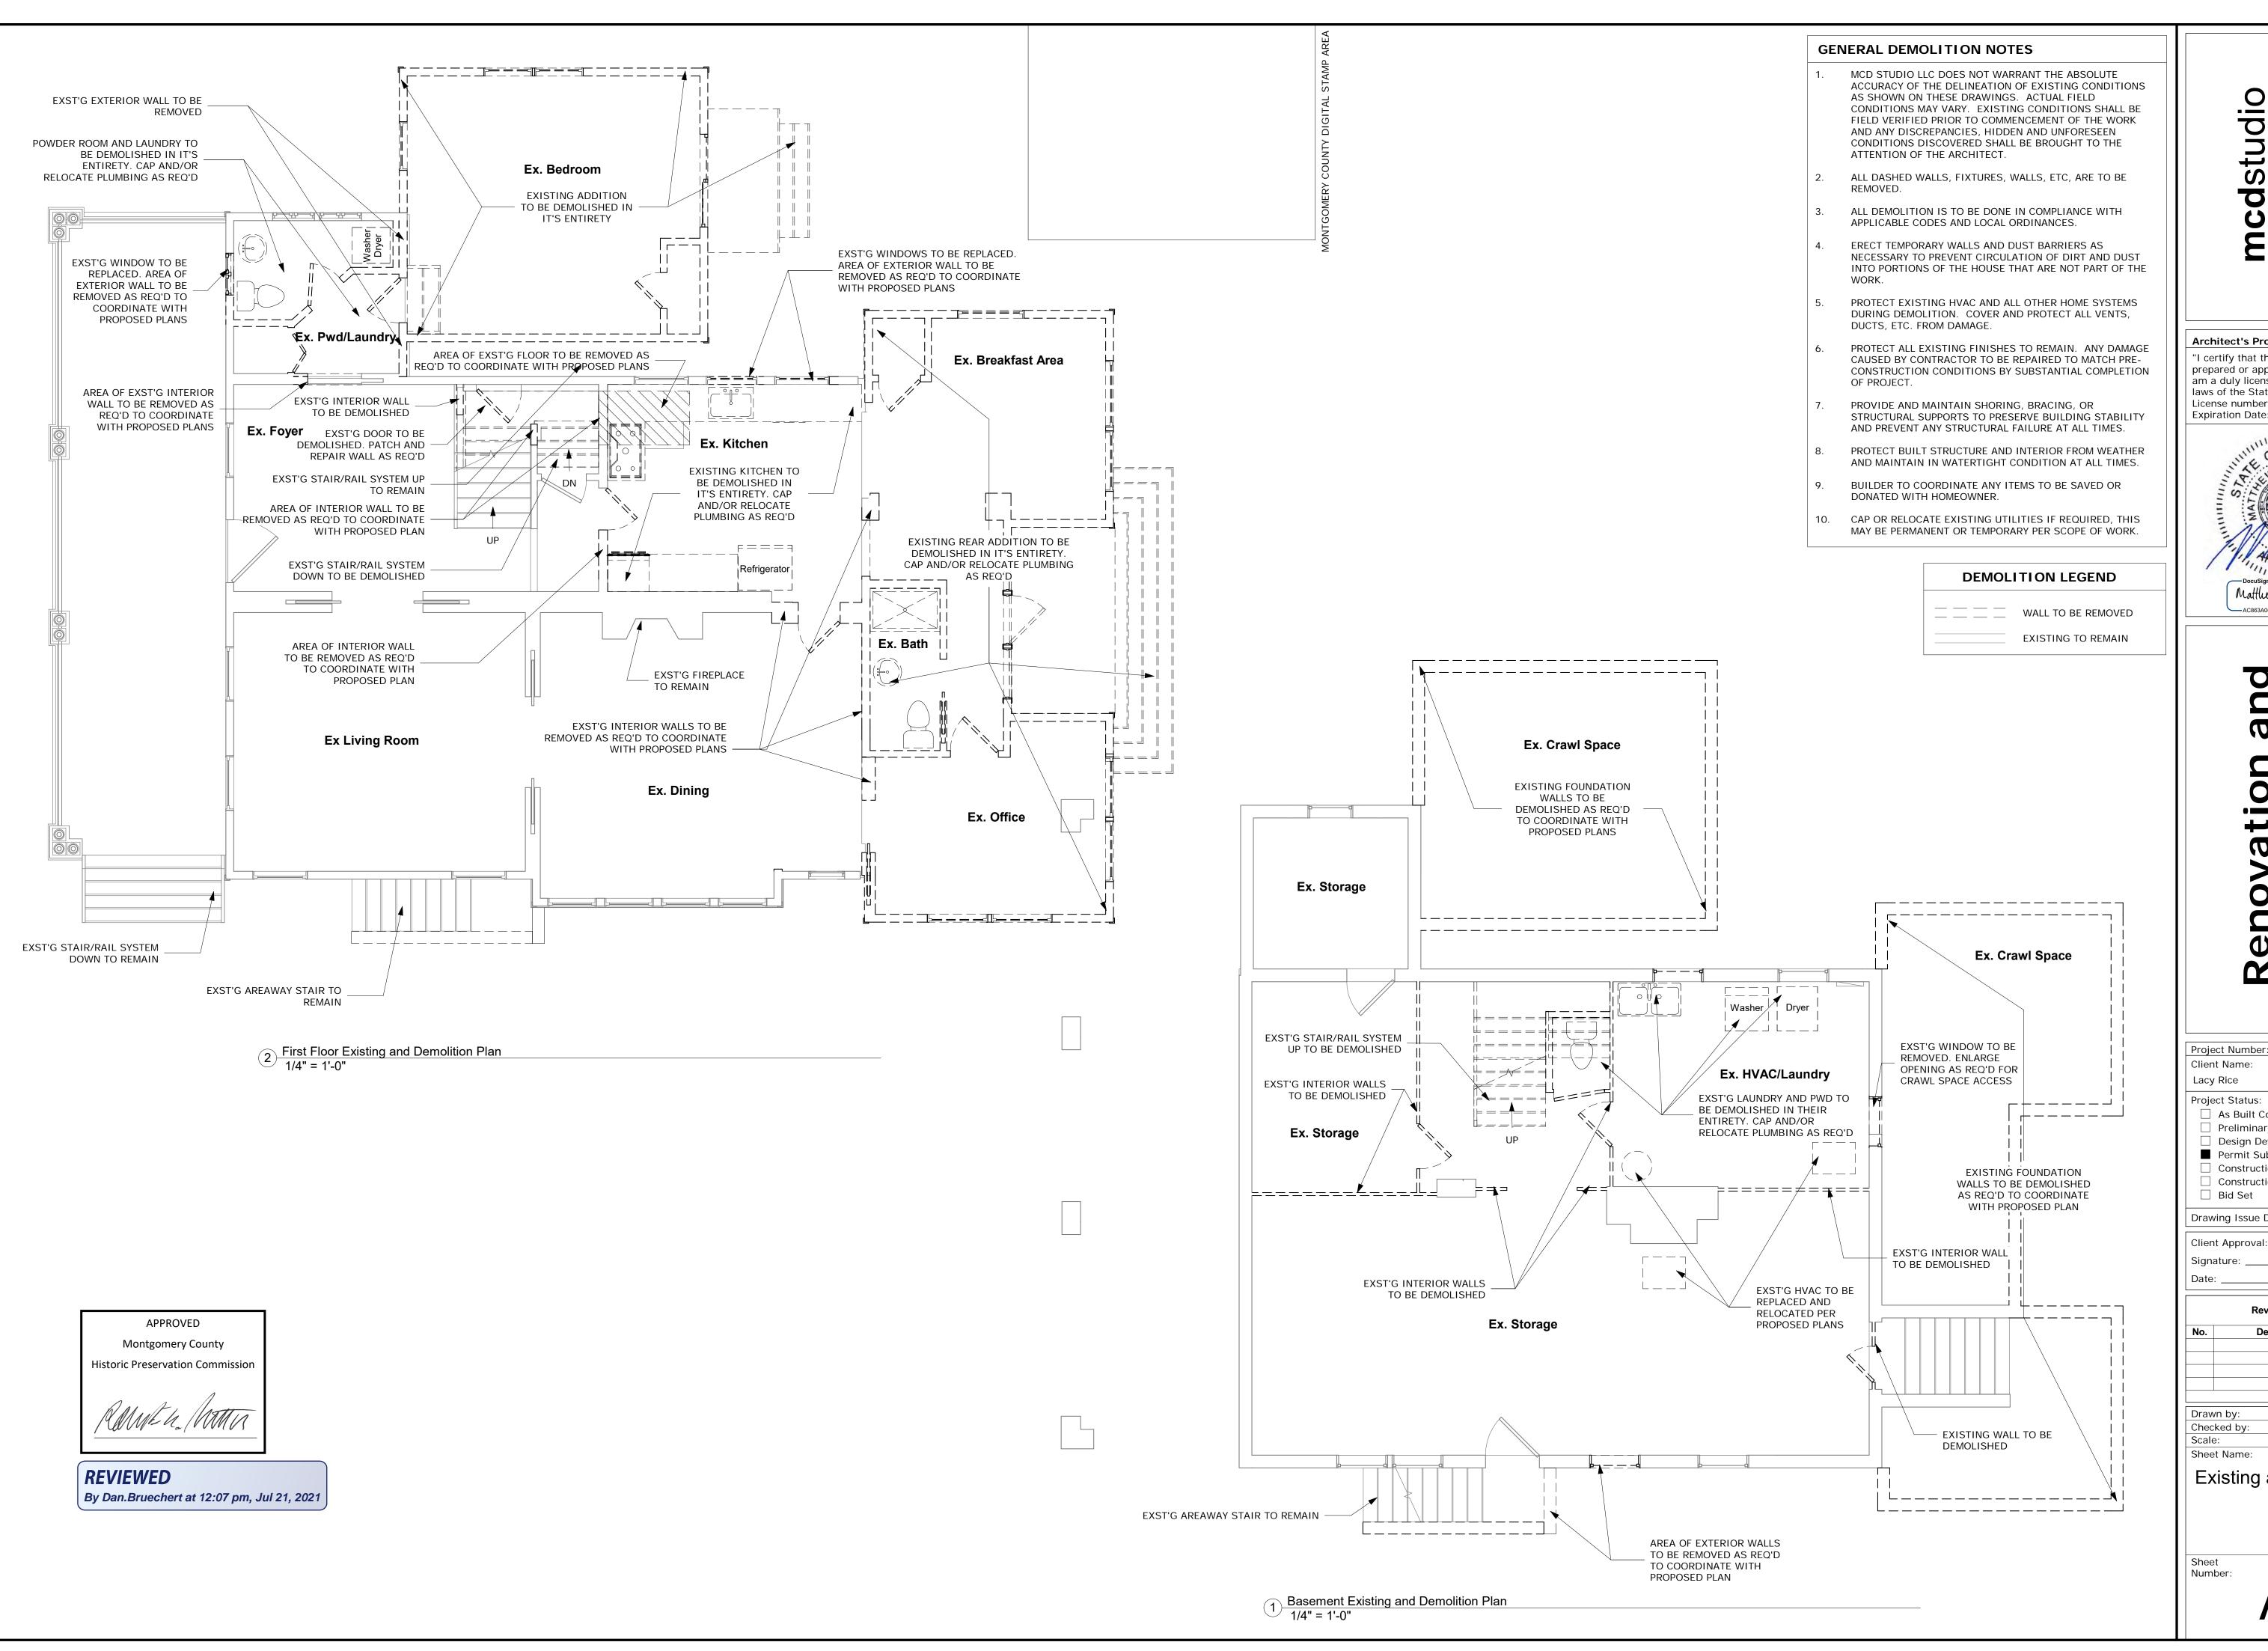
**\(\frac{1}{2}\)** SCALE: 1 INCH = 30 FEET

SHEET TITLE:

**Preliminary Plan** 

PP-6

P:\2019\19135\_7309-7311 Brookville Road\6 drawings\19135B\_PP.dwg, PP6\_Preliminary Plan, 6/11/2021 8:00:10 AM



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Expiration Date: 7/21/2022



Matthew McDonald

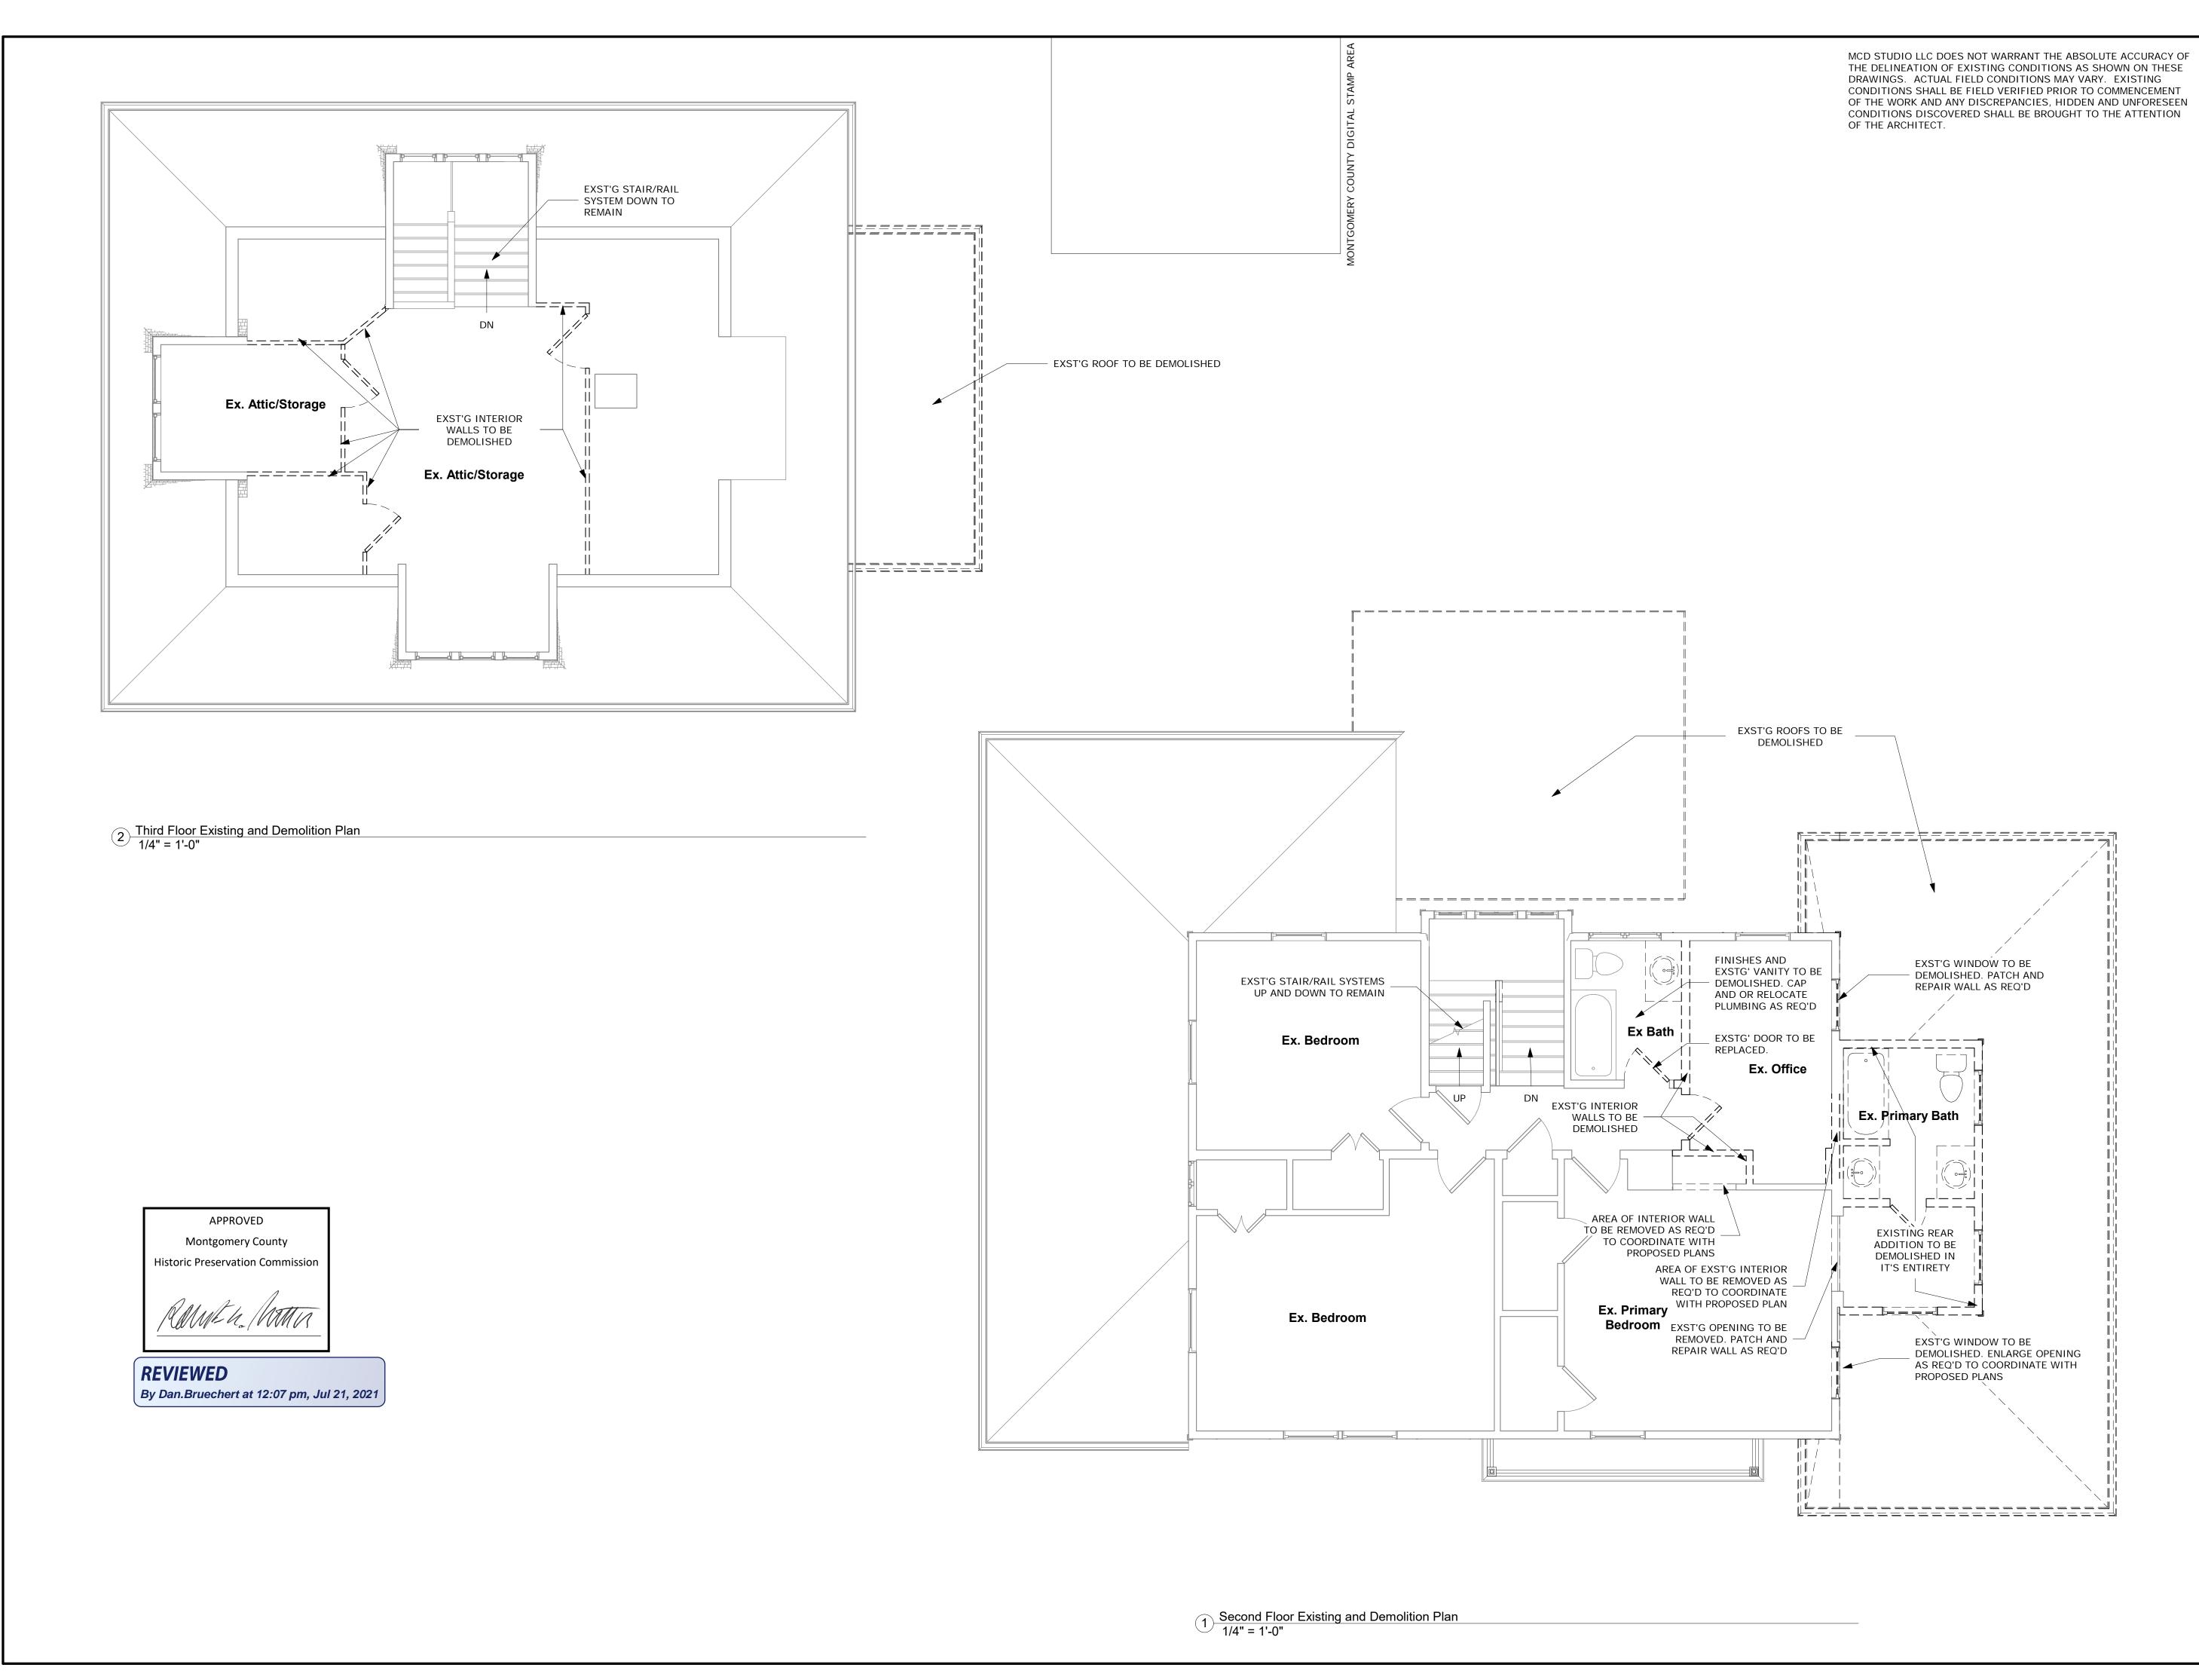
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☐ Construction Docume	nts
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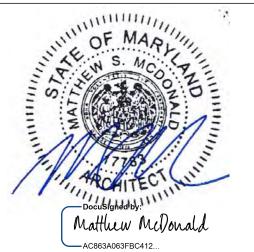
**Existing and Demolition** 



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prepared or approved by me, and that I am a duly licensed architect under the laws of the State of Maryland, License number 17783, Expiration Date: 7/21/2022



Project Number:	20-043	
Client Name:		
Lacy Rice		
Project Status:  As Built Conditions Preliminary Design Design Development Permit Submission Construction Documents Construction Administratio Other	n	
Drawing Issue Date:	5-25-2021	
Client Approval:		

Signature: Revision Schedule

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Sheet Name:

Existing and Demolition Plans

#### Architect's Professional Certification

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Project Number:	20-043
Client Name:	
Lacy Rice	
Project Status:	
☐ As Built Condit	ions
☐ Preliminary De	sign
☐ Design Develop	oment
Permit Submiss	sion
Construction D	ocuments

5-25-2021 Drawing Issue Date:

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Existing and Demolition Plans

MM

1/4" = 1'-0"



20-043

APPROVED

Montgomery County

**Historic Preservation Commission** 

By Dan.Bruechert at 12:07 pm, Jul 21, 2021

**REVIEWED** 

#### DOOR SCHEDULE NOTES

- DOORS WITH GLAZING ARE TO BE MINIMUM DOUBLE PANE INSULATED GLASS, LOW-E, ENERGY EFFICIENT WINDOWS;
- GLASS DOORS, SIDE GLASS PANELS, TUB AND SHOWER ENCLOSURES AND OTHER GLAZING IN HAZARDOUS LOCATIONS SHALL BE SAFETY GLAZED PER CURRENT BUILDING CODES.

MAX. U-FACTOR = 0.32; MAX. SHGC = 0.40.

- DOOR STYLE TBD BY OWNER
- DOOR HARDWARE TBD BY OWNER

#### **GENERAL BASEMENT NOTES**

- FINISH FLOOR MATERIAL TBD BY OWNER.
- PAINTED WALL TO BE GYP. BD. ASSUME 1 COLOR PER ROOM, 1 COAT PRIMER AND TWO COATS FINISH PAINT, BENJAMIN MOORE OR EQUAL - COLOR TBD BY OWNER.
  - CEILING TO BE PAINTED GYP. BD. ASSUME 1 COLOR, 1 COAT PRIMER AND TWO COATS FINISH PAINT - COLOR TBD BY OWNER
  - BASE MOLDING TBD BY OWNER.
  - WINDOW AND DOOR TRIM TBD BY OWNER.
  - STAIRS TO BE HARDWOOD TREAD W/RISER FOR PAINT.
  - BALUSTER AND HANDRAIL PER 2018 IRC SECTION R312.
- GENERAL CABINETRY, COUNTERTOP AND VANITY LAYOUTS ARE SHOWN - FINAL LAYOUT AND DESIGN BY OTHERS.
- GENERAL PLUMBING FIXTURE AND LOCATIONS SHOWN. FINAL SELECTION TO BE DETERMINED BY OWNER.
- 10. CONFIRM SHOWER AND TUB SHAMPOO NICHES WITH OWNER
- 11. PROVIDE PAINTED GYP. BD. BULKHEAD AROUND DROPPED BEAM LOCATIONS.

#### **GENERAL PLAN NOTES**

- ALL DIMENSIONS ARE FROM FACE OF STUD TO FACE OF STUD,
- ALL INTERIOR WALLS SHALL BE NOM. 2X4 WOOD STUD @ 16"
- ALL EXTERIOR WALLS SHALL BE NOM. 2X6 WOOD STUD @ 16" O.C. WITH 1/2" GWB ON INTERIOR SIDE, R-21 MIN. BATT INSULATION WITHIN STUD CAVITIES AND 7/16" OSB ON
- ALL BATHROOMS WITHOUT WINDOWS SHALL BE VENTED TO
- GLASS DOORS, SIDE GLASS PANELS, TUB AND SHOWER ENCLOSURES AND OTHER GLAZING IN HAZARDOUS
- PROVIDE SOUND ATTENUATING INSULATION AT ALL INTERIOR
- THE MAXIMUM LENGTH OF A 4" DIAMETER EXHAUST VENT DEGREE BED AND 5' FOR EACH 90 DEGREE BEND SHALL APPLY.
- REVIEW ALL DROPPED BEAM HEIGHTS WITH ARCHITECT PRIOR TO FINAL CLOSE-IN.

- UNLESS NOTED OTHERWISE.
- O.C. WITH 1/2"GWB ON BOTH SIDES, U.N.O.
- EXTERIOR SIDE, U.N.O.
- THE OUTSIDE.
- LOCATIONS SHALL BE SAFETY GLAZED PER CURRENT BUILDING
- CLOTHES DRYER VENT SYSTEMS SHALL BE INDEPENDENT OF ALL OTHER SYSTEMS AND SHALL BE VENTED TO THE EXTERIOR OF THE BUILDING. FLEXIBLE DUCT CONNECTORS SHALL NOT BE CONCEALED WITHIN WALLS OR CEILING.
- SHALL NOT EXCEED 25' FROM THE DRYER TO THE WALL OR ROOF TERMINATION. A REDUCTION OF 2.5' FOR EACH 45

Expiration Date: 7/21/2022 Matthew McDonald

**Architect's Professional Certification** 

prepared or approved by me, and that I

am a duly licensed architect under the

laws of the State of Maryland,

License number 17783,

"I certify that these documents were

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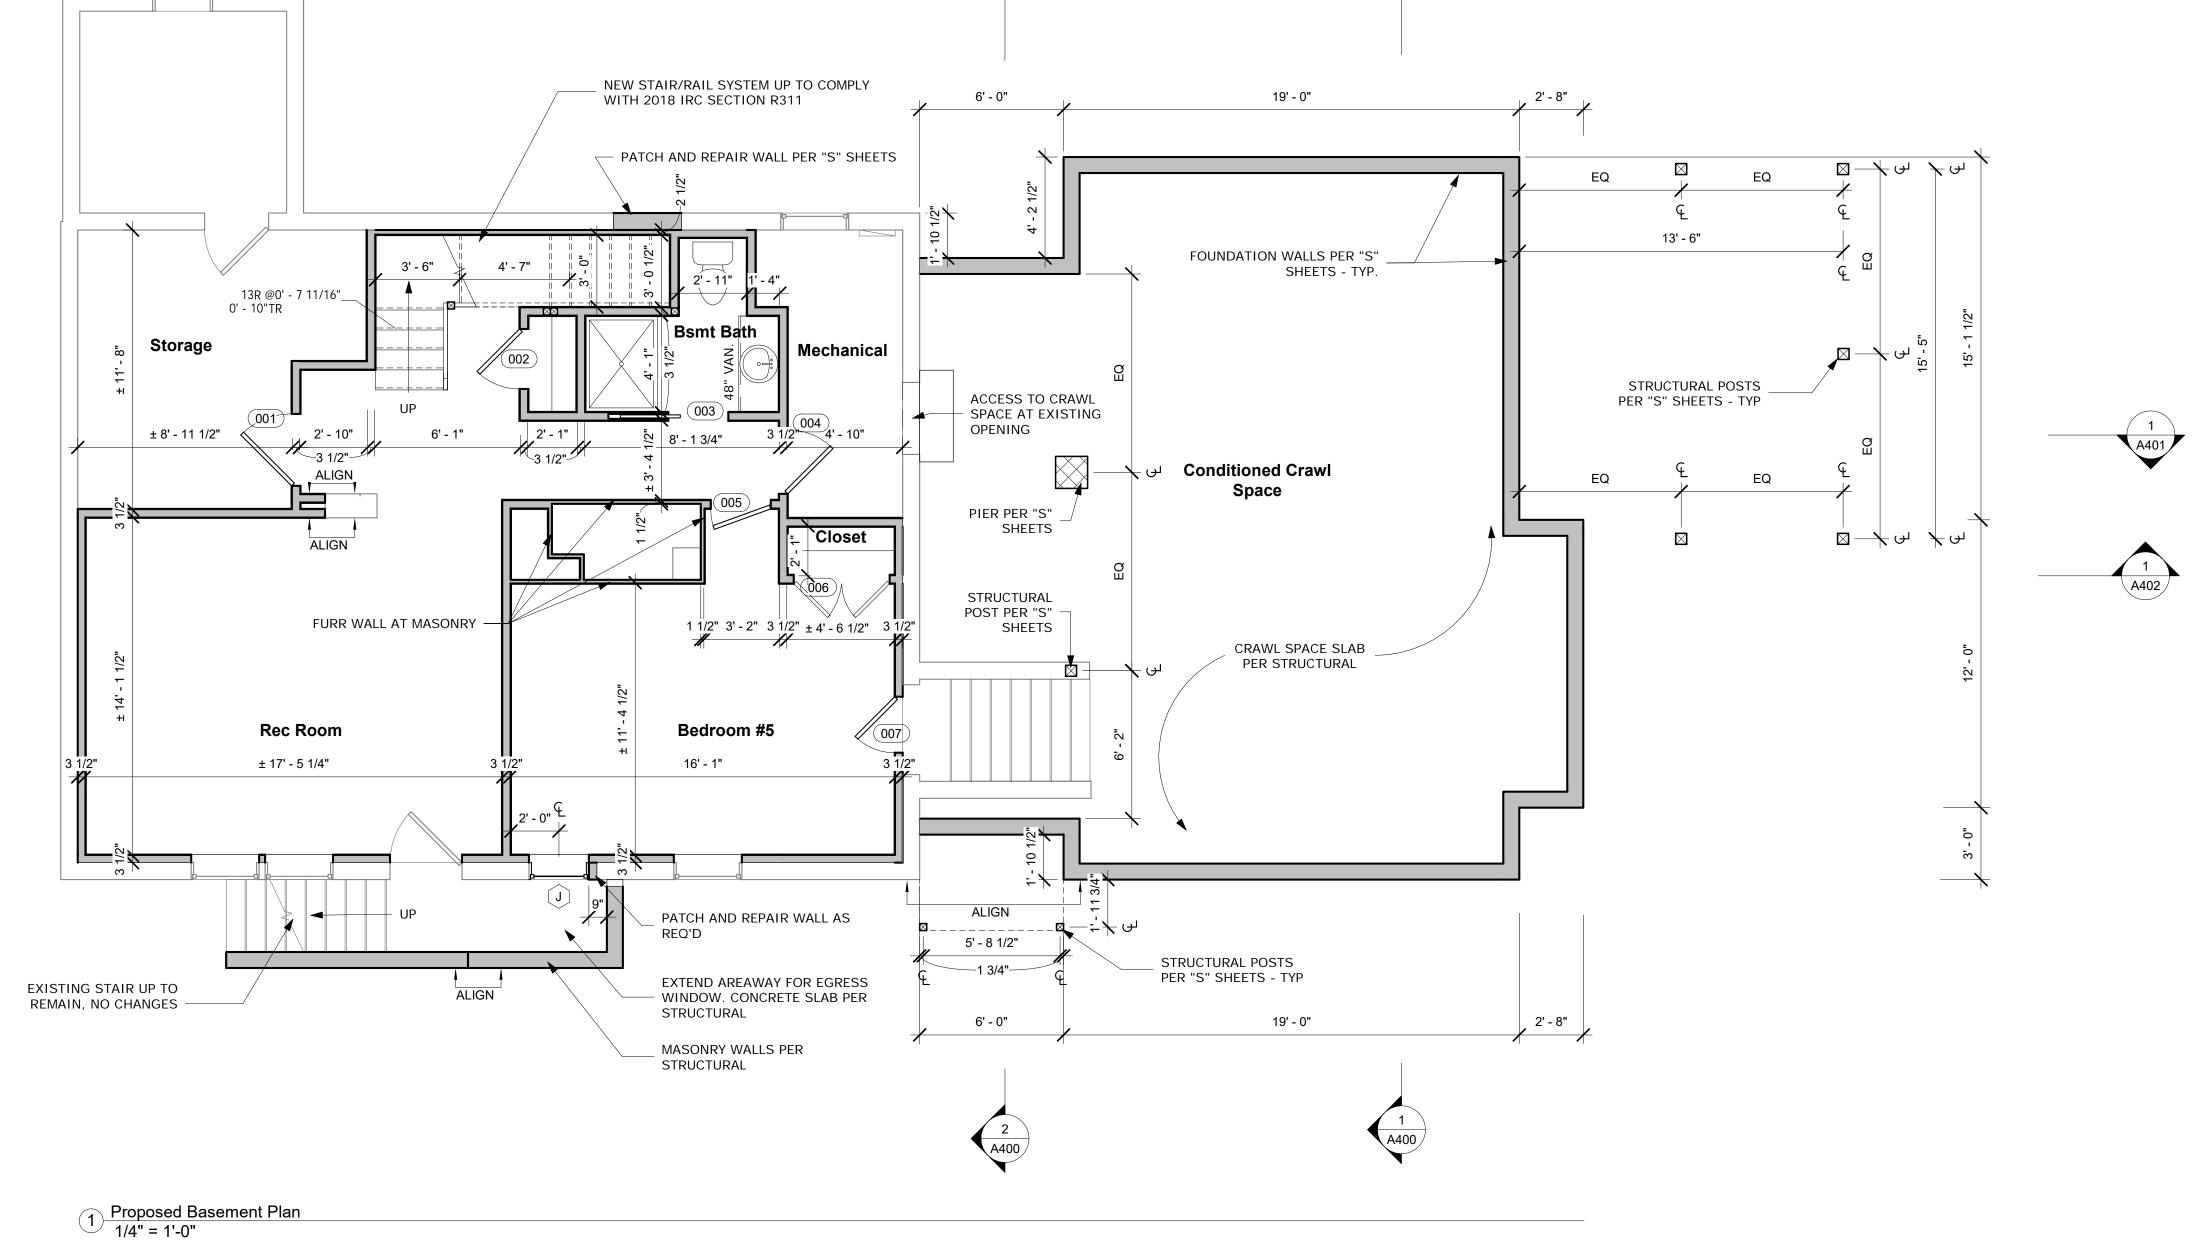
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Project Number: 20-043 Client Name: Lacy Rice Project Status: As Built Conditions Preliminary Design ☐ Design Development Permit Submission Construction Documents Construction Administration ☐ Bid Set 5-25-2021 Drawing Issue Date: Client Approval:

Signature: **Revision Schedule** Date

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**Proposed Plans** 

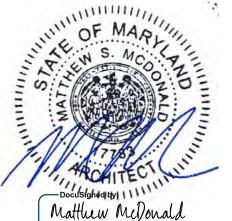


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t. Elmo Ave, Suite 304 thesda, MD 20814 (301) 215-7277

Expiration Date: 7/21/2022



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Project Number: Client Name: Lacy Rice Project Status: ☐ As Built Conditions ☐ Preliminary Design ☐ Design Development 20-043

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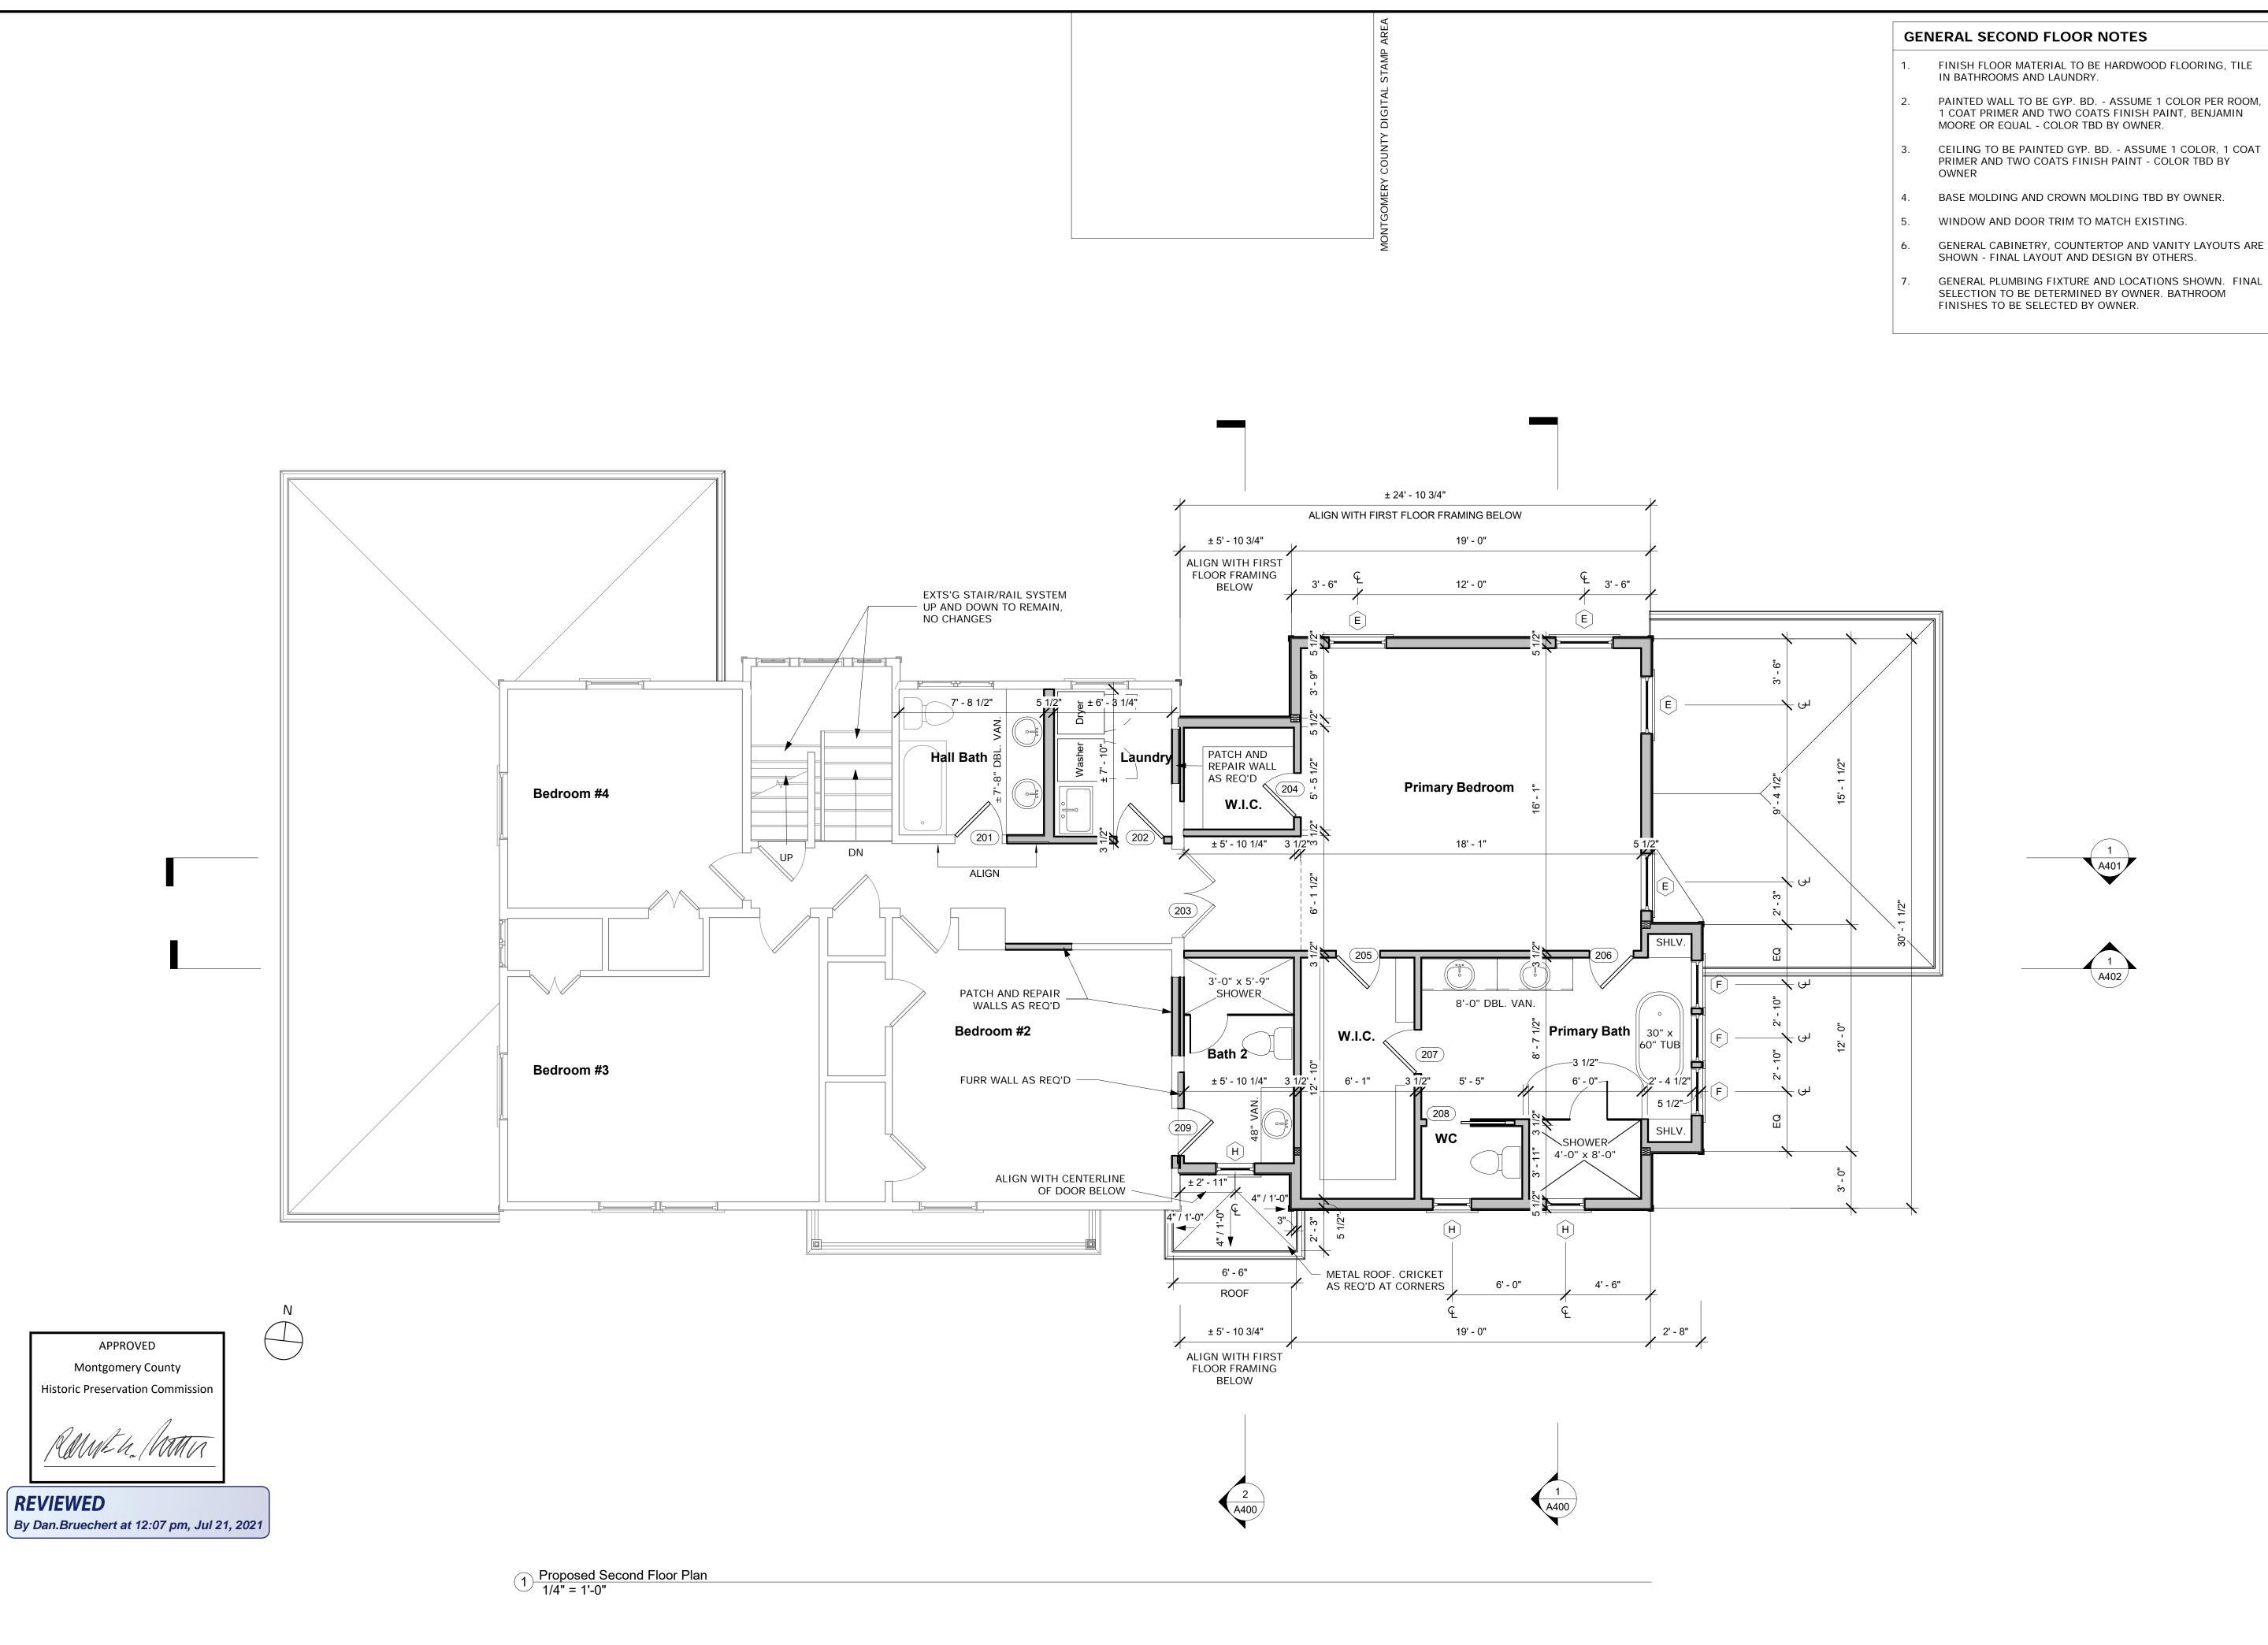
Permit Submission ☐ Construction Documents Construction Administration

5-25-2021 Drawing Issue Date: Client Approval:

**Revision Schedule** 

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Proposed Plans



FINISH FLOOR MATERIAL TO BE HARDWOOD FLOORING, TILE

PAINTED WALL TO BE GYP. BD. - ASSUME 1 COLOR PER ROOM, 1 COAT PRIMER AND TWO COATS FINISH PAINT, BENJAMIN

CEILING TO BE PAINTED GYP. BD. - ASSUME 1 COLOR, 1 COAT PRIMER AND TWO COATS FINISH PAINT - COLOR TBD BY

GENERAL CABINETRY, COUNTERTOP AND VANITY LAYOUTS ARE

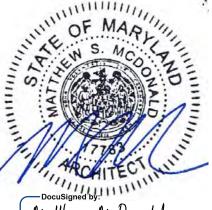
SELECTION TO BE DETERMINED BY OWNER. BATHROOM

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Expiration Date: 7/21/2022



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Project Number:	20-043
Client Name:	
Lacy Rice	
Project Status:	
☐ As Built Conditions	
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☐ Construction Administration	
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Drawing Issue Date: 5-25-2021 Client Approval:

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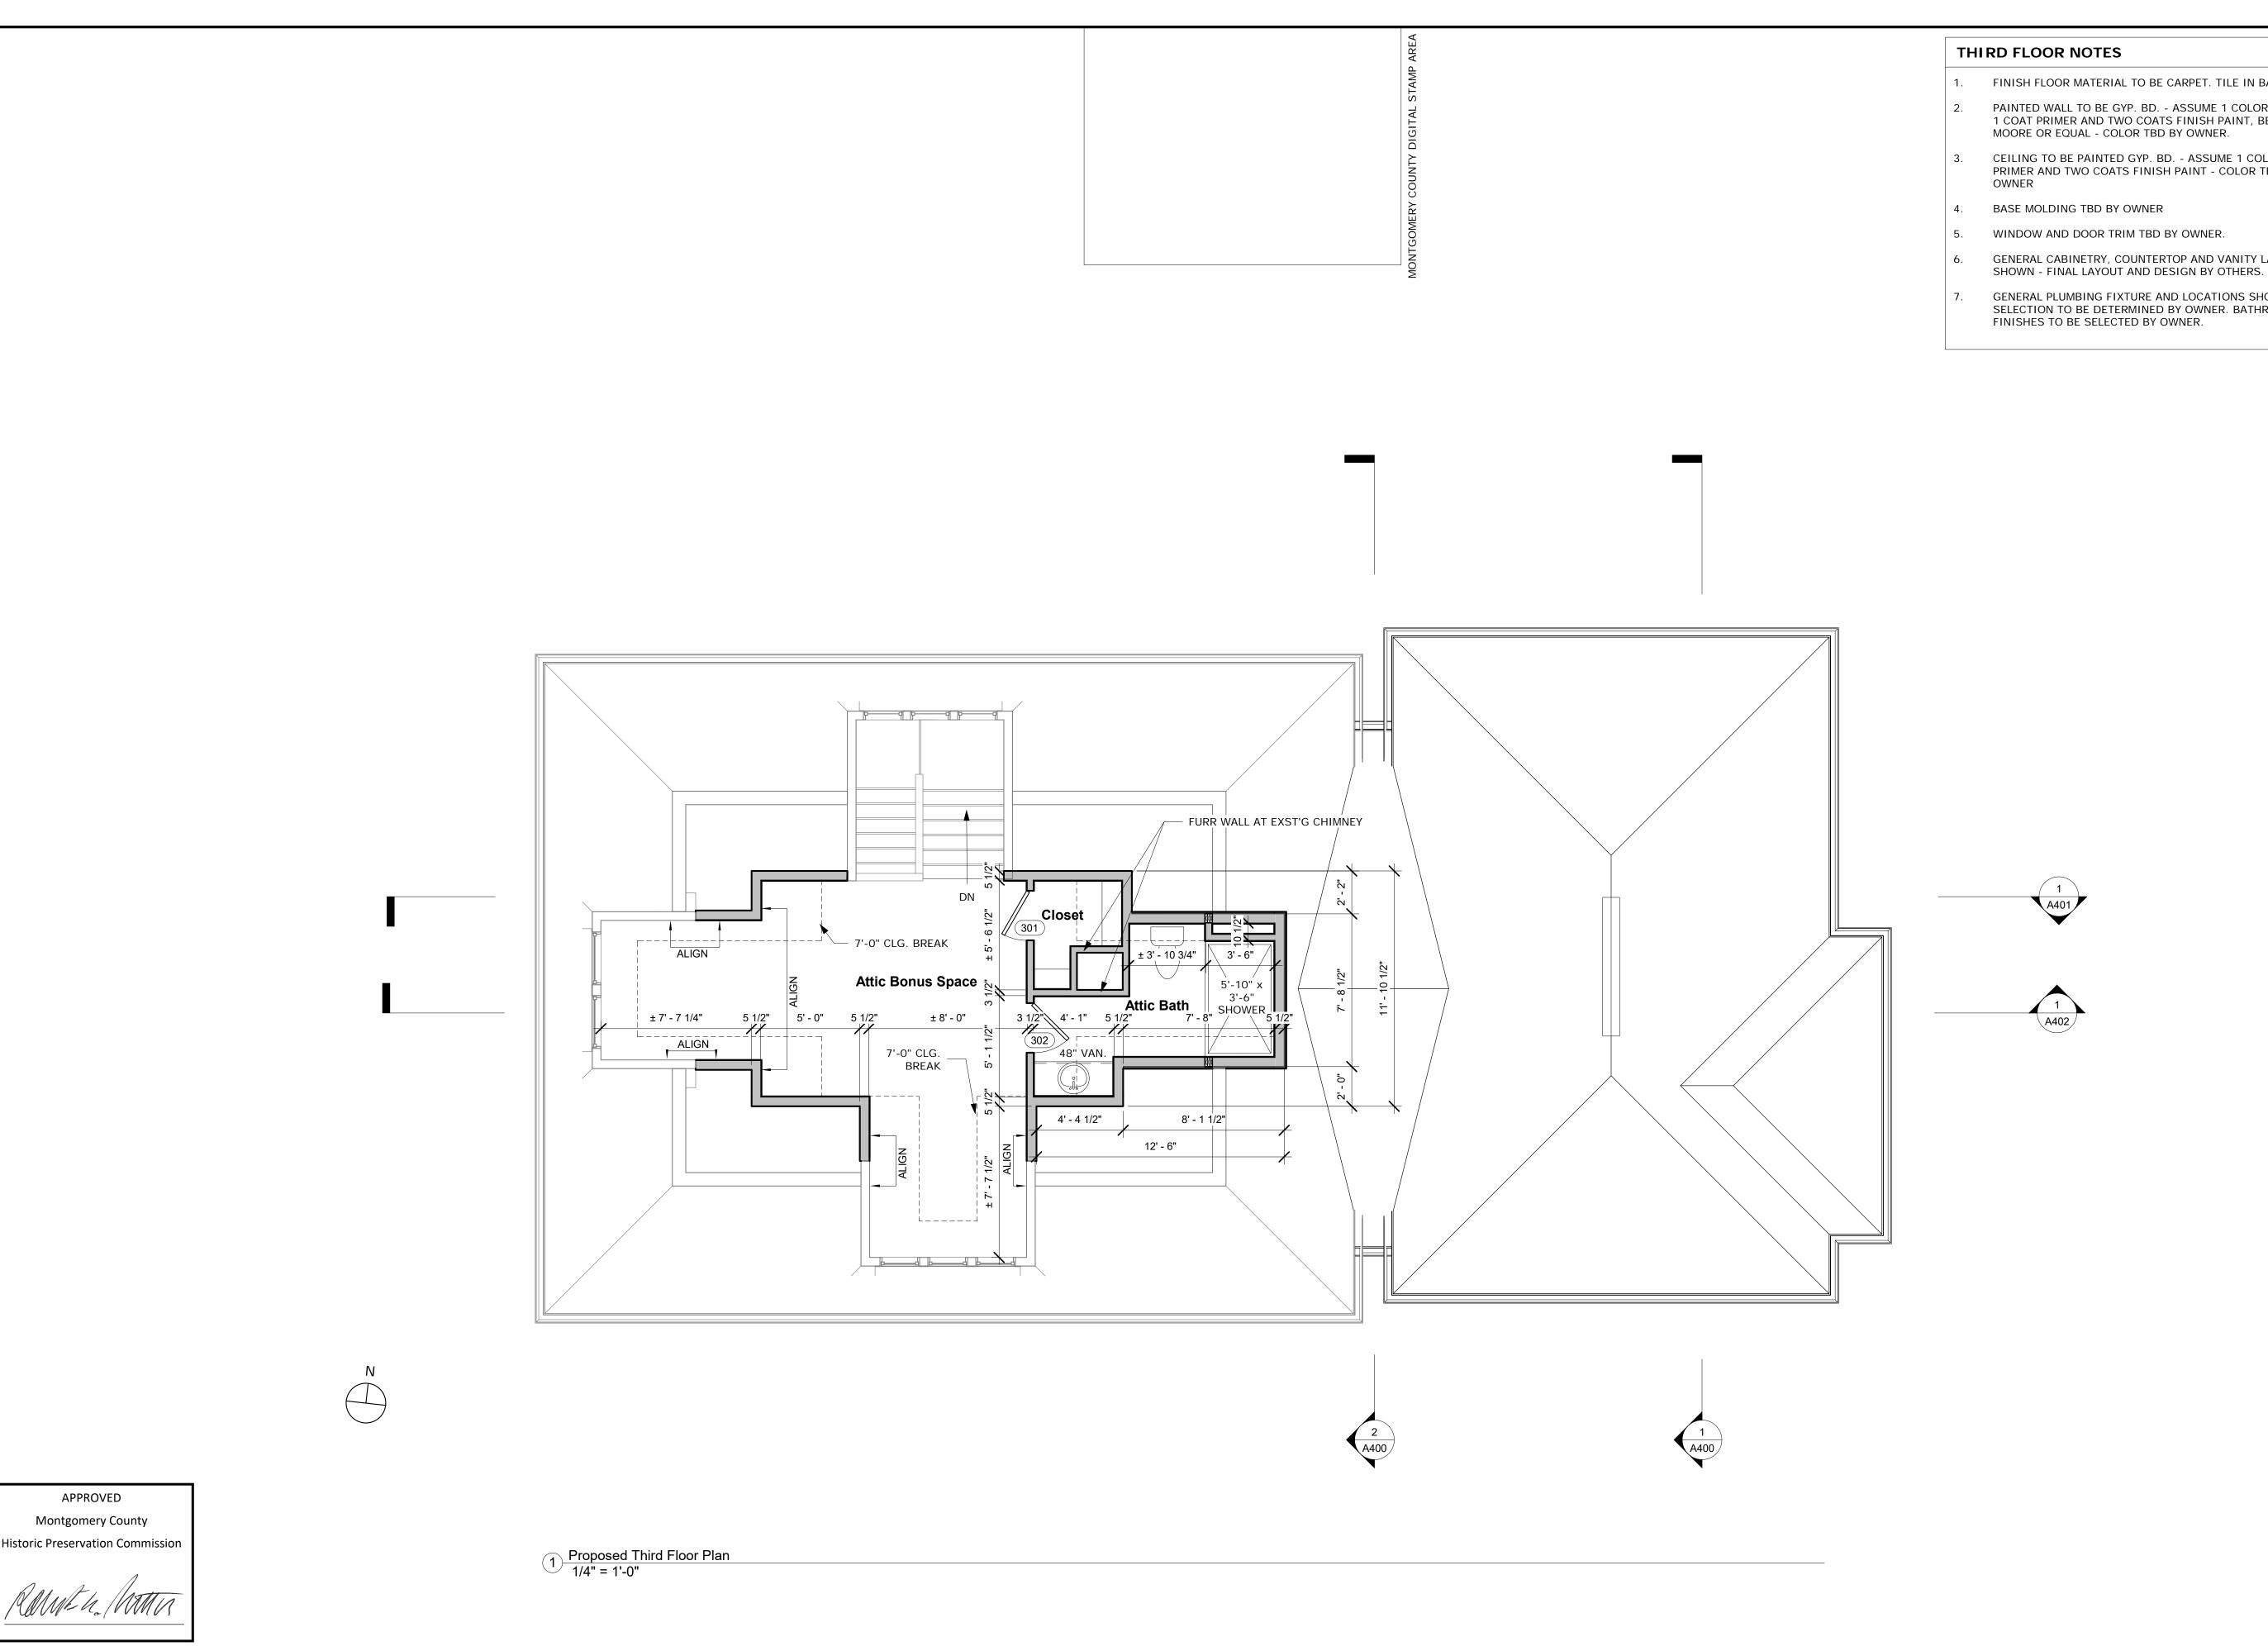
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Proposed Plans

Sheet Number:

REVIEWED

By Dan.Bruechert at 12:07 pm, Jul 21, 2021



- FINISH FLOOR MATERIAL TO BE CARPET. TILE IN BATHROOM.
- PAINTED WALL TO BE GYP. BD. ASSUME 1 COLOR PER ROOM, 1 COAT PRIMER AND TWO COATS FINISH PAINT, BENJAMIN MOORE OR EQUAL - COLOR TBD BY OWNER.
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- GENERAL CABINETRY, COUNTERTOP AND VANITY LAYOUTS ARE
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Expiration Date: 7/21/2022



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Project Number: 20-043 Client Name: Lacy Rice Project Status: ☐ As Built Conditions ☐ Preliminary Design ☐ Design Development Permit Submission ☐ Construction Documents Construction Administration

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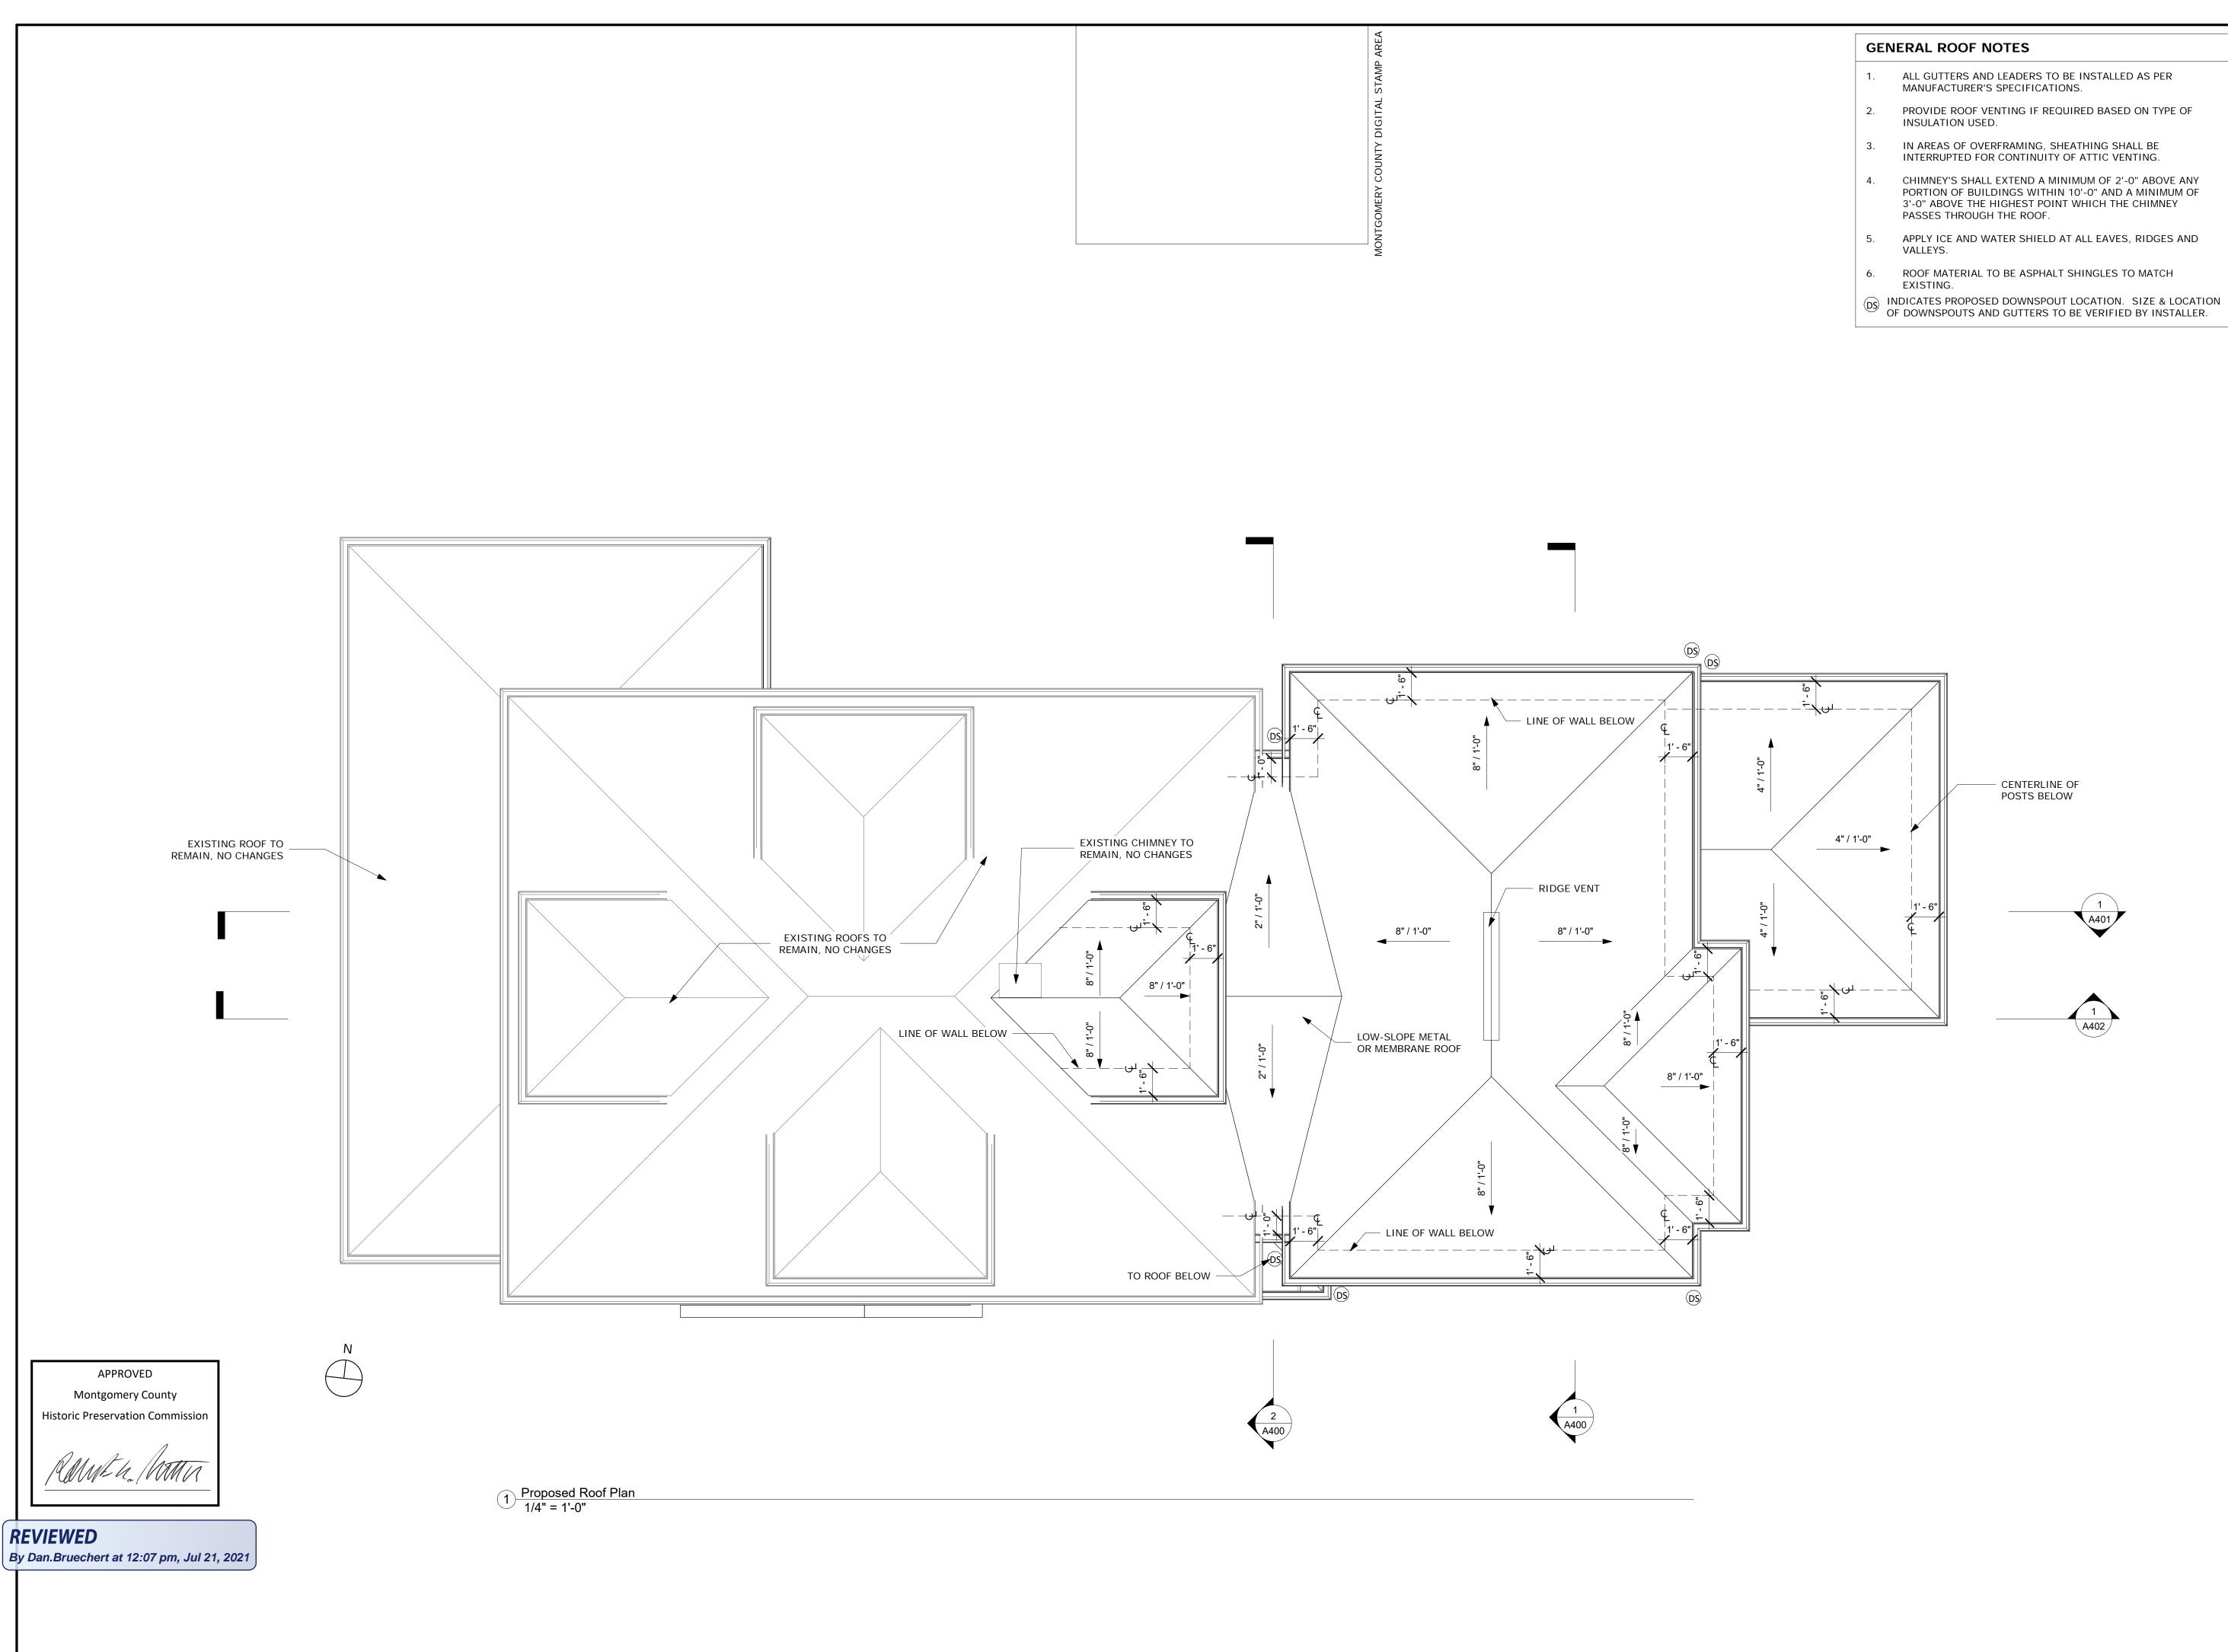
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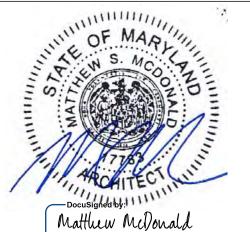
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License number 17783, Expiration Date: 7/21/2022



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Lacy Rice Project Status: As Built Conditions ☐ Preliminary Design ☐ Design Development Permit Submission

> ☐ Construction Documents Construction Administration

Other 5-25-2021 Drawing Issue Date:

Client Approval: Signature:

Project Number:

Client Name:

**Revision Schedule** Date Drawn by:

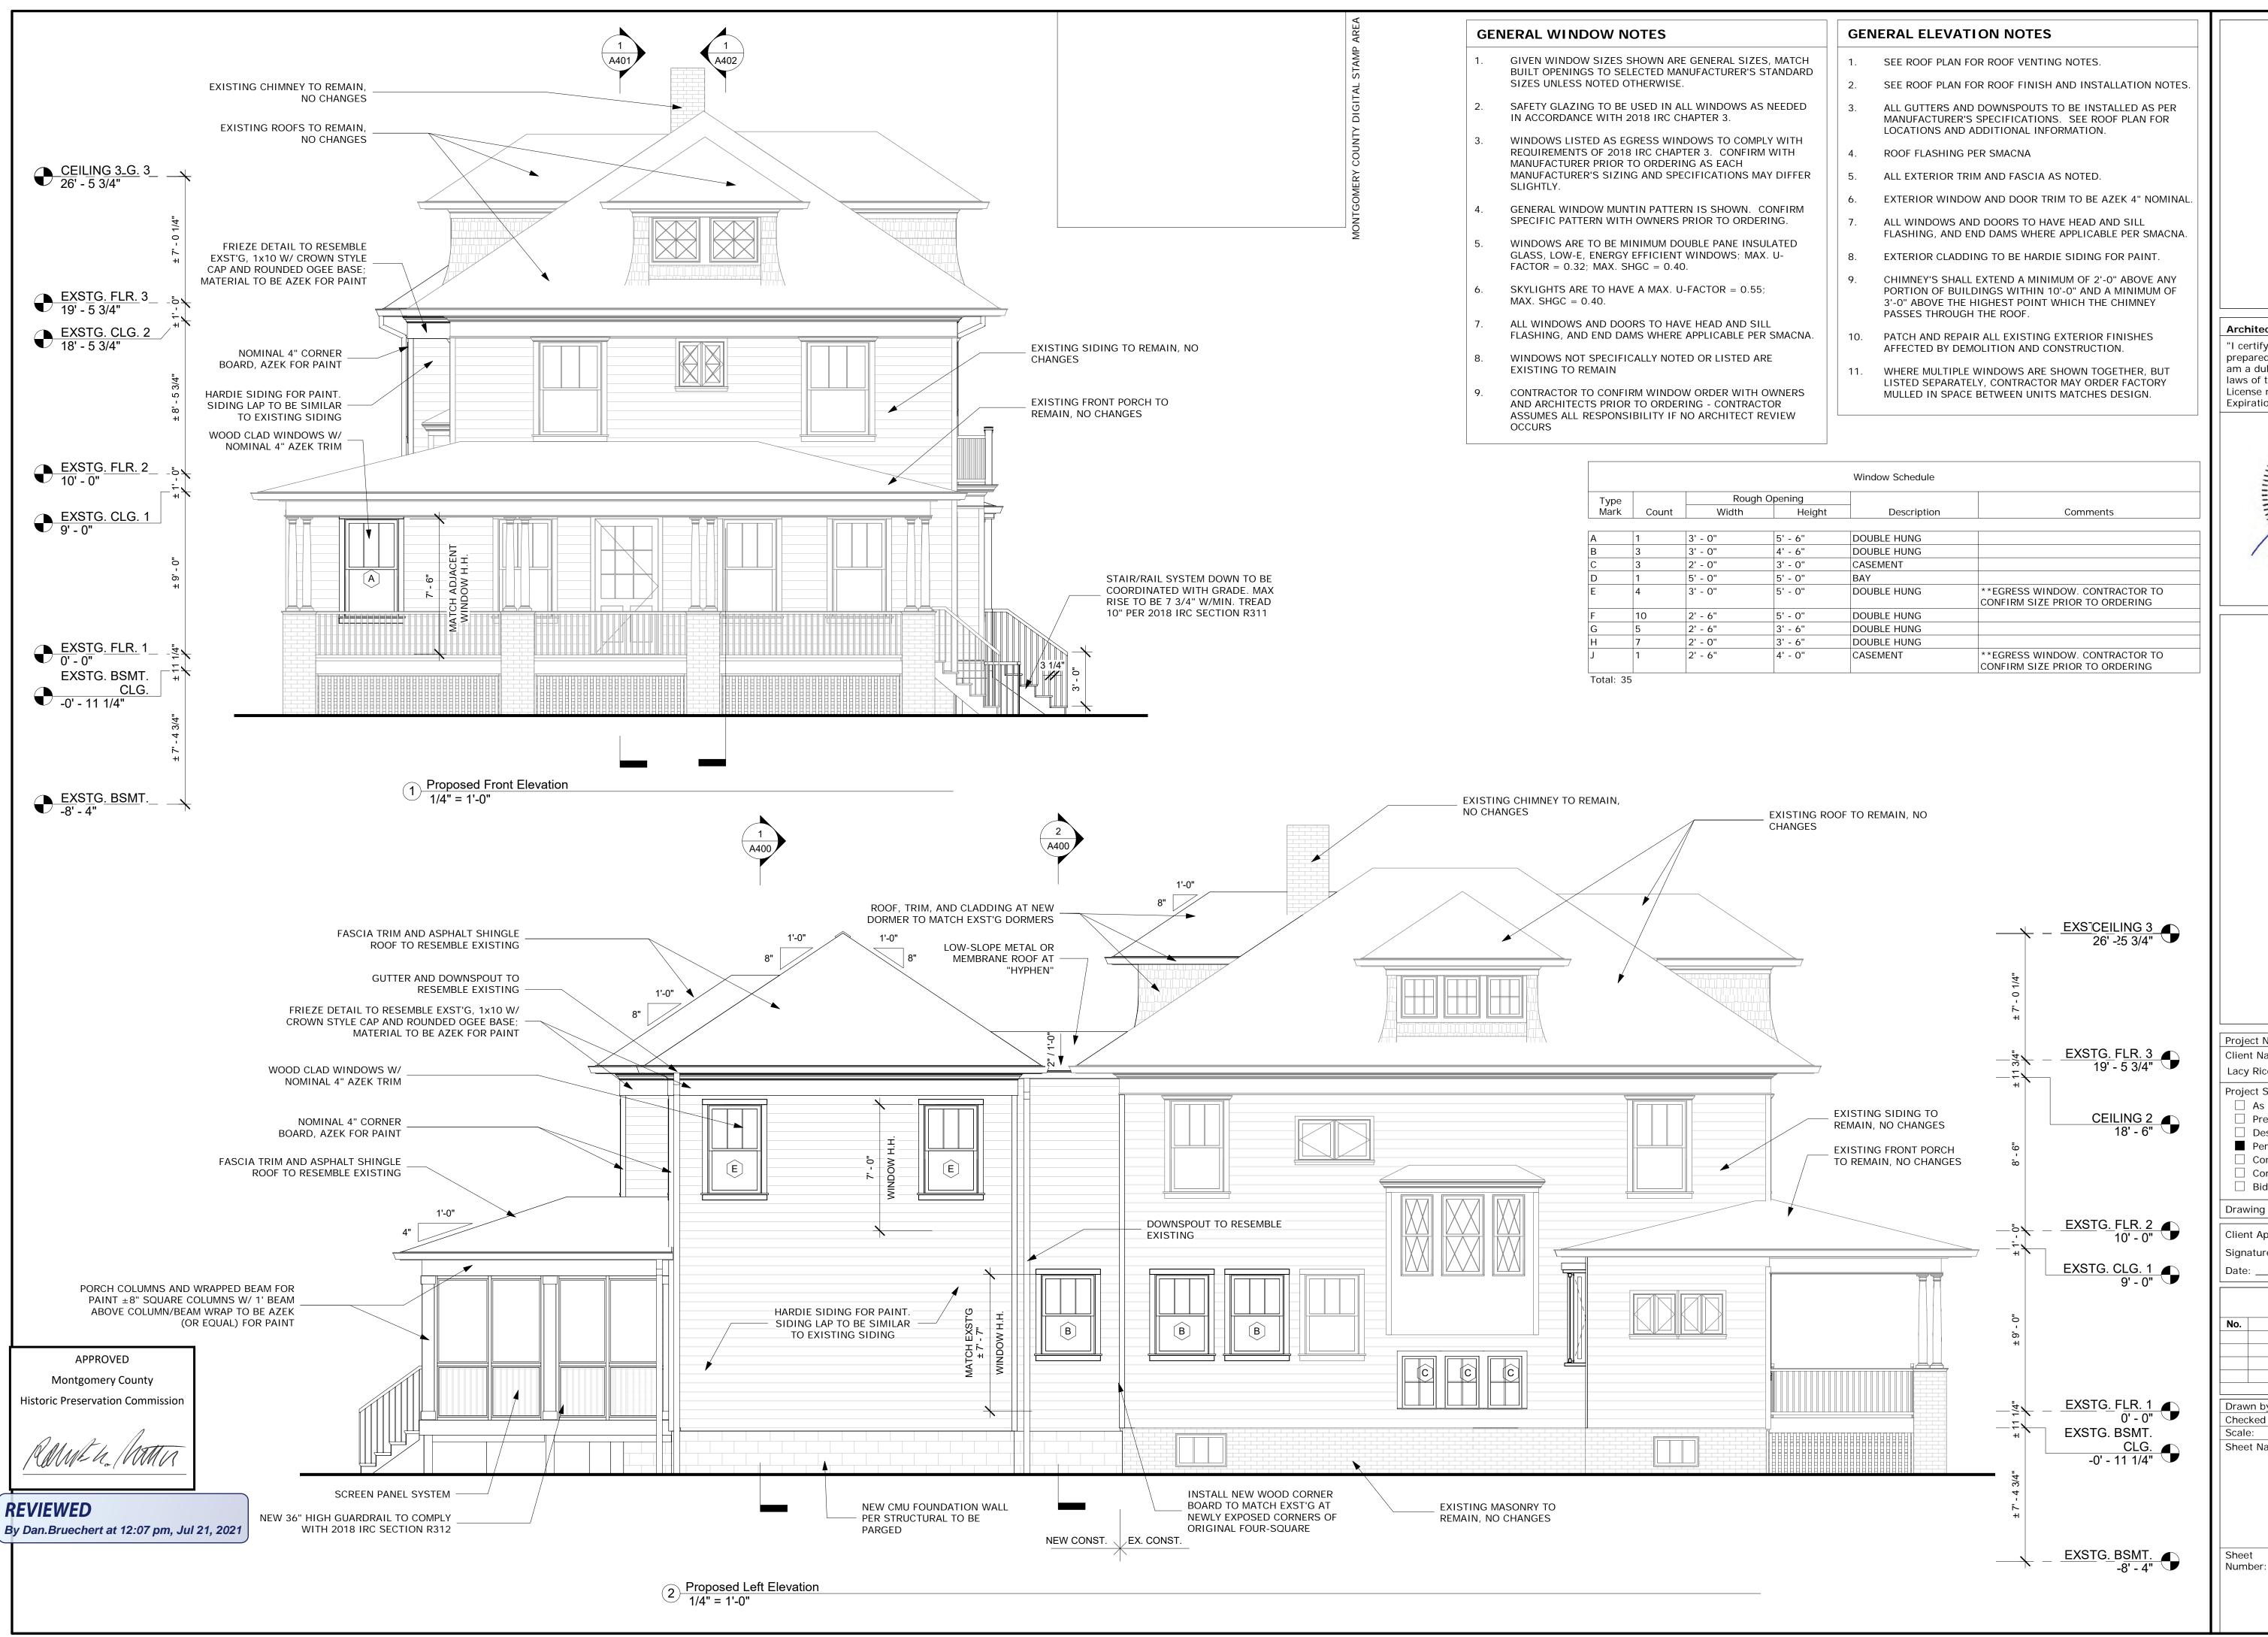
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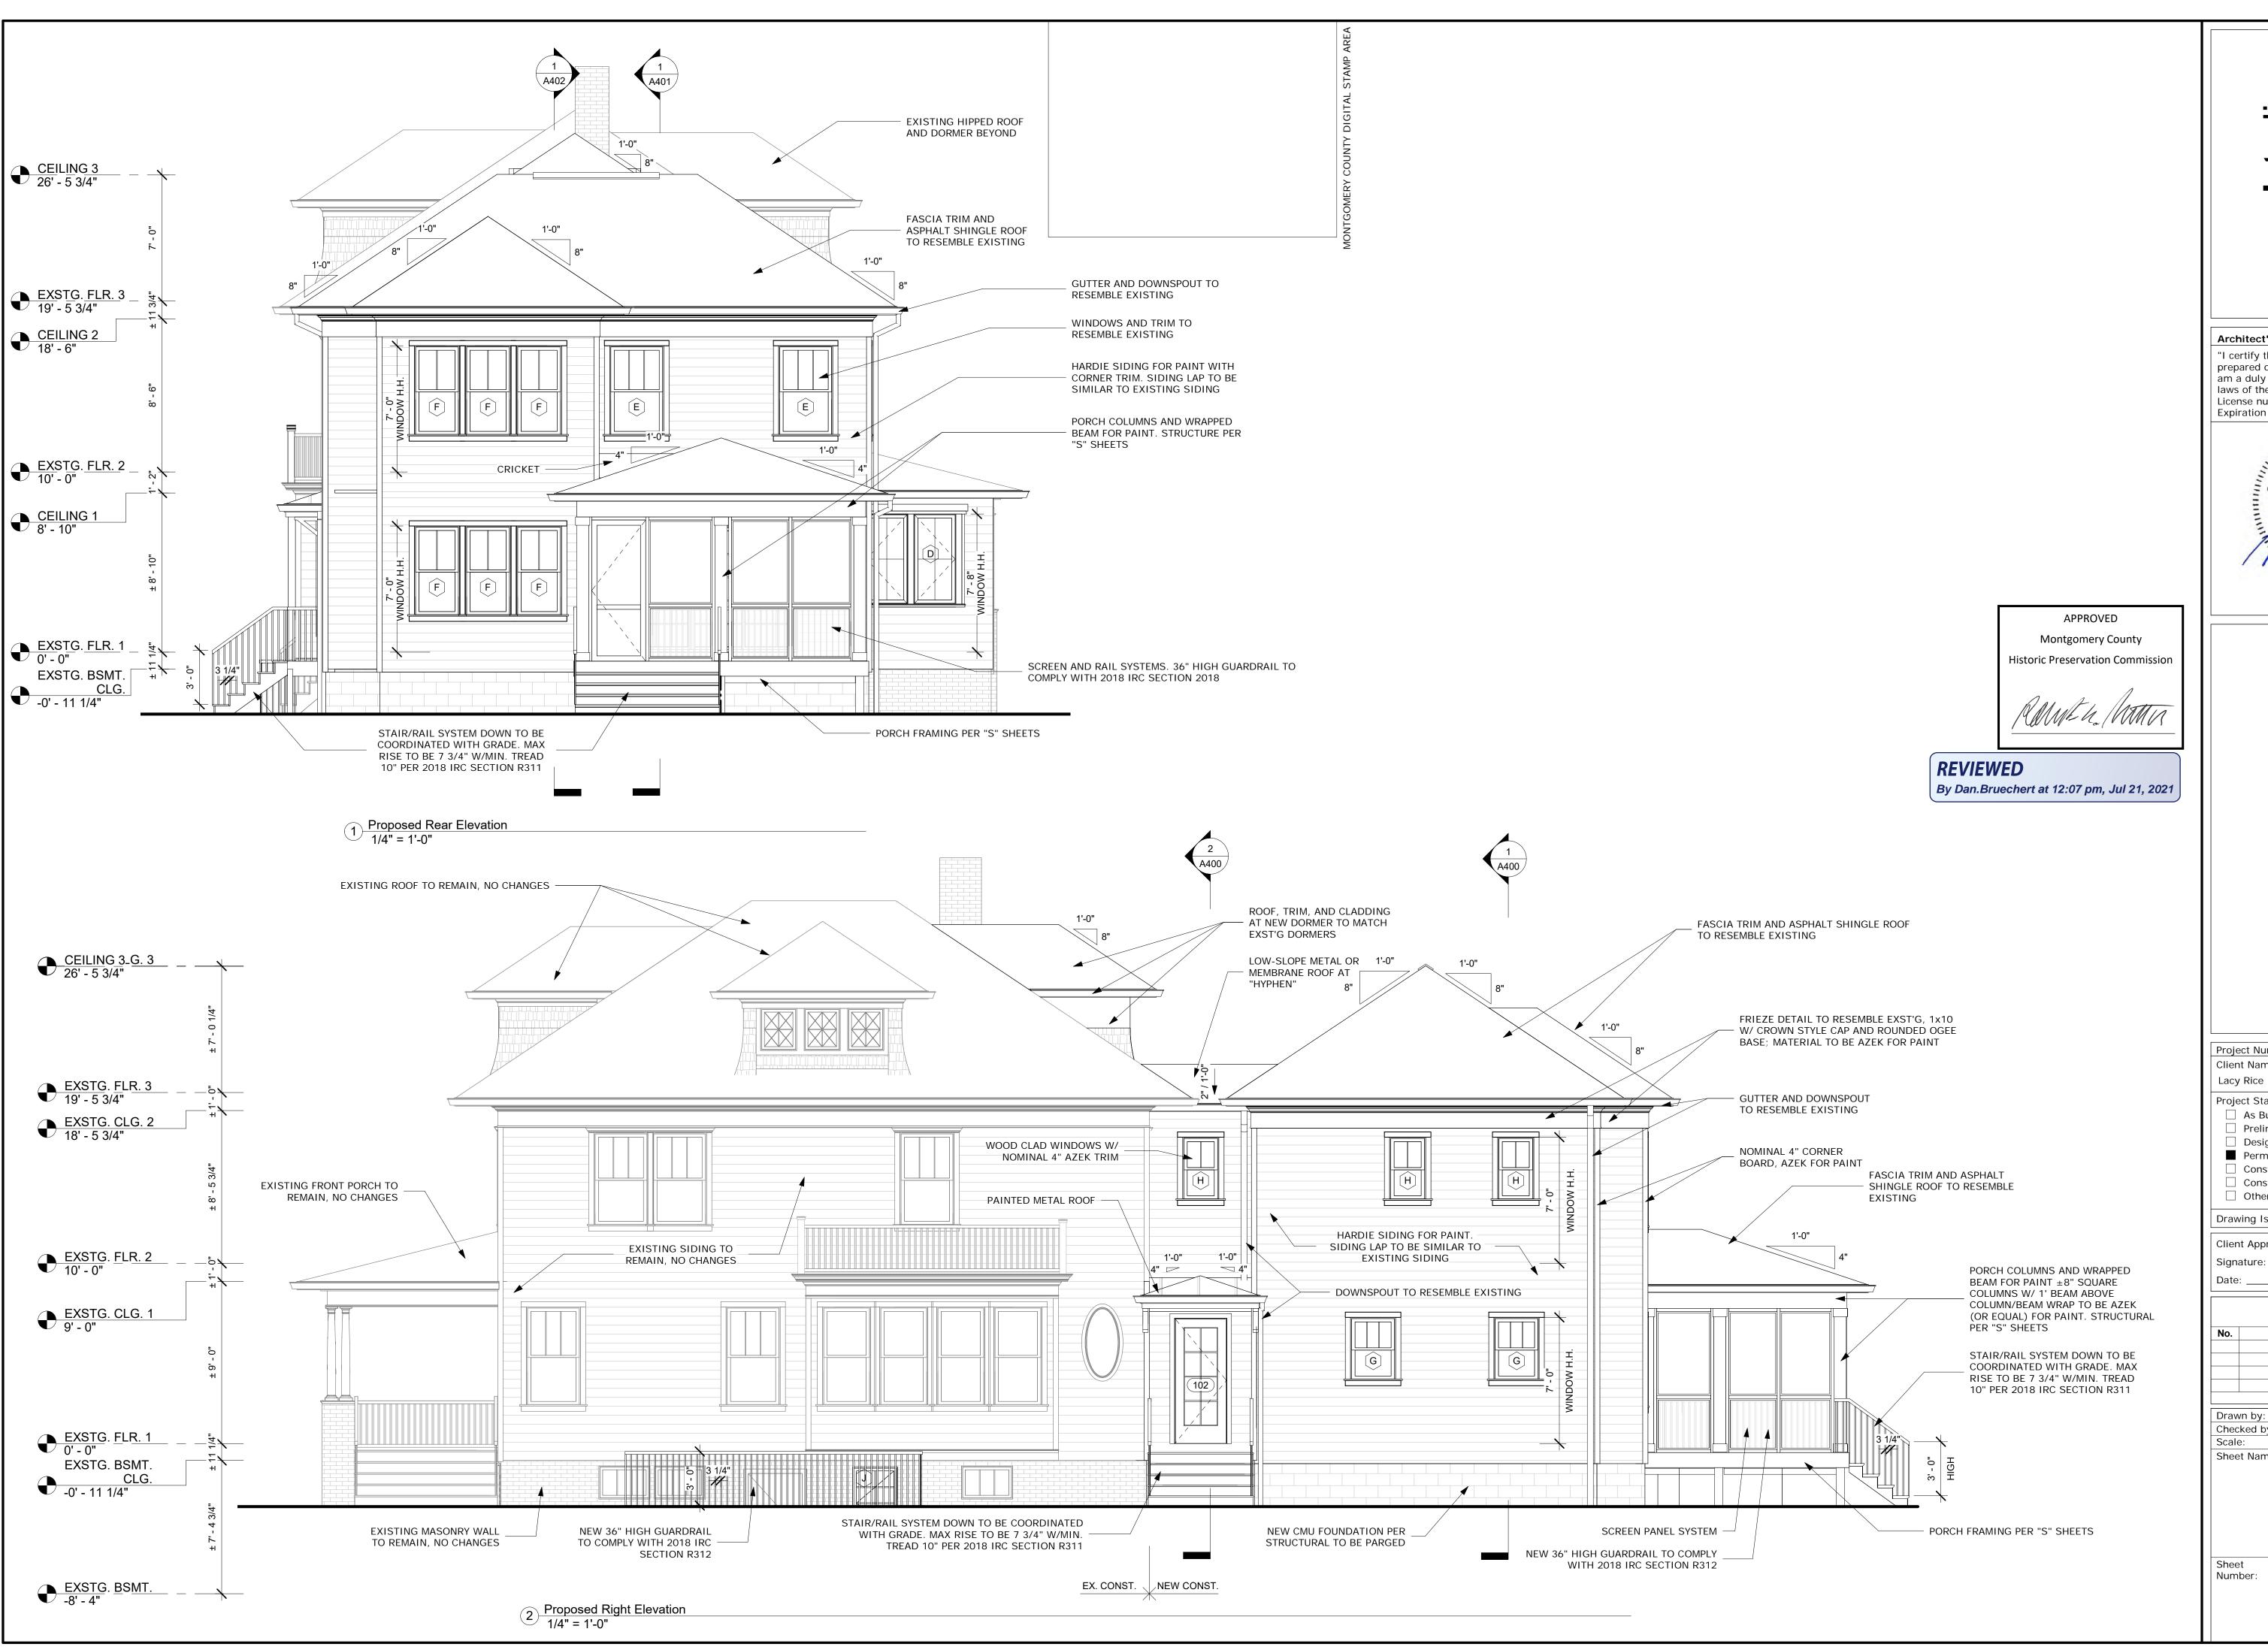
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Renovation and Addition

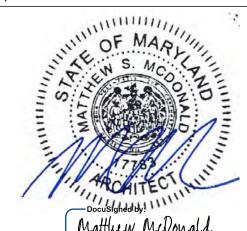
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Matthew McDonald

Addition

20-043 Project Number: Client Name: Lacy Rice Project Status: As Built Conditions Preliminary Design ☐ Design Development Permit Submission Construction Documents

Construction Administration 5-25-2021 Drawing Issue Date: Client Approval:

**Revision Schedule** 

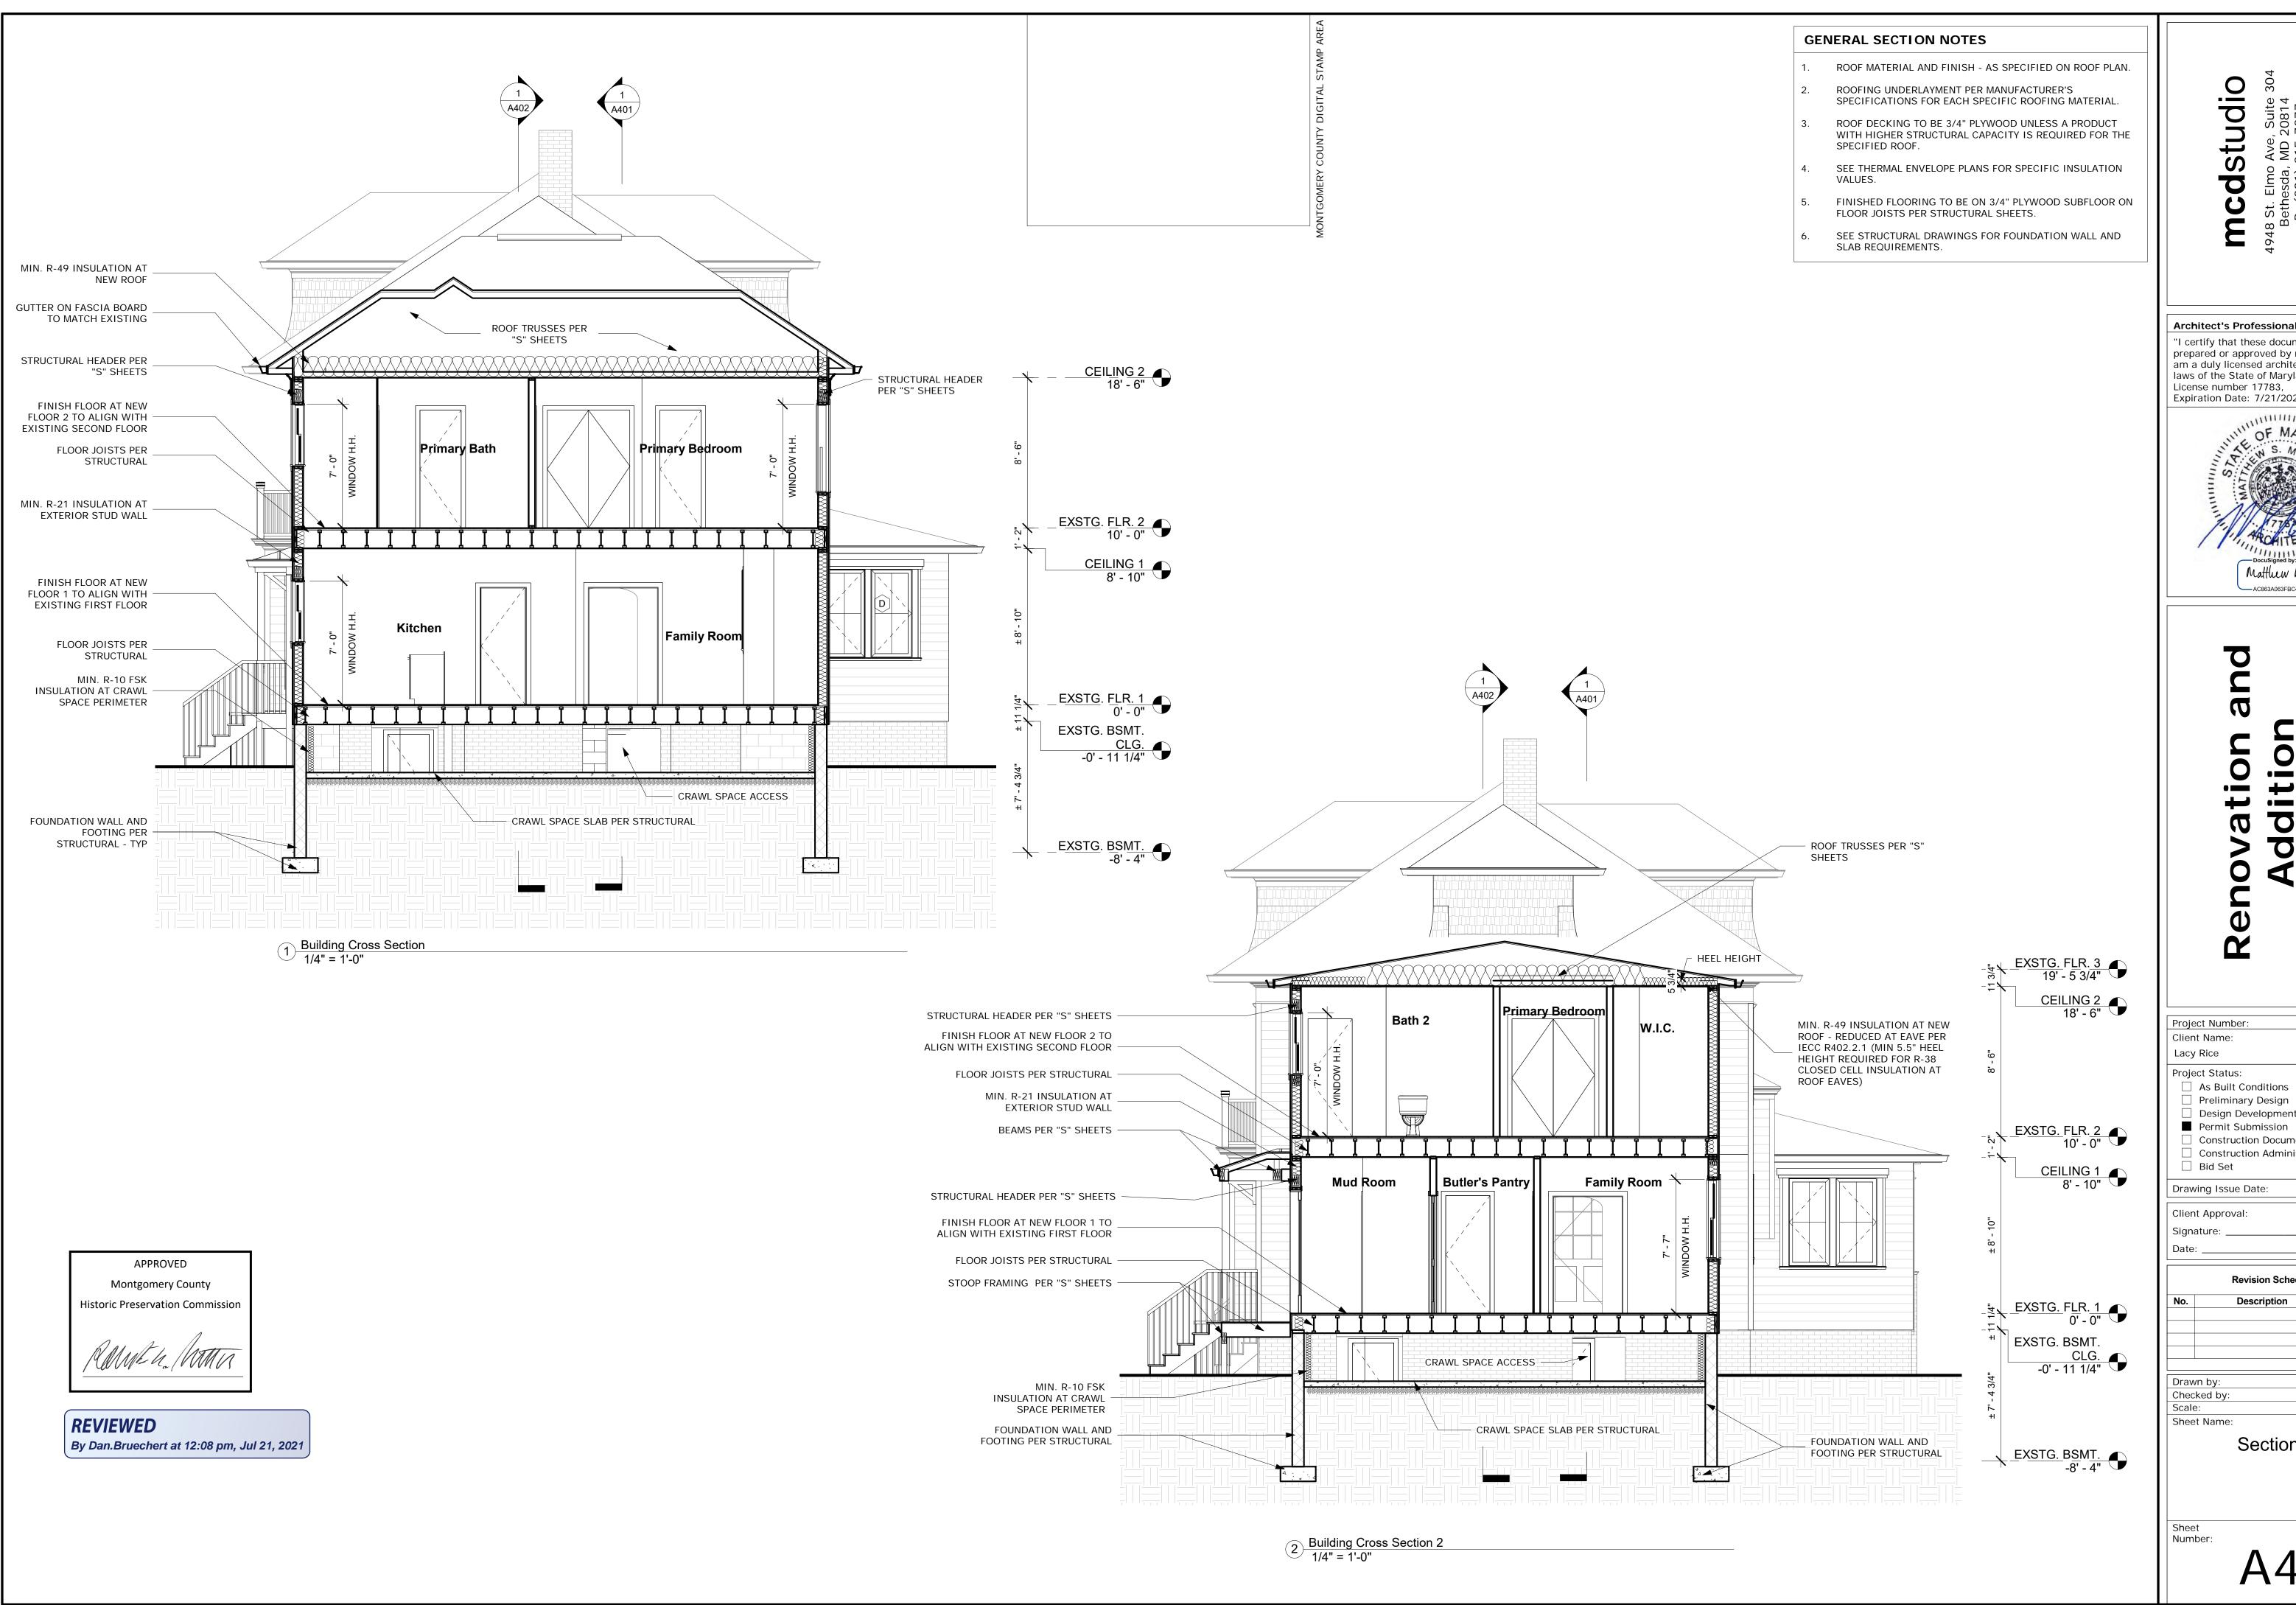
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Elevations



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Project Number: Client Name: Lacy Rice Project Status: As Built Conditions Preliminary Design ☐ Design Development

Construction Documents Construction Administration Bid Set 5-25-2021 Drawing Issue Date:

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Client Approval:

**Revision Schedule** 

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Sections



Addition

20-043

5-25-2021

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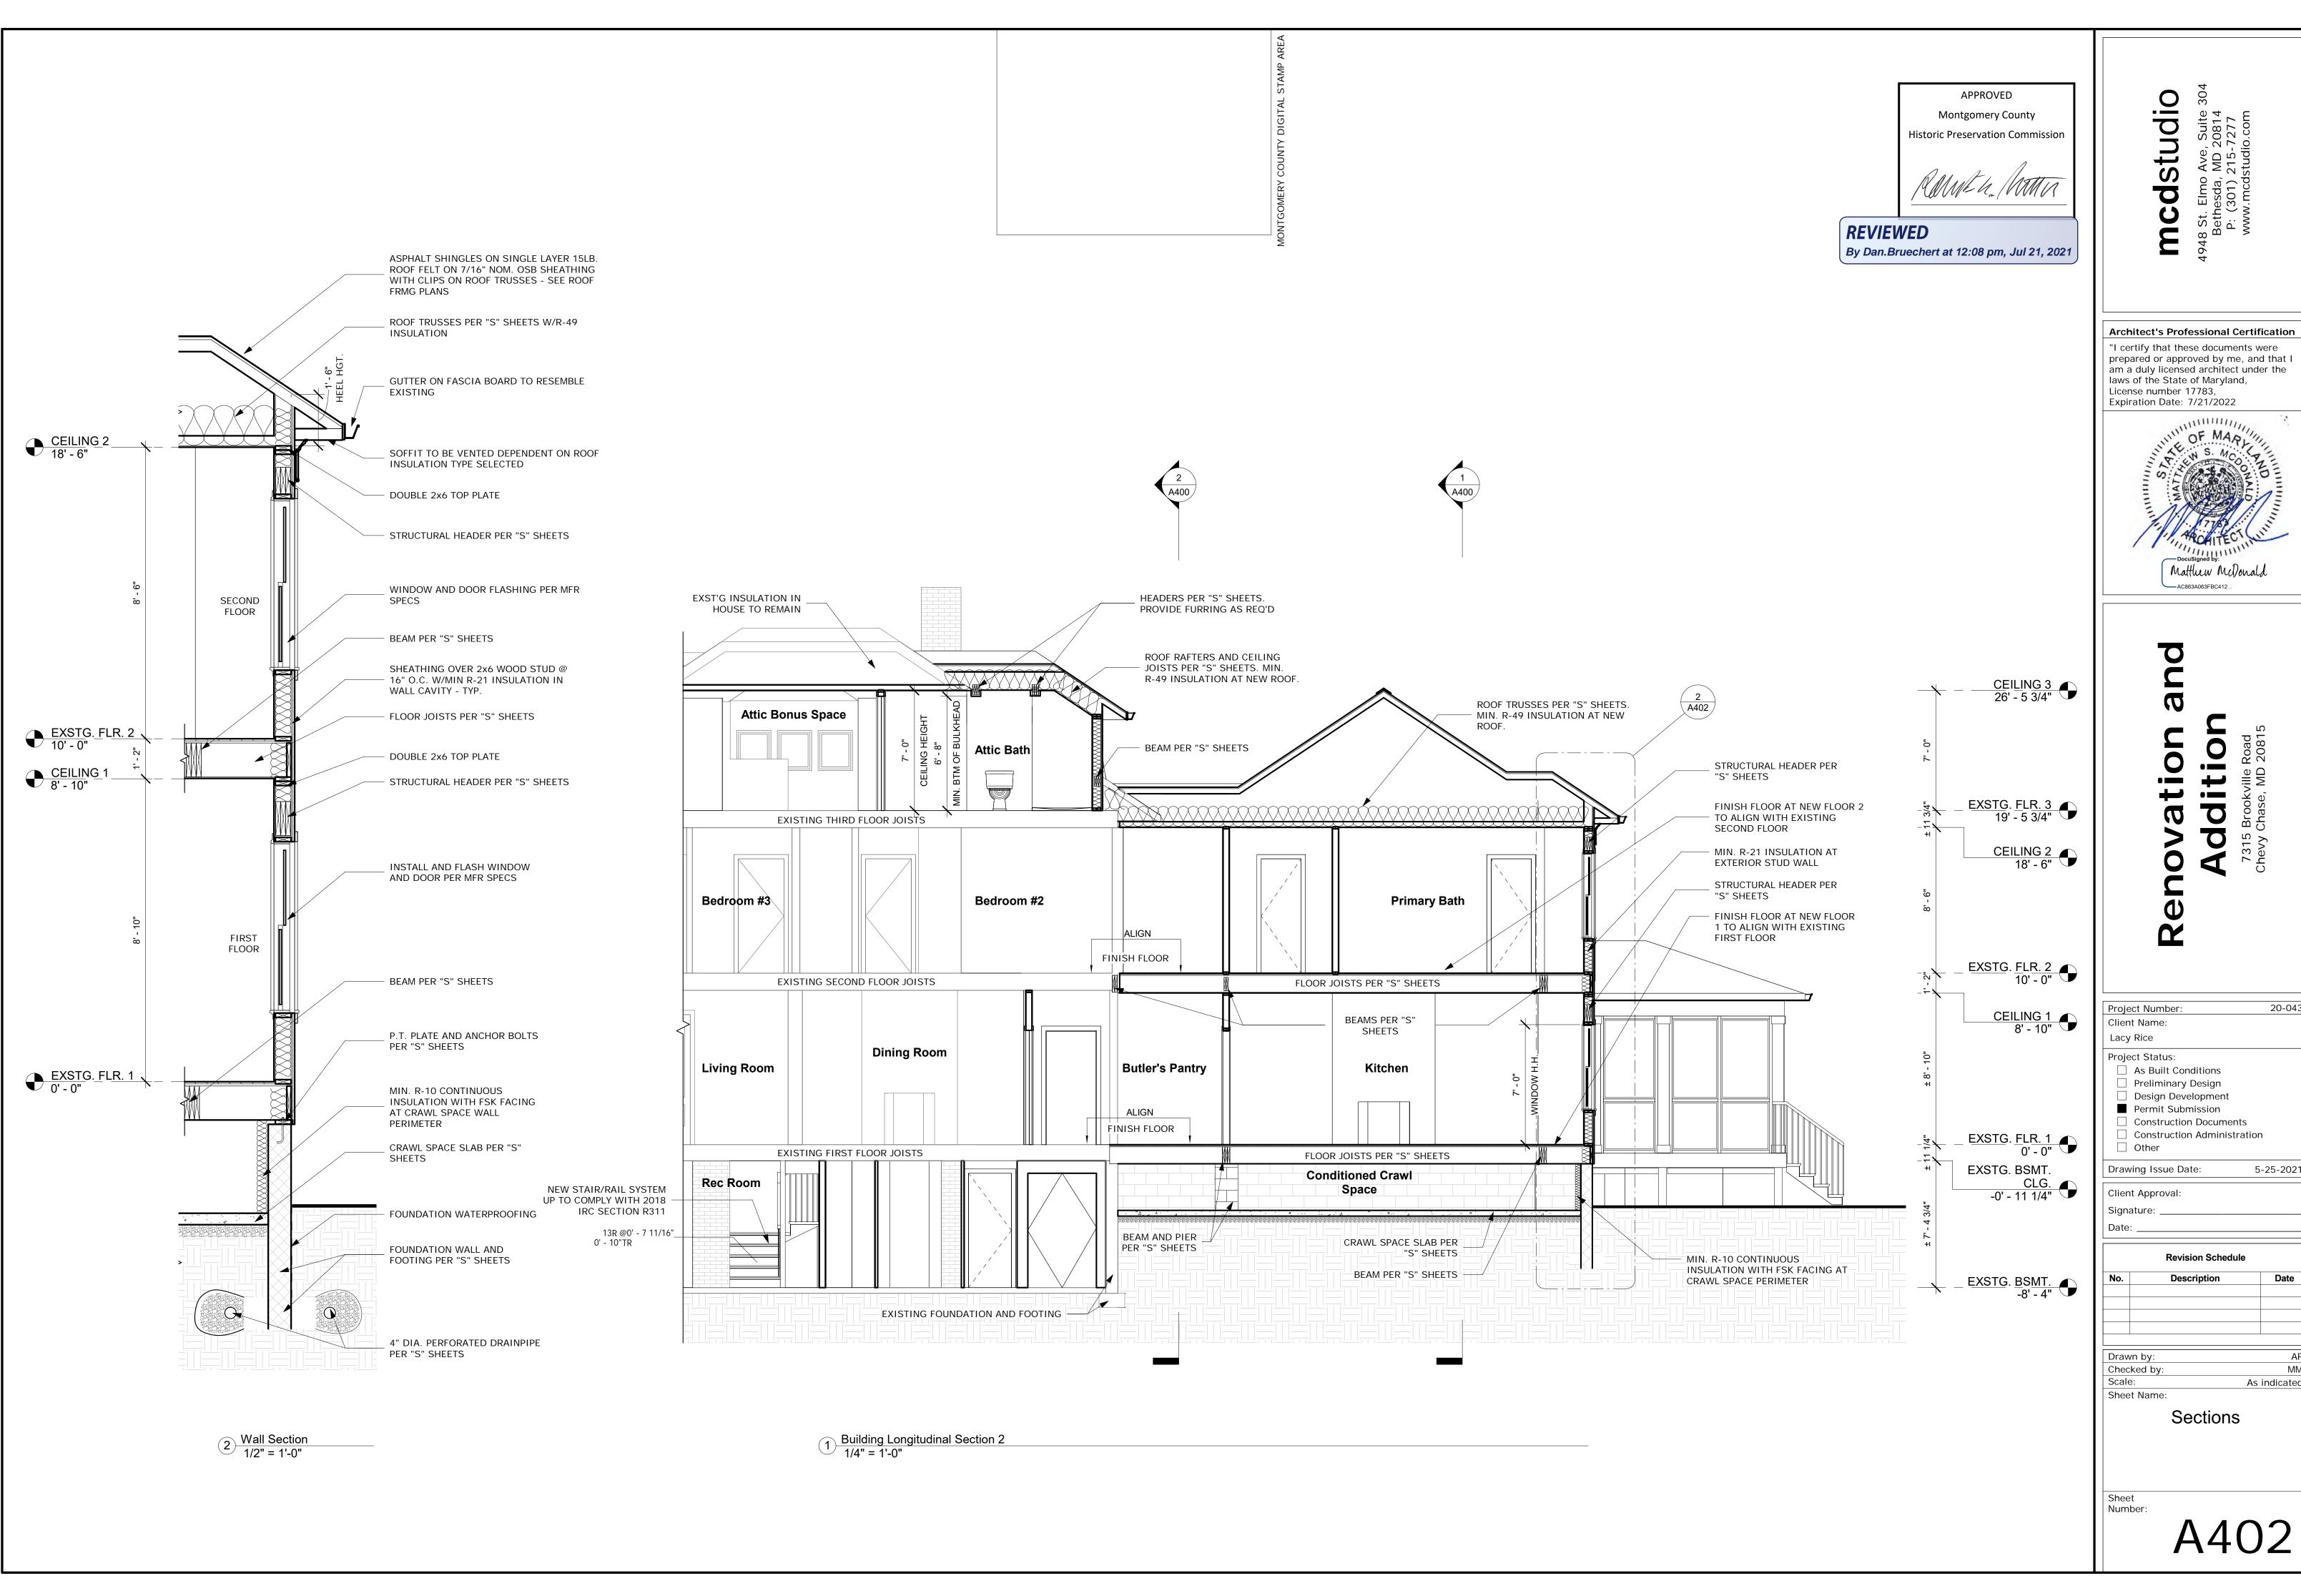
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**Revision Schedule** 

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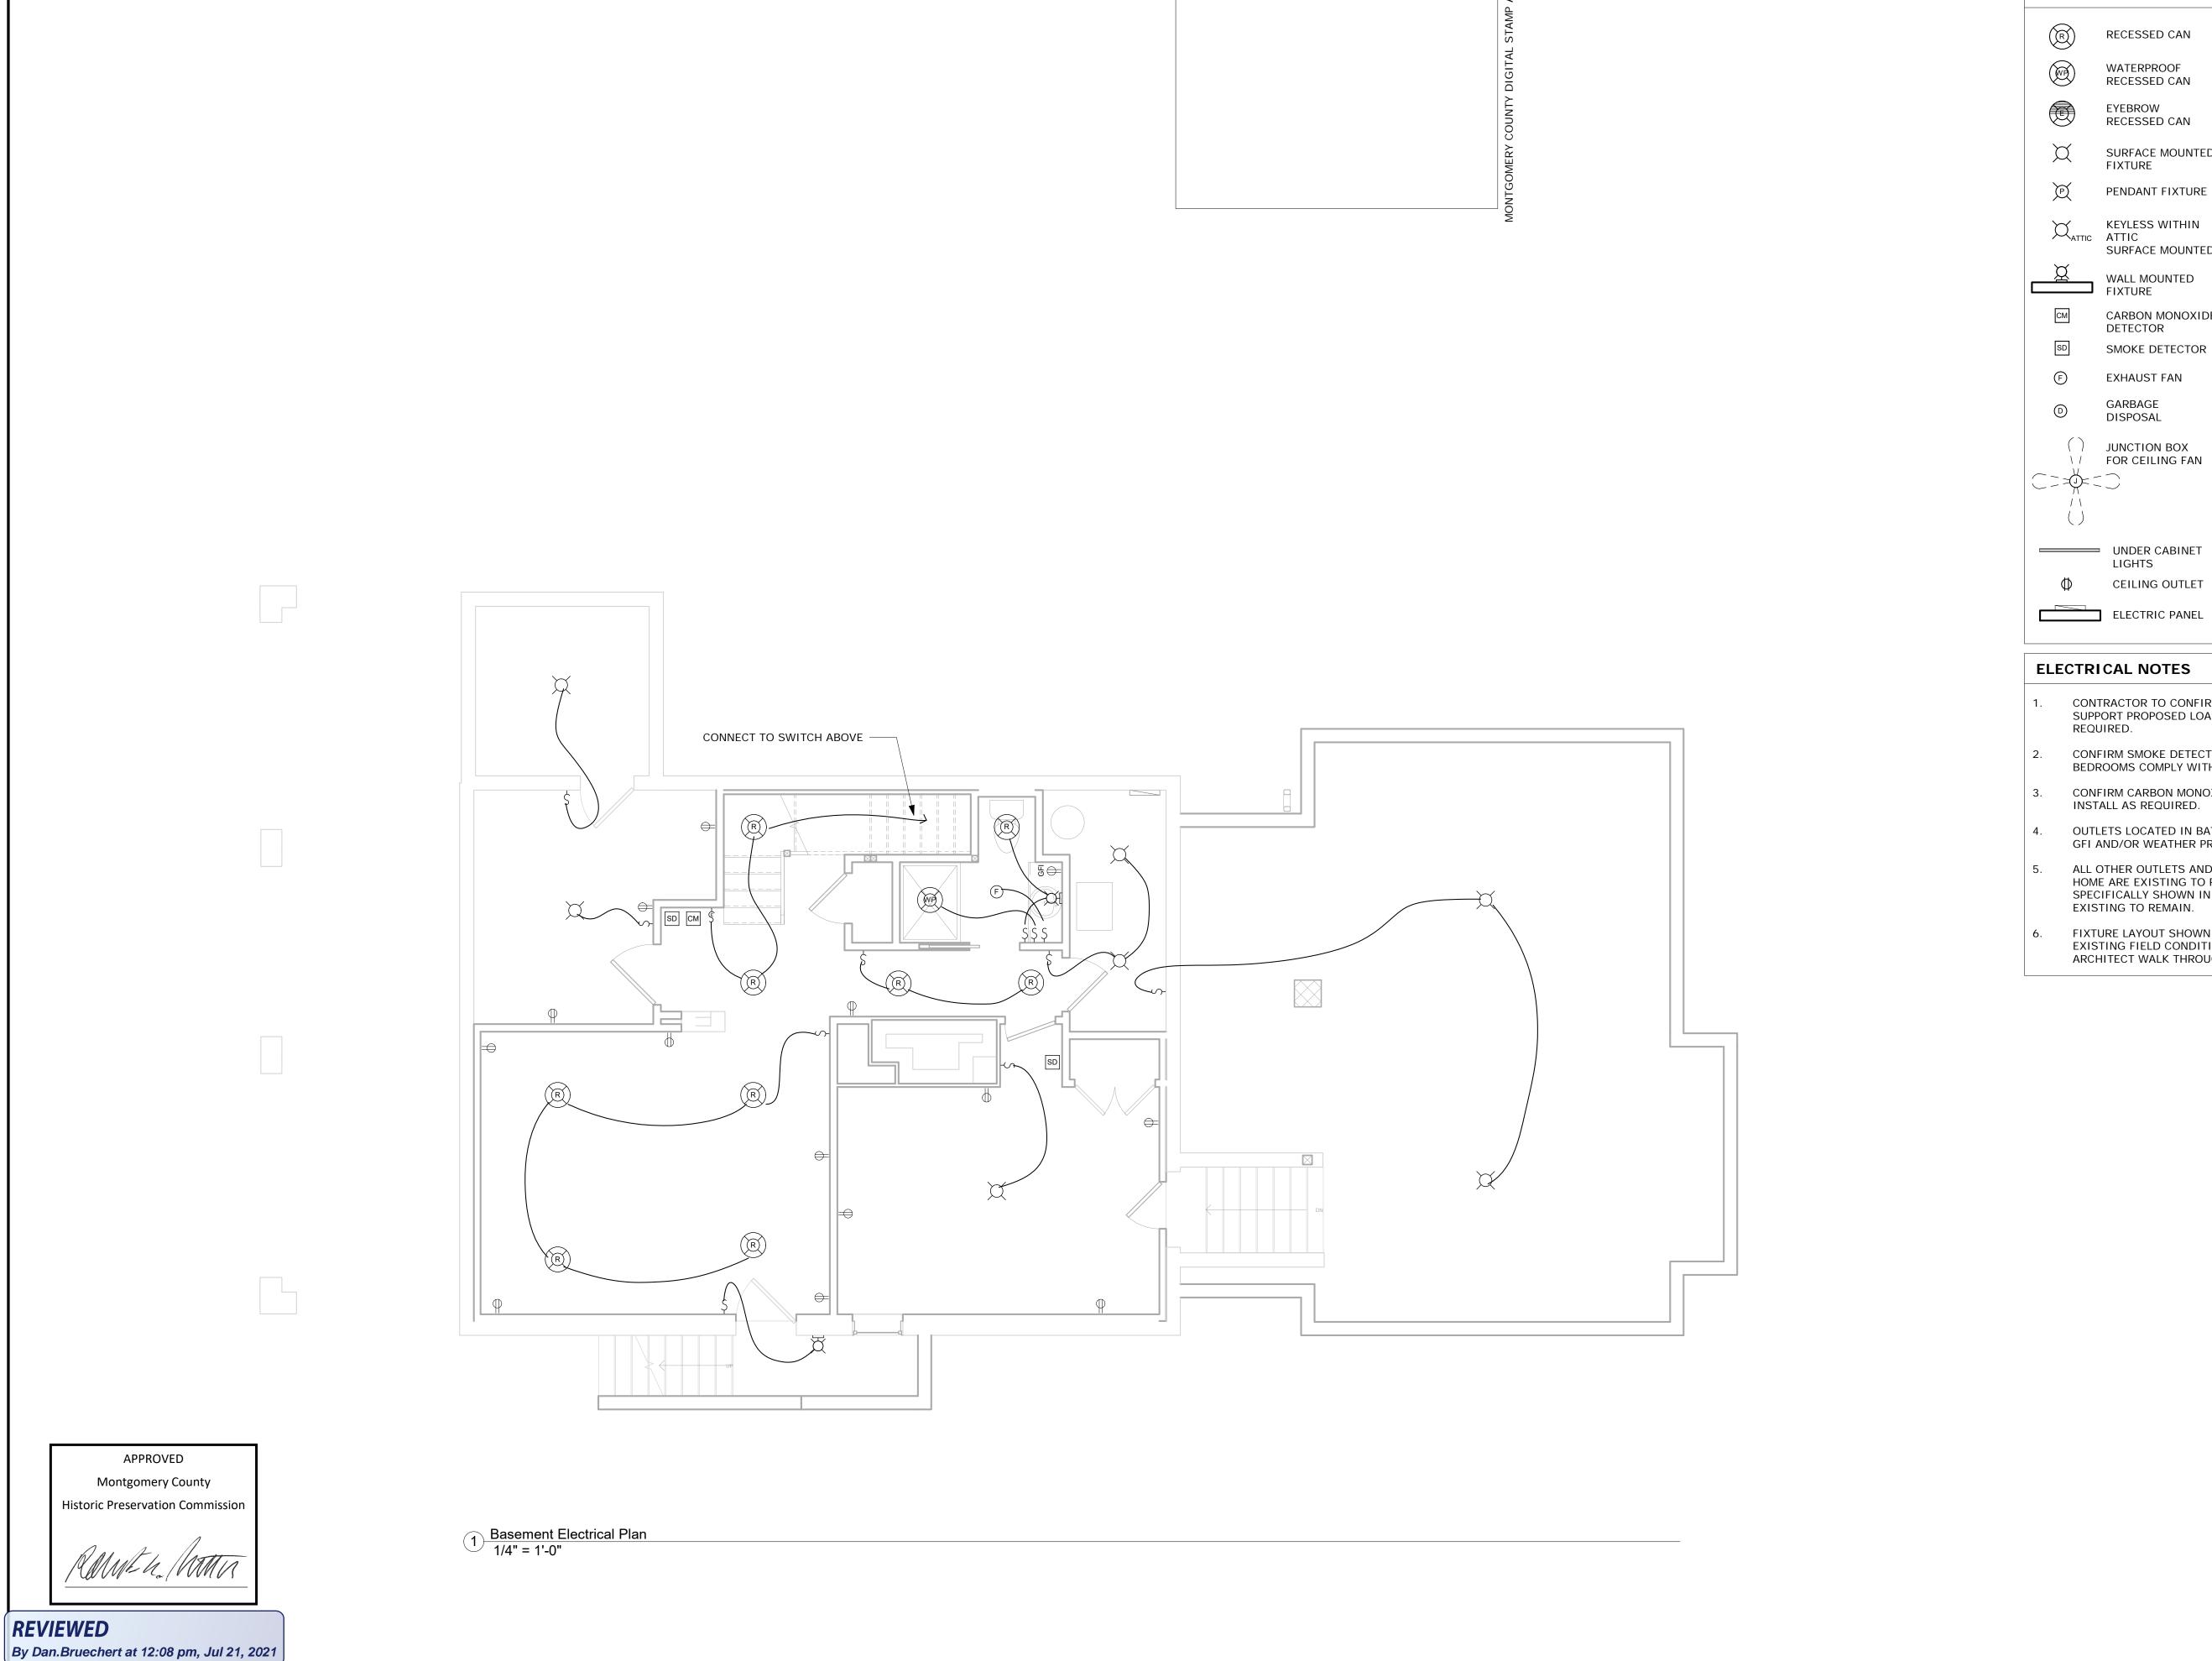
5-25-2021 Drawing Issue Date: Client Approval:

**Revision Schedule** Date

Checked by: As indicated

Sections

MM



**ELECTRICAL SYMBOLS** STD. DUPLEX RECESSED CAN OUTLET WATERPROOF (1) SWITCHED & RECESSED CAN (1) NON-SWITCHED DUPLEX OUTLET 220 VOLT OUTLET RECESSED CAN SURFACE MOUNTED STD. G.F.I. OUTLET PENDANT FIXTURE STD. G.F.I. OUTLET 36" ABOVE FIN. FLR. KEYLESS WITHIN STD. G.F.I. OUTLET SURFACE MOUNTED 42" ABOVE FIN. FLR. WALL MOUNTED STD. SINGLE SWITCH CARBON MONOXIDE SINGLE DIMMER DETECTOR SWITCH SMOKE DETECTOR 2-WAY SWITCH EXHAUST FAN 2-WAY DIMMER SWITCH 3-WAY SWITCH JUNCTION BOX \ / FOR CEILING FAN 3-WAY DIMMER SWITCH CABLE TV JACK — UNDER CABINET DATA JACK CEILING OUTLET PHONE JACK

- CONTRACTOR TO CONFIRM EXISTING ELECTRICAL CAN SUPPORT PROPOSED LOAD - INCREASE PANEL SIZE IF
- CONFIRM SMOKE DETECTORS IN ALL HALLWAYS AND BEDROOMS COMPLY WITH 2018 IRC - INSTALL AS REQUIRED.
- CONFIRM CARBON MONOXIDE DETECTOR AT EACH LEVEL -
- OUTLETS LOCATED IN BATHROOM, EXTERIOR, OR OTHER TO BE
- GFI AND/OR WEATHER PROOF AS REQUIRED BY 2018 IRC. ALL OTHER OUTLETS AND FIXTURES IN OTHER AREAS OF THE
- HOME ARE EXISTING TO REMAIN. OUTLETS NOT SPECIFICALLY SHOWN IN AREAS OF WORK ARE ALSO TO BE EXISTING TO REMAIN.
- FIXTURE LAYOUT SHOWN IS GENERAL, COORDINATE WITH EXISTING FIELD CONDITIONS AND CONDUCT OWNER/ ARCHITECT WALK THROUGH AT ROUGH-IN.

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**Architect's Professional Certification** 

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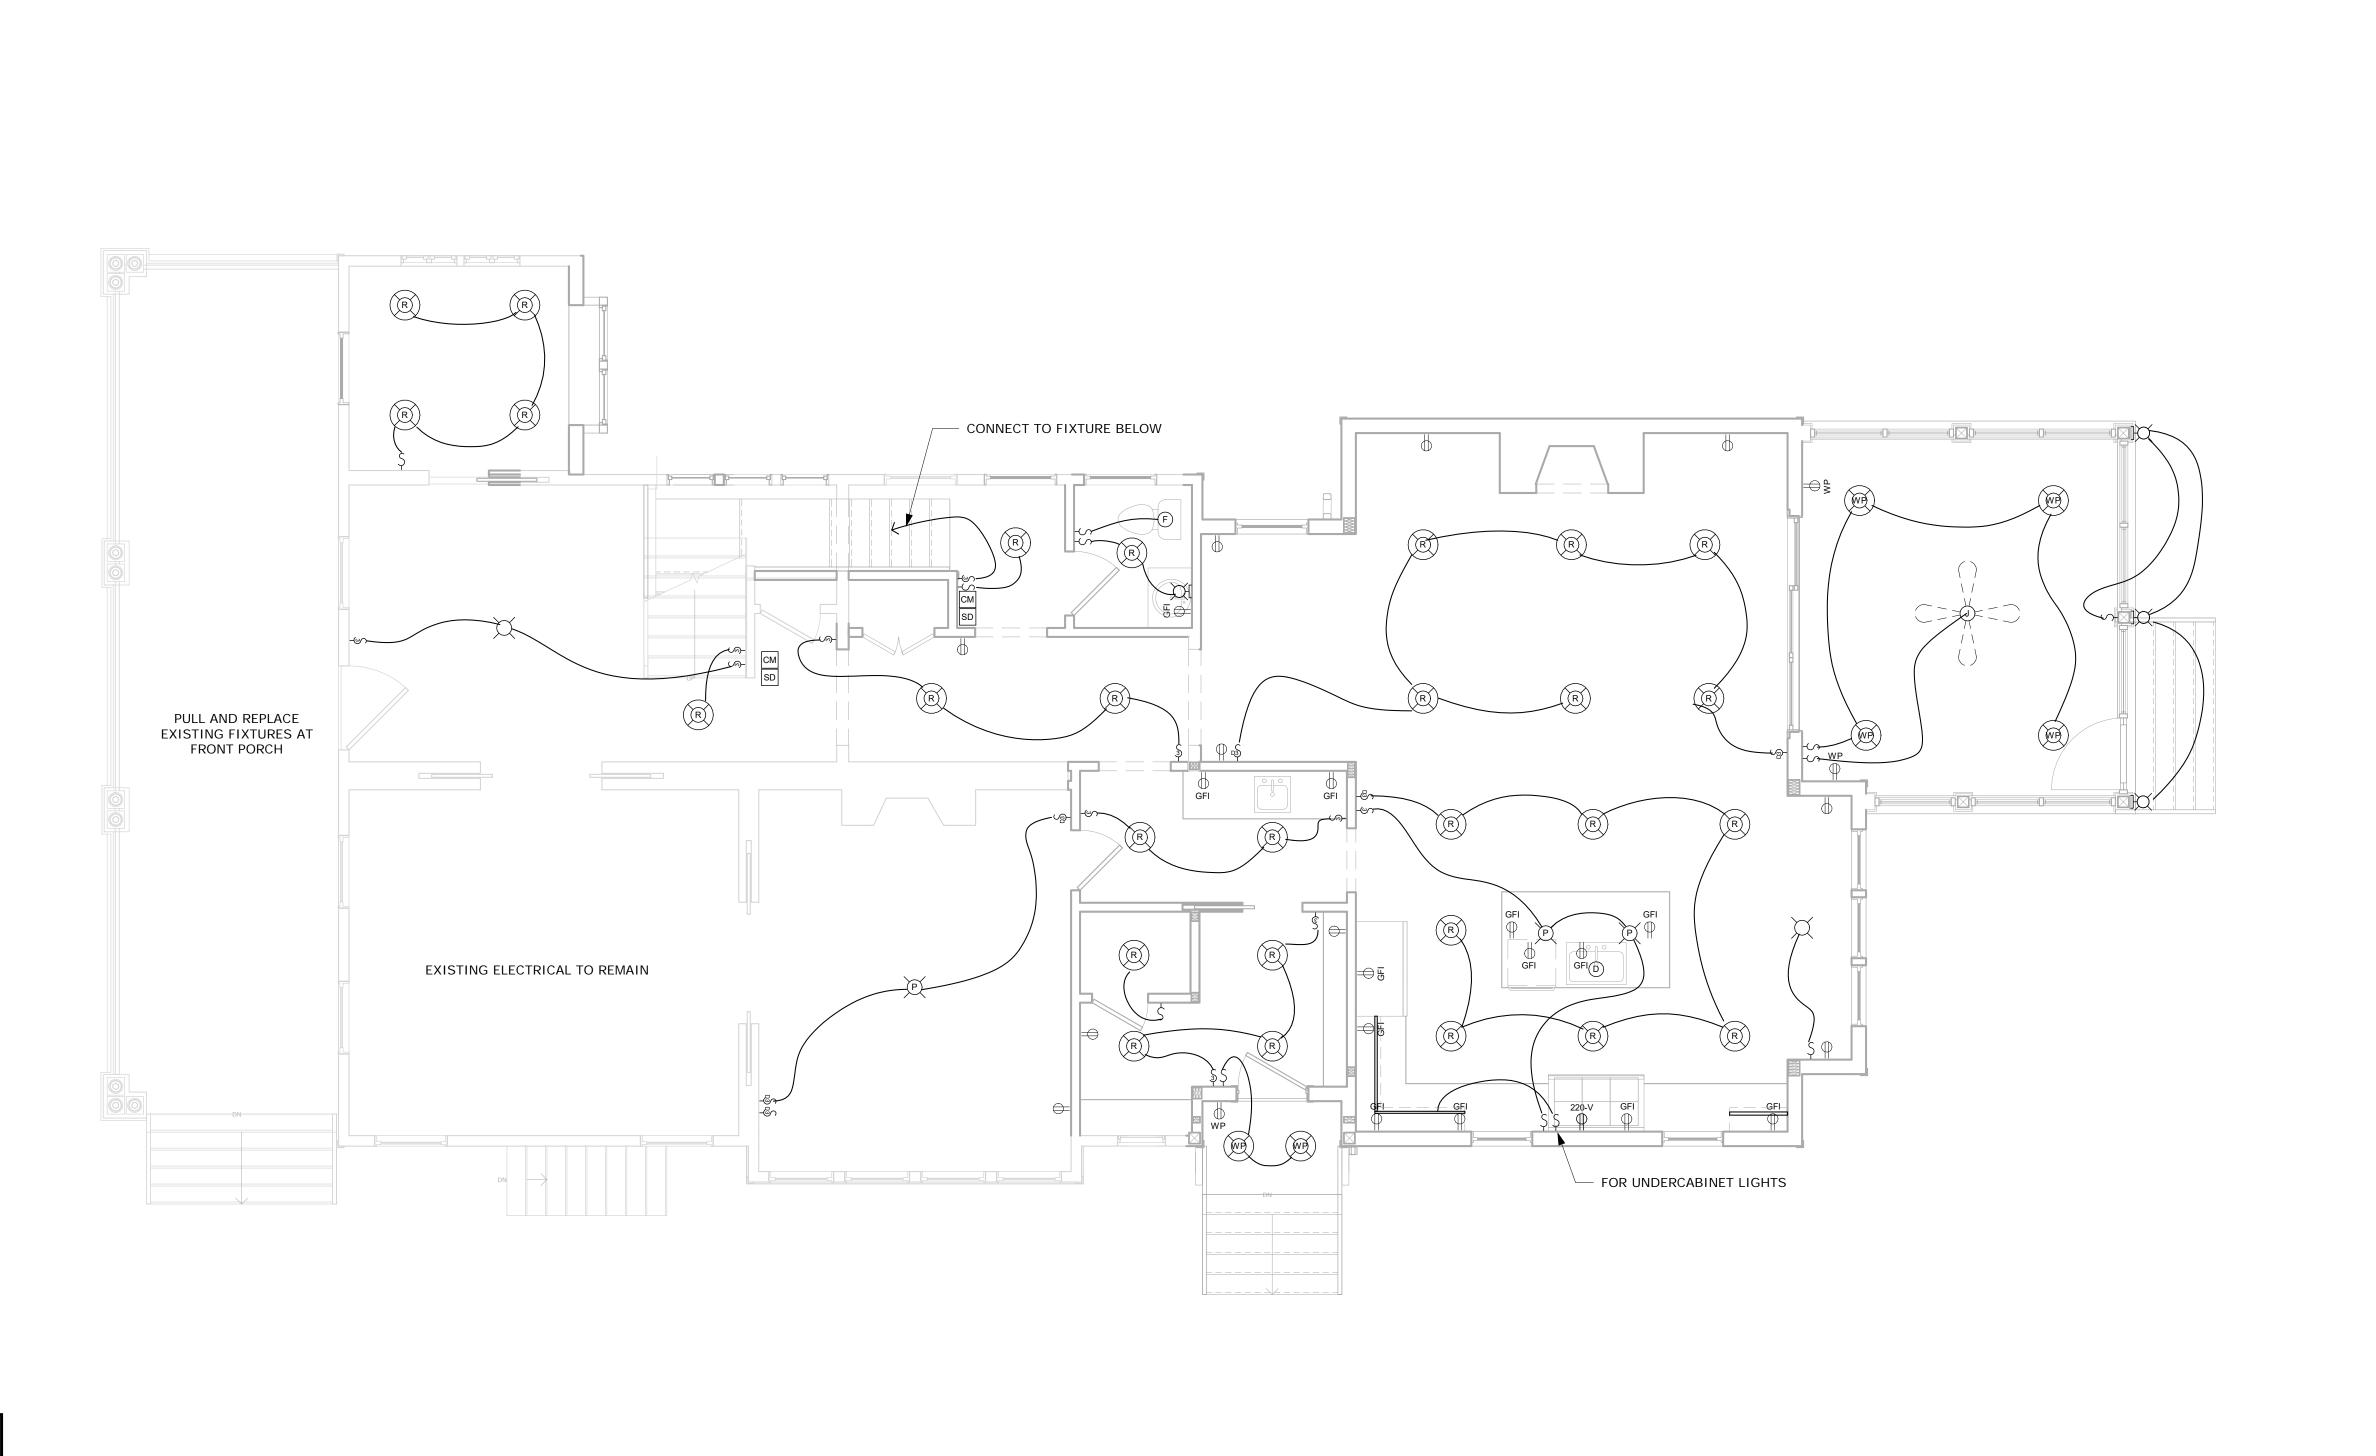
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Project Number:	20-043
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Lacy Rice	
Project Status:	
As Built Conditions	
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Electrical Plans



# Architect's Professional Certification

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Project Number: 20-043 Client Name: Lacy Rice Project Status: ☐ As Built Conditions Preliminary Design ☐ Design Development Permit Submission ☐ Construction Documents Construction Administration Other

Drawing Issue Date: 5-25-2021 Client Approval:

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Electrical Plans

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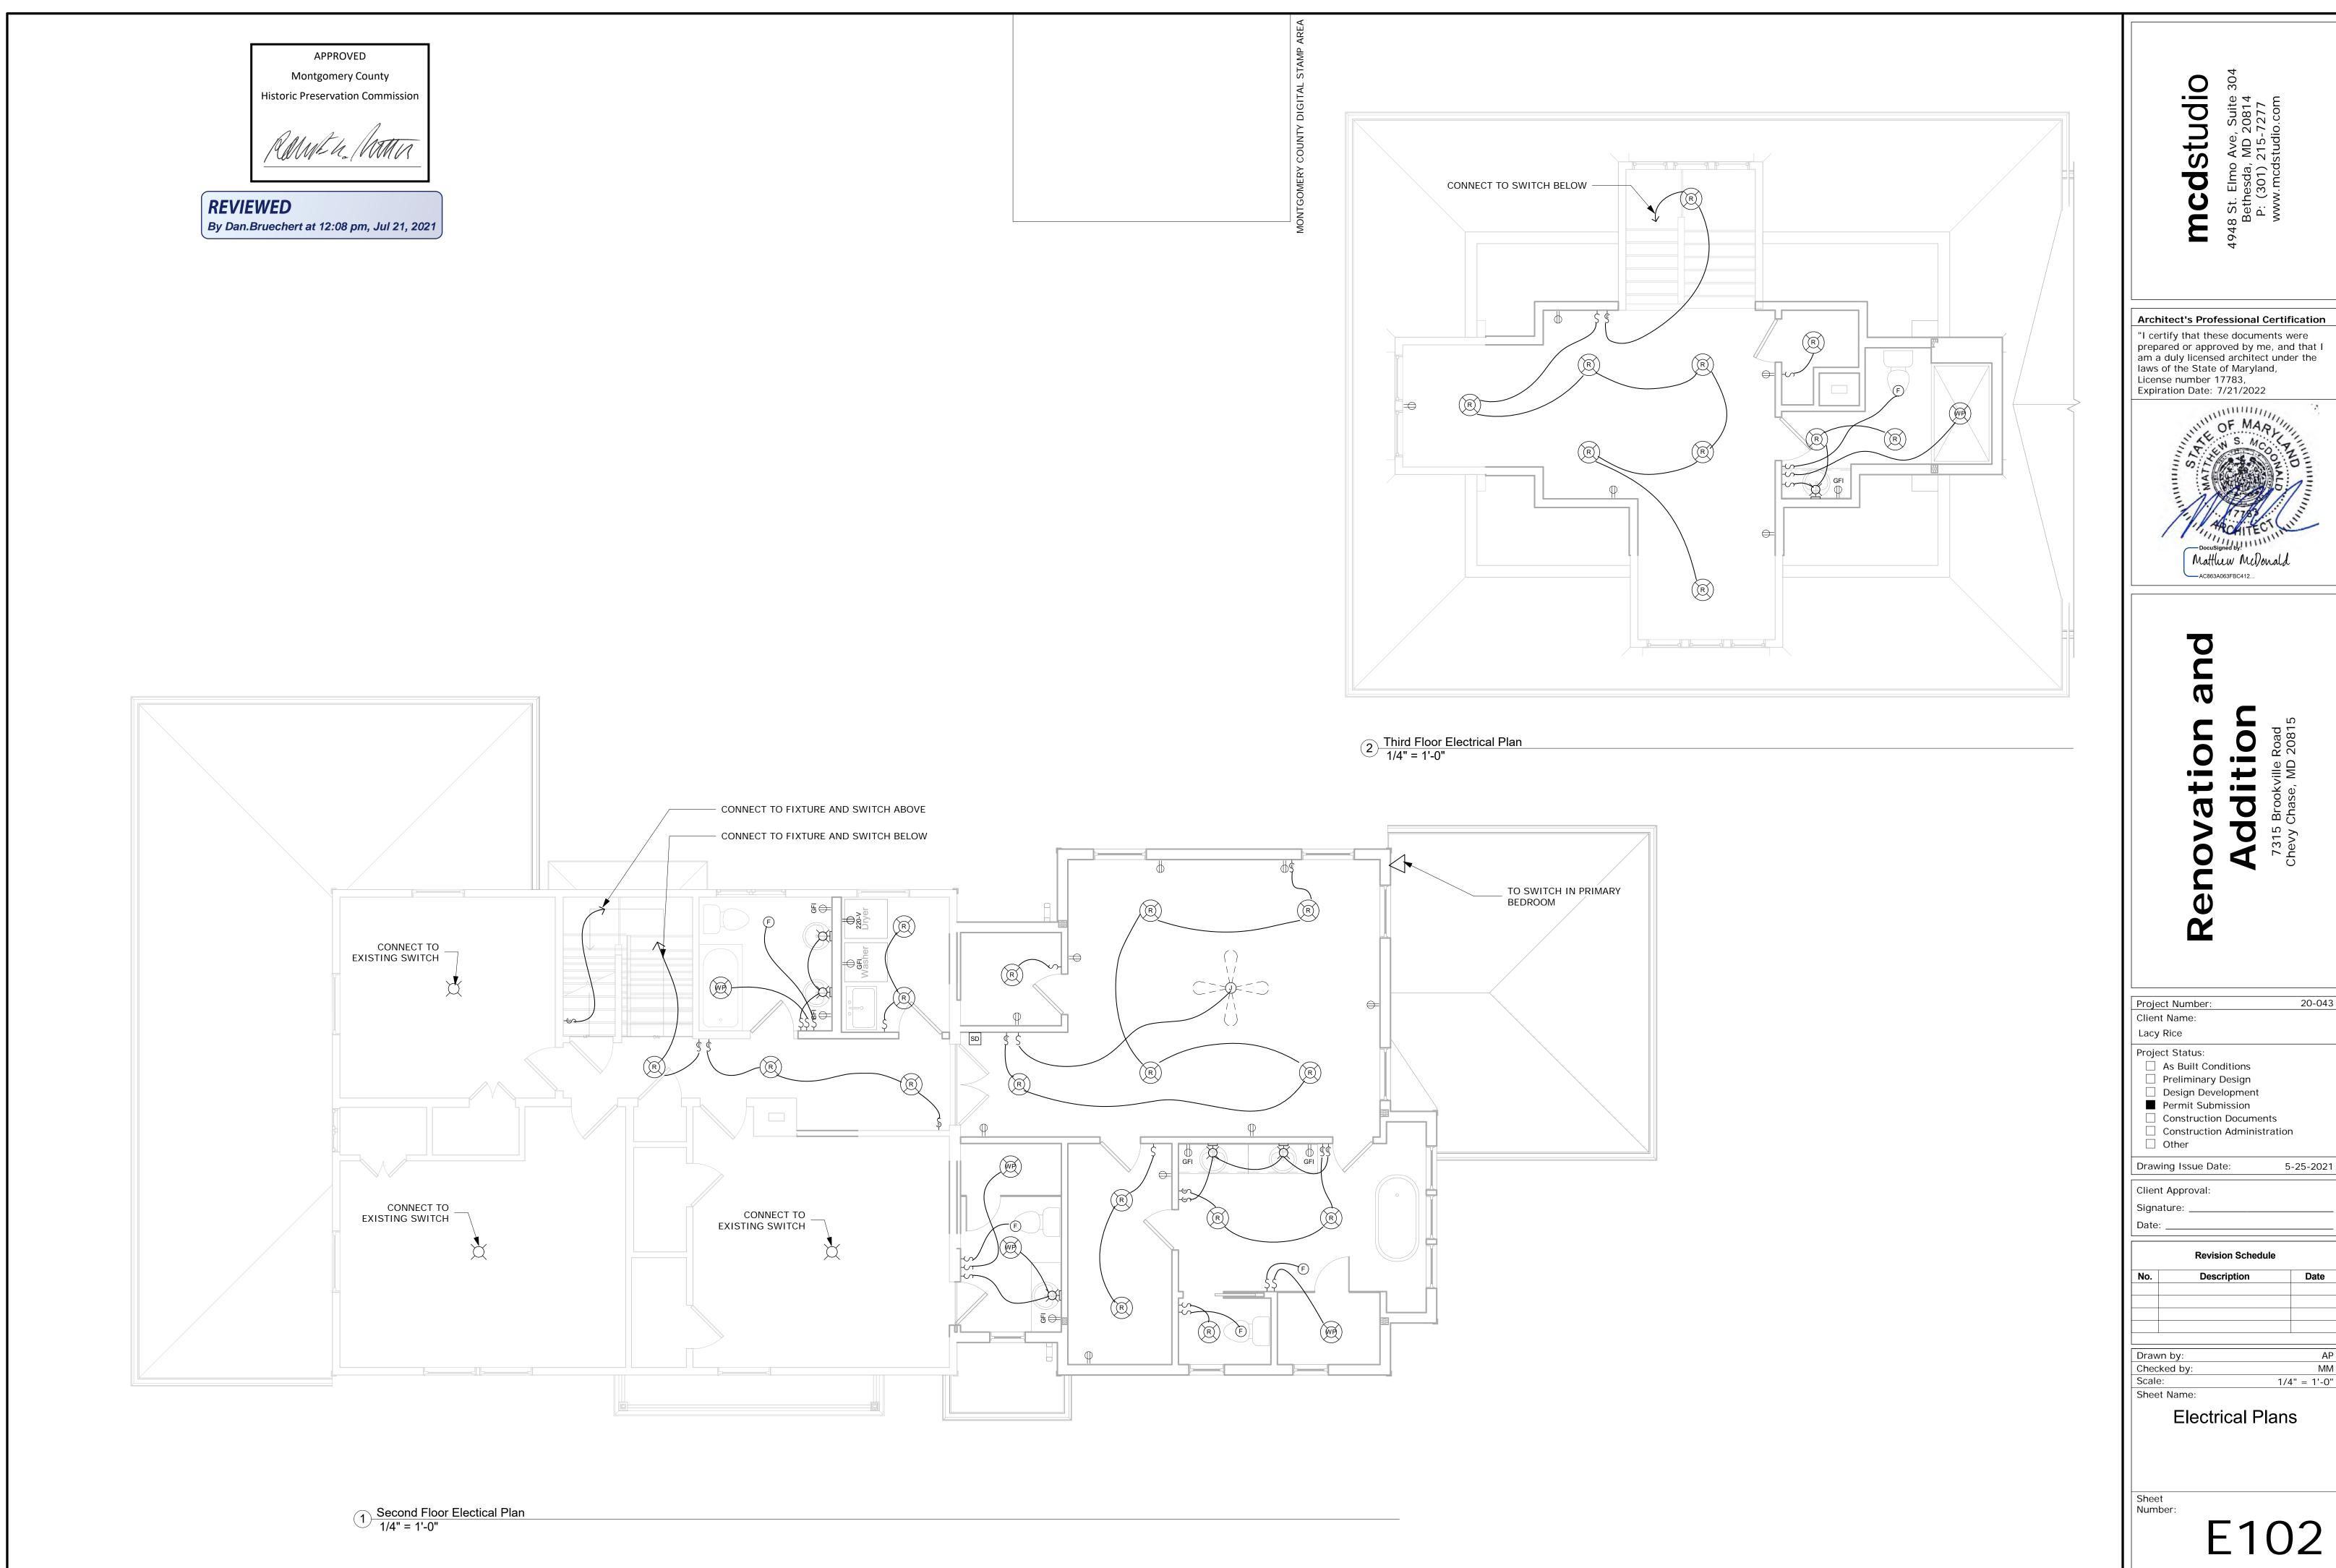
By Dan.Bruechert at 12:08 pm, Jul 21, 2021

APPROVED

Montgomery County

**Historic Preservation Commission** 

1) First Floor Electrical Plan
1/4" = 1'-0"



Matthew McDonald Addition

Project Number: 20-043 Client Name: Project Status: ☐ As Built Conditions

Preliminary Design ☐ Design Development Permit Submission ☐ Construction Documents Construction Administration

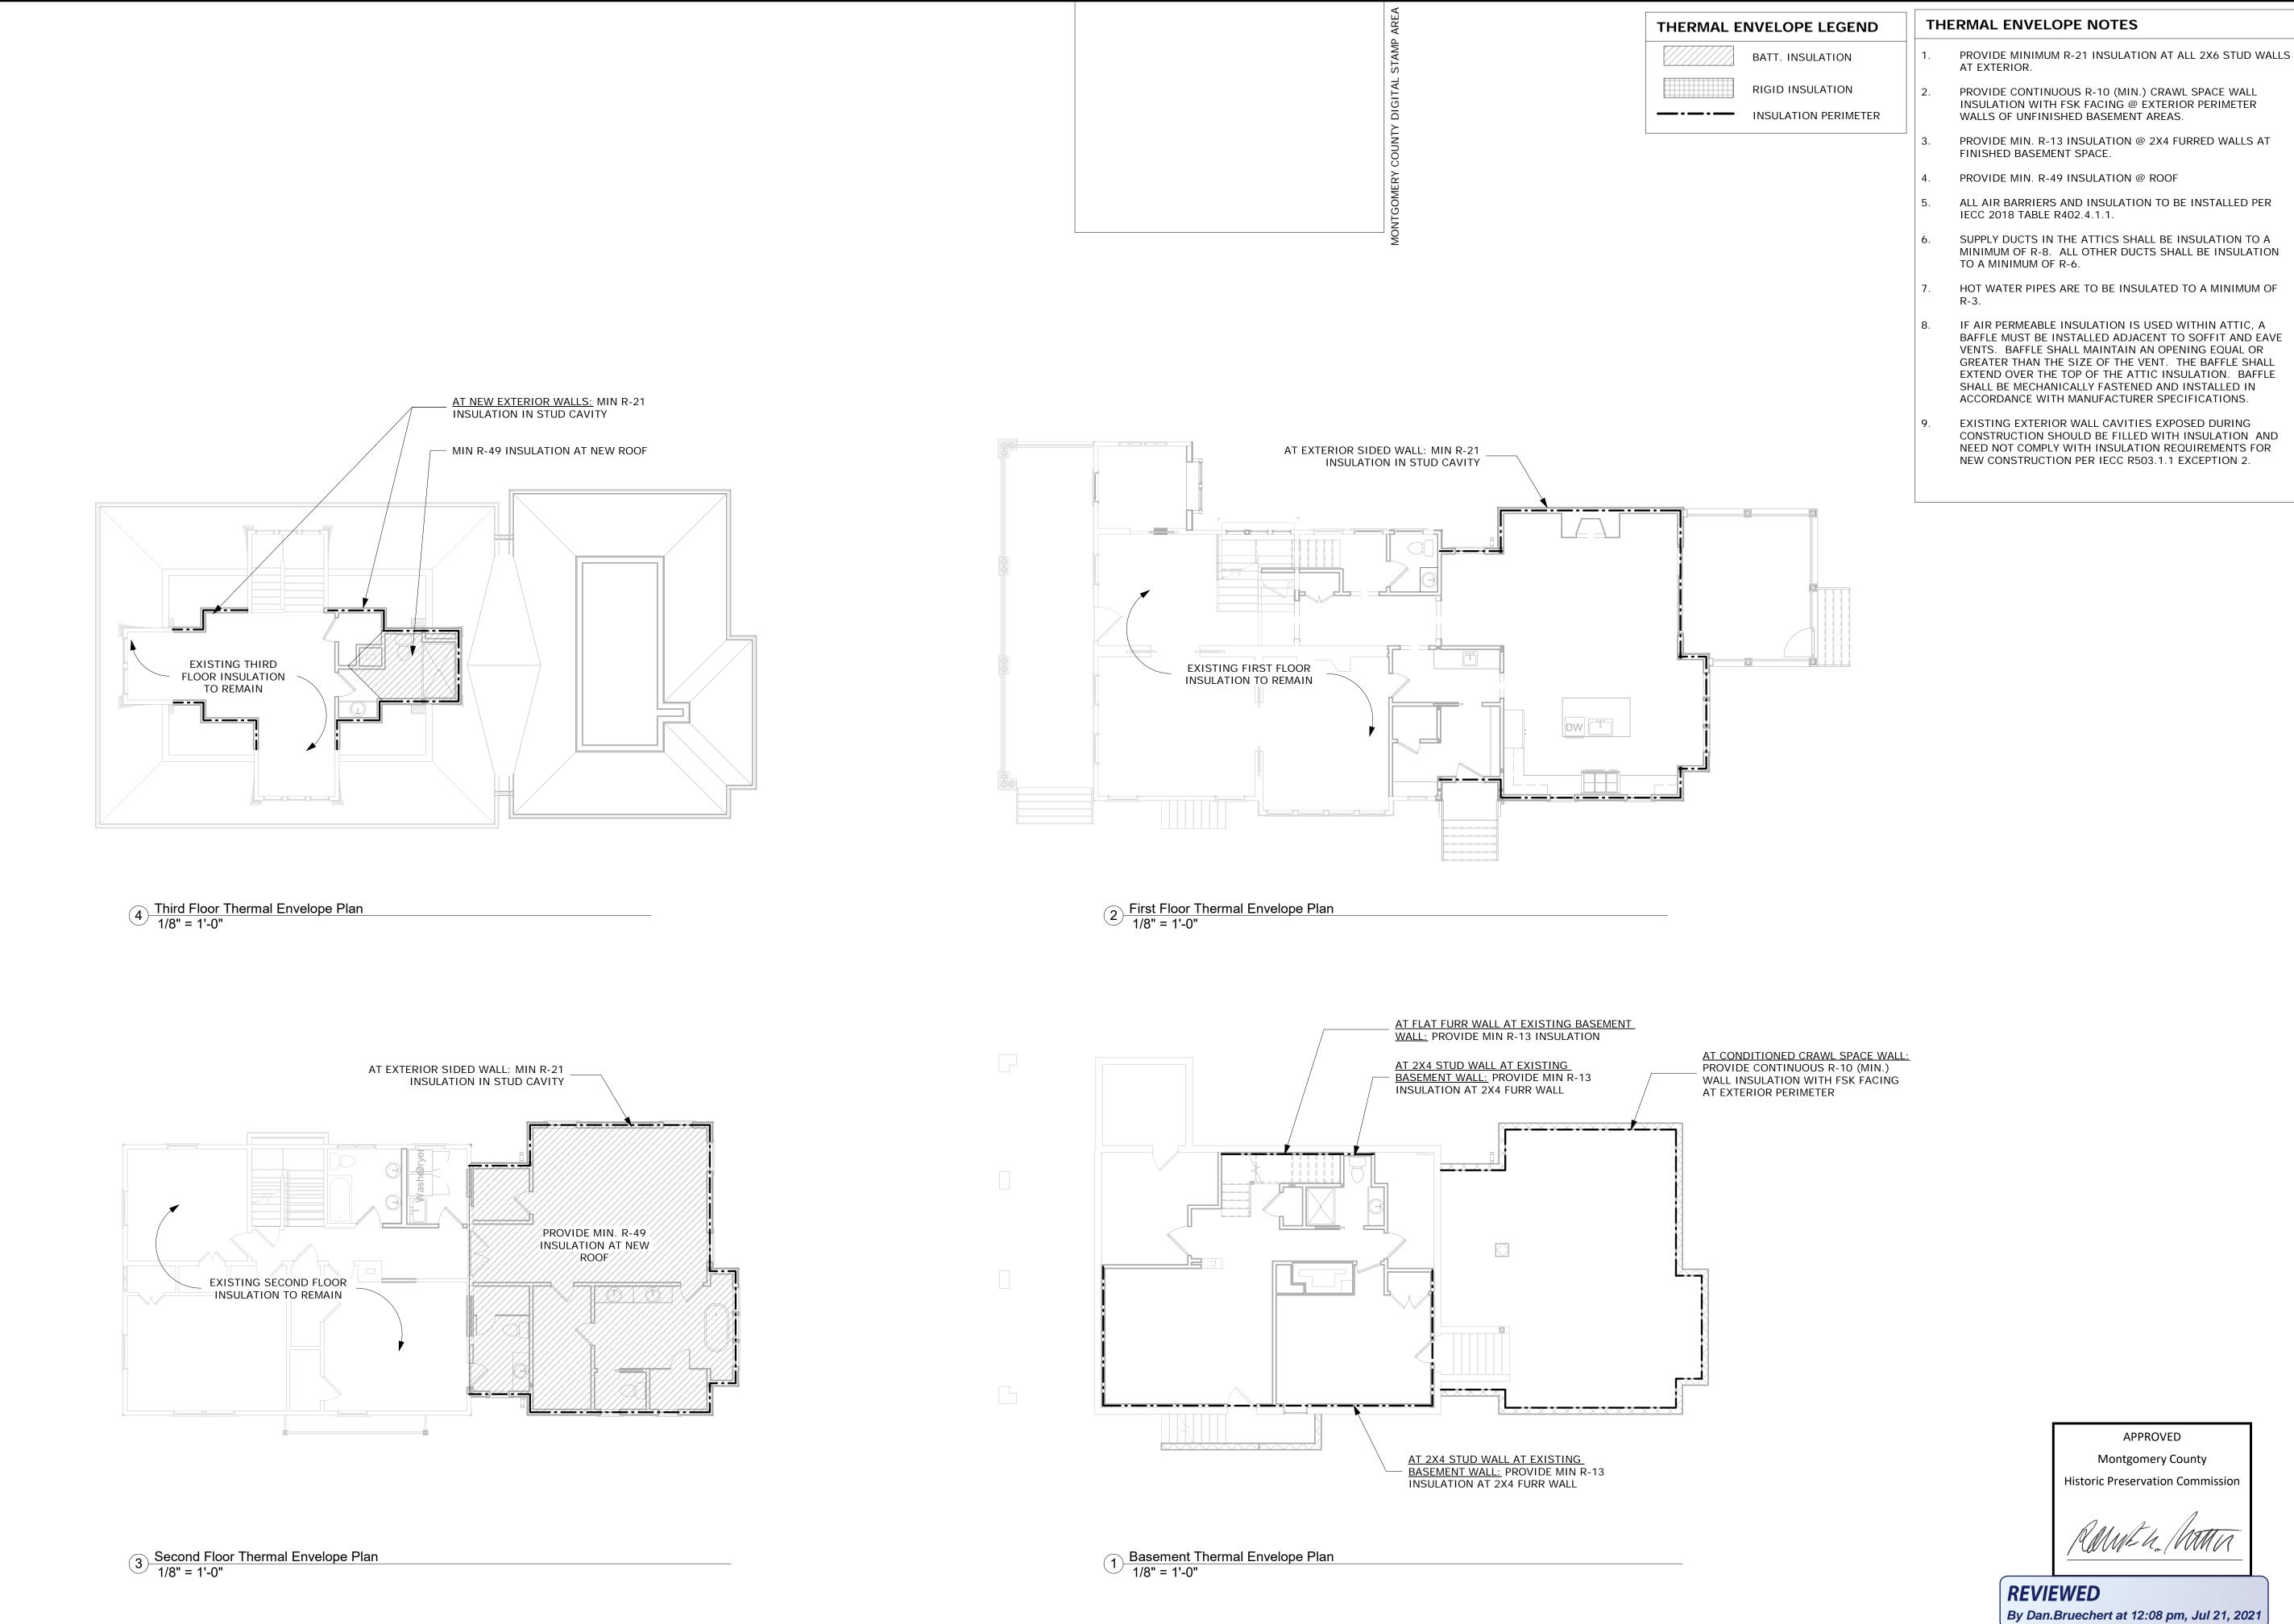
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- ALL AIR BARRIERS AND INSULATION TO BE INSTALLED PER
- BAFFLE MUST BE INSTALLED ADJACENT TO SOFFIT AND EAVE VENTS. BAFFLE SHALL MAINTAIN AN OPENING EQUAL OR GREATER THAN THE SIZE OF THE VENT. THE BAFFLE SHALL EXTEND OVER THE TOP OF THE ATTIC INSULATION. BAFFLE SHALL BE MECHANICALLY FASTENED AND INSTALLED IN
- CONSTRUCTION SHOULD BE FILLED WITH INSULATION AND NEED NOT COMPLY WITH INSULATION REQUIREMENTS FOR

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Expiration Date: 7/21/2022

Matthew McDonald

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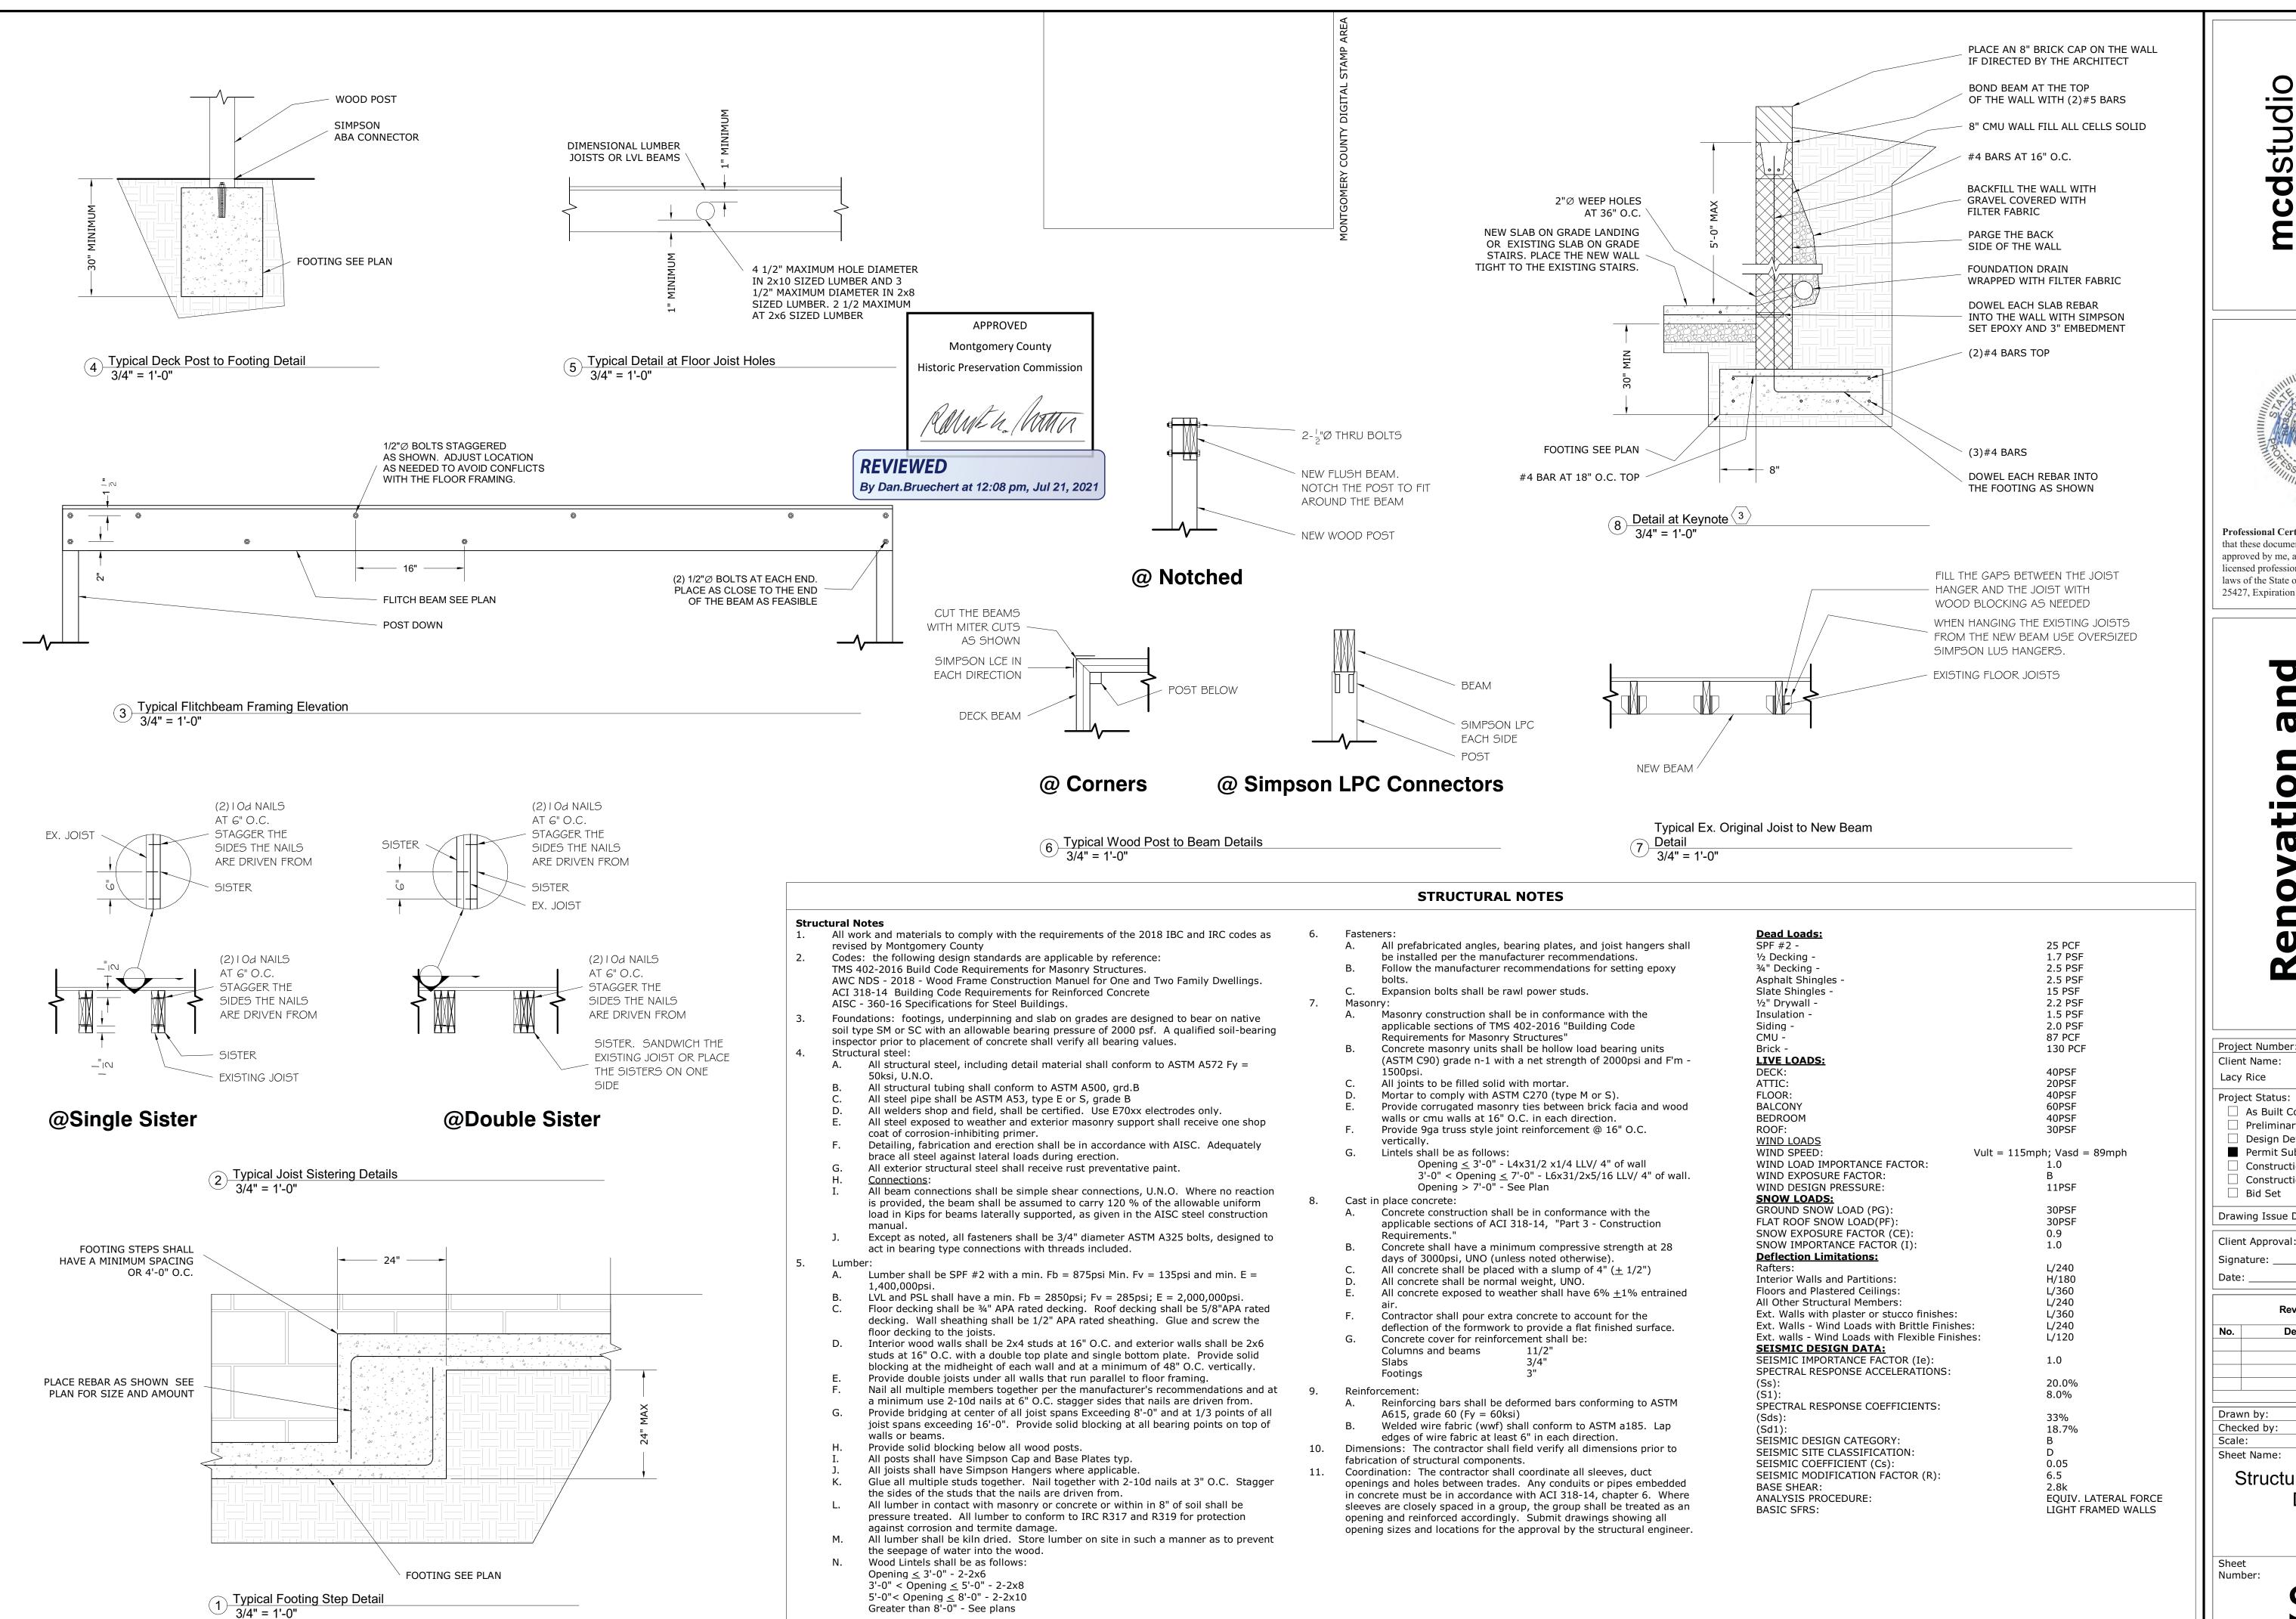
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Thermal and Energy



Greater than 8'-0" - See plans

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25427, Expiration Date: 7/17/22.

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Client Name: Project Status: As Built Conditions Preliminary Design Design Development Permit Submission Construction Documents Construction Administration Bid Set Drawing Issue Date: 5-25-2021 Client Approval: **Revision Schedule** 

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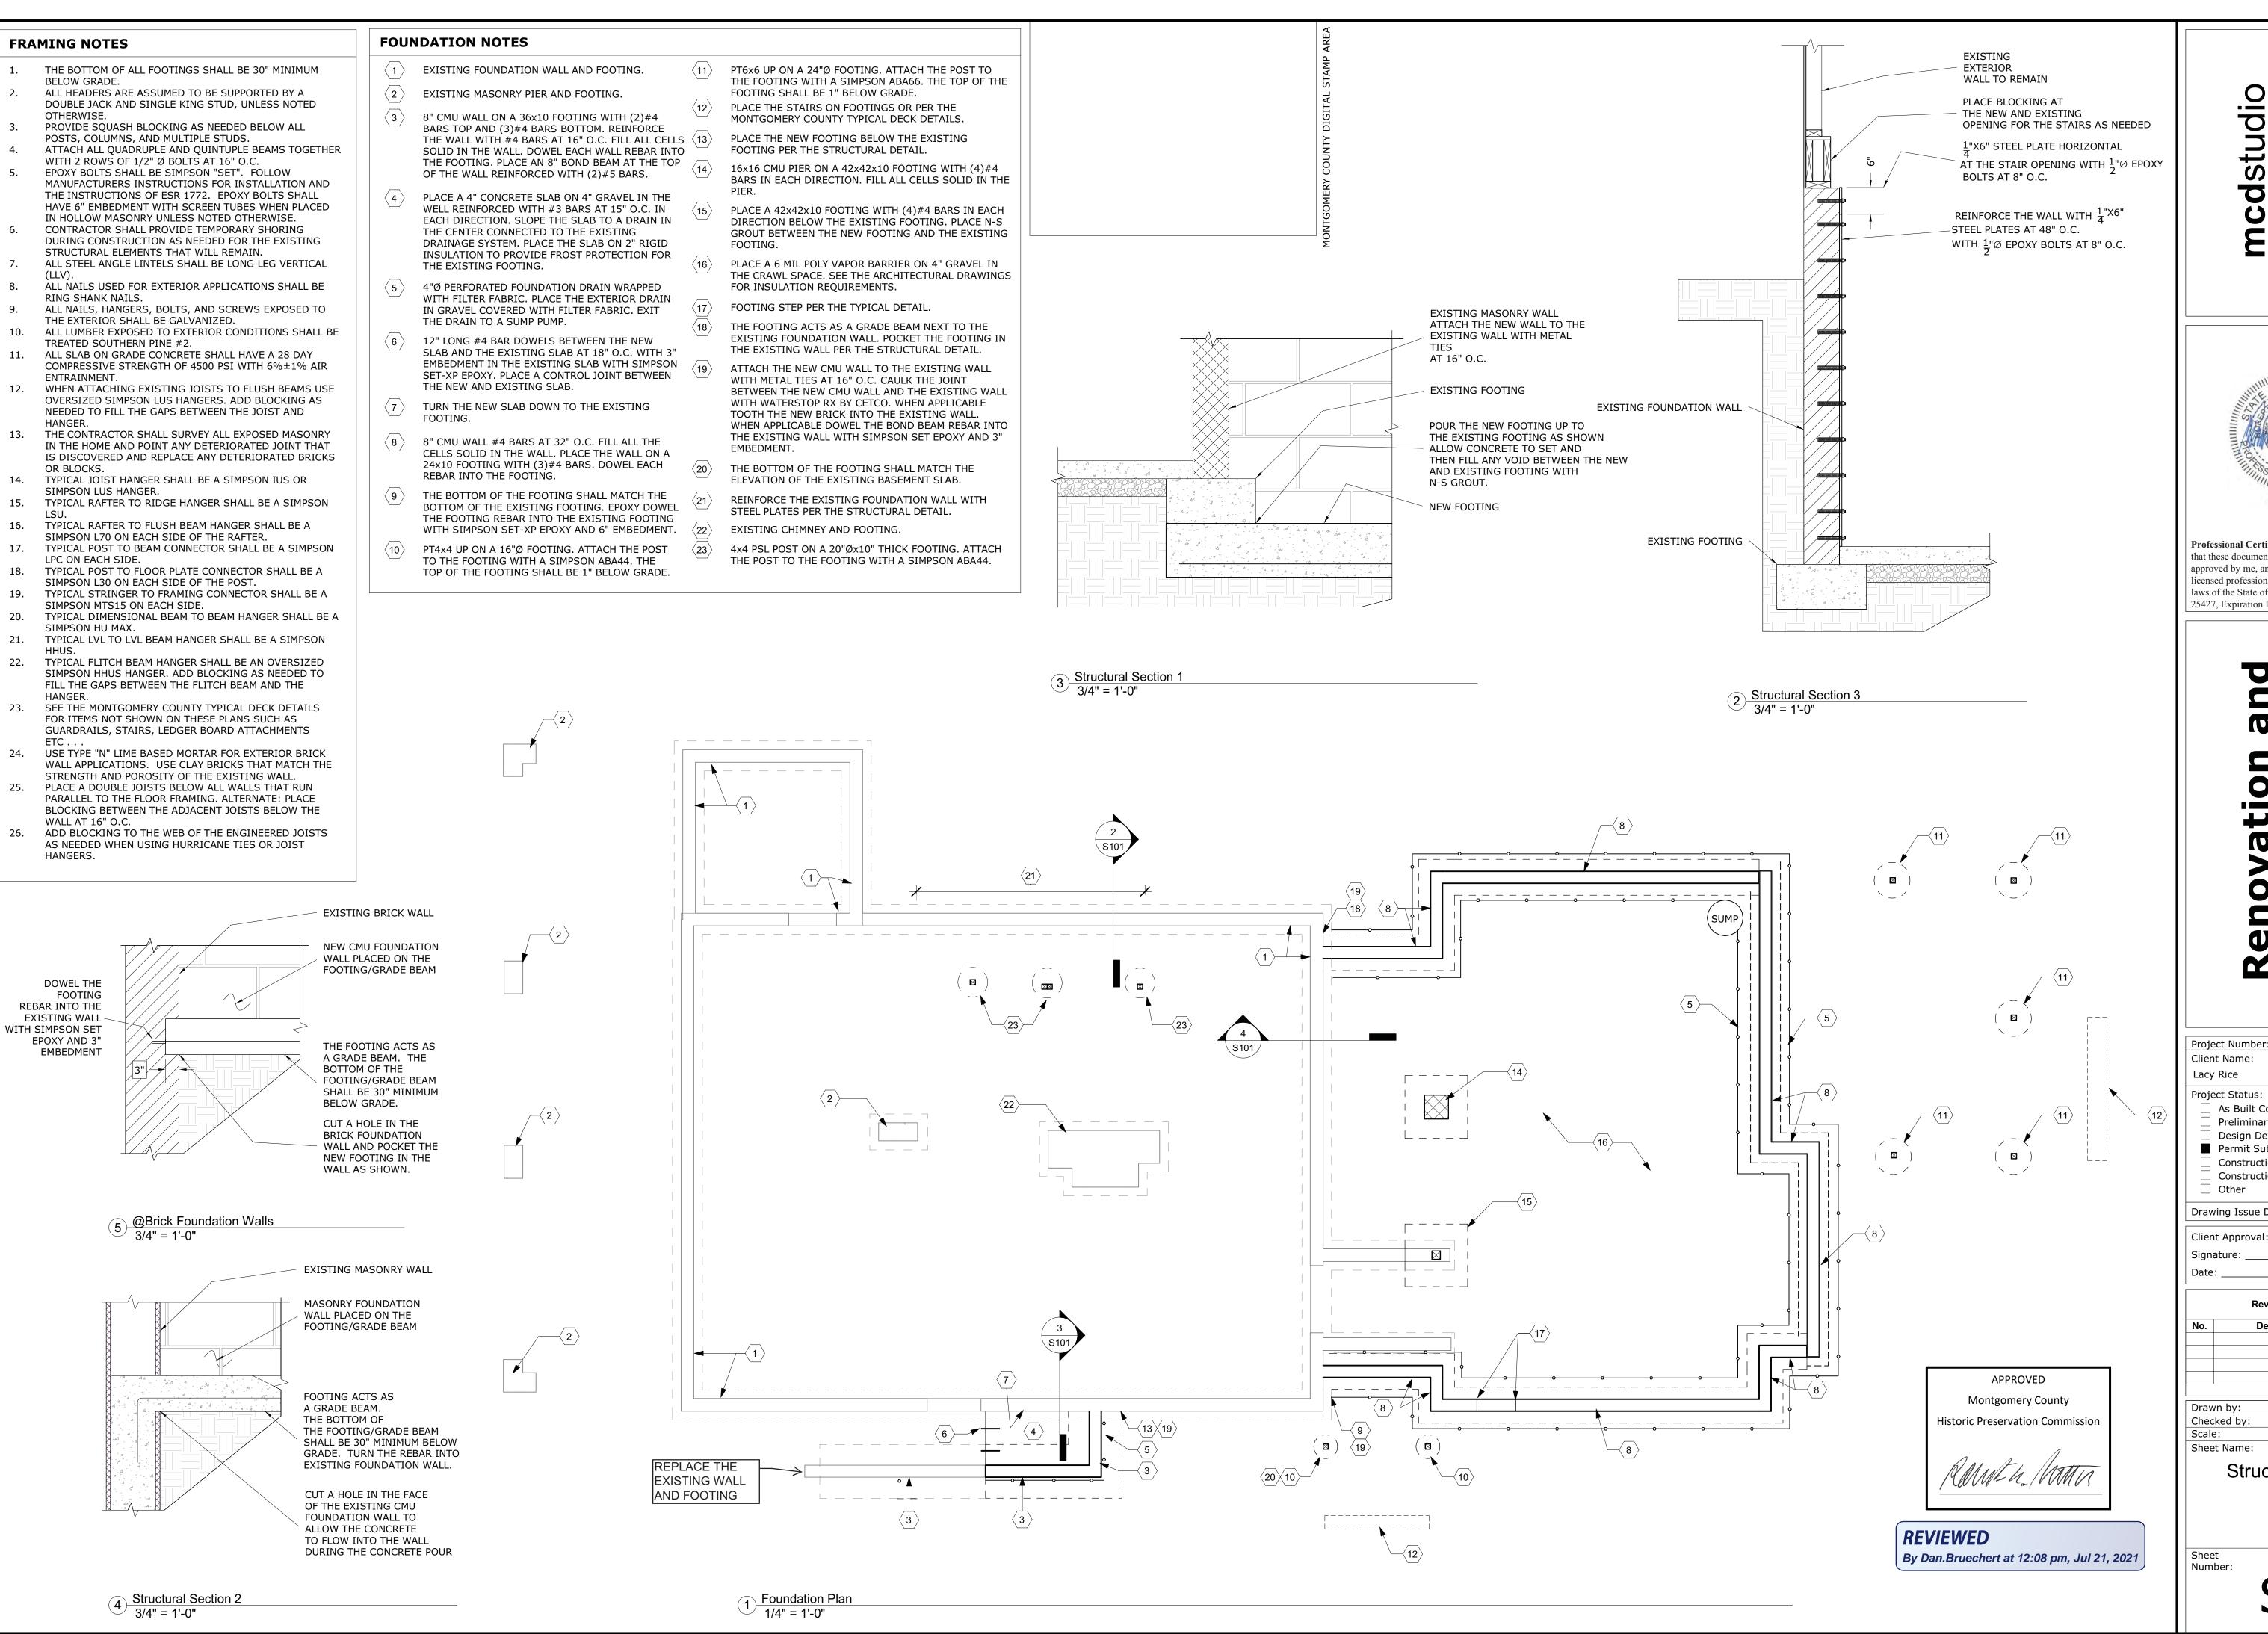
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Structural Notes and Details



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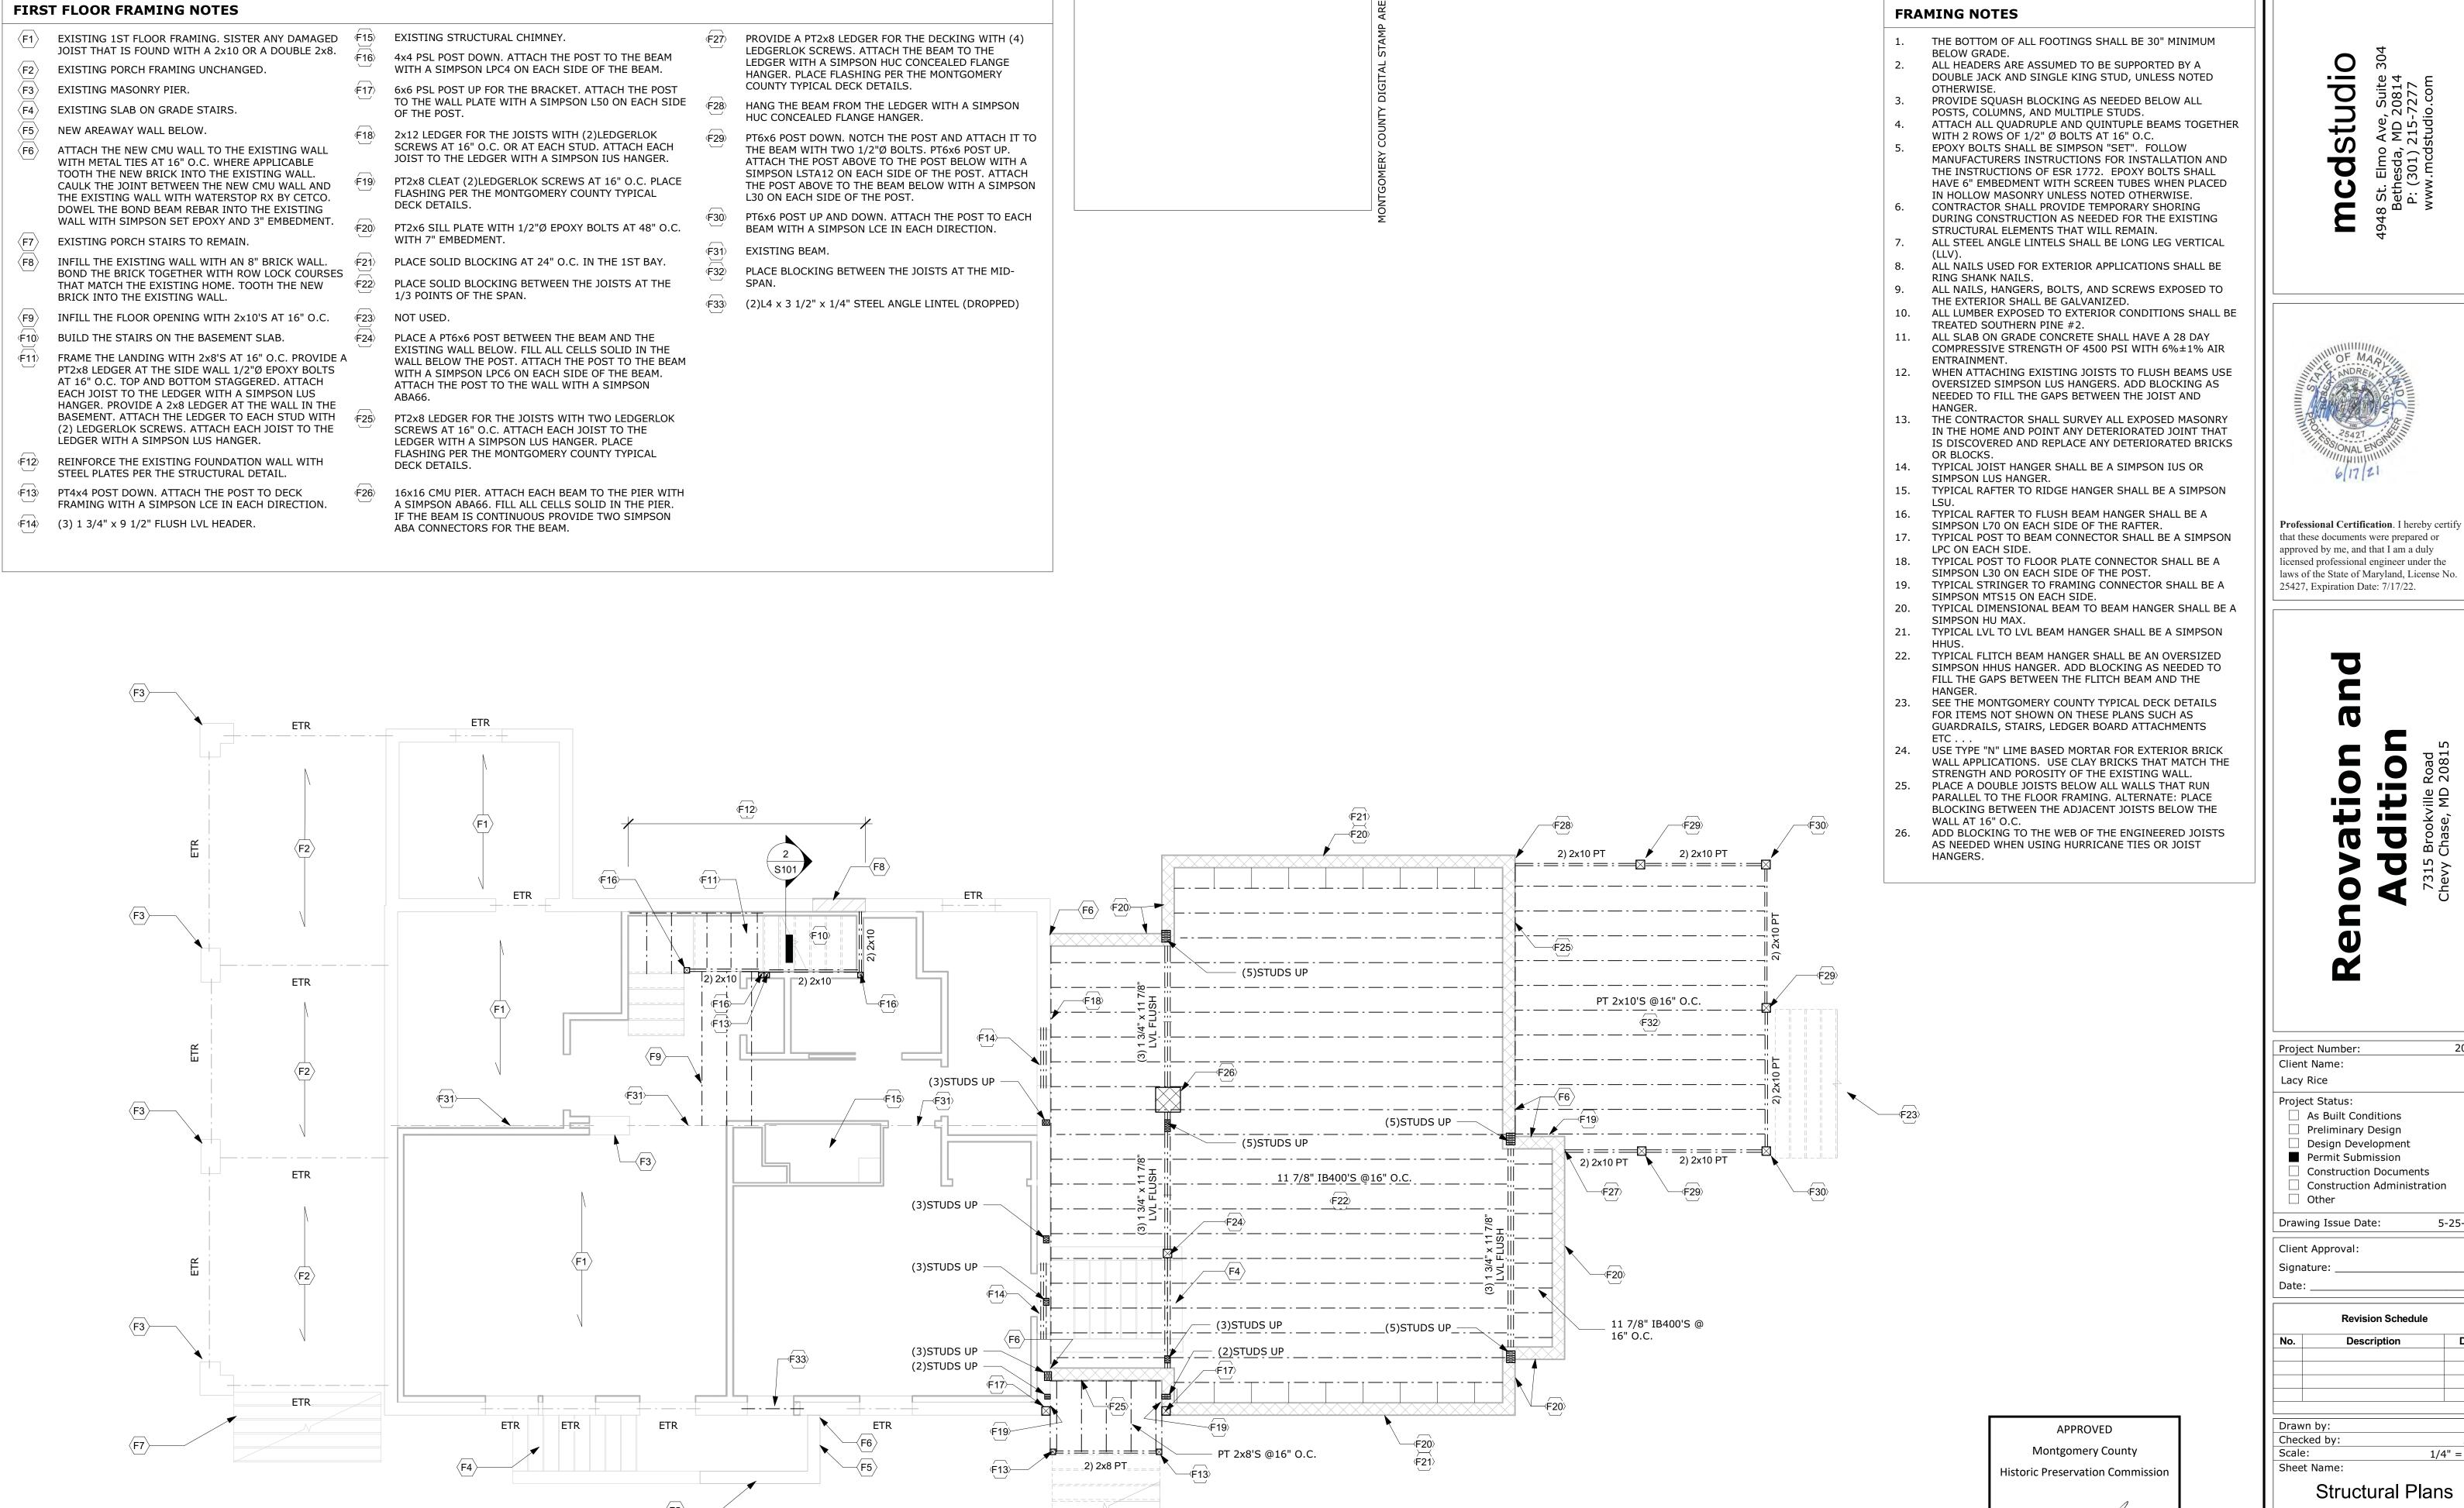
25427, Expiration Date: 7/17/22.

20-043

Client Name: Lacy Rice Project Status: As Built Conditions Preliminary Design Design Development Permit Submission Construction Documents Construction Administration 5-25-2021 Drawing Issue Date: Client Approval: Signature: **Revision Schedule** Date Drawn by: APAC Checked by:

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Structural Plans



1 First Floor Deck Framing Plan
1/4" = 1'-0"

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**Revision Schedule** 

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Structural Plans

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By Dan.Bruechert at 12:09 pm, Jul 21, 2021



#### **SECOND FLOOR FRAMING NOTES**

- EXISTING ROOF FRAMING UNCHANGED.
- EXISTING 2ND FLOOR FRAMING TO REMAIN. SISTER ANY DAMAGED JOIST THAT IS FOUND WITH 2x10 OR A DOUBLE 2x8.
- EXISTING POST.
- ATTACH THE 1ST STUD TO THE EXISTING WALL WITH (2)10d NAILS AT 6" O.C.
- INFILL THE WALL WITH 2x6 STUDS AT 16" O.C. SET THE EXISTING RAFTERS ON THE NEW WALL.
- PT6x6 POST DOWN. ATTACH THE POST TO THE BEAM
- WITH A SIMPSON LPC6 ON BOTH SIDES OF THE BEAM. PT6x6 POST DOWN. ATTACH THE POST TO EACH BEAM

WITH A SIMPSON LCE IN EACH DIRECTION.

- HANG THE BEAM FROM THE RIM BOARD WITH A SIMPSON HUC CONCEALED FLANGE HANGER. PLACE FLASHING AROUND THE BEAM.
- OVERBUILT CRICKET.
- BRACKET DESIGNED BY THE SUPPLIER. THE BRACKET ⟨S10⟩ SHALL HAVE AN ALLOWABLE LOAD OF 750 LBS.
- ATTACH EACH RAFTER TO THE SUPPORTING BEAM OR BRACKET WITH A SIMPSON H2.5A HURRICANE TIE.
- ATTACH EACH RAFTER TO THE HIP WITH (4)10d TOE ⟨\$12⟩ NAILS.
- AND THE BEAM IN THE CEILING. (\$14) HANG THE RIDGE BEAM FROM THE CLEATS WITH A SIMPSON LUS HANGER. NOTCH THE RIDGE AS NEEDED TO FIT IN THE CONNECTOR.

PLACE A TRIPLE STUD BETWEEN THE RIDGE AND HIPS

- S15 DOUBLE 2x8 BEAM IN THE CEILING.
- 2x8 CLEAT WITH (2)#8 SCREWS AT 6" O.C. EACH SIDE OF THE RIDGE.
- SET THE BEAM ON THE BRACKET. ATTACH THE BEAM TO THE BRACKET WITH A SIMPSON H2.5A HURRICANE TIE ON EACH SIDE OF THE BEAM.
- (\$18) PLACE A 6x6 PSL POST IN THE WALL BEHIND THE BRACKET. ATTACH THE BRACKET TO THE POST PER THE SUPPLIERS RECOMMENDATIONS. ATTACH THE POST TO THE TOP AND BOTTOM PLATE OF THE WALL WITH A SIMPSON L50 ON EACH SIDE OF THE POST.
- HANG THE RAFTERS AND THE CEILING BEAM AND CEILING JOISTS FROM THE RIM BOARD WITH A SIMPSON LUS HANGER. NOTCH THE RAFTERS AS NEEDED TO FIT IN THE CONNECTOR.
- PROVIDE OVERBUILT CRICKETS AS NEEDED TO SHED (S20) WATER.
- (S21) PLACE A DOUBLE JACK STUD BETWEEN EACH WINDOW.
- INFILL THE WALL WITH 2x STUDS AT 16" O.C. THE STUDS SHALL MATCH THE SIZE OF THE EXISTING WALL STUDS.
- POINT OF THE SPAN.

#### FRAMING NOTES

- THE BOTTOM OF ALL FOOTINGS SHALL BE 30" MINIMUM BELOW GRADE.
- ALL HEADERS ARE ASSUMED TO BE SUPPORTED BY A DOUBLE JACK AND SINGLE KING STUD, UNLESS NOTED OTHERWISE.

PROVIDE SQUASH BLOCKING AS NEEDED BELOW ALL

- POSTS, COLUMNS, AND MULTIPLE STUDS. ATTACH ALL QUADRUPLE AND QUINTUPLE BEAMS TOGETHER WITH 2 ROWS OF 1/2" Ø BOLTS AT 16" O.C. EPOXY BOLTS SHALL BE SIMPSON "SET". FOLLOW
- MANUFACTURERS INSTRUCTIONS FOR INSTALLATION AND THE INSTRUCTIONS OF ESR 1772. EPOXY BOLTS SHALL HAVE 6" EMBEDMENT WITH SCREEN TUBES WHEN PLACED IN HOLLOW MASONRY UNLESS NOTED OTHERWISE.
- CONTRACTOR SHALL PROVIDE TEMPORARY SHORING DURING CONSTRUCTION AS NEEDED FOR THE EXISTING STRUCTURAL ELEMENTS THAT WILL REMAIN.
- ALL STEEL ANGLE LINTELS SHALL BE LONG LEG VERTICAL
- ALL NAILS USED FOR EXTERIOR APPLICATIONS SHALL BE RING SHANK NAILS.
- ALL NAILS, HANGERS, BOLTS, AND SCREWS EXPOSED TO THE EXTERIOR SHALL BE GALVANIZED. ALL LUMBER EXPOSED TO EXTERIOR CONDITIONS SHALL BE
- TREATED SOUTHERN PINE #2. ALL SLAB ON GRADE CONCRETE SHALL HAVE A 28 DAY COMPRESSIVE STRENGTH OF 4500 PSI WITH 6%±1% AIR
- WHEN ATTACHING EXISTING JOISTS TO FLUSH BEAMS USE OVERSIZED SIMPSON LUS HANGERS. ADD BLOCKING AS NEEDED TO FILL THE GAPS BETWEEN THE JOIST AND
- 13. THE CONTRACTOR SHALL SURVEY ALL EXPOSED MASONRY IN THE HOME AND POINT ANY DETERIORATED JOINT THAT IS DISCOVERED AND REPLACE ANY DETERIORATED BRICKS
- OR BLOCKS. 14. TYPICAL JOIST HANGER SHALL BE A SIMPSON IUS OR
- SIMPSON LUS HANGER. TYPICAL RAFTER TO RIDGE HANGER SHALL BE A SIMPSON 15.
- TYPICAL RAFTER TO FLUSH BEAM HANGER SHALL BE A SIMPSON L70 ON EACH SIDE OF THE RAFTER.
- TYPICAL POST TO BEAM CONNECTOR SHALL BE A SIMPSON LPC ON EACH SIDE.
- TYPICAL POST TO FLOOR PLATE CONNECTOR SHALL BE A SIMPSON L30 ON EACH SIDE OF THE POST. TYPICAL STRINGER TO FRAMING CONNECTOR SHALL BE A
- SIMPSON MTS15 ON EACH SIDE. TYPICAL DIMENSIONAL BEAM TO BEAM HANGER SHALL BE A 20.
- SIMPSON HU MAX. TYPICAL LVL TO LVL BEAM HANGER SHALL BE A SIMPSON
- 22. TYPICAL FLITCH BEAM HANGER SHALL BE AN OVERSIZED SIMPSON HHUS HANGER. ADD BLOCKING AS NEEDED TO FILL THE GAPS BETWEEN THE FLITCH BEAM AND THE
- 23. SEE THE MONTGOMERY COUNTY TYPICAL DECK DETAILS FOR ITEMS NOT SHOWN ON THESE PLANS SUCH AS GUARDRAILS, STAIRS, LEDGER BOARD ATTACHMENTS
- ETC . . USE TYPE "N" LIME BASED MORTAR FOR EXTERIOR BRICK WALL APPLICATIONS. USE CLAY BRICKS THAT MATCH THE
- STRENGTH AND POROSITY OF THE EXISTING WALL. PLACE A DOUBLE JOISTS BELOW ALL WALLS THAT RUN PARALLEL TO THE FLOOR FRAMING. ALTERNATE: PLACE BLOCKING BETWEEN THE ADJACENT JOISTS BELOW THE WALL AT 16" O.C.
- ADD BLOCKING TO THE WEB OF THE ENGINEERED JOISTS AS NEEDED WHEN USING HURRICANE TIES OR JOIST HANGERS.



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Project Number:	20-043
Client Name:	
Lacy Rice	
Project Status:	
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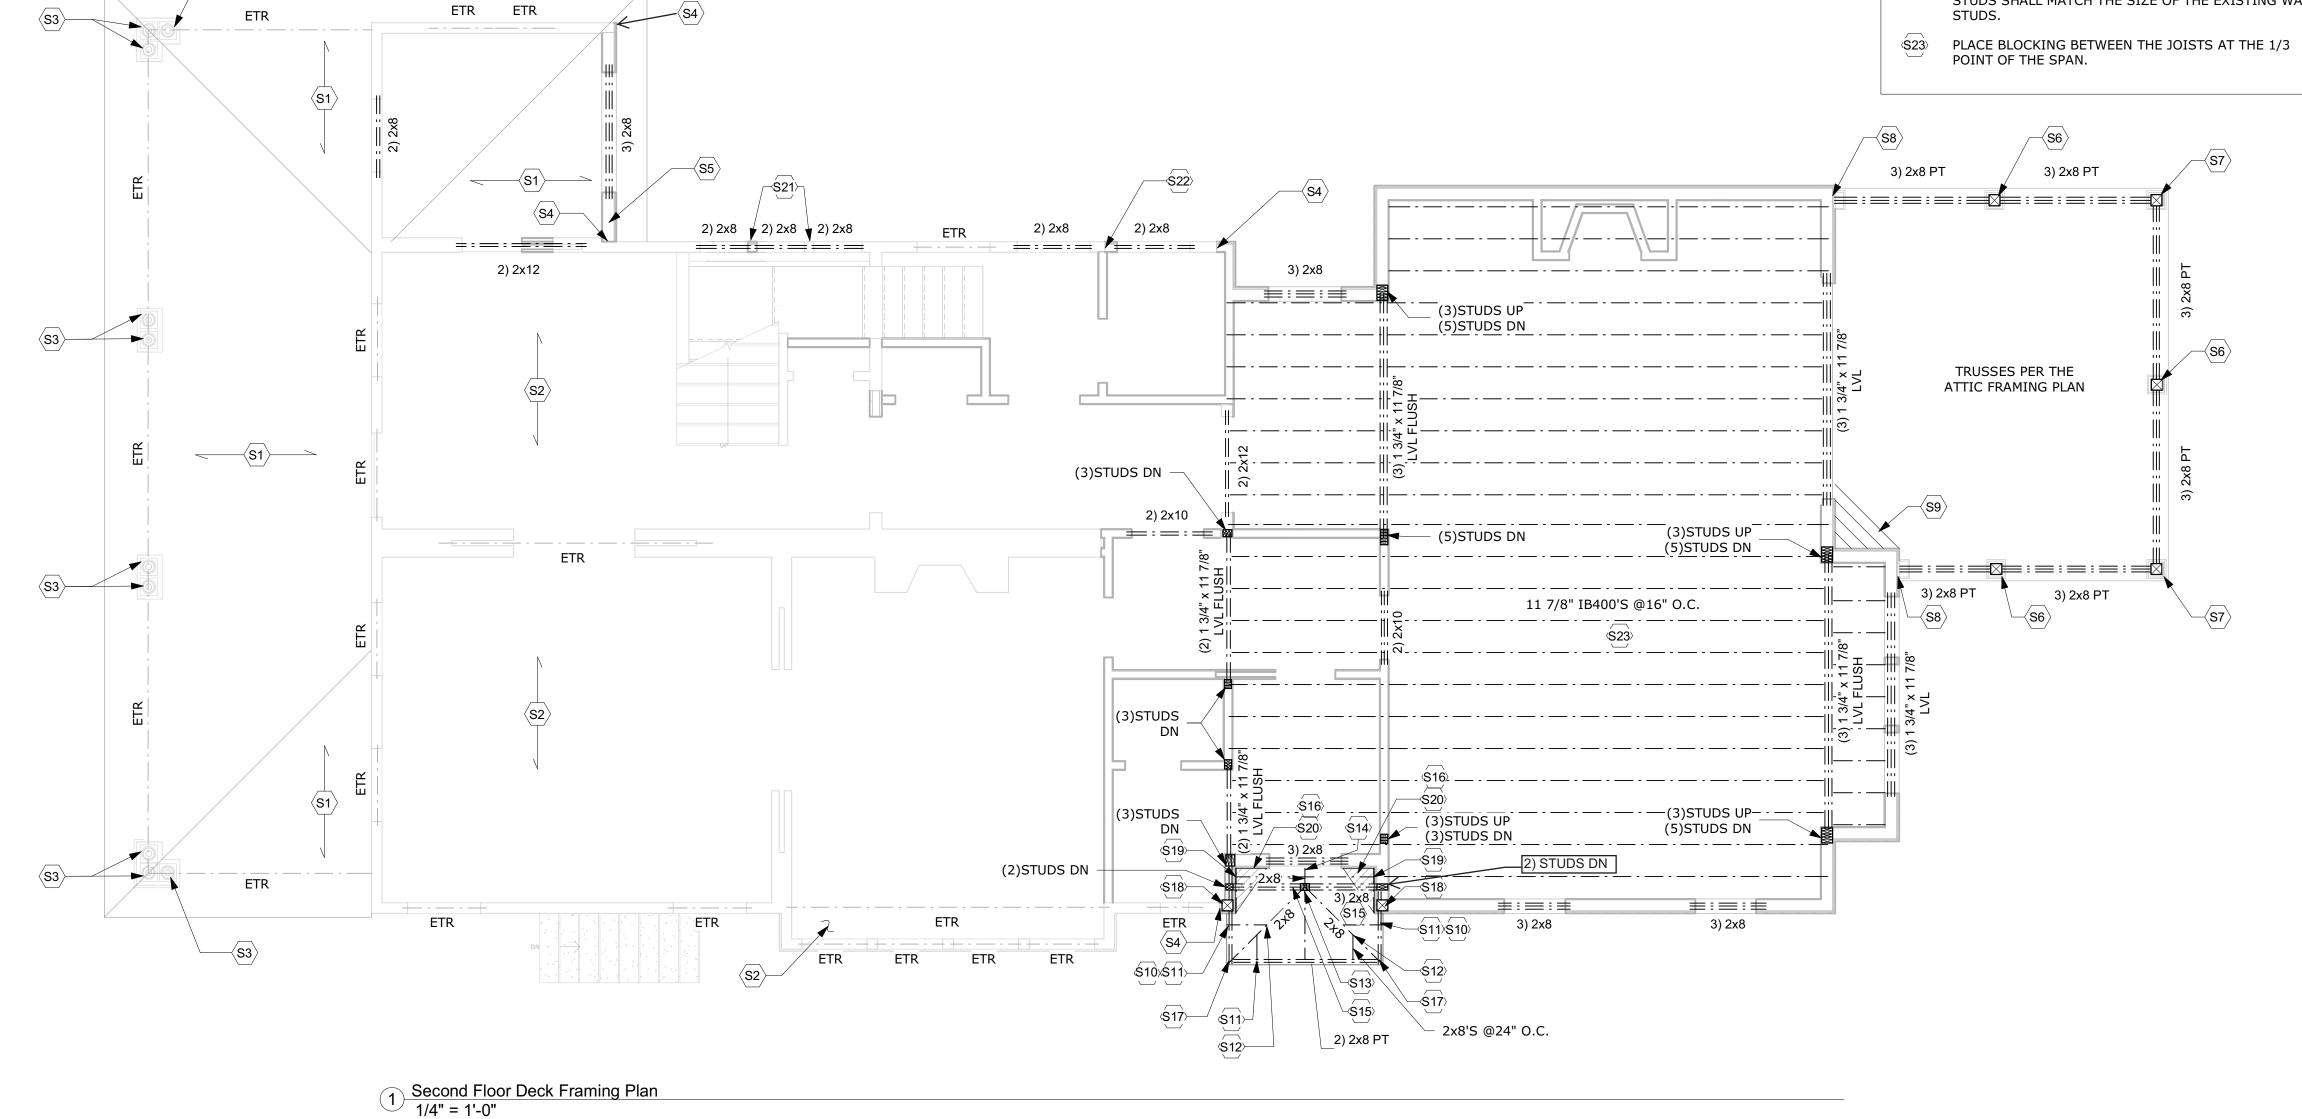
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Revision Schedule		
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Structural Plans



#### THIRD FLOOR FRAMING NOTES

- INFILL THE WALL WITH 2x STUDS AT 16" O.C. THE STUDS SHALL MATCH THE SIZE OF THE EXISTING WALL
- ATTACH THE 1ST STUD TO THE EXISTING WALL WITH (2)10d NAILS AT 6" O.C.
- $\langle \mathsf{T4} \rangle$ OVERBUILT CRICKET.
- THE TRUSS MANUFACTURER SHALL COORDINATE THE ROOF AND CEILING LINES WITH THE ARCHITECTURAL
- ATTACH EACH TRUSS TO THE SUPPORTING BEAM WITH A SIMPSON H2.5A HURRICANE TIE.
- 2x6 LEDGER WITH (2)LEDGERLOK SCREWS AT 16" O.C. ATTACH EACH TRUSS TO THE LEDGER WITH A SIMPSON LUS HANGER.
- 2x8 CLEAT FOR THE ROOF AND A 2x6 CLEAT FOR THE CEILING. ATTACH EACH CLEAT TO THE WALL WITH (2)#8 SCREWS AT 6" O.C.

- ⟨T1⟩ EXISTING 3RD FLOOR FRAMING TO REMAIN. SISTER ANY DAMAGED JOIST THAT IS FOUND WITH A 2x10 OR A DOUBLE 2x8.

#### FRAMING NOTES

- THE BOTTOM OF ALL FOOTINGS SHALL BE 30" MINIMUM
- ALL HEADERS ARE ASSUMED TO BE SUPPORTED BY A DOUBLE JACK AND SINGLE KING STUD, UNLESS NOTED OTHERWISE.

PROVIDE SQUASH BLOCKING AS NEEDED BELOW ALL

POSTS, COLUMNS, AND MULTIPLE STUDS. 4. ATTACH ALL QUADRUPLE AND QUINTUPLE BEAMS TOGETHER WITH 2 ROWS OF 1/2" Ø BOLTS AT 16" O.C. EPOXY BOLTS SHALL BE SIMPSON "SET". FOLLOW

MANUFACTURERS INSTRUCTIONS FOR INSTALLATION AND

- THE INSTRUCTIONS OF ESR 1772. EPOXY BOLTS SHALL HAVE 6" EMBEDMENT WITH SCREEN TUBES WHEN PLACED IN HOLLOW MASONRY UNLESS NOTED OTHERWISE. CONTRACTOR SHALL PROVIDE TEMPORARY SHORING
- DURING CONSTRUCTION AS NEEDED FOR THE EXISTING STRUCTURAL ELEMENTS THAT WILL REMAIN.
- ALL STEEL ANGLE LINTELS SHALL BE LONG LEG VERTICAL
- 8. ALL NAILS USED FOR EXTERIOR APPLICATIONS SHALL BE RING SHANK NAILS.
- ALL NAILS, HANGERS, BOLTS, AND SCREWS EXPOSED TO THE EXTERIOR SHALL BE GALVANIZED. ALL LUMBER EXPOSED TO EXTERIOR CONDITIONS SHALL BE
- TREATED SOUTHERN PINE #2. ALL SLAB ON GRADE CONCRETE SHALL HAVE A 28 DAY COMPRESSIVE STRENGTH OF 4500 PSI WITH 6%±1% AIR
- WHEN ATTACHING EXISTING JOISTS TO FLUSH BEAMS USE OVERSIZED SIMPSON LUS HANGERS. ADD BLOCKING AS NEEDED TO FILL THE GAPS BETWEEN THE JOIST AND
- THE CONTRACTOR SHALL SURVEY ALL EXPOSED MASONRY IN THE HOME AND POINT ANY DETERIORATED JOINT THAT IS DISCOVERED AND REPLACE ANY DETERIORATED BRICKS OR BLOCKS.
- TYPICAL JOIST HANGER SHALL BE A SIMPSON IUS OR SIMPSON LUS HANGER.
- TYPICAL RAFTER TO RIDGE HANGER SHALL BE A SIMPSON
- TYPICAL RAFTER TO FLUSH BEAM HANGER SHALL BE A SIMPSON L70 ON EACH SIDE OF THE RAFTER. TYPICAL POST TO BEAM CONNECTOR SHALL BE A SIMPSON
- TYPICAL POST TO FLOOR PLATE CONNECTOR SHALL BE A SIMPSON L30 ON EACH SIDE OF THE POST.
- TYPICAL STRINGER TO FRAMING CONNECTOR SHALL BE A SIMPSON MTS15 ON EACH SIDE. 20. TYPICAL DIMENSIONAL BEAM TO BEAM HANGER SHALL BE A
- SIMPSON HU MAX. TYPICAL LVL TO LVL BEAM HANGER SHALL BE A SIMPSON
- TYPICAL FLITCH BEAM HANGER SHALL BE AN OVERSIZED SIMPSON HHUS HANGER. ADD BLOCKING AS NEEDED TO FILL THE GAPS BETWEEN THE FLITCH BEAM AND THE
- 23. SEE THE MONTGOMERY COUNTY TYPICAL DECK DETAILS FOR ITEMS NOT SHOWN ON THESE PLANS SUCH AS GUARDRAILS, STAIRS, LEDGER BOARD ATTACHMENTS
- USE TYPE "N" LIME BASED MORTAR FOR EXTERIOR BRICK WALL APPLICATIONS. USE CLAY BRICKS THAT MATCH THE STRENGTH AND POROSITY OF THE EXISTING WALL. PLACE A DOUBLE JOISTS BELOW ALL WALLS THAT RUN PARALLEL TO THE FLOOR FRAMING, ALTERNATE: PLACE
- BLOCKING BETWEEN THE ADJACENT JOISTS BELOW THE WALL AT 16" O.C. ADD BLOCKING TO THE WEB OF THE ENGINEERED JOISTS AS NEEDED WHEN USING HURRICANE TIES OR JOIST

APPROVED

Montgomery County

**Historic Preservation Commission** 

By Dan.Bruechert at 12:09 pm, Jul 21, 2021

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Lacy Rice

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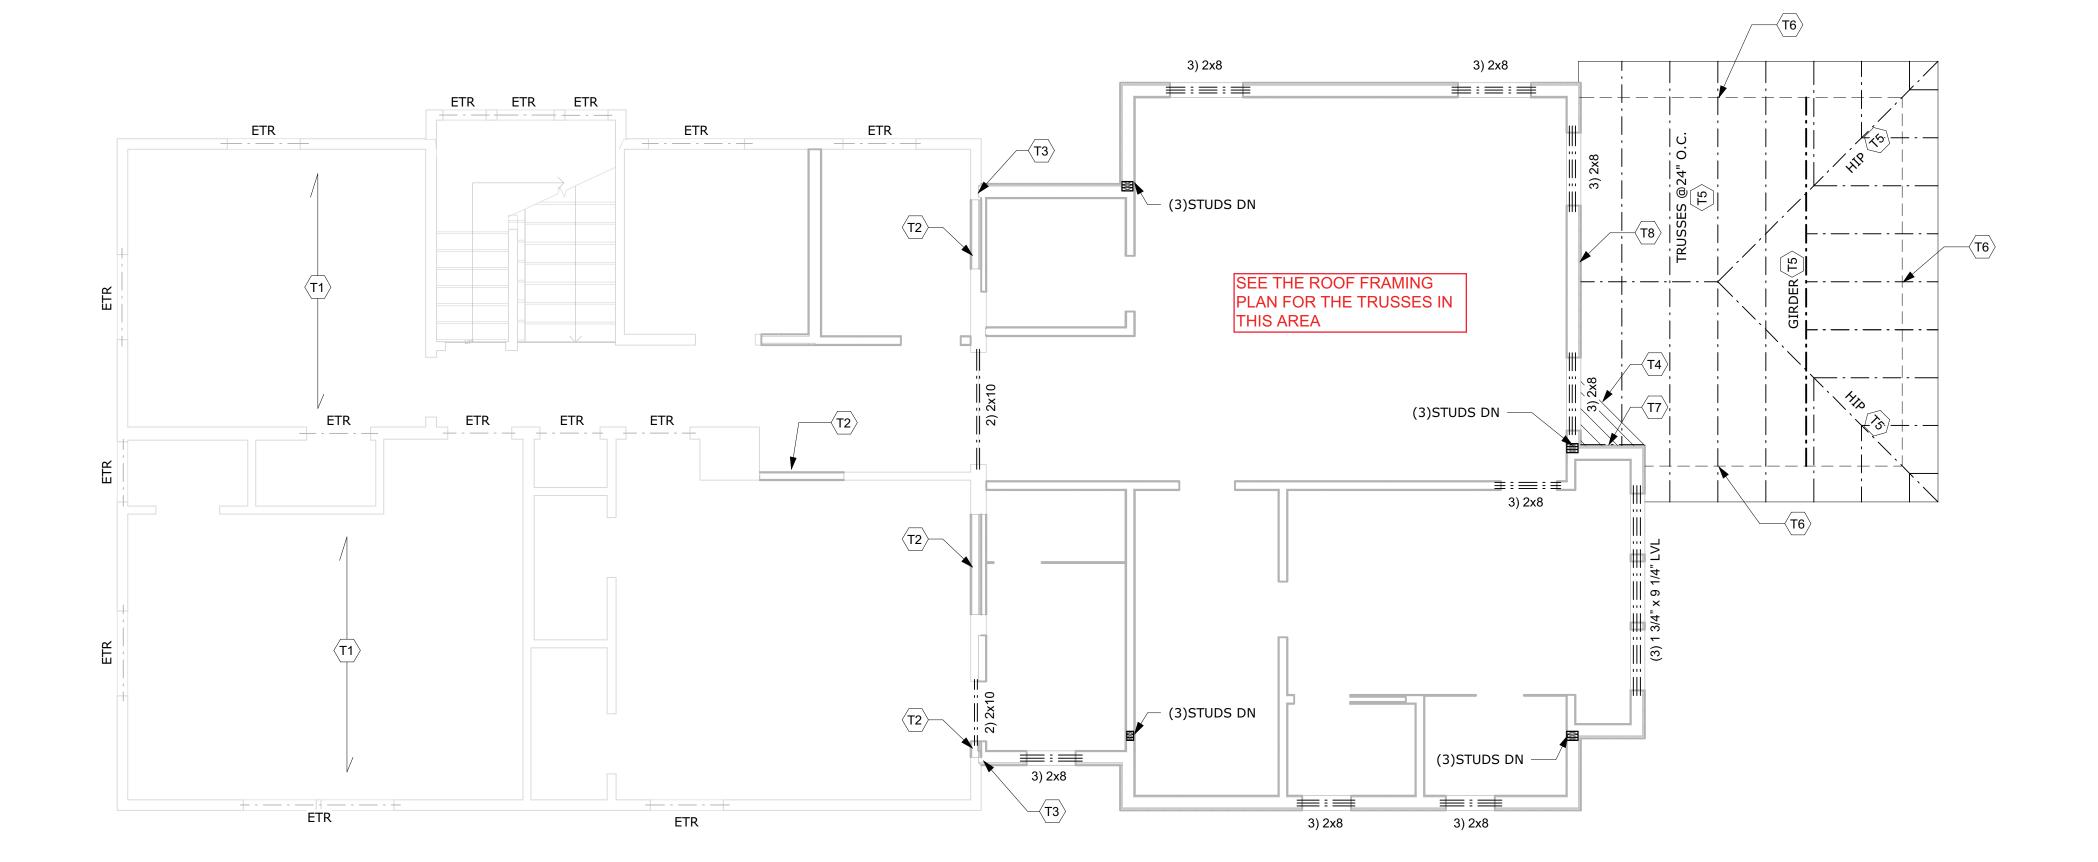
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Structural Plans



Roof Framing Plan
1/4" = 1'-0"

1 STR. Roof Framing Plan 1/4" = 1'-0"

#### **ROOF FRAMING NOTES**

- EXISTING ROOF FRAMING TO REMAIN. SISTER ANY DAMAGED JOIST THAT IS FOUND WITH A 2x10 OR A DOUBLE 2x8.
- THE TRUSS MANUFACTURER SHALL COORDINATE THE ROOF AND CEILING LINES WITH THE ARCHITECTURAL DRAWINGS.
- THE TRUSS MANUFACTURER SHALL SPECIFY ALL TRUSS TO GIRDER AND TRUSS TO HIP AND HIP TO GIRDER CONNECTORS.
- TRIPLE STUD BETWEEN THE BEAM IN THE CEILING AND THE LVL RAFTER. TAPER CUT THE TOP OF THE BEAM IF
- NEEDED TO FIT BELOW THE ROOF.
- ATTACH EACH RAFTER OR TRUSS TO THE SUPPORTING WALL OR BEAM WITH A SIMPSON H2.5A HURRICANE TIE.
- OVERBUILT ROOF. USE 2x8'S AT 24" O.C. AND A 2x10 RIDGE BOARD. RIP THE RAFTERS AND PLACE THEM ON THE LOWER ROOF. ATTACH EACH RAFTER TO THE LOWER ROOF WITH (3)10d TOE NAILS AND A SIMPSON LS50 ON EACH SIDE OF THE RAFTER. ATTACH EACH RAFTER TO THE RIDGE WITH A SIMPSON LSU HANGER. HOLD THE TOP OF THE RIDGE DOWN AS NEEDED FOR VENTILATION AND SO THAT THE BOTTOM OF THE RIDGE IS EVEN WITH OR DEEPER THAN THE BOTTOM OF THE RAFTERS.
- ATTACH EACH RAFTER TO THE RIDGE WITH A SIMPSON LSU HANGER. HOLD THE RIDGE DOWN AS NEEDED FOR VENTILATION AND SO THAT THE BOTTOM OF THE RIDGE IS EVEN WITH OR DEEPER THAN THE RAFTERS.
- ATTACH EACH RAFTER TO THE HIP WITH (4)10d TOE
- ATTACH THE 1ST STUD TO THE EXISTING WALL WITH (2)10d NAILS AT 6" O.C.
- R10 PLACE A TRIPLE STUD BETWEEN THE RIDGE AND HIPS AND THE HEADER OR BEAM BELOW.
- (R11) TRIPLE 1 3/4" x 7 1/4" LVL RAFTER. BUILD A WALL ON TOP OF THE LVL RAFTER TO SUPPORT THE DORMER
- FRAME THE END OF THE DORMER WITH A TRIPLE 2x8 HEADER. ATTACH EACH EXISTING RAFTER TO THE HEADER WITH A SIMPSON L50 ON EACH SIDE OF THE RAFTER.
- PLACE A TRIPLE 2x8 BEAM BELOW THE DORMER WALL AT THE ELEVATION OF THE EXISTING ROOF RAFTERS. ATTACH EACH EXISTING RAFTER TO THE BEAM WITH A SIMPSON L50 ON EACH SIDE OF THE RAFTER. ATTACH THE BEAM TO THE LVL RAFTER ON EACH SIDE OF THE DORMER WITH A SIMPSON LUS HANGER.
- ATTACH THE LVL RAFTER TO THE EXISTING HIP WITH A SIMPSON SUR/L HANGER. NOTCH THE BOTTOM AND SIDES OF THE RAFTER AS NEEDED TO FIT IN THE CONNECTOR.
- SET THE GIRDER ON THE HEADER OVER THE 2ND FLOOR WINDOW. IF THE GIRDER DOES NOT ALIGN WITH THE HEADER, PLACE IT ON A TRIPLE STUD DOWN TO THE HEADER OVER THE DOOR IN THE 1ST FLOOR OR DOWN TO THE NEW FOUNDATION WALL.
- PLACE A TRIPLE 2x8 BEAM IN THE CEILING TO SUPPORT THE HIP/RIDGE CONNECTION. TAPER CUT EACH END OF THE BEAM AS NEEDED TO FIT BELOW THE ROOF. PLACE A RAFTER ON THE FRONT SIDE OF THE BEAM ON EACH SIDE OF THE RIDGE. ATTACH THE RAFTER TO THE BEAM WITH (5)10d NAILS.

- ALL HEADERS ARE ASSUMED TO BE SUPPORTED BY A DOUBLE JACK AND SINGLE KING STUD, UNLESS NOTED
- THE INSTRUCTIONS OF ESR 1772. EPOXY BOLTS SHALL HAVE 6" EMBEDMENT WITH SCREEN TUBES WHEN PLACED IN HOLLOW MASONRY UNLESS NOTED OTHERWISE.

- ALL NAILS USED FOR EXTERIOR APPLICATIONS SHALL BE
- ALL NAILS, HANGERS, BOLTS, AND SCREWS EXPOSED TO THE EXTERIOR SHALL BE GALVANIZED.
- TREATED SOUTHERN PINE #2. ALL SLAB ON GRADE CONCRETE SHALL HAVE A 28 DAY
- 12. WHEN ATTACHING EXISTING JOISTS TO FLUSH BEAMS USE OVERSIZED SIMPSON LUS HANGERS. ADD BLOCKING AS
- IN THE HOME AND POINT ANY DETERIORATED JOINT THAT IS DISCOVERED AND REPLACE ANY DETERIORATED BRICKS
- 14. TYPICAL JOIST HANGER SHALL BE A SIMPSON IUS OR
- 16. TYPICAL RAFTER TO FLUSH BEAM HANGER SHALL BE A
- LPC ON EACH SIDE.
- 19. TYPICAL STRINGER TO FRAMING CONNECTOR SHALL BE A SIMPSON MTS15 ON EACH SIDE.
- SIMPSON HU MAX.
- 22. TYPICAL FLITCH BEAM HANGER SHALL BE AN OVERSIZED
- 23. SEE THE MONTGOMERY COUNTY TYPICAL DECK DETAILS FOR ITEMS NOT SHOWN ON THESE PLANS SUCH AS GUARDRAILS, STAIRS, LEDGER BOARD ATTACHMENTS
- USE TYPE "N" LIME BASED MORTAR FOR EXTERIOR BRICK WALL APPLICATIONS. USE CLAY BRICKS THAT MATCH THE
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- ADD BLOCKING TO THE WEB OF THE ENGINEERED JOISTS AS NEEDED WHEN USING HURRICANE TIES OR JOIST



- THE BOTTOM OF ALL FOOTINGS SHALL BE 30" MINIMUM
- OTHERWISE.
- PROVIDE SQUASH BLOCKING AS NEEDED BELOW ALL
- POSTS, COLUMNS, AND MULTIPLE STUDS. ATTACH ALL QUADRUPLE AND QUINTUPLE BEAMS TOGETHER WITH 2 ROWS OF 1/2" Ø BOLTS AT 16" O.C. EPOXY BOLTS SHALL BE SIMPSON "SET". FOLLOW
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- SIMPSON LUS HANGER. TYPICAL RAFTER TO RIDGE HANGER SHALL BE A SIMPSON
- SIMPSON L70 ON EACH SIDE OF THE RAFTER. TYPICAL POST TO BEAM CONNECTOR SHALL BE A SIMPSON
- TYPICAL POST TO FLOOR PLATE CONNECTOR SHALL BE A SIMPSON L30 ON EACH SIDE OF THE POST.
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- TYPICAL LVL TO LVL BEAM HANGER SHALL BE A SIMPSON
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20-043 Project Number: Client Name: Lacy Rice Project Status:

Preliminary Design Design Development Permit Submission Construction Documents

As Built Conditions

Construction Administration

5-25-2021 Drawing Issue Date: Client Approval:

**Revision Schedule** 

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1/4" = 1'-0" Sheet Name:

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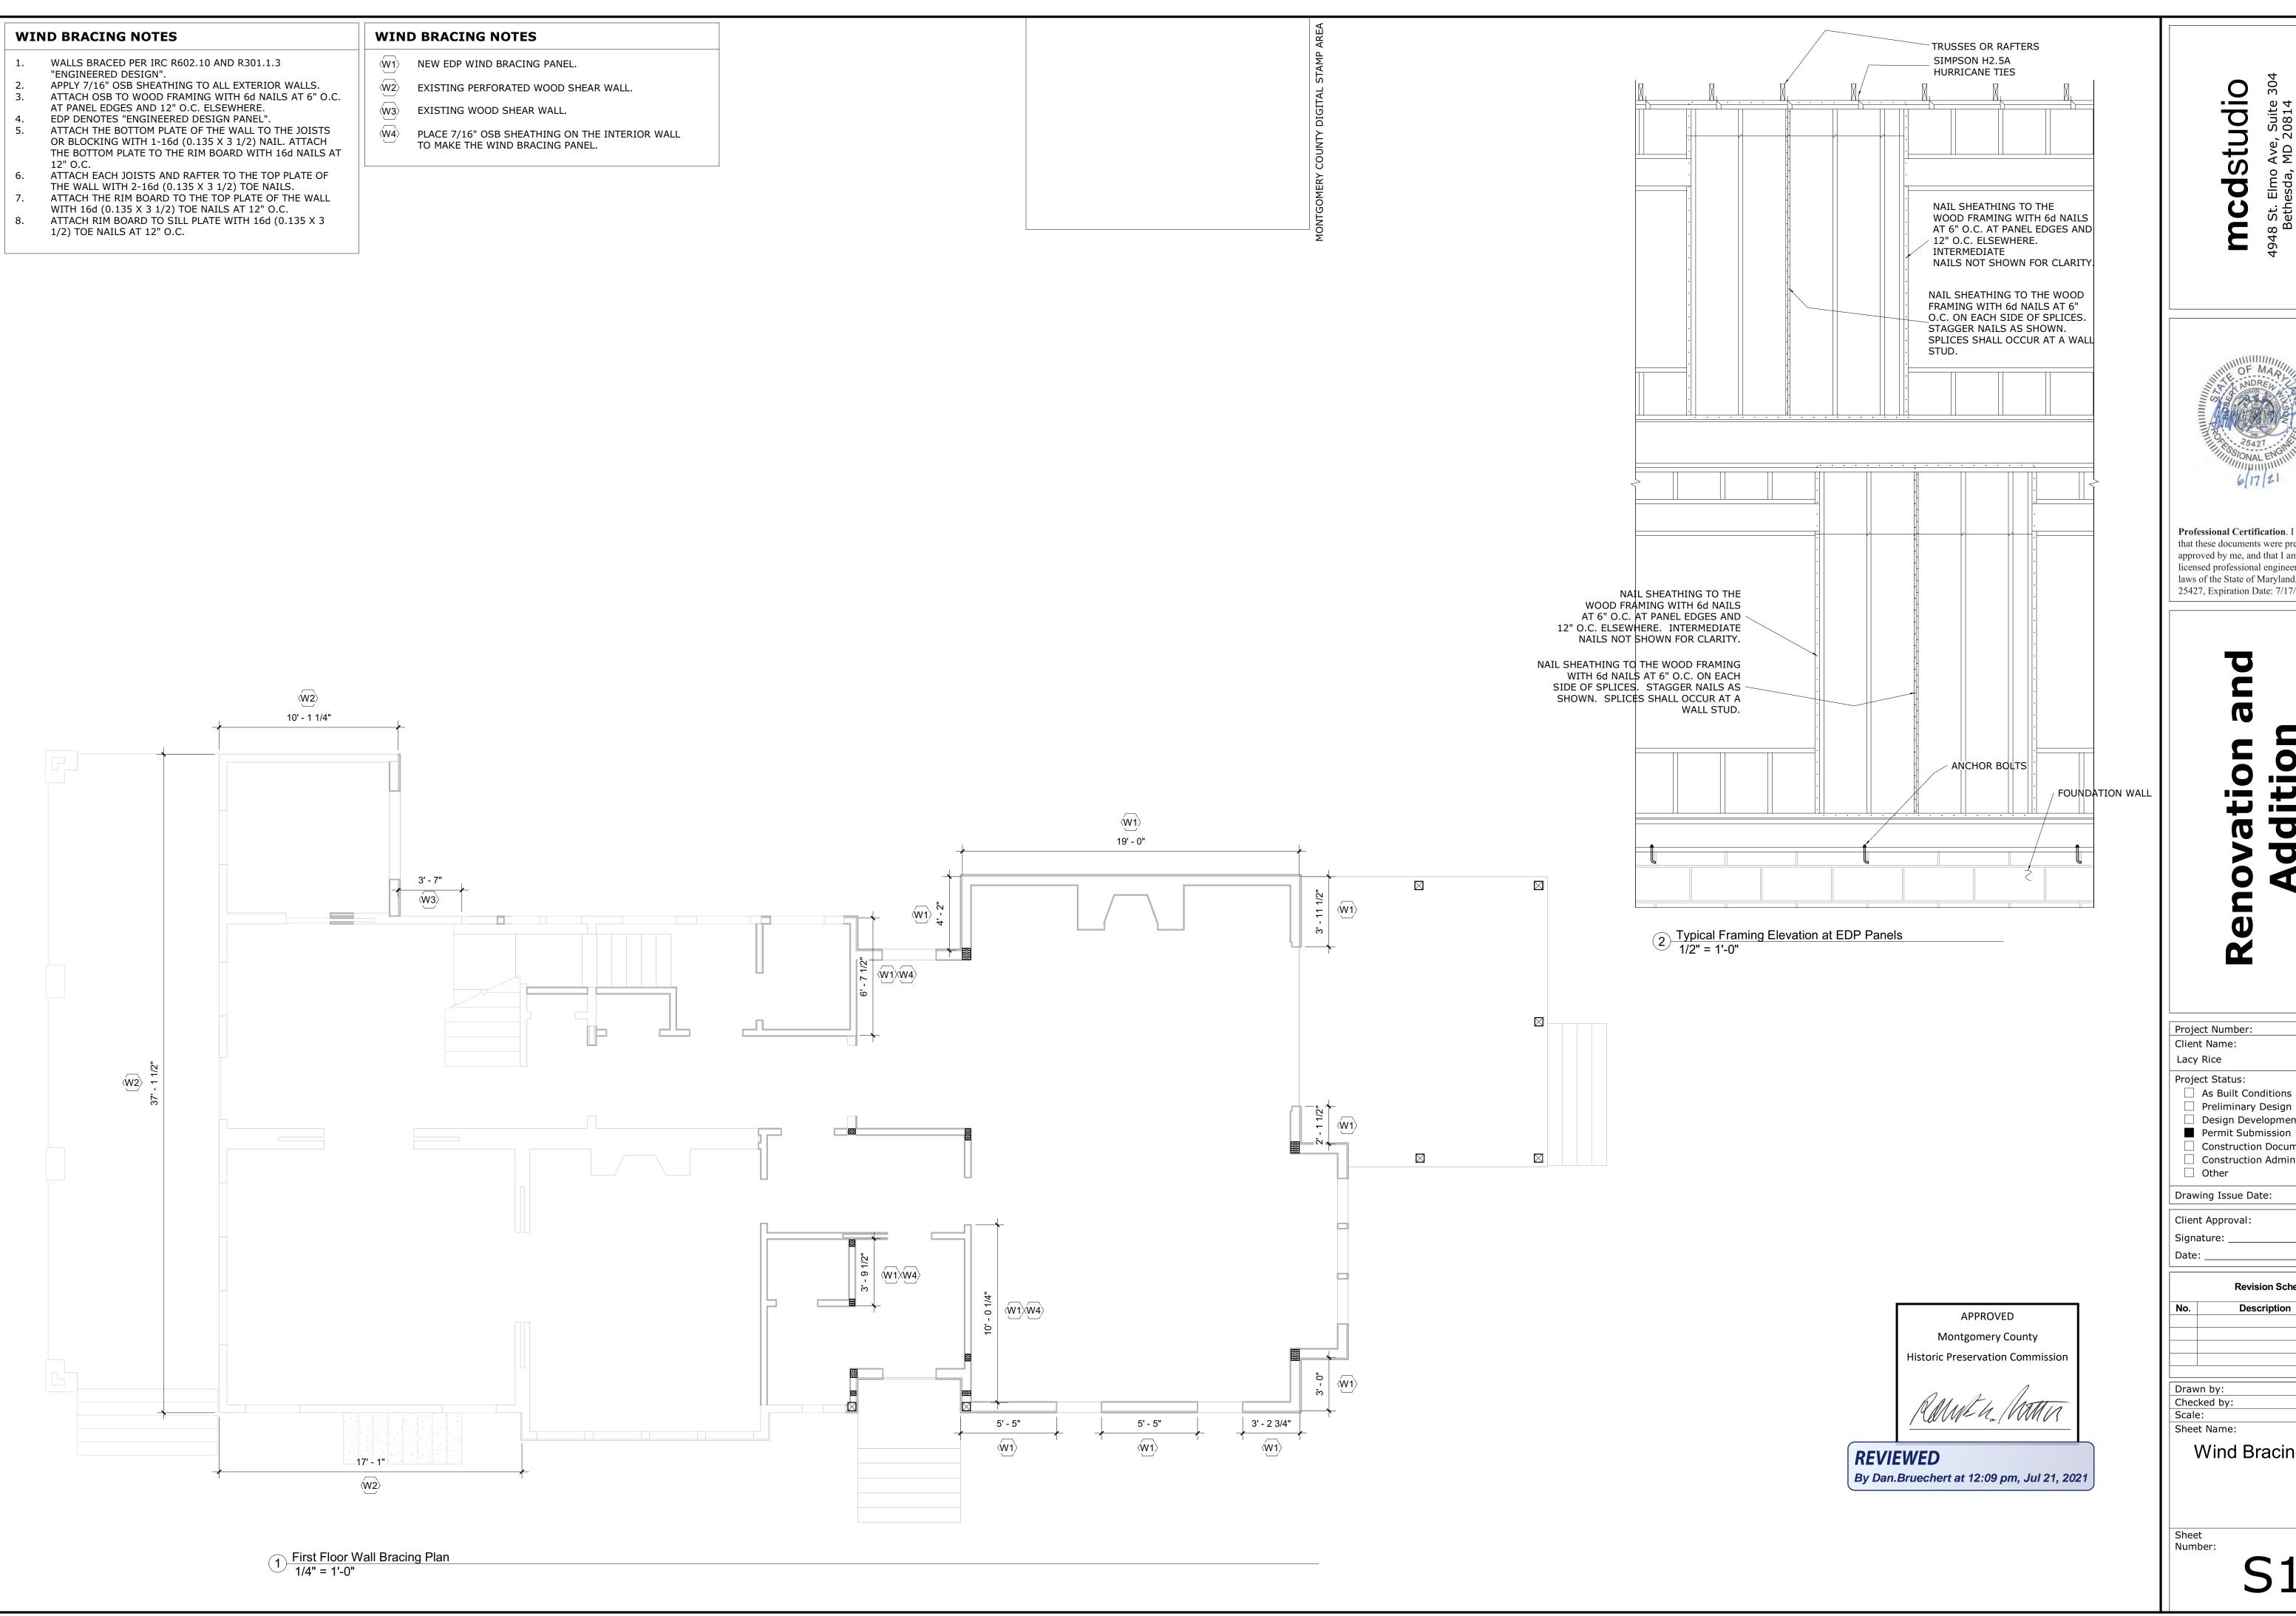
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Date:

APPROVED Montgomery County **Historic Preservation Commission** 

**REVIEWED** 

By Dan.Bruechert at 12:09 pm, Jul 21, 2021



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☐ Design Development Permit Submission Construction Documents Construction Administration 5-25-2021 Drawing Issue Date: **Revision Schedule** Date APAC As indicated

20-043

Wind Bracing Plans

MONTGOMERY COUNTY DIGITAL STAMP AREA

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Second Floor Wall Bracing Plan
1/4" = 1'-0"

REVIEWED

APPROVED

Montgomery County

**Historic Preservation Commission** 

By Dan.Bruechert at 12:09 pm, Jul 21, 2021

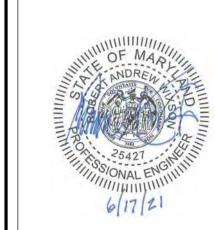
#### WIND BRACING NOTES

- 1. WALLS BRACED PER IRC R602.10 AND R301.1.3
- "ENGINEERED DESIGN".
  2. APPLY 7/16" OSB SHEATHING TO ALL EXTERIOR WALLS.
  3. ATTACH OSB TO WOOD FRAMING WITH 6d NAILS AT 6" O.C. AT PANEL EDGES AND 12" O.C. ELSEWHERE.
- 4. EDP DENOTES "ENGINEERED DESIGN PANEL".
  5. ATTACH THE BOTTOM PLATE OF THE WALL TO THE JOISTS OR BLOCKING WITH 1-16d (0.135 X 3 1/2) NAIL. ATTACH THE BOTTOM PLATE TO THE RIM BOARD WITH 16d NAILS AT
  - 12" O.C.
    ATTACH EACH JOISTS AND RAFTER TO THE TOP PLATE OF
- THE WALL WITH 2-16d (0.135 X 3 1/2) TOE NAILS.

  7. ATTACH THE RIM BOARD TO THE TOP PLATE OF THE WALL
- WITH 16d (0.135 X 3 1/2) TOE NAILS AT 12" O.C. 8. ATTACH RIM BOARD TO SILL PLATE WITH 16d (0.135 X 3 1/2) TOE NAILS AT 12" O.C.

#### WIND BRACING NOTES

- W1 NEW EDP WIND BRACING PANEL.
- (W2) EXISTING PERFORATED WOOD SHEAR WALL.
- (W3) EXISTING WOOD SHEAR WALL.
- W4 PLACE 7/16" OSB SHEATHING ON THE INTERIOR WALL TO MAKE THE WIND BRACING PANEL.



Professional Certification. I hereby certify that these documents were prepared or approved by me, and that I am a duly licensed professional engineer under the laws of the State of Maryland, License No. 25427, Expiration Date: 7/17/22.

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# on and soad

Addition
7315 Brookville Road
Chevy Chase, MD 20815

Project Number: 20-043
Client Name:
Lacy Rice
Project Status:

As Built Conditions
Preliminary Design

□ Design Development■ Permit Submission□ Construction Documents□ Construction Administration

Drawing Issue Date: 5-25-2021

Client Approval:

Signature: \_\_\_

No. Description Date

Drawn by: AP
Checked by: APAC
Scale: 1/4" = 1'-0"
Sheet Name:

Sheet Name:

Wind Bracing Plans

heet

S107