



HISTORIC PRESERVATION COMMISSION

Marc Elrich
County Executive

Sandra I. Heiler
Chairman

Date: November 2, 2020

MEMORANDUM

TO: Hadi Mansouri
Department of Permitting Services

FROM: Michael Kyne
Historic Preservation Section
Maryland-National Capital Park & Planning Commission

SUBJECT: Historic Area Work Permit #907051: Porch Construction

The Montgomery County Historic Preservation Commission (HPC) has reviewed the attached application for a Historic Area Work Permit (HAWP). This application was **Approved** at the March 25, 2020 HPC meeting.


The HPC staff has reviewed and stamped the attached construction drawings.

THE BUILDING PERMIT FOR THIS PROJECT SHALL BE ISSUED CONDITIONAL UPON ADHERENCE TO THE ABOVE APPROVED HAWP CONDITIONS AND MAY REQUIRE APPROVAL BY DPS OR ANOTHER LOCAL OFFICE BEFORE WORK CAN BEGIN.

Applicant: Nathan and Sarah Engle (Luke Olson, Architect)
Address: 3929 Baltimore Street, Kensington


This HAWP approval is subject to the general condition that the applicant will obtain all other applicable Montgomery County or local government agency permits. After the issuance of these permits, the applicant must contact this Historic Preservation Office if any changes to the approved plan are made. Once work is complete the applicant will contact Michael Kyne at 301.563.3403 or michael.kyne@montgomeryplanning.org to schedule a follow-up site visit.



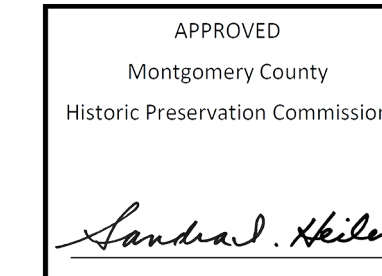

GTM ARCHITECTS

7735 OLD GEORGETOWN ROAD
SUITE 700
BETHESDA, MD 20814
(240)333-3800
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Consultant

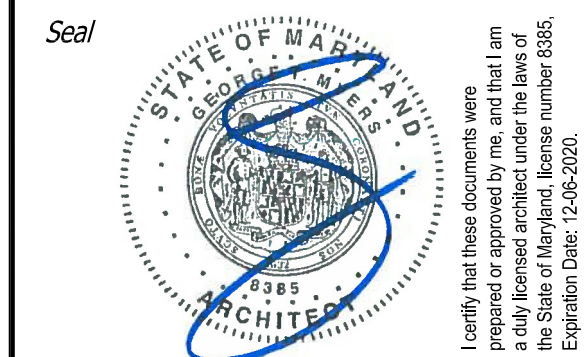Project
ENGLE RESIDENCE
3929 BALTIMORE ST., KENSINGTON, MD 20895
Owner

Developer


PERMIT SET 10/23/2020

Issue Description Date

GTM Project No. 19.0654
Checked By GTM
Drawn By LEO
Scale AS NOTED

Sheet Title
SITE PLAN

Sheet No.
003

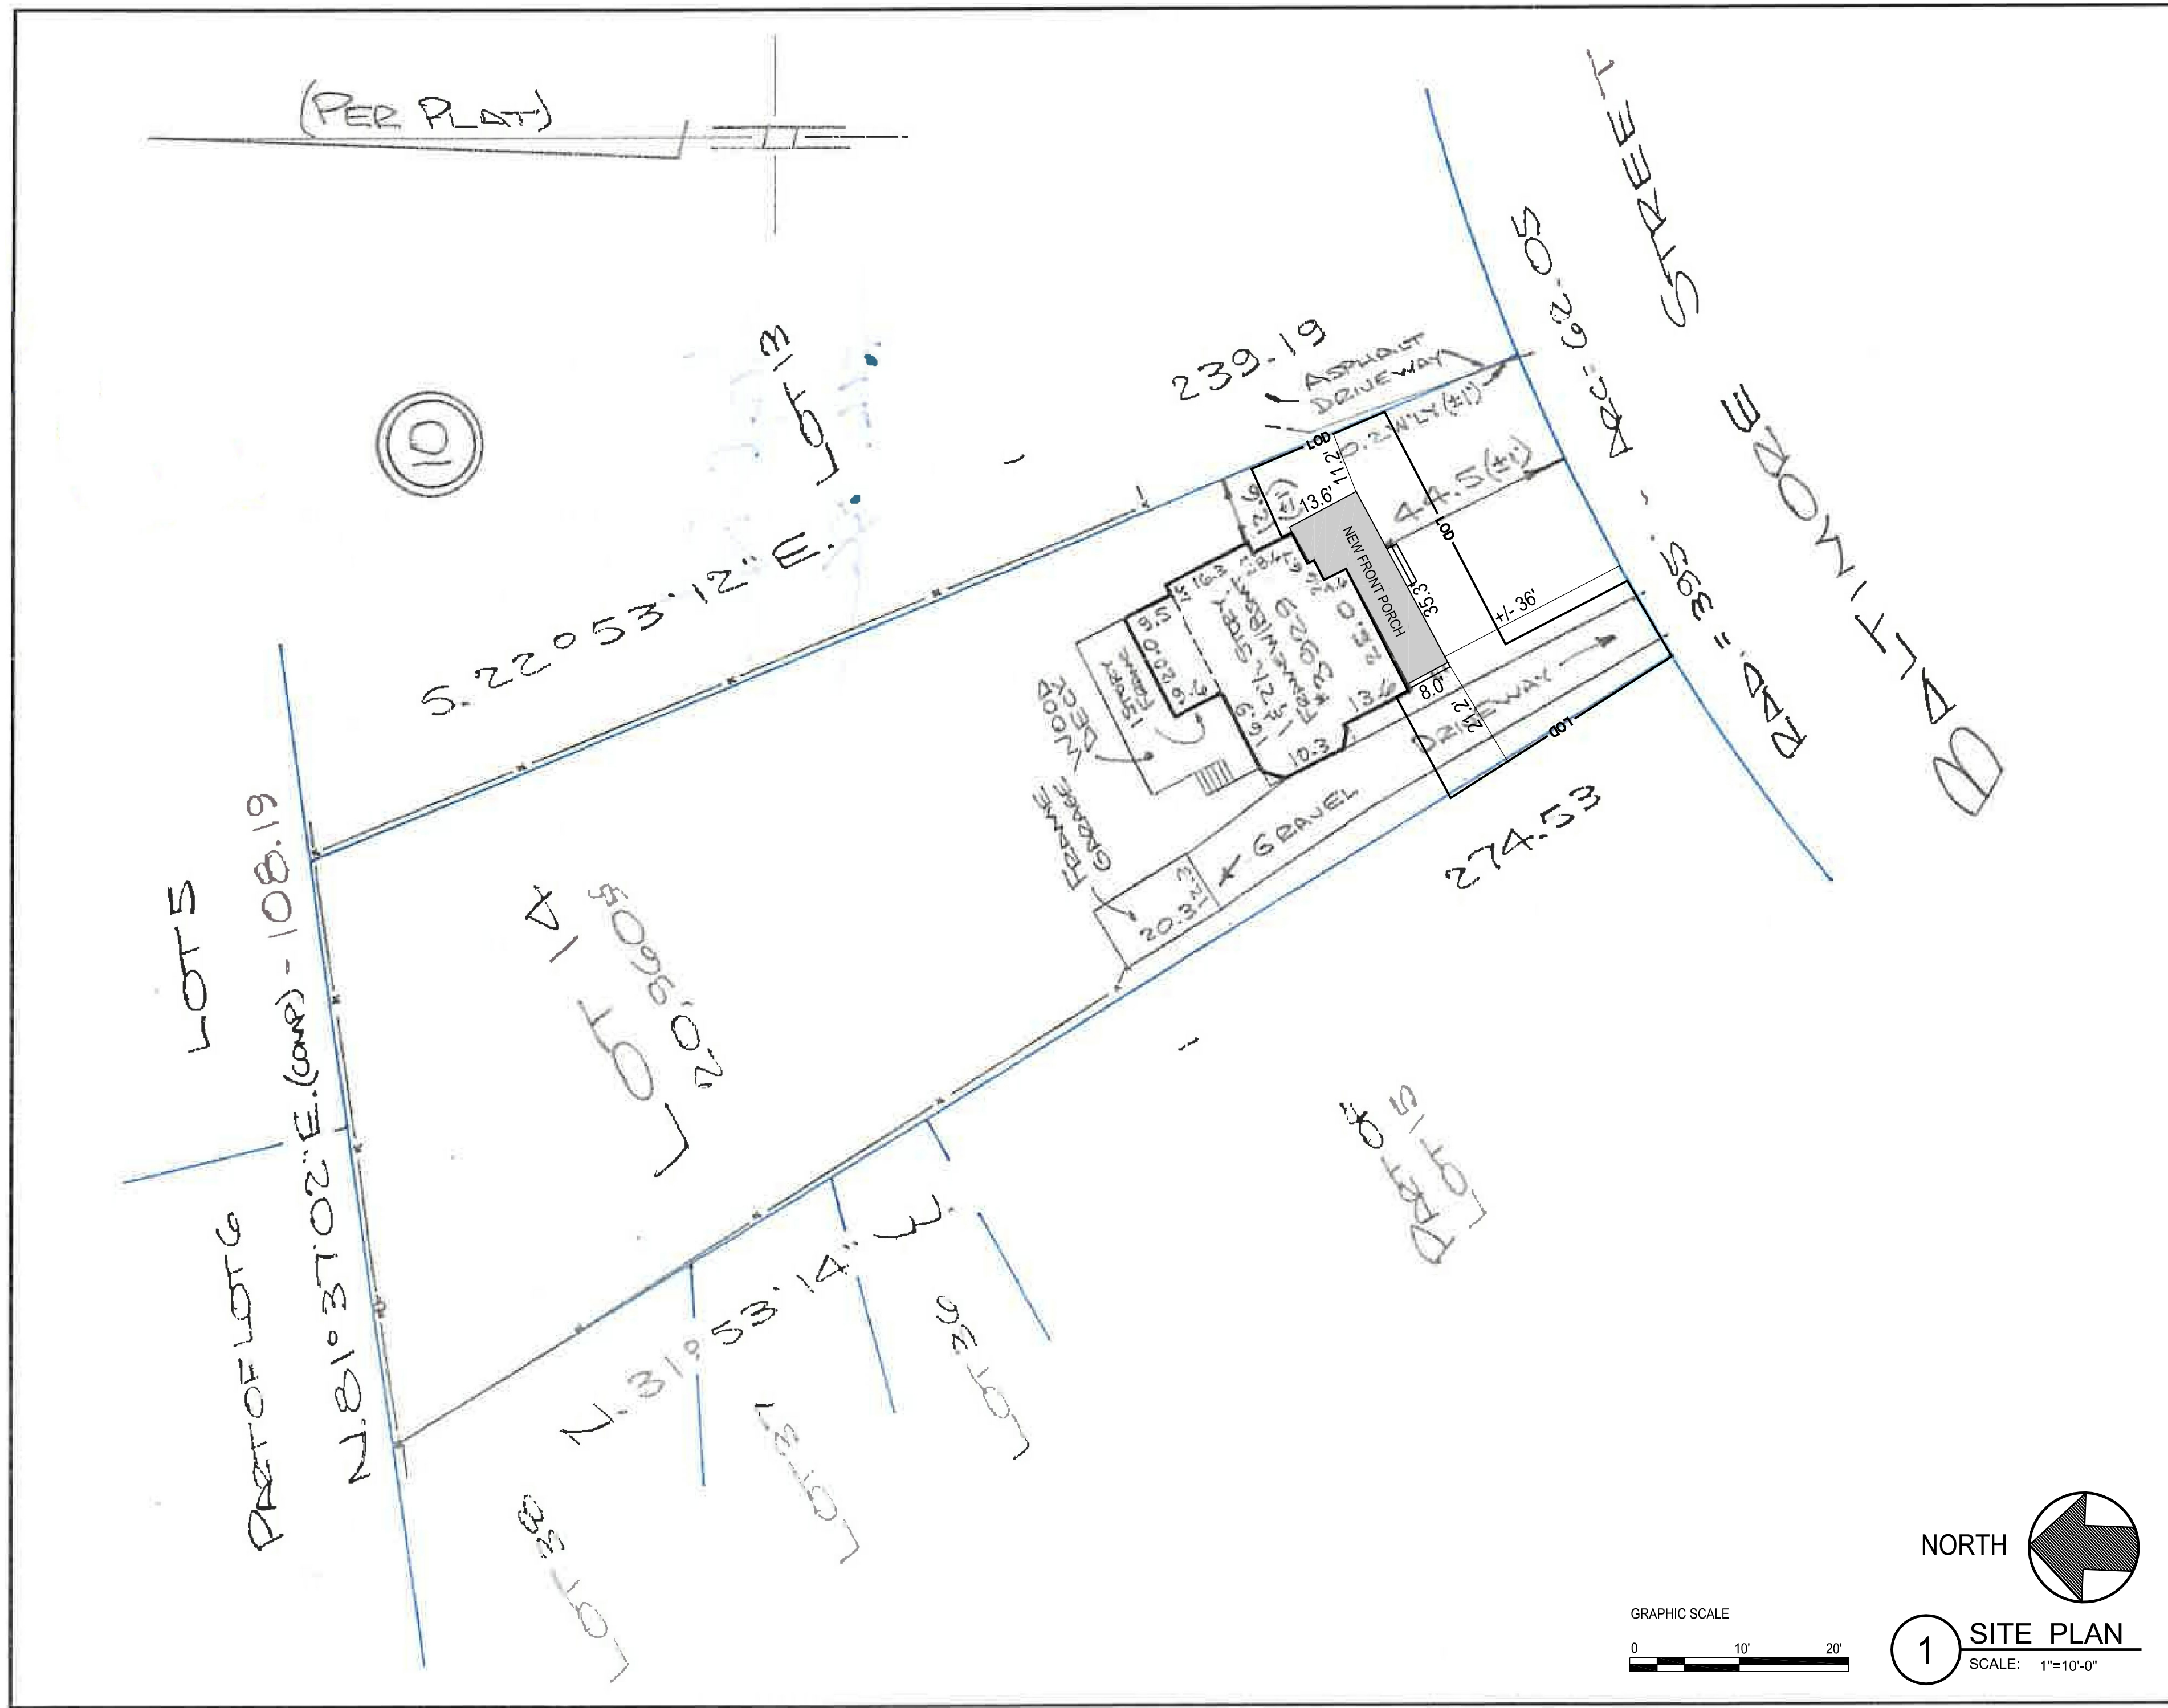

Capitol Surveys, Inc.
10762 Rhode Island Avenue
Beltsville, Maryland 20705
Phone 301-931-1350
Fax 301-931-1352

NOTES: Plat is of benefit to a consumer only insofar as it is required by a lender or a title insurance company or its agent in connection with contemplated transfer, financing or re-financing; the plat is not to be relied upon for the establishment or location of fences, garages, buildings, or other existing or future improvements; and the plat does not provide for the accurate identification of property boundary lines, but such identification may not be required for the transfer of title and securing financing or refinancing.


LOCATION DRAWING
LOT 14 BLOCK 10
KENSINGTON PARK
MONTGOMERY COUNTY, MARYLAND
Recorded in Plat Book B Plat 4 Scale 1" = 40'
CASE: 879-17 FILE: 105635
DATE: JUNE 30, 2017

I hereby certify this location drawing was prepared in accordance with the minimum standards of practice for the State of Maryland and is correct to the best of my belief of what can be visually and accessibly observed.
Edward L. Lopez, Jr.
Edward L. Lopez, Jr.
Maryland Property Line Surveyor No. 522
License Current Through February 13, 2017

LEGEND	
	CLEAN OUT
	SEWER MANHOLE
	STORM DRAIN MANHOLE
	ROOF DRAIN SPOUT
	UTILITY POLE
	GUY WIRE
	LIGHT
	ELECTRIC BOX
	SIGN
	WATER VALVE
	WATER METER
	FIRE HYDRANT
	GAS METER
	MAILBOX
	BURIED SEWER LINE
	BURIED WATER LINE
	WOOD FENCE
	CHAIN LINK FENCE
	METAL HANDRAIL
	OVER HEAD WIRE
	WOODS LINE
	LANDSCAPE AREA
	AIR CONDITIONER UNIT
	WINDOW WELL
	REBAR AND CAP
	IRON PIPE
	MONUMENT
	BUSH
	SINGLE TREE WITH SIZE & TYPE
	TWIN TREE WITH SIZE & TYPE
	TRIPLE TREE WITH TYPE & SIZE
	QUADRUPLE TREE WITH TYPE & SIZE
	LIMIT OF DISTURBANCE


LOT INFO
3929 BALTIMORE STREET -KENSINGTON PARK- LOT 14 - BLOCK 10
ZONED: R-60 LOT AREA= 20,960 SQ. FT.

CALCULATIONS
LOT AREA = 20,960 SF LOT IS AT LEAST 15,000 S.F. - DRAINAGE PLAN IS NOT REQUIRED TOTAL SF OF DISTURBED LAND AREA = 1,970 SF PROJECT IS EXEMPT FROM STORMWATER MANAGEMENT REQUIREMENTS AS IT DISTURBS LESS THAN 5,000 SF OF LAND AREA PER SECTION 19-31 OF THE MONTGOMERY COUNTY CODE TOTAL SF INCREASE IN LOT COVERAGE = 340 SF TOTAL VOLUME OF EARTH MOVEMENT = 6 CY NO DRAINAGE PLAN IS REQUIRED AS THE ADDITION DOES NOT INCREASE THE BUILDING LOT COVERAGE BY MORE THAN 400 SQUARE FEET AND INVOLVES LESS THAN 100 CUBIC YARDS OF EARTH MOVEMENT PER SECTION 8-29B OF THE MONTGOMERY COUNTY CODE.

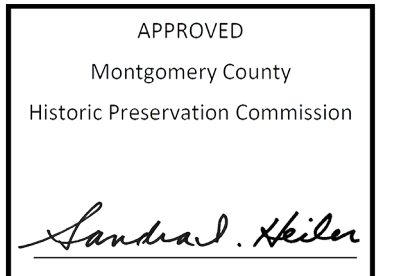

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FLOOR PLANS

Sheet No.

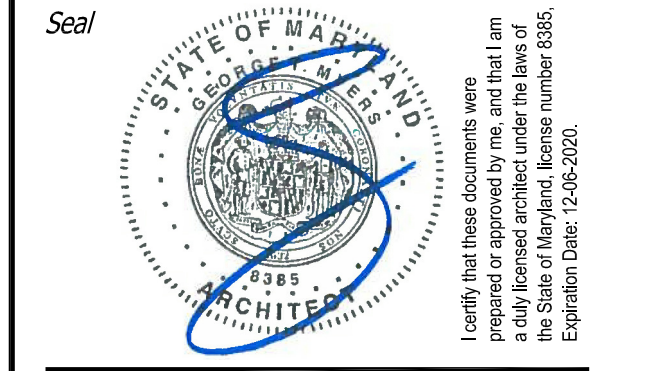A100



CONSTRUCTION NOTES

- 1 PTD. WOOD STEPS TO GRADE. F.V. RISE AND RUN. COORD. W/ CIVIL DRAWINGS
- 2 PTD. 6X6 TURNED WOOD POST, CENTURY POST VICTORIAN OR EQ.
- 3 ENGAGED PTD. WOOD PILASTER AT WALL TO MATCH POSTS
- 4 PTD. WOOD 5/4X6 T&G DECKING T.B.S.
- 5 PTD. 30" H. DECORATIVE WOOD GUARDRAIL. CONFIRM DECK IS NO MORE THAN 30" ABOVE GRADE AT ALL POINTS
- 6 GC TO PATCH & REPAIR EXISTING DRYWALL AS REQUIRED BY DEMO & PROVIDE NEW FINISHES, TRIM, ETC. TO MATCH NEW CONSTRUCTION
- 7 CONFIRM EXG. / PROVIDE NEW HARDWIRED SMOKE/CARBON MONOXIDE DETECTOR W/ BATTERY BACKUP PER IRC 2018
- 8 TOOTH-IN NEW HARDWOOD FLOORING INTO EXISTING. ALIGN NEW FLOORING W/ EXISTING AND MATCH FINISHES
- 9 NEW 1 1/2" WD. ROD. PTD W/ 14" WD SHELF, PTD.
- 10 NEW VANITY WITH SINK, FAUCET AND COUNTERTOP, T.B.S.
- 11 NEW PLUMBING FIXTURES, & ACCESSORIES T.B.S. BY OWNER, TYP.
- 12 BUILT-IN BENCH SEAT/DAYBED, SEE 9/A300
- 13 MARBLE THRESHOLD, T.B.S., SEE 6/A300, SIM.
- 14 TILED RECESS W/ SLOPED SILL @ 42" A.F.F., COORD. W/ OWNER, SEE 7/A300
- 15 EXG. WOOD STAIRCASE TO REMAIN
- 16 HANDRAIL @ 34" ABOVE NOSING, HANDRAIL HT AND GRIPSIZE PER IRC 2018.
- 17 EXISTING HVAC TO REMAIN, EXTEND EXG. DUCTWORK AS REQUIRED FOR ADDITION
- 18 ICE AND WATER GUARD AT ALL EAVES, VALLEYS AND LOW SLOPE ROOFS; SEE GENERAL ROOFING NOTE #1 BELOW
- 19 NEW ASPHALT SHINGLE ROOFING TO MATCH EXISTING
- 20 EXISTING ROOF TO REMAIN
- 21 DASHED LINE OF EXG. FRAME WALL BELOW
- 22 EXISTING OPERABLE AWNING WINDOW WITH 35.5" CLEAR WIDTH, 24.5" CLEAR HEIGHT AND +/- 28" SILL HEIGHT MEETS EGRESS REQUIREMENTS, SCRAPE, PAINT & REPAIR AS NEEDED
- 23 PTD. ALUM 6" HALF-ROUND GUTTERS AND 4" ROUND DOWNSPOUTS TO SPLASHBLOCKS @ GRADE

- NOTE:
1. VERIFY ALL EXTERIOR RISER & TREAD DIMENSIONS IN FIELD
 2. UNLESS INDICATED OTHERWISE, DIMENSIONS ARE TO FACE OF FRAMING
 3. TONED WALLS INDICATE NEW 2x STUD WALLS. SEE PLAN
 4. SAND & STAIN EXISTING HARDWOOD FLOORING, TYPICAL

LEGEND


LOW SLOPE ROOF, PROVIDE ICE & WEATHER GUARD

GENERAL ROOFING NOTES


1. PROVIDE SELF-ADHERING, 40 MIL ICE AND WATER GUARD UNDERLAYMENT UNDER SHINGLES AT ALL VALLEYS AND FROM LOWEST EDGE OF ROOF SURFACES TO A POINT AT LEAST 24" INSIDE THE EXTERIOR WALL LINE, AND ON ALL AREAS WITH A SLOPE LESS THAN 4:12.
2. SEE FRAMING PLAN FOR OVERBUILD AREAS
3. DOTTED LINE INDICATES LINE OF BUILDING BELOW

DOOR SCHEDULE

NO.	DOOR			HARDWARE	REMARKS
	SIZE	MATERIAL	MANUF.		
1	2 ⁹ x 6 ⁹ x 1 3/4"	MDF, PAINTED	TBD	PASSAGE SET	
2	2 ⁹ x 7 ⁹ x 1 3/4"	MDF, PAINTED	TBD	PRIVACY LOCK	RE-USE EXISTING ATTIC BEDROOM DOOR
3	2 ⁴ x 7 ⁹ x 1 3/4"	MDF, PAINTED	TBD	PRIVACY LOCK	MATCH EXISTING DOOR STICKING PROFILE
4	2 ⁹ x 7 ⁹ x 1 3/4"	MDF, PAINTED	TBD	PRIVACY LOCK	MATCH EXISTING DOOR STICKING PROFILE
5	1 ⁹ x 7 ⁹ x 1 3/4"	MDF, PAINTED	TBD	BALL CATCHES & DUMMY KNOBS	MATCH EXISTING DOOR STICKING PROFILE

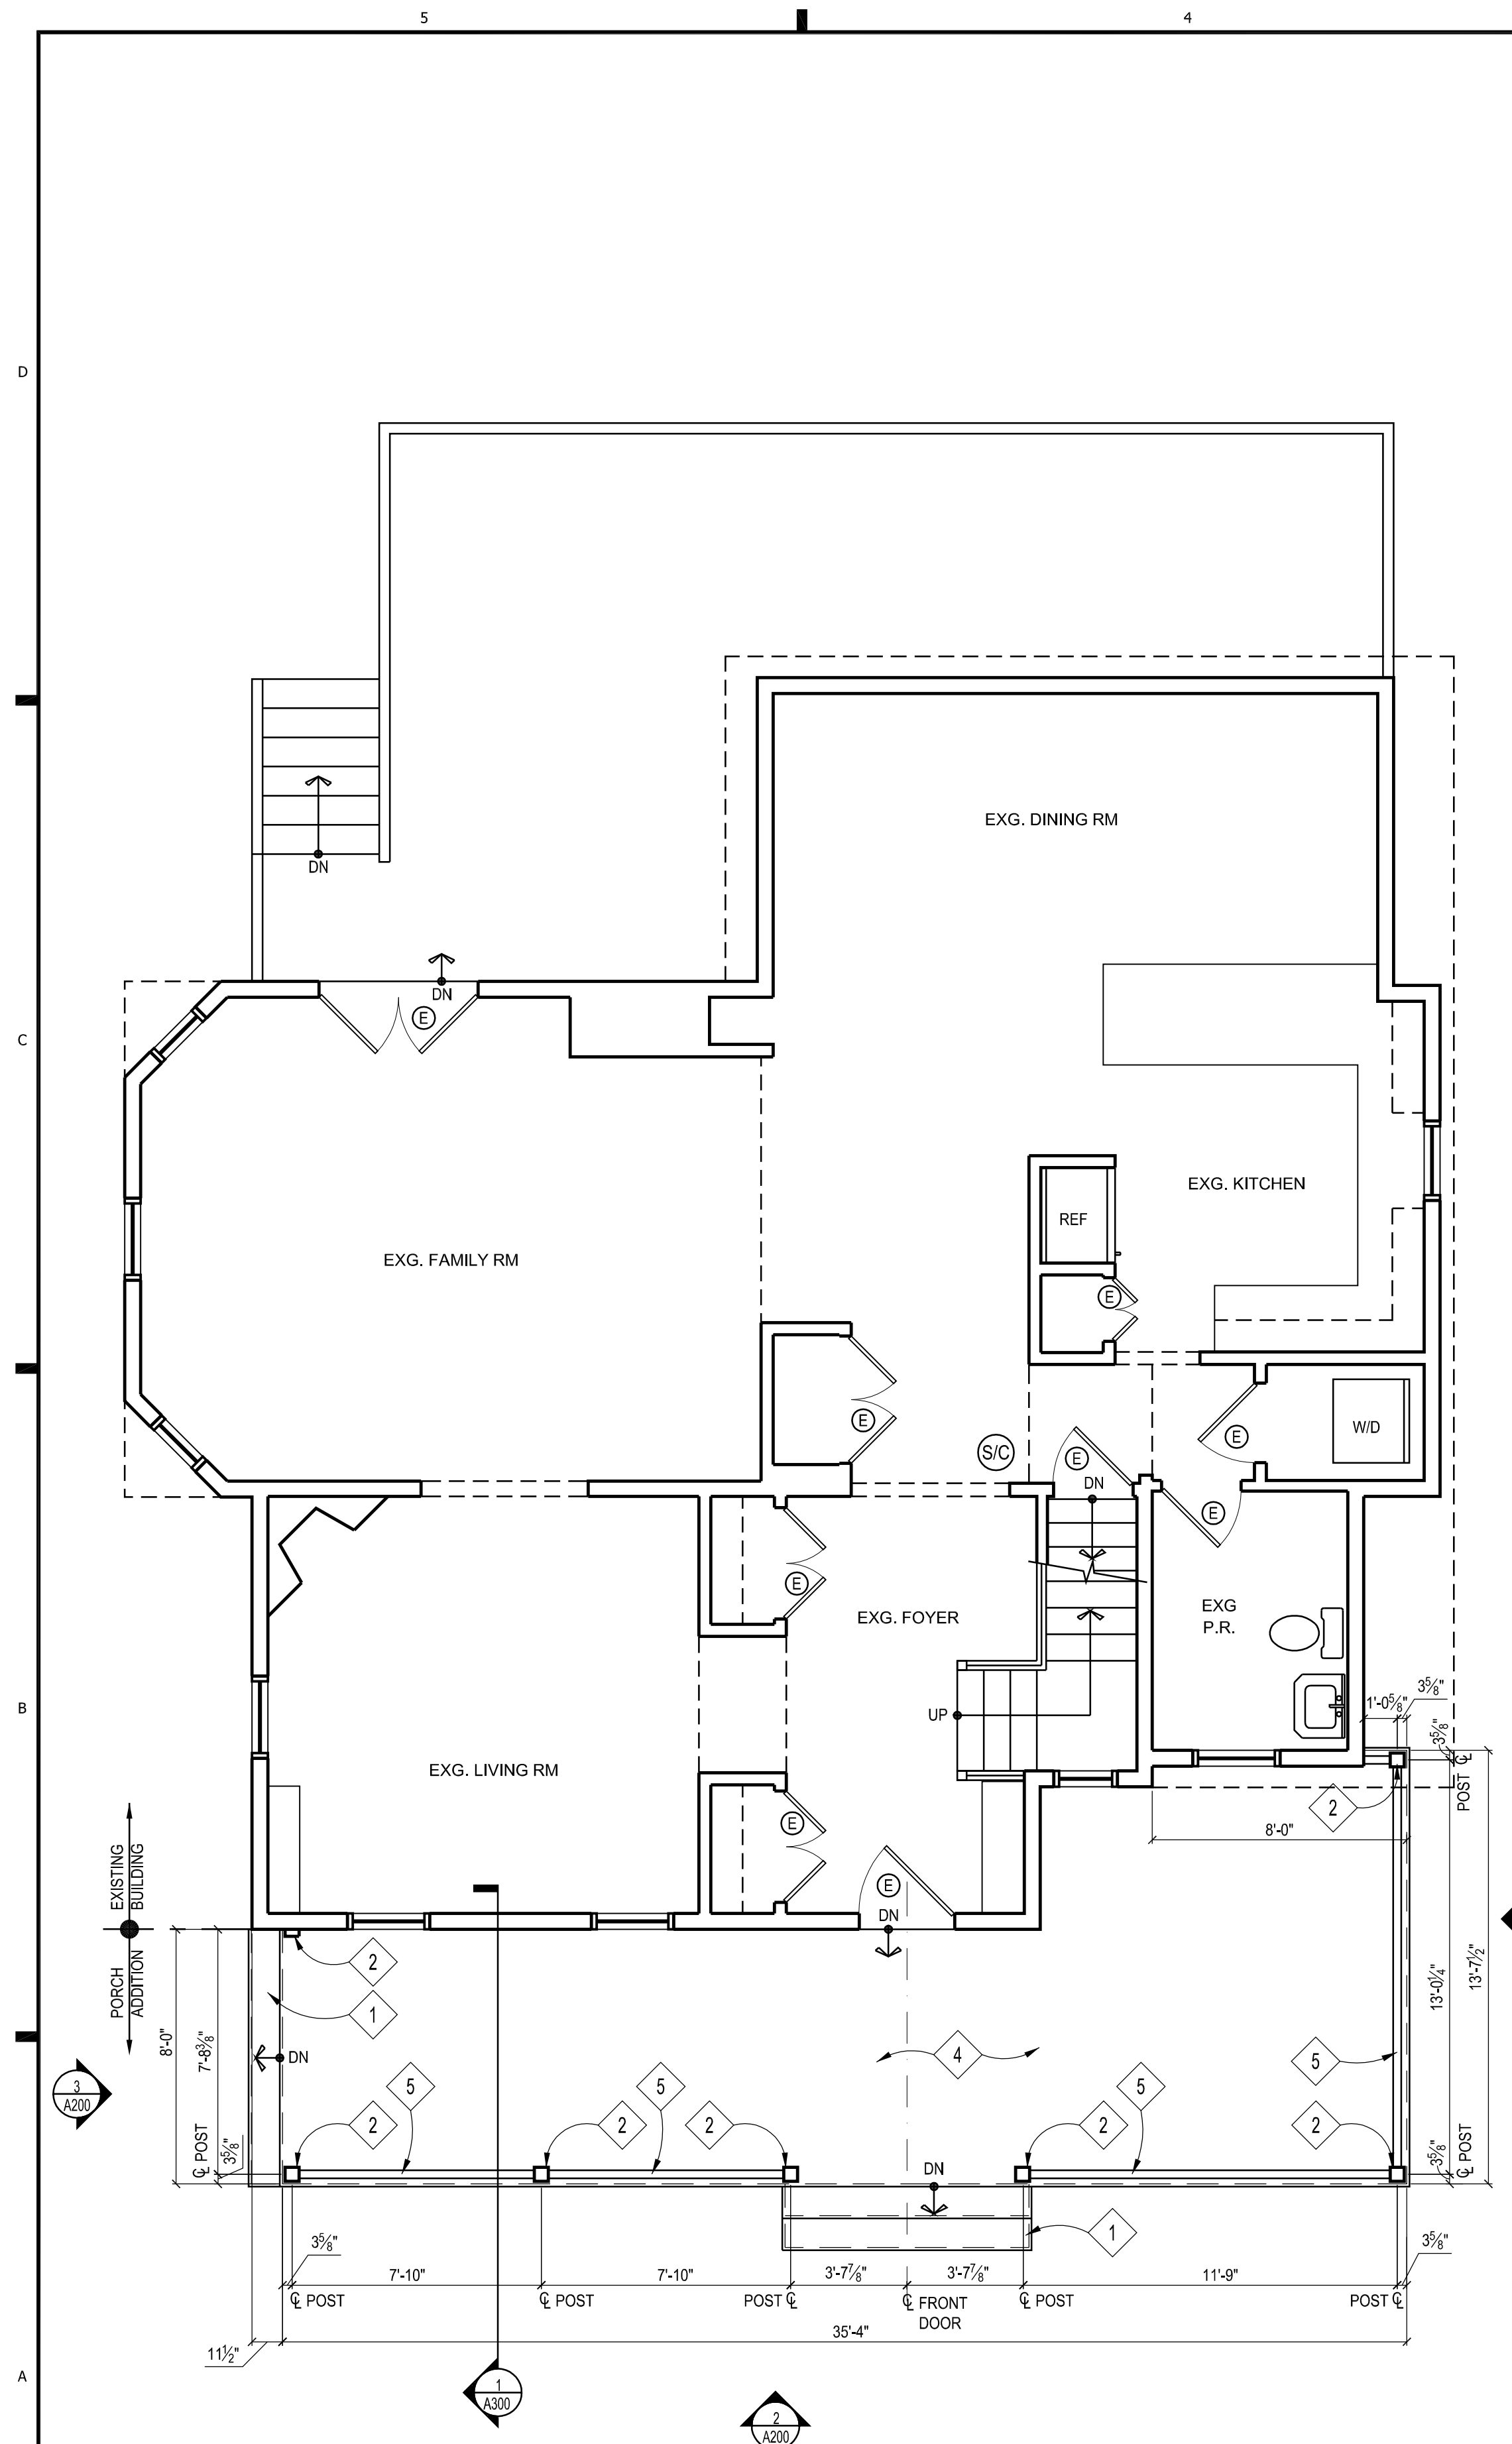

1 1ST FLOOR PLAN
SCALE: 1/4"=1'-0"

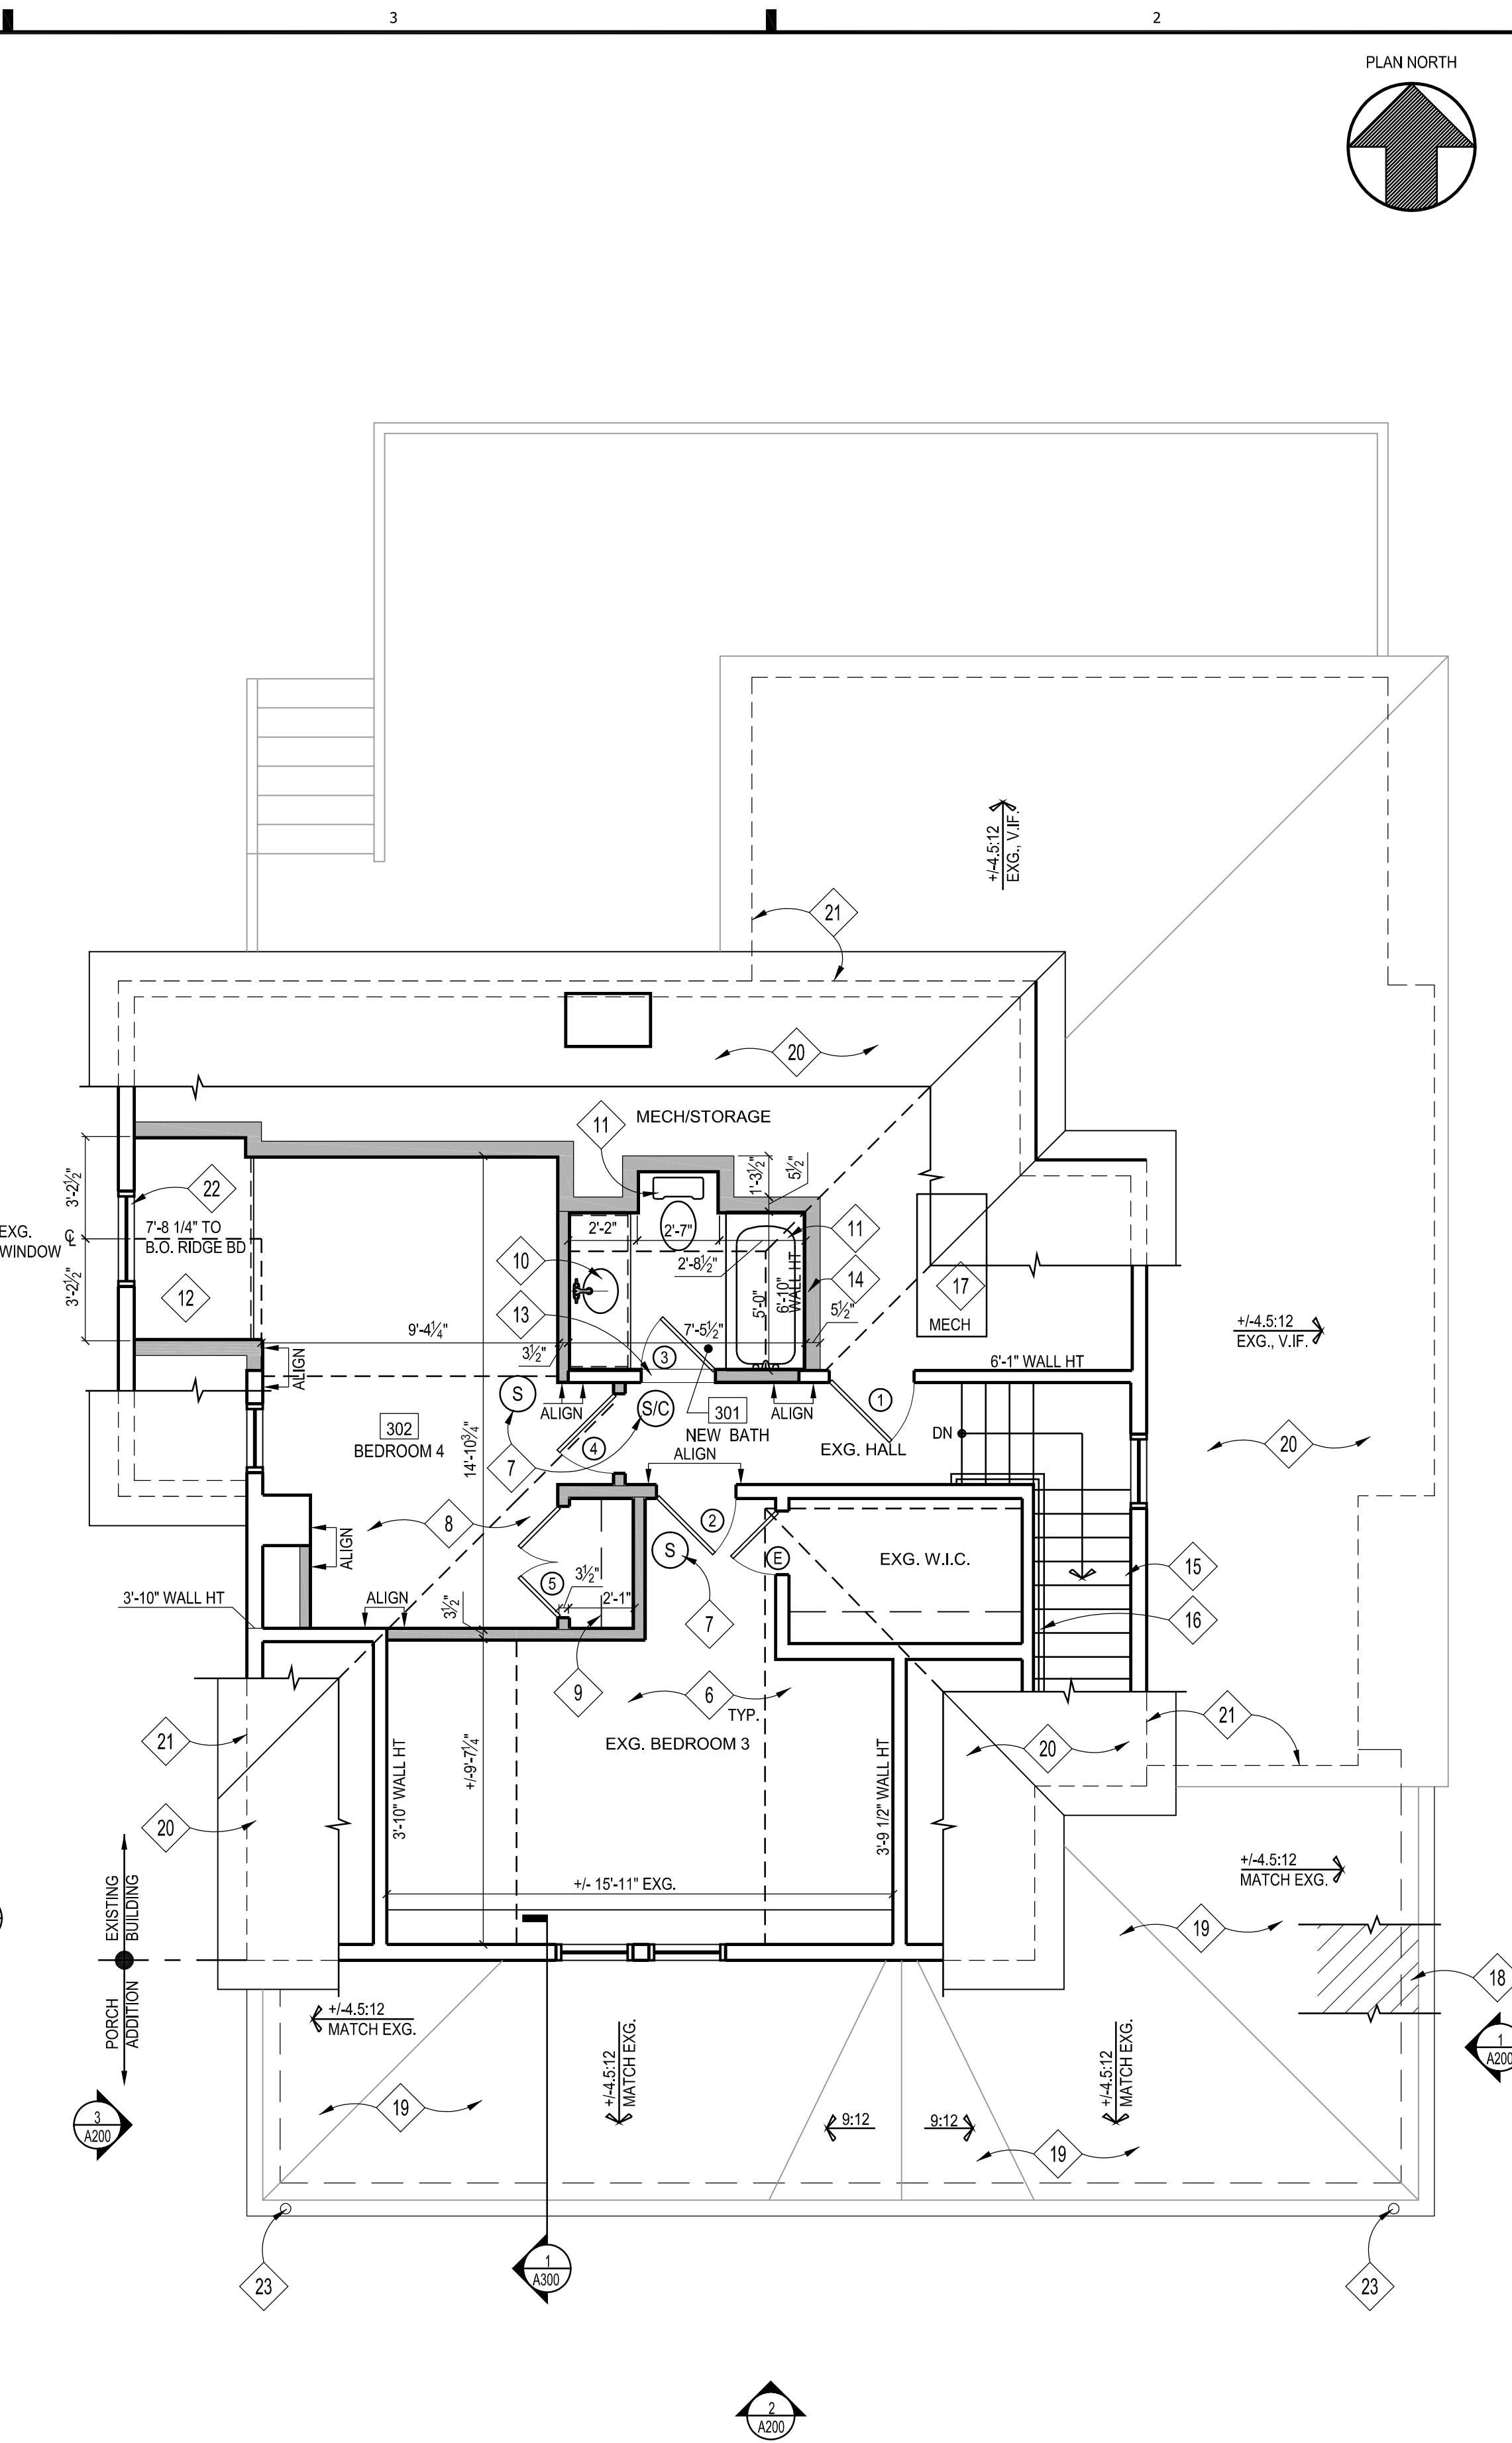

2 ATTIC PLAN
SCALE: 1/4"=1'-0"



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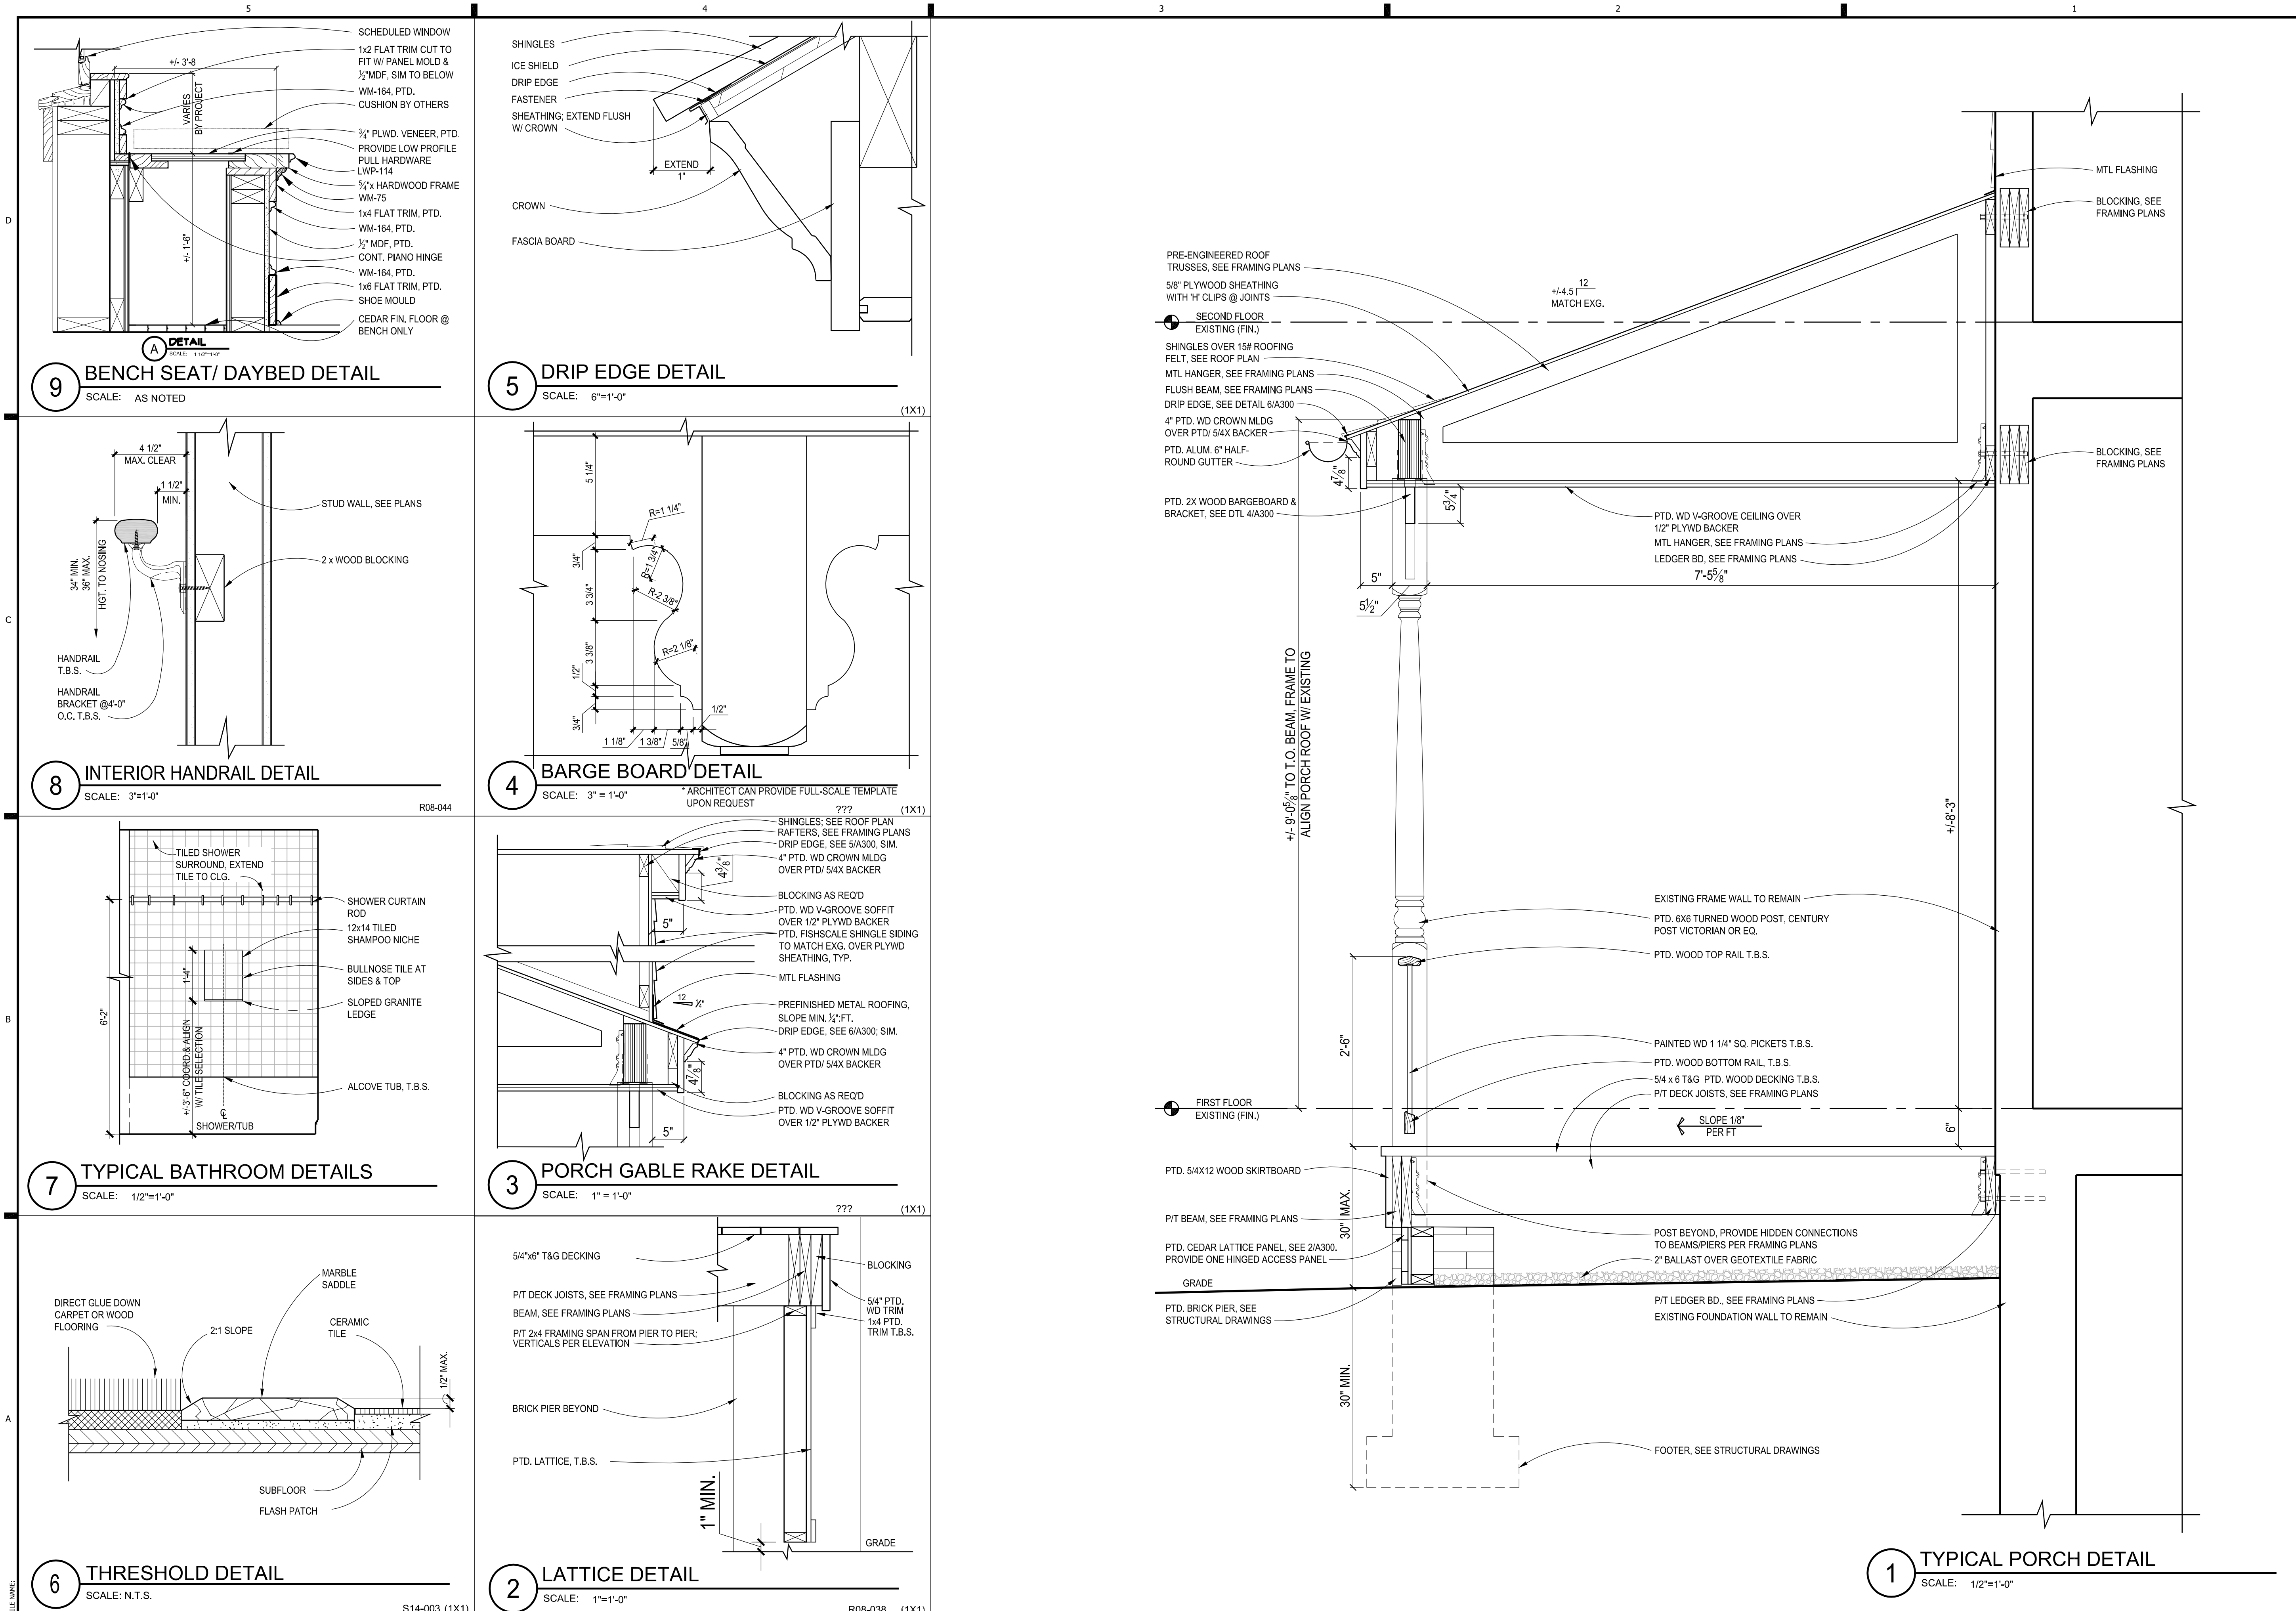
Sheet Title

SECTION & DETAILS

Sheet No.

A300

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FILE NAME:

S14-003 (1X1)

R08-038 (1X1)

PRE-ENGINEERED WOOD TRUSSES

TRUSSES SHALL BE DESIGNED IN ACCORDANCE WITH THESE SPECIFICATIONS AND WHERE ANY APPLICABLE DESIGN FEATURE IS NOT SPECIFIED HEREIN, DESIGN SHALL BE IN ACCORDANCE WITH APPLICABLE PROVISIONS OF LATEST EDITION OF NATIONAL DESIGN SPECIFICATIONS FOR WOOD CONSTRUCTION (NDS), AMERICAN FOREST AND PAPER ASSOCIATION (AFPA), AND DESIGN SPECIFICATIONS FOR METAL PLATE CONNECTED WOOD TRUSSES (ANSI/TPI 1), TRUSS PLATE INSTITUTE (TPI), AND CODES OF JURISDICTION. FABRICATE, SUPPLY AND ERECT WOOD TRUSSES AS SHOWN ON THE DRAWINGS AND AS SPECIFIED. WORK SHALL INCLUDE ALL ANCHORAGE, BLOCKING, CURBING, MISCELLANEOUS FRAMING AND BRACING.

LUMBER USED FOR TRUSS MEMBERS SHALL BE IDENTIFIED BY GRADE MARK OF A LUMBER INSPECTION AGENCY, AND SHALL BE AS SHOWN ON DESIGN DRAWINGS. TRUSSES SHALL BE HANDLED DURING FABRICATION, DELIVERY AND AT JOBSITE SO AS NOT TO BE SUBJECTED TO EXCESSIVE BENDING. TRUSSES SHALL BE UNLOADED ON SMOOTH GROUND TO AVOID LATERAL STRAIN. TRUSSES SHALL BE PROTECTED FROM DAMAGE THAT MIGHT RESULT FROM ON-SITE ACTIVITIES AND ENVIRONMENTAL CONDITIONS. PREVENT TOPPLING WHEN BANDING IS REMOVED.

HANDLE DURING INSTALLATION IN ACCORDANCE WITH HANDLING, INSTALLING AND BRACING WOOD TRUSSES (HIB-1), TPI, AND ANSI/TPI 1-1999. INSTALLATION SHALL BE CONSISTENT WITH GOOD WORKMANSHIP AND GOOD BUILDING PRACTICES. TRUSSES SHALL BE SET AND SECURED LEVEL AND PLUMB, AND IN CORRECT LOCATION. TRUSSES SHALL BE HELD IN CORRECT ALIGNMENT UNTIL SPECIFIED PERMANENT BRACING IS INSTALLED. CUTTING AND ALTERING OF TRUSSES IS NOT PERMITTED. CONCENTRATED LOADS (FULL BUNDLES OF DECKING) SHALL NOT BE PLACED ATOP TRUSSES UNTIL ALL SPECIFIED BRACING HAS BEEN INSTALLED AND DECKING IS PERMANENTLY NAILED IN PLACE. ERECTION BRACING IS ALWAYS REQUIRED. THE CONTRACTOR IS RESPONSIBLE FOR OBTAINING AND FURNISHING THE MATERIALS USED FOR INSTALLATION AND PERMANENT BRACING.

STRUCTURAL ENGINEER OF RECORD SHALL APPROVE SHOP DRAWINGS PRIOR TO SUBMITTAL TO BUILDING OFFICIAL. BUILDING OFFICIAL SHALL APPROVE SHOP DRAWING PRIOR TO INSTALLATION. TRUSSES SHALL BE FABRICATED FROM APPROVED SHOP DRAWINGS.

MANUFACTURER SHALL SUBMIT 3 COPIES OF TRUSS DESIGN DRAWINGS BEARING SEAL OF PROFESSIONAL ENGINEER FOR APPROVAL PRIOR TO ERECTION AND ENGINEERING FRAMING PLANS FOR ALL FLAT CHORD TRUSSES. ALL TRUSS SHOP DRAWINGS MUST BE REVIEWED AND APPROVED IN WRITING, BY GENERAL CONTRACTOR, PRIOR TO SUBMITTAL OF SHOP DRAWINGS TO STRUCTURAL ENGINEER AND MUST INCLUDE THE FOLLOWING:

1. STAMP AND SIGNATURE OF ENGINEER, WHO IS REGISTERED IN THE STATE WHERE THE JOB IS TO BE CONSTRUCTED, RESPONSIBLE FOR PREPARATION OF ALL TRUSS DESIGN AND LAYOUT DRAWING.
2. ALLOWABLE LOADS IN LBS/EFFECTIVE NAIL OR PSI FOR LUMBER & PLATES USED AS DRAWING BY ICBO, CURRENT ICBO REPORT NUMBER & BY SOUTHERN BUILDING CODE CONGRESS INTERNATIONAL.
3. STRESS REDUCTION FACTORS USED FOR PLATES.
4. TOP AND BOTTOM CHORD DESIGN LOADS IN PLF.
5. SIZE, GAUGE, AND EXACT LOCATION BY DIMENSION OF PLATES.
6. LUMBER SPECIES AND GRADES USED.
7. NAME & TRADEMARK OF PLATE MANUFACTURER, TRUSS FABRICATOR & PROJECT NAME/LOCATION
8. CONCENTRATED LOAD REQUIREMENTS HAVE BEEN DESIGNED FOR AND SHOWN ON DOCUMENTS.
9. TRUSS CONNECTION HARDWARE REQUIREMENTS.

ALL TRUSSES MUST BE DESIGNED FOR UPLIFT LOADS. UPLIFT VALUES @ EACH TRUSS BEARING POINT MUST BE SHOWN ON TRUSS ENGINEERING SHEET.

ALL ROOF TRUSSES SHALL BE ATTACHED TO PERPENDICULAR NON-LOAD BEARING WALLS WITH TRUSS CLIPS. CEILING GMB SHALL BE ATTACHED TO BLOCKING ON THE WALL AND NOT TO THE TRUSS FOR A DISTANCE OF 18" FROM THE WALL.

ALL FLOOR TRUSSES ON THE LOWEST FLOOR w/ TRUSSES SHALL BE ATTACHED TO PERPENDICULAR NON-LOAD BEARING WALLS WITH TRUSS CLIPS. CEILING GMB SHALL BE ATTACHED TO BLOCKING ON THE WALL AND NOT TO THE TRUSS FOR A DISTANCE OF 18" FROM THE WALL.

LIVE LOAD DEFLECTION SHALL NOT EXCEED 1/4" OR L/480 FOR FLOOR TRUSSES AND 1/8" OR L/360 FOR ROOF TRUSSES.

THE MANUFACTURER SHALL SUPPLY ALL REQUIRED HANGERS, HOLD-DOWN CLIPS, AND OTHER SPECIAL HARDWARE.

MASONRY

ALL MASONRY WORK SHALL CONFORM TO THE APPLICABLE REQUIREMENTS OF BIA AND NCMA SPECIFICATION FOR CONSTRUCTION (ACI 531-76) AND "SPECIFICATIONS FOR MASONRY STRUCTURE (ACI 530.1-02)" PUBLISHED BY THE AMERICAN CONCRETE INSTITUTE.

PROVIDE CONTINUOUS MASONRY BOND BEAM SPANNING ALL EXPANSION JOINTS & WALL INTERSECTIONS.

PROVIDE (2) #5 BENT BARS WITH 3-FOOT LEGS AT EVERY CORNER OR WALL INTERSECTION.

CONTINUOUS TIE OR BOND BEAMS SHALL BE REINFORCED WITH NOT LESS THAN 2 #5 CONTINUOUS BARS. LINTELS SHALL BE THE SIZES SHOWN AND REINFORCED AS INDICATED ON THE DRAWINGS.

REINFORCED MASONRY WALLS SHALL HAVE ALL REINFORCED CELLS FILLED WITH CONCRETE. CONCRETE MAY BE PLACED IN MAXIMUM VERTICAL LIFTS NOT TO EXCEED 4-FEET. ROUGHEN ALL SURFACES OF CONCRETE FILL WHICH ARE TO RECEIVE ADDITIONAL LIFTS ABOVE.

MASONRY WALLS SHALL HAVE "DUR-O-WALL" (OR APPROVED EQUAL) TRUSS TYPE HORIZONTAL REINFORCEMENT AT 16"oc VERTICALLY ABOVE GRADE AND 8"oc VERTICALLY BELOW GRADE. COORDINATE BRICK TIE BACK REQUIREMENTS WITH ARCHITECTURAL DRAWINGS. UNLESS NOTED OTHERWISE, STOP ALL HORIZONTAL JOINT REINFORCING AT CONTROL JOINTS.

BRICK VENEER WALLS TO HAVE NON-CORROSIVE METAL TIES AT 16"oc VERTICALLY AND HORIZONTALLY AND COMPLY WITH ASTM A82 WITH A153, CLASS B-2 COATING. MINIMUM WIRE DIAMETER SHALL BE 0.1875 INCHES. PROVIDE KEEP HOLES AT 24"oc AT BASE FLASHING.

PROVIDE MIN. 2 COURSES 8"x 16" SOLID BEARING AT BEAM & HEADER BEARING POINTS IN CMU WALLS.

A36 STEEL LINTEL SIZES FOR OPENINGS PER 4" THICKNESS OF MASONRY WALL AS FOLLOWS:
4"-0" SPAN OR LESS: 1 1/2"x 3" 1/2"x 5/16"
5'-6" SPAN OR LESS: 1 1/2"x 5/16"
7'-0" SPAN OR LESS: 1 1/2"x 5/16"
9'-0" SPAN OR LESS: 1 1/2"x 5/16"
11'-0" SPAN OR LESS: 1 1/2"x 5/16"
13'-0" SPAN OR LESS: 1 1/2"x 5/16"
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CONCRETE

ALL CONCRETE SHALL BE MADE IN ACCORDANCE WITH DESIGN MIXES WHICH ARE TO BE APPROVED BY THE ARCHITECT OR ENGINEER PRIOR TO CASTING ANY CONCRETE MIXES SHALL BE IN ACCORDANCE WITH THE AMERICAN CONCRETE INSTITUTION ACI 318. ALL PLAIN CONCRETE TO CONFORM TO ACI 318.1 AND ACI 302.2 GUIDE TO RESIDENTIAL CAST IN PLACE CONCRETE CONSTRUCTION. MIXES SHALL HAVE A MINIMUM CEMENT CONTENT OF 520 LB. PER CUBIC YD., MAXIMUM WATER/CEMENT RATIO OF 0.53 FOR INTERIOR CONCRETE PROTECTED FROM FREEZING AND 0.45 FOR ALL EXTERIOR EXPOSED CONCRETE.

CONCRETE MATERIALS SHALL CONFORM TO ASTM C150, TYPE I FOR PORTLAND CEMENT AND ASTM C33 FOR AGGREGATES. WATER-REDUCING ADMIXTURES SHALL CONFORM TO ASTM C494, TYPE A (FREE OF CALCIUM CHLORIDES). AIR-ENTRAINING ADMIXTURES SHALL CONFORM TO ASTM C260, AND HIGH-RANGE WATER REDUCERS (SUPER-PLASTICIZERS) SHALL CONFORM TO ASTM C494, TYPE F. FLY ASH SHALL COMPLY WITH ASTM C619 FOR CLASS F AND SHALL NOT BE PROPORTIONED IN MIXES WITH MORE THAN 20% CEMENT BY WEIGHT. LIQUID-MEMBRANE CURING COMPOUNDS SHALL BE HIGH-SOLIDS, WATER AND ACRYLIC-BASED, COMPLYING WITH ASTM C309 AS TESTED UNDER ASTM C566. SLUMP OF THE CONCRETE SHALL BE A MINIMUM OF 4-INCHES AND A MAXIMUM OF 6-INCHES. SEE THE PROJECT SPECIFICATIONS. THE COMPRESSIVE STRENGTH IS BASED 28-DAY COMPRESSIVE STRENGTH.

SLAB ISOLATION JOINTS- PROVIDE PRE-MOLDED JOINT FILLER AROUND ALL PIPING, PIERS & FOUNDATION WALLS.

ALL CONCRETE TO BE PLACED IN THE CELLS OF CONCRETE MASONRY UNITS (CMU BLOCK FILL), OR IN THE VOIDS OF BRICK MASONRY CONSTRUCTION, SHALL CONTAIN FEA GRAVEL (3/8"Ø STONE) IN LIEU OF COARSE AGGREGATE. THE CONCRETE MIX SHALL CONTAIN A HIGH-RANGE WATER REDUCER (SUPERPLASTICIZER). SLUMP OF THE CONCRETE SHALL BE A MINIMUM OF 6" AND A MAXIMUM OF 9". SEE THE PROJECT SPECIFICATIONS.

ALL EXTERIOR CONCRETE AND CONCRETE EXPOSED TO WEATHER SHALL BE AIR-ENTRAINED, 6% ±. USE OF ADDITIVES SHALL NOT BE PERMITTED UNLESS SPECIFICALLY APPROVED BY THE STRUCTURAL ENGINEER. USE OF ADDITIVES CONTAINING CALCIUM CHLORIDE SHALL NOT BE PERMITTED. DO NOT USE HIGH-RANGE WATER REDUCING ADMIXTURES IN AIR-ENTRAINED CONCRETE. CONFORM TO ASTM C260.

ADDITION OF WATER TO THE CONCRETE AT THE JOB SITE FOR THE PURPOSE OF INCREASING THE SLUMP OR FOR RETEMPERING THE CONCRETE WHICH HAS BEGUN TO SET IS STRICTLY PROHIBITED. SEE THE PROJECT SPECIFICATIONS FOR REQUIREMENTS OF WATER ADDITION TO CONCRETE AT THE JOBSITE.

SLABS ON GRADE SHALL BE 4" THICK CONCRETE AND REINFORCED W/6# W1.4XW1.4 W/MF. WELDED WIRE FABRIC SHALL BE SUPPORTED ON HIGH CHAIRS SO THAT THE FABRIC IS POSITIONED AT MID-DEPTH OF THE SLAB THICKNESS. LAP ONE FULL MESH PLUS 2" AT SPLICES IN EACH DIRECTION. PLACE CONTROL JOINTS OVER 6 MIL. POLYETHYLENE VAPOR BARRIER AND 4" MINIMUM COURSE AGGREGATE OR AS RECOMMENDED BY SOILS ENGINEER. THE AGGREGATE LAYER SHALL BE PLACED OVER FIRM NATURAL SUBGRADE OR ON COMPACTED AND CONTROLLED FILL. FILL UNDER SLABS SHALL BE COMPACTED IN 8 INCH LAYERS TO 95% MAX. DENSITY. USE AIR-ENTRAINED AT ALL EXTERIOR SLABS.

CONCRETE FOR SLABS-ON-GRADE SHALL BE PLACED IN A SEQUENCE AND MANNER THAT IS CONSISTENT WITH THE RECOMMENDATIONS OF THE AMERICAN CONCRETE INSTITUTE. LOCATE CONSTRUCTION AND CONTROL JOINTS IN SUCH A WAY TO MINIMIZE THE EFFECTS OF SHRINKAGE OF THE CONCRETE. SUBMIT TO THE ARCHITECT/ENGINEER THE SEQUENCE AND METHOD OF CASTING CONCRETE SLABS-ON-GRADE PRIOR TO PLACING THESE ELEMENTS. FOUR SLABS IN ALTERNATE PANELS WITH A MAXIMUM OF 600 SF AND PROVIDE CONTROL AND CONSTRUCTION JOINTS AT 15'-0" MAXIMUM OR AS REQUIRED TO PREVENT UNCONTROLLED CRACKING.

SLAB CONTROL JOINTS- SAW CUT OR FORM TO 1/3 SLAB DEPTH. SPACE NO MORE THAN 15 FEET APART. DISCONTINUE WELDED WIRE FABRIC AT CONTROL JOINTS. PROVIDE JOINTS ON GROUND SUPPORTED SLABS IN RECTANGULAR CONFIGURATION, WITH THE LONGER SIDE NO MORE THAN ONE-AND-ONE-HALF TIMES THE LENGTH OF THE SHORTER SIDE.

THE CONTRACTOR SHALL BE RESPONSIBLE FOR FURNISHING AND INSTALLING ANCHOR BOLTS, CLIPS, INSERTS, CONNECTION PLATES, SLEEVES, SLOTS AND OTHER REQUIRED ITEMS IN ACCORDANCE WITH THE CONTRACT DRAWINGS, AND IN COOPERATION WITH OTHER TRADES PRIOR TO PLACING CONCRETE.

ALL REINFORCING SHALL BE DETAILED, FABRICATED, AND PLACED IN ACCORDANCE WITH ACI'S MANUAL OF STANDARD PRACTICE FOR DETAILING CONCRETE STRUCTURES, (ACI-318). DETAILS OF REINFORCEMENT SHALL CONFORM TO ACI 318, ACI 315, AND CRSI STANDARDS.

ALL REINFORCING STEEL (INCLUDING WELDED WIRE FABRIC) SHALL BE SECURELY TIED AND ANCHORED IN PLACE TO PREVENT DISLOCATION DURING THE PLACING OPERATION.

REINFORCING STEEL SHALL BE CLEAN OF MUD, DEBRIS, LOOSE RUST, CEMENT, GROUT, OR ANY OTHER MATERIAL WHICH MAY INHIBIT THE BOND BETWEEN THE STEEL AND CONCRETE.

PROVIDE 8" X 8" CORNER BARS TO MATCH ALL HORIZONTAL REINFORCING IN WALLS AND FOOTINGS. ALL BARS SHALL BE A MINIMUM OF 3/8" BAR DIAMETERS. PROVIDE DOWELS BETWEEN ALL FOOTINGS, WALLS AND PIERS TO MATCH SIZE AND SPACING OF VERTICAL REINFORCING.

DRY PACK SHALL CONSIST OF SIKAGROUT 212 OR APPROVED SUBSTITUTE. INSTALL PER MANUFACTURERS RECOMMENDATIONS.

WOOD

FLITCH BEAMS SHALL BE SIZED AS INDICATED ON THE DRAWINGS, USING #2 SPF MINIMUM AND A-86 STEEL PLATE. USE TWO ROWS OF 1/2" DIAMETER THROUGH BOLTS 2' FROM TOP AND BOTTOM. SPACED 16"OC AT TOP AND 32"OC AT THE BOTTOM. BEGIN BOLTING ROWS 6" FROM ENDS. STEEL FLITCH PLATES MUST BE EITHER FULL LENGTH OR FULL MOMENT BUTT SPLICE.

WOOD EXPOSED TO THE ELEMENTS, WOOD IN CONTACT WITH CONCRETE OR MASONRY, AND WOOD DESIGNATED "TREATED" SHALL BE #2 GRADE SOUTHERN PINE OR BETTER & PRESSURE IMPREGNATED WITH ALKALINE COPPER QUATERNARY (ACQ) IN ACCORDANCE WITH AMERICAN WOOD PRESERVERS ASSOCIATION (AWPA) STANDARD C2, WITH A MIN. RETENTION OF 0.40 LBS. PER CUBIC FOOT OF WOOD. MIN. DEPTH OF PENETRATION SHALL BE 2.5" OR 85% OF THE SAWWOOD.

ALL STUDS SHALL BE INSTALLED IN ACCORDANCE WITH WFOPA. MEMBERS ARE NOT TO BE DRILLED IN EXCESS OF NDS OR LOCAL CODE REQUIREMENTS, WHICHEVER IS MORE STRINGENT. ALL POSTS AND MULTIPLE STUDS SHALL BE RUN CONTINUOUSLY TO SOLID BEARING ON FOUNDATION WALL OR BEAMS, PROVIDE SOLID BLOCKING AT FLOORS. COLUMN SHALL BE ADEQUATELY ANCHORED TO PREVENT INTERNAL DISPLACEMENT.

FRAME CHIMNEYS- FRAME CHIMNEYS SHALL BE CONSTRUCTED OF MINIMUM #2 SPF STUDS, MAXIMUM 16"OC. USE 2 X 4 IF CHIMNEY EXTENDS LESS THAN 8' ABOVE ROOF, OTHERWISE USE 2 X 6. SHEATH WITH 1/2" APA OR APPROVED SUBSTITUTE RATED SHEATHING CONTINUOUS ACROSS PLATES AND JOISTS, GLUE, AND NAIL WITH 8D NAILS @ 6"OC SECURE TO ROOF. STUDS MUST BE CONTINUOUS ACROSS ROOF INTERSECTION.

NO STRUCTURAL MEMBER SHALL BE OMITTED, NOTCHED, CUT, BLOCKED OUT OR RELOCATED WITHOUT PRIOR APPROVAL BY THE DESIGNER OR STRUCTURAL ENGINEER. DO NOT ALTER SIZES OF MEMBERS NOTED WITHOUT APPROVAL OF BOTH.

CUTTING OF WOOD BEAMS, JOISTS AND RAFTERS SHALL BE LIMITED TO CUTS AND BORED HOLES NOT DEEPER THAN ONE-SIXTH THE MEMBER DEPTH AND SHALL NOT BE LOCATED WITHIN THE MIDDLE THIRD OF THE SPAN. NOTCHES LOCATED CLOSER TO SUPPORTS THAN THREE TIMES THE MEMBER DEPTH SHALL NOT EXCEED ONE-FIFTH THE DEPTH. HOLES BORED OR CUT INTO JOISTS SHALL BE MIN. 2" CLEAR FROM THE TOP OR BOTTOM OF THE JOIST AND THE HOLE DIAMETER SHALL NOT EXCEED ONE-THIRD OF THE JOIST DEPTH.

THERE SHALL NOT BE LESS THAN ONE LINE OF BRIDGING IN EVERY EIGHT FEET OF SPAN IN FLOOR, ATTIC AND ROOF FRAMING. THE BRIDGING SHALL CONSIST OF NOT LESS THAN ONE BY THREE INCH LUMBER DOUBLED NAILED AT EACH END OR OF EQUIVALENT METAL BRACING OF EQUAL RIGIDITY. MIDSPAN BRIDGING IS NOT REQUIRED FOR FLOOR, ATTIC OR ROOF FRAMING WHERE JOIST DEPTH DOES NOT EXCEED TWELVE INCHES NOMINAL. BLOCK ALL STUD WALLS AT MAXIMUM INTERVALS OF EIGHT FEET WITH A MINIMUM OF TWO-BY-SIX SOLID MATERIAL WITH TIGHT JOINTS. PROVIDE TWO-BY-FIVE FIRE-STOP AT MID-POINT OF STUD WALLS.

UNLESS NOTED OTHERWISE, BRACE EXTERIOR CORNERS OF BUILDING WITH 1 X 4 DIAGONALS, LET INTO STUDS, OR 4 X 8 PLYWOOD SHEET OF THICKNESS TO MATCH THAT OF SHEATHING, OR WITH METAL STRAPS. LAP PLATES AT ALL CORNERS.

MISCELLANEOUS

THE CONTRACTOR IS SOLELY RESPONSIBLE FOR ALL SAFETY REGULATIONS, PROGRAMS AND PRECAUTIONS RELATED TO ALL WORK ON THIS PROJECT AND FOR THE PROTECTION OF PERSONS AND PROPERTY EITHER ON OR ADJACENT TO THE PROJECT AND SHALL PROTECT SAME AGAINST INJURY, DAMAGE OR LOSS.

THE CONTRACTOR IS RESPONSIBLE FOR LIMITING THE AMOUNT OF CONSTRUCTION LOAD IMPOSED ON THE STRUCTURE. SUCH LOADS SHALL NOT EXCEED THE CAPACITY OF THE STRUCTURE AT ANY TIME. THE STRUCTURE IS DESIGNED TO FUNCTION AS A UNIT UPON COMPLETION, AND ANY TEMPORARY BRACING OR SUPPORT REQUIRED TO ACCOMMODATE THE CONTRACTOR'S MEANS AND METHODS ARE THE RESPONSIBILITY OF THE CONTRACTOR.

THE CONTRACTOR IS TO VERIFY ALL OPENING SIZES AND LOCATIONS WITH THE REQUIREMENTS OF OTHER TRADES PRIOR TO FABRICATION AND ERECTION.

STRUCTURAL DRAWINGS SHALL BE USED IN CONJUNCTION WITH THE ARCHITECTURAL, MECHANICAL, ELECTRICAL AND PLUMBING DRAWINGS, AND THE CONTRACTOR SHALL BE RESPONSIBLE FOR SEEING THAT THE WORK OF ALL TRADES IS COORDINATED WITH STRUCTURAL WORK.

EARTH RETAINING WALLS, OTHER THAN CANTILEVERED TYPE WALLS, SHALL BE ADEQUATELY BRACED UNTIL CONCRETE FOR SUPPORTING SLABS HAS BEEN PLACED AND ALL CONCRETE HAS CURED.

THE CONTRACTOR SHALL BE RESPONSIBLE FOR DESIGNING, FURNISHING, ERECTING AND REMOVING ANY TEMPORARY SHORING AND BRACING DURING CONSTRUCTION.

THE ARCHITECT AND ENGINEER SHALL BE NOTIFIED AT THE PROPER TIME WHEN ALL ITEMS ARE READY FOR OBSERVATION. SUFFICIENT NOTICE SHALL BE GIVEN BY THE CONTRACTOR TO ALLOW FOR SCHEDULING OF OBSERVATIONS.

SAFETY REGULATIONS SHALL BE STRICTLY FOLLOWED BY THE CONTRACTOR OR SUBCONTRACTOR DURING ALL TIMES OF WORK ON THIS PROJECT. THE ARCHITECT OR ENGINEER SHALL NOT HAVE CONTROL OR CHARGE OF, AND SHALL NOT BE RESPONSIBLE FOR CONSTRUCTION MEANS, METHODS, TECHNIQUES, SEQUENCES OR PROCEDURES, FOR SAFETY PRECAUTIONS AND PROGRAMS IN CONNECTION WITH THE WORK, FOR ACTS OF OMISSIONS OF THE CONTRACTOR, SUBCONTRACTORS, OR ANY OTHER PERSONS PERFORMING ANY OF THE WORK IN ACCORDANCE WITH THE CONTRACT DOCUMENTS.

ALL SPECIALTY BOLTS, INCLUDING EXPANSION TYPE AND EPOXY TYPE ANCHORS SHALL BE INSTALLED IN STRICT ACCORDANCE WITH THE MANUFACTURER'S PRINTED INSTRUCTIONS.

THE CONTRACTOR SHALL PROTECT FROM DAMAGES EXISTING BUILDING(S), OWNER EQUIPMENT, ROADS, WALKS AND UTILITIES. THE CONTRACTOR SHALL MAINTAIN THESE DURING THE COURSE OF THE WORK, AND SHALL REPAIR ALL DAMAGES AT NO ADDITIONAL EXPENSE TO THE OWNER.

IN AREAS WHERE THE DRAWINGS DO NOT ADDRESS METHODOLOGY, THE CONTRACTOR SHALL BE BOUND TO PERFORM IN STRICT COMPLIANCE WITH MANUFACTURER'S SPECIFICATIONS AND/OR RECOMMENDATIONS.

ON-SITE VERIFICATION OF ALL DIMENSIONS AND CONDITIONS SHALL BE THE RESPONSIBILITY OF THE GENERAL CONTRACTOR AND HIS SUBCONTRACTORS. NOTED DIMENSIONS SHALL TAKE PRECEDENCE OVER SCALE.

THE GENERAL NOTES AND TYPICAL DETAILS APPLY THROUGHOUT THE JOB UNLESS OTHERWISE NOTED OR SHOWN.

THE CONTRACTOR SHALL COMPARE AND COORDINATE ALL DRAWINGS. IF A DISCREPANCY EXISTS, HE SHALL PROMPTLY REPORT IT FOR PROPER ADJUSTMENT BEFORE PROCEEDING WITH THE WORK.

IN THE EVENT THAT CERTAIN FEATURES OF THE CONSTRUCTION ARE NOT FULLY SHOWN ON THE DRAWINGS, THEIR CONSTRUCTION SHALL BE OF THE SAME CHARACTER AS SIMILAR CONDITIONS THAT ARE SHOWN OR NOTED.

THESE PLANS ARE SUBJECT TO MODIFICATIONS AS NECESSARY TO MEET CODE REQUIREMENTS OR TO FACILITATE MECHANICAL, PLUMBING INSTALLATIONS OR TO INCORPORATE DESIGN IMPROVEMENTS.

DO NOT BUILD OVER GAS LINES OR ENCLOSE THE METER. CONSULT THE LOCAL GAS COMPANY PRIOR TO CONSTRUCTION.

CHIMNEY SHALL EXTEND AT LEAST 2 FEET HIGHER THAN ANY PORTION OF THE BUILDING WITHIN 10 FEET, BUT SHALL NOT BE LESS THAN 3 FEET ABOVE THE POINT WHERE IT PASSES THROUGH THE ROOF.

DECKS ARE NOT APPROVED FOR FUTURE HOT TUB INSTALLATION.

NO OPENING NOR ANY CHANGES IN SIZE, DIMENSION OR LOCATION SHALL BE MADE IN ANY STRUCTURAL ELEMENTS WITHOUT WRITTEN APPROVAL OF THE STRUCTURAL ENGINEER.

CONTRACTOR SHALL VERIFY ALL EXISTING CONDITIONS PRIOR TO ORDERING MATERIALS OR PROCEEDING WITH NEW WORK IN AREAS AFFECTED BY EXISTING CONDITIONS. STRUCTURAL ENGINEER SHALL BE INFORMED IN WRITING OF CONFLICTS BETWEEN EXISTING AND PROPOSED NEW CONSTRUCTION.

CONTRACTOR IS RESPONSIBLE FOR COORDINATING ALL DIMENSIONS SHOWN ON THE CONTRACT DOCUMENTS. INCONSISTENCIES ON THE STRUCTURAL DRAWINGS OR BETWEEN THE STRUCTURAL DRAWINGS AND ANY OTHER CONTRACT, SHOP, FABRICATION, OR OTHER DRAWINGS OR INFORMATION SHALL BE BROUGHT TO THE ATTENTION OF THE STRUCTURAL ENGINEER PRIOR TO PROCEEDING WITH AFFECTED WORK.

THE STRUCTURAL INTEGRITY OF THE BUILDING IS DEPENDANT UPON COMPLETION ACCORDING TO EXPOSED TO THE ELEMENTS. THE STRUCTURAL ENGINEER ASSUMES NO LIABILITY FOR THE STRUCTURE DURING CONSTRUCTION. THE METHOD OF CONSTRUCTION AND SEQUENCE OF OPERATIONS IS THE SOLE RESPONSIBILITY OF THE CONTRACTOR. THE CONTRACTOR SHALL SUPPLY ANY NECESSARY SHORING, BRACING, GUTS, ETC., TO PROPERLY BRACE THE STRUCTURE AGAINST WIND, DEAD AND LIVE LOADS UNTIL THE BUILDING IS COMPLETED ACCORDING TO THE PLANS AND SPECIFICATIONS.

CONTRACTOR SHALL NOT PLACE BACK-FILL AGAINST BASEMENT WALLS UNTIL THE FLOOR SYSTEM IS COMPLETELY INSTALLED OR CONTRACTOR HAS PROVIDED ADEQUATE SHORING AND BRACING. ANY QUESTIONS REGARDING TEMPORARY SHORING REQUIREMENTS SHOULD BE FORWARDED TO THE STRUCTURAL ENGINEER FOR REVIEW.

FOUNDATION STEM WALL REINFORCEMENT SCHEDULE

STEM WALL HEIGHT (H)	SOIL CLASSIFICATIONS / PRESUMPTIVE BEARING CAPACITIES (EQUIVALENT FLUID PRESSURE)			
	GM, GP, SW & SP (30pcf)	GM, GP, SW & SP (45 pcf)	SC, MH, ML-CL, INORGANIC CL (60 pcf)	
8' WALL HEIGHT (H)				
16'	36'	N/A	N/A	
24'	44'	#4 @ 18"oc	#4 @ 16"oc	
32'	52'	#4 @ 16"oc	#4 @ 12"oc	
40'	60'	#4 @ 16"oc	#4 @ 12"oc	
48'	68'	#4 @ 16"oc	#4 @ 12"oc	
9' WALL HEIGHT (H)				
16'	36'	N/A	N/A	
24'	44'	#4 @ 18"oc	#4 @ 16"oc	
32'	52'	#4 @ 16"oc	#4 @ 12"oc	
40'	60'	#4 @ 18"oc	#4 @ 8"oc	
48'	68'	#4 @ 16"oc	#4 @ 12"oc	

d = 3.5"(MIN), CONCRETE COMPRESSIVE STRENGTH = 3,000 psi

FOUNDATION WALL STRIP FOOTING SCHEDULE

MARK	8" CONCRETE WALL (D) FOOTING SIZES			
	CL, ML, MH & CH (1500 psf)	SM, SP, SH, SC, GP1 & GC (2000 psf)	(2500 psf)	GM, GP (3000 psf)
WBA	8' x 16'	8' x 16'		
WBB	8' x 18'	8' x 18'		
WBC	8' x 20'			
WBD	8' x 22'	8' x 18'		
WBE	8' x 24'		8' x 16'	
WBF	10' x 26'	8' x 20'		
WBG	10' x 28'	8' x 22'		
WBH	10' x 30'	8' x 24'	8' x 18'	
WBI	12' x 32'	8' x 24'	8' x 20'	
WBJ	12' x 34'	10' x 26'		
WBK	14' x 36'	10' x 28'	8' x 22'	8' x 18'

MARK	10" CONCRETE WALL (D) FOOTING SIZES			
	CL, ML, MH & CH (1500 psf)	SM, SP, SH, SC, GP1 & GC (2000 psf)	(2500 psf)	GM, GP (3000 psf)
WIBB	8' x 18'			
WIOC	8' x 20'	8' x 18'		
WIOD	8' x 22'			
WIOE	8' x 24'		8' x 18'	
WIOF	8' x 26'	8' x 20'		
WIOG	10' x 28'	8' x 22'		
WIOH	10' x 30'	8' x 24'		
WIOI	12' x 32'	8' x 24'	8' x 20'	
WIOJ	12' x 34'	8' x 26'		
WIOK	14' x 36'	10' x 28'	8' x 22'	

MARK	12" CONCRETE WALL (D) FOOTING SIZES			
	CL, ML, MH & CH (1500 psf)	SM, SP, SH, SC, GP1 & GC (2000 psf)	(2500 psf)	GM, GP (3000 psf)
WIZC	8' x 20'			
WIZD	8' x 22'	8' x 20'		
WIZE	8' x 24'			
WIZF	8' x 26'		8' x 18'	
WIZG	8' x 28'	8' x 22'		8' x 20'
WIZH	10' x 30'	8' x 24'		
WIZI	10' x 32'			
WIZJ	12' x 34'	8' x 26'	8' x 22'	
WIZK	14' x 36'	10' x 28'		

ISOLATED FOOTING SCHEDULE

MARK (FHR)	SQUARE, ISOLATED FOOTING SPECIFICATIONS			
	CL, ML, MH & CH (1500psf)	SM, SP, SH, SC, GP1 & GC (2000psf)	(2500psf)	GM, GP (3000psf)
FA	30"x12"-0	24"x12"-0	24"x12"-0	24"x12"-0
FB	32"x12"-0	26"x12"-0	24"x12"-0	24"x12"-0
FC	34"x12"-0	28"x12"-0	24"x12"-0	24"x12"-0
FD	36"x12"-0	30"x12"-0	26"x12"-0	26"x12"-0
FE	38"x12"-0	32"x12"-0	30"x12"-0	28"x12"-0
FF	40"x12"-0	34"x12"-0	32"x12"-0	28"x12"-0
FG	44"x12"-3	36"x12"-0	32"x12"-0	30"x12"-0
FH	46"x12"-3	38"x12"-2	34"x12"-2	32"x12"-2
FI	48"x12"-3	40"x12"-2	36"x12"-2	34"x12"-2
FJ	50"x12"-3	42"x12"-3	38"x12"-2	34"x12"-2
FK	52"x12"-3	44"x12"-3	40"x12"-2	36"x12"-2
FL	54"x12"-3	46"x12"-3	42"x12"-3	38"x12"-2
FM	58"x12"-4	48"x12"-3	44"x12"-3	40"x12"-2
FN	60"x12"-5	50"x12"-4	46"x12"-4	42"x12"-3
FO	62"x12"-6	52"x12"-4	48"x12"-4	42"x12"-3
FP	64"x12"-6	54"x12"-4	48"x12"-4	44"x12"-4
FP	64"x12"-6	56"x12"-5	50"x12"-4	46"x12"-4
FR	68"x12"-7	58"x12"-6	52"x12"-5	48"x12"-5
FS	72"x12"-8	60"x12"-6	54"x12"-6	50"x12"-5
FT	74"x12"-9	62"x12"-7	56"x12"-6	50"x12"-5
FV	76"x12"-10	64"x12"-8	58"x12"-7	52"x12"-6
FV	78"x12"-10	66"x12"-8	60"x12"-8	54"x12"-7
FY	80"x12"-11	68"x12"-9	62"x12"-8	56"x12"-7
FY	82"x12"-11	70"x12"-9	62"x12"-8	58"x12"-8
FZ	86"x12"-12	72"x12"-10	64"x12"-9	58"x12"-8
FZ	88"x12"-13	74"x12"-11	66"x12"-9	60"x12"-8

N = NUMBER OF #4 BOTTOM BARS, EACH WAY

FOUNDATION WALL REINFORCEMENT SCHEDULE

MAXIMUM WALL HEIGHT (H)	MAXIMUM UNBALANCED HEIGHT (H _{unb})	SOIL CLASSIFICATIONS / PRESUMPTIVE BEARING CAPACITIES (EQUIVALENT FLUID PRESSURE)			
		GM, GP, SW & SP (30pcf)	GM, GP, SW & SP (45 pcf)	SC, MH, ML-CL, INORGANIC CL (60 pcf)	
8" CONCRETE WALL (D) VERTICAL REINFORCEMENT					
5'	4'-4"	N/A	N/A	N/A	N/A
6'	4.5,5'-4"	N/A	N/A	N/A	N/A
7'	6	N/A	N/A	#4 @ 36"oc	N/A
8'	6'-4"	N/A	#4 @ 24"oc	#4 @ 18"oc	N/A
9'	4.5	N/A	N/A	N/A	N/A
10'	7	N/A	N/A	#4 @ 24"oc	N/A
	7	N/A	#4 @ 24"oc	#4 @ 18"oc	N/A
	7'-4"	#4 @ 30"oc	#4 @ 18"oc	#4 @ 12"oc	N/A
	4.5	N/A	N/A	N/A	N/A
	6	N/A	N/A	#4 @ 24"oc	N/A
	7	N/A	#4 @ 18"oc	#4 @ 16"oc	N/A
	8	#4 @ 24"oc	#4 @ 16"oc	#4 @ 12"oc	N/A
	8'-4"	#4 @ 20"oc	#4 @ 12"oc	#4 @ 8"oc	N/A
	4.5	N/A	N/A	N/A	N/A
	6	N/A	N/A	#4 @ 20"oc	N/A
	7	N/A	#4 @ 18"oc	#4 @ 12"oc	N/A
	8	#4 @ 24"oc	#4 @ 12"oc	#4 @ 8"oc	N/A
	9	#4 @ 18"oc	#4 @ 12"oc	#4 @ 8"oc	N/A
	9'-4"	#4 @ 12"oc	#4 @ 8"oc	#4 @ 8"oc	N/A

d = 5"(MIN), CONCRETE COMPRESSIVE STRENGTH = 3,000 psi

MAXIMUM WALL HEIGHT (H)	MAXIMUM UNBALANCED HEIGHT (H _{unb})	SOIL CLASSIFICATIONS / PRESUMPTIVE BEARING CAPACITIES (EQUIVALENT FLUID PRESSURE)			
		GM, GP, SW & SP (30pcf)	GM, GP, SW & SP (45 pcf)	SC, MH, ML-CL, INORGANIC CL (60 pcf)	
10" CONCRETE WALL (D) VERTICAL REINFORCEMENT					
5'	4'-4"	N/A	N/A	N/A	N/A
6'	4.5,5'-4"	N/A	N/A	N/A	N/A
7'	4.5,6'-4"	N/A	N/A	N/A	N/A
8'	7'-4"	N/A	N/A	#4 @ 20"oc	N/A
9'	4.5,6	N/A	N/A	N/A	N/A