

HISTORIC PRESERVATION COMMISSION

Marc Elrich
County Executive

Sandra I. Heiler Chairman

Date: March 26, 2020

MEMORANDUM

TO: Hadi Mansouri

Department of Permitting Services

FROM: Dan Bruechert

Historic Preservation Section

Maryland-National Capital Park & Planning Commission

SUBJECT: Historic Area Work Permit #907120: Fenestration Alteration

The Montgomery County Historic Preservation Commission (HPC) has reviewed the attached application for a Historic Area Work Permit (HAWP). This application was **approved** at the March 25, 2020 HPC meeting.

The HPC staff has reviewed and stamped the attached construction drawings.

THE BUILDING PERMIT FOR THIS PROJECT SHALL BE ISSUED CONDITIONAL UPON ADHERENCE TO THE ABOVE APPROVED HAWP CONDITIONS AND MAY REQUIRE APPROVAL BY DPS OR ANOTHER LOCAL OFFICE BEFORE WORK CAN BEGIN.

Applicant: Susan Bundock

Address: 7213 Maple Ave., Takoma Park

This HAWP approval is subject to the general condition that the applicant will obtain all other applicable Montgomery County or local government agency permits. After the issuance of these permits, the applicant must contact this Historic Preservation Office if any changes to the approved plan are made. Once work is complete the applicant will contact Dan Bruechert at 301.563.3400 or dan.bruechert@montgomeryplanning.org to schedule a follow-up site visit.



By Dan.Bruechert at 3:53 pm, Apr 14, 2020

GENERAL DEMOLITION NOTES:

necessary to implement new layout and design.

wiring, etc. that are to be replaced by new work.

direct loads until new bearing elements are constructed.

Dispose of all discarded material in a safe and clean manner.

lead abatement professional must be used.

1. Remove any existing kitchen cabinets and fixtures as necessary to implement new

2. Remove/re-route plumbing (water supplies, drains, vents and gas lines, radiators,

etc.) as necessary to accomplish new plan layout and to minimize their impact on

3. Remove all trim, gypsum board/plaster, doors, thresholds, flooring, etc. but only as

4. For removal of any lead paint, asbestos tile or siding, etc., a certified asbestos or

5. Remove existing wall and/or floor construction as noted on plans as necessary to

6. Remove and salvage (as per owners' request) existing light fixtures to implement

7. Remove all electrical outlets, fixtures, smoke alarms, telephone wiring, exposed

9. Protect all surfaces during demolition (and construction) from unnecessary damage.

implement new layout; if walls are bearing walls, use temporary supports to re-

the new space; cap off lines as necessary during construction. If any lines discovered

plan layout; save any items as per owners' request, dispose of all others.

cannot be moved/re-routed easily, notify architect to review solutions.

REVIEWED

Bundock/Johnson Residence

Kitchen Renovation for:

7213 Maple Ave.

Takoma Park, MD 20912

ELECTRICAL & LIGHTING LEGEND

Indicates existing unit (light or outlet)

Duplex Outlet/new

Ac Duplex Outlet/new/above counter

GPCI Duplex Outlet/new/GFCI

AFCI Duplex Outlet/new/AFCI

Double Duplex Outlet

Duplex Floor Outlet

→ 240v Outlet

-\$-er Exhaust Fan Фън Exhaust Fan/Heat

Ф-вг/н/L Exhaust Fan/Heat/Light

🖒 🌣 Ceiling Fan

Or Ceiling Fan/Light

Pendant Light Fixture Recessed Light Fixture

Recessed Light Fixture/Existing

Ox/8 Recessed Light Fixture/Eyeball

On Surface Mounted Light Fixture Wall Mounted Light Fixture/Sconce

Light Fixture /Waterproof

Dual Flood Light Data/Telephone Jack

Coaxial/Cable TV

Audio Speaker

Switch/Dimmer

Three-way Switch

⊨== τ Track light

=== , "Plugmold" Power Strip === u/c Undercabinet Lights

Smoke & Carbon Monoxide Detectors

House/Site Information:

Block: 3

Address: 7213 Maple Ave., Takoma Park, MD 20912 Year built: 1898

Project Information:

Zoning: R-60

Outstanding Resource House in the Takoma Park Historic District. Renovate existing kitchen, replace and add new windows at rear wall; move rear door.

Residential Code Information:

All construction shall be in conformance with the International Residential Code (IRC), 2012 Edition, as Amended by Mont. Co., ER 8-12.

AREA CALCULATIONS


EXISTING:

Lot Area: 12,705 s.f. Lot Coverage/Building Area 2338 s.f. % of Lot Coverage: 18.4%

PROPOSED:

Lot Coverage/Building Area (net gain, interior space):

0 s.f.

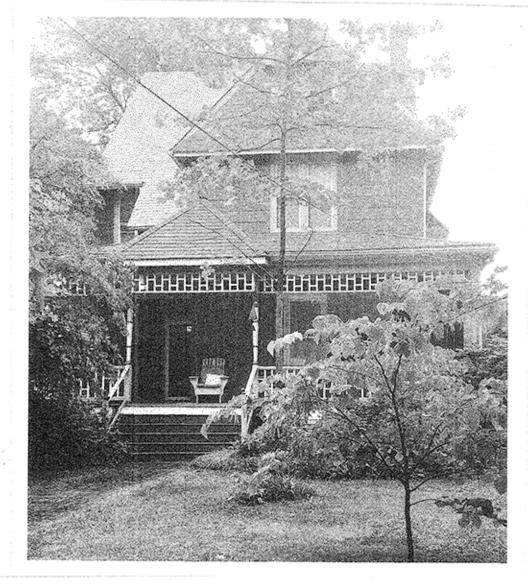

GENERAL CONSTRUCTION NOTES:

This is only a renovation of an existing space; appliances and fixtures will be

replaced in kind. No new plumbing fixtures are being added.

methods are to be determined by contractor. The contractor shall fully acquaint him/herself with the conditions relating to construction and labor so that he/sh understands the issues relating to the execution of the work

3. Contractor shall provide all materials, labor and equipment and pay all freight charges, taxes, and handling of materials necessary for the full implementation of the work herein described on these drawings unless noted otherwise

4. Contractor to verify all dimensions and assumed conditions in the field; bring any discrepancies, omissions, ambiguities or conflicts to the attention of the architect and owner as soon as possible before proceeding with any of this work in question. any other relevant item) that are revealed by demolition and are scheduled to be

removed or re-routed for the new plan are determined to be not easily moved. o 6. Contractor to notify architect and/or structural engineer if any existing wood joists,

sheathing, studs, etc. are damaged or deteriorated from termites, water, etc.

code modification approval is granted. 8. The owner's written authorization will be required before any work is executed or materials ordered that involve a change from the original specifications affecting the

9. All plan dimensions on drawings are set to edge of framing members; all finishes are not taken into account unless otherwise noted. If dimension is taken to a finish surface, it shall be noted as "FINISH DIMENSION", "FIN. DIM.", or "CLEAR DIM."

10. Solid blocking required under posts or any bearing from above to solid bearing below; match bearing area of post above to bearing below; cut bearing blocks to minimum 1/16" deeper than joists.

11. Install solid blocking in walls for receipt of plumbing fixtures, accessories (towel bars, toilet paper holders, etc.), hardware, cabinets, etc., as necessary; verify rough-in dimensions for plumbing fixtures prior to framing of posts, studs, beams and joists. 12. All wood in contact with masonry/concrete surfaces shall be pressure-treated; install

13. New doors, windows and hardware, are to be provided and installed by contractor; verify window and door manufacturers' rough opening dimensions prior to framing. 14. In all newly exposed existing 2 x 4 furring or walls at exterior, insert insulation in any

combination of closed cell foam/rockwool/batts for R-13, minimum. 15. If house-wrap and or building paper is used, apply and lap in a shingle-fashion so that upper courses lap over lower courses; any window and door flashing is integrated into this system in the same manner. Apply Z-flashing at all heads and apply pan flashing at all sills.

16. All new or existing wall surfaces are to be prepared for painting to be smooth and free of cracks, peeling paint, etc.; walls to be primed and painted (2 coats, min.) with color to be selected by owner.

17. Install new interconnected AC-powered smoke and CO detectors as per drawings and per code, as necessary 18. All electrical outlets in bath, kitchen (except refrigerator) and at exterior to be

ground fault circuit interrupters (GFCI); in all rooms (except kitchens), all-fault circuit interrupters (AFCI) to be installed. 19. Upgrade electrical service as necessary to provide sufficient power for new fixtures,

20. Electrical switches (dimmers, toggles, etc.), and telephone/modem to be approved by owner, installed by contractor. All decorative light fixtures to be selected by owner, installed by contractor.

Sheet No. Sheet Title


Cover Project Description / General Notes 1st Floor Demolition Plan (1/4"=1'-0")/ Demolition Notes / Electrical & Lighting Legend


A-1 First Floor Plan (1/4"=1'-0")/ Kitchen Elevations (3/8"=1'-0")

Window & Door Schedule Exterior Elevations/Rear (1/4"=1'-0")/ Window Head/Sill Detail (3"=1'-0")

First Floor Framing Plan (1/4"=1'-0")/ Second Floor Framing Plan (1/4"=1'-0") Roof Framing Plan (1/4"=1'-0")

COVER

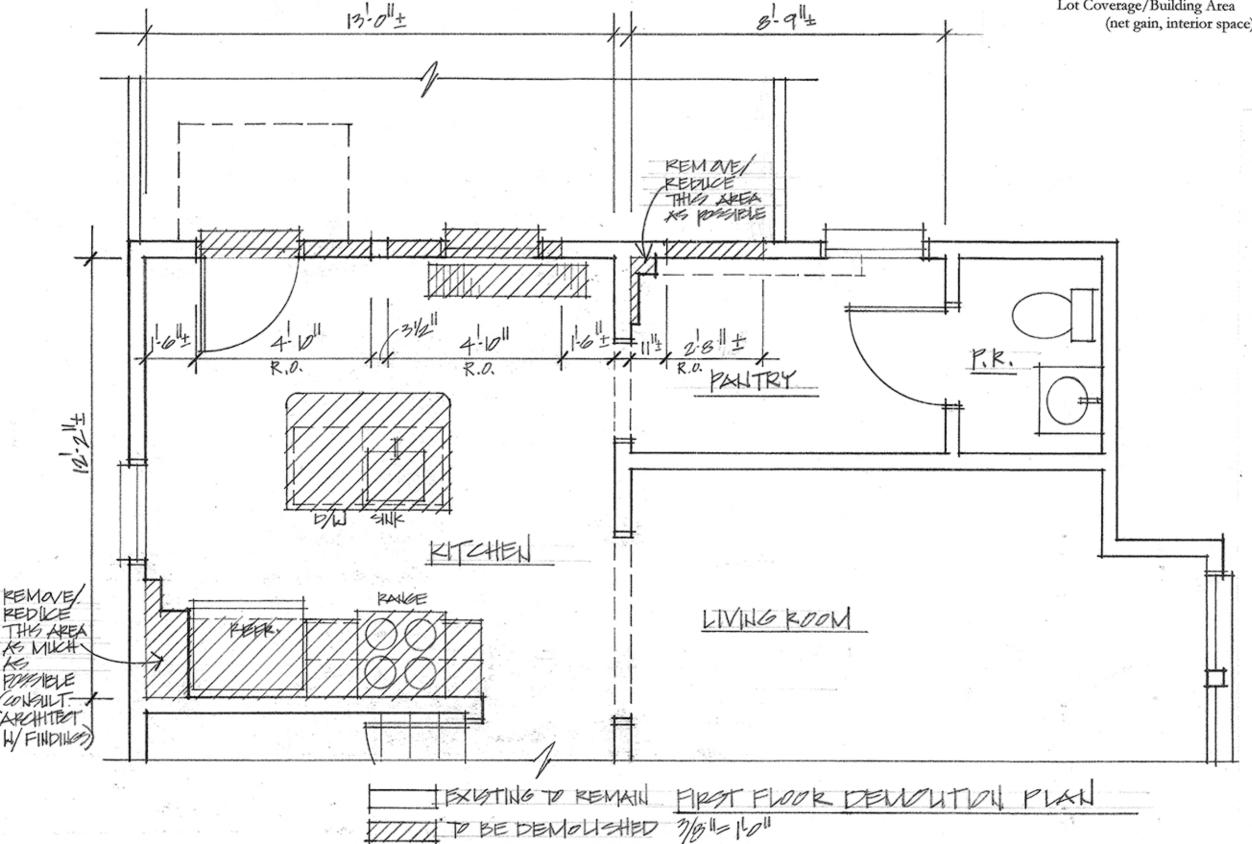

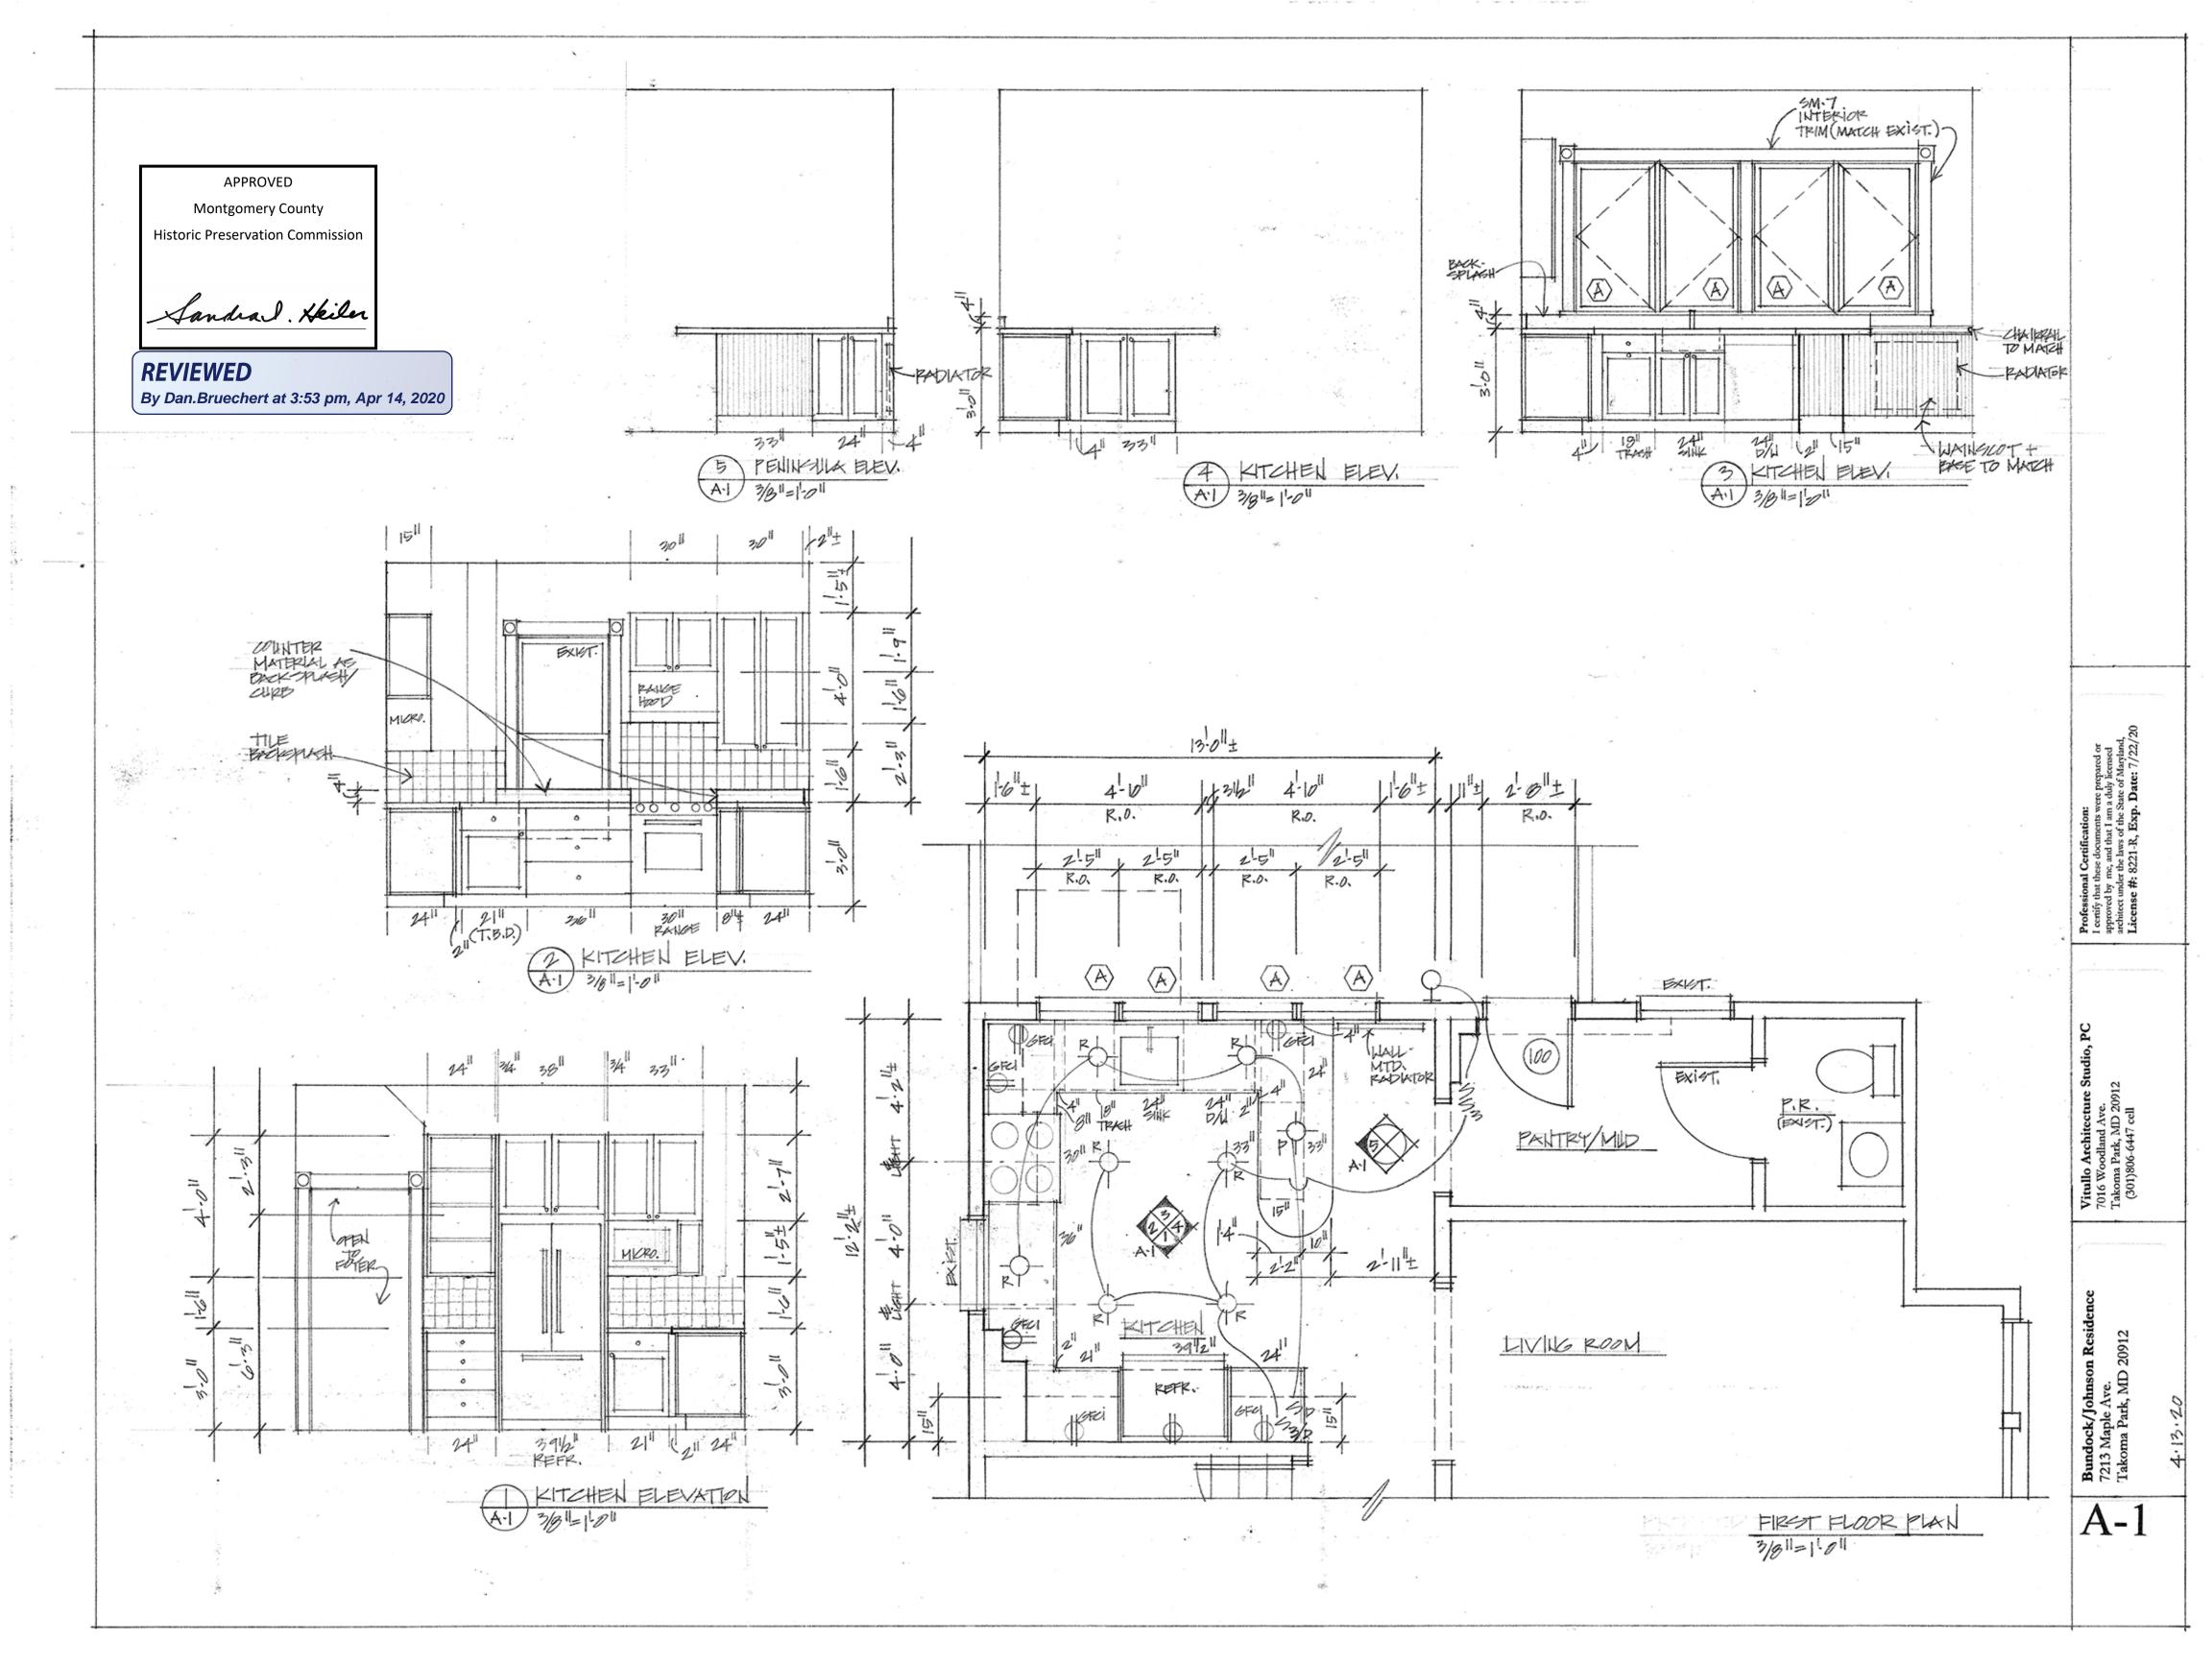

APPROVED

Montgomery County


Historic Preservation Commission


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REVIEWED

By Dan.Bruechert at 3:53 pm, Apr 14, 2020

WINDOW SCHEDULE						Manufacturer- Windows: Marvin/ Velux										
No.	Mfr. No.	Height, Unit (R.O.)	Width, Unit (R.O.)	Jamb Depth	Window Type/Material	Glazing Type	Grille Structure	Mullion Divisions	Screens / Screen Door	Hardware	Overall Glass Size (Total s.f.)	SHGC- value Total Unit	U-value Total Unit	Egress window	Quant.	Remarks
А	WUCA 2854	4'-6 1/16" (4'-6 9/16" R.O.)	2'-4" (2'-5" R.O.)	4 1/2"	CASEMENT /Wood interior & Wood exterior	Insulating glass Low E II w/ Argon/ TEMPERED		NONE	YES	Satin Taupe (Std.)	9.5 s.f. (38.0 s.f.)	0.25	0.29	no	4	Operable: 2 left hinged & 2 right hinged
SUBTOTAL												0.25 avg.	0.29 avg.		4 units	
	DOOR SCHEDULE				Manufacturer- Doors: Marvin/ TBD											
No.	Mfr. No.	Height, Unit (R.O.)	Width, Unit (R.O.)	Jamb Depth	Door Type / Material	Glazing Type	Grille Structure	Mullion Divisions	Screens / Screen Door	Exterior Color	Overall Opening Size (Glass s.f.)	SHGC-value Total Unit	U-value Total Unit	Swing direction (shown from outdside room)	Quant.	
100	TBD	7'-0'' +/-	2'-8" +/-	4 1/2"	WOOD INSWING DOOR	Insulating glass Low E II w/ Argon/ TEMPERED		4-lites (see elevation)	TBD	n/a	6 s.f.	0.24	0.31	Hinged Left, from outside	1	Exterior Door
SUBTOTALS												0.24 avg.	0.31 avg.		1 units	
TOTALS												0.25 avg.	0.30 avg.		5 units	



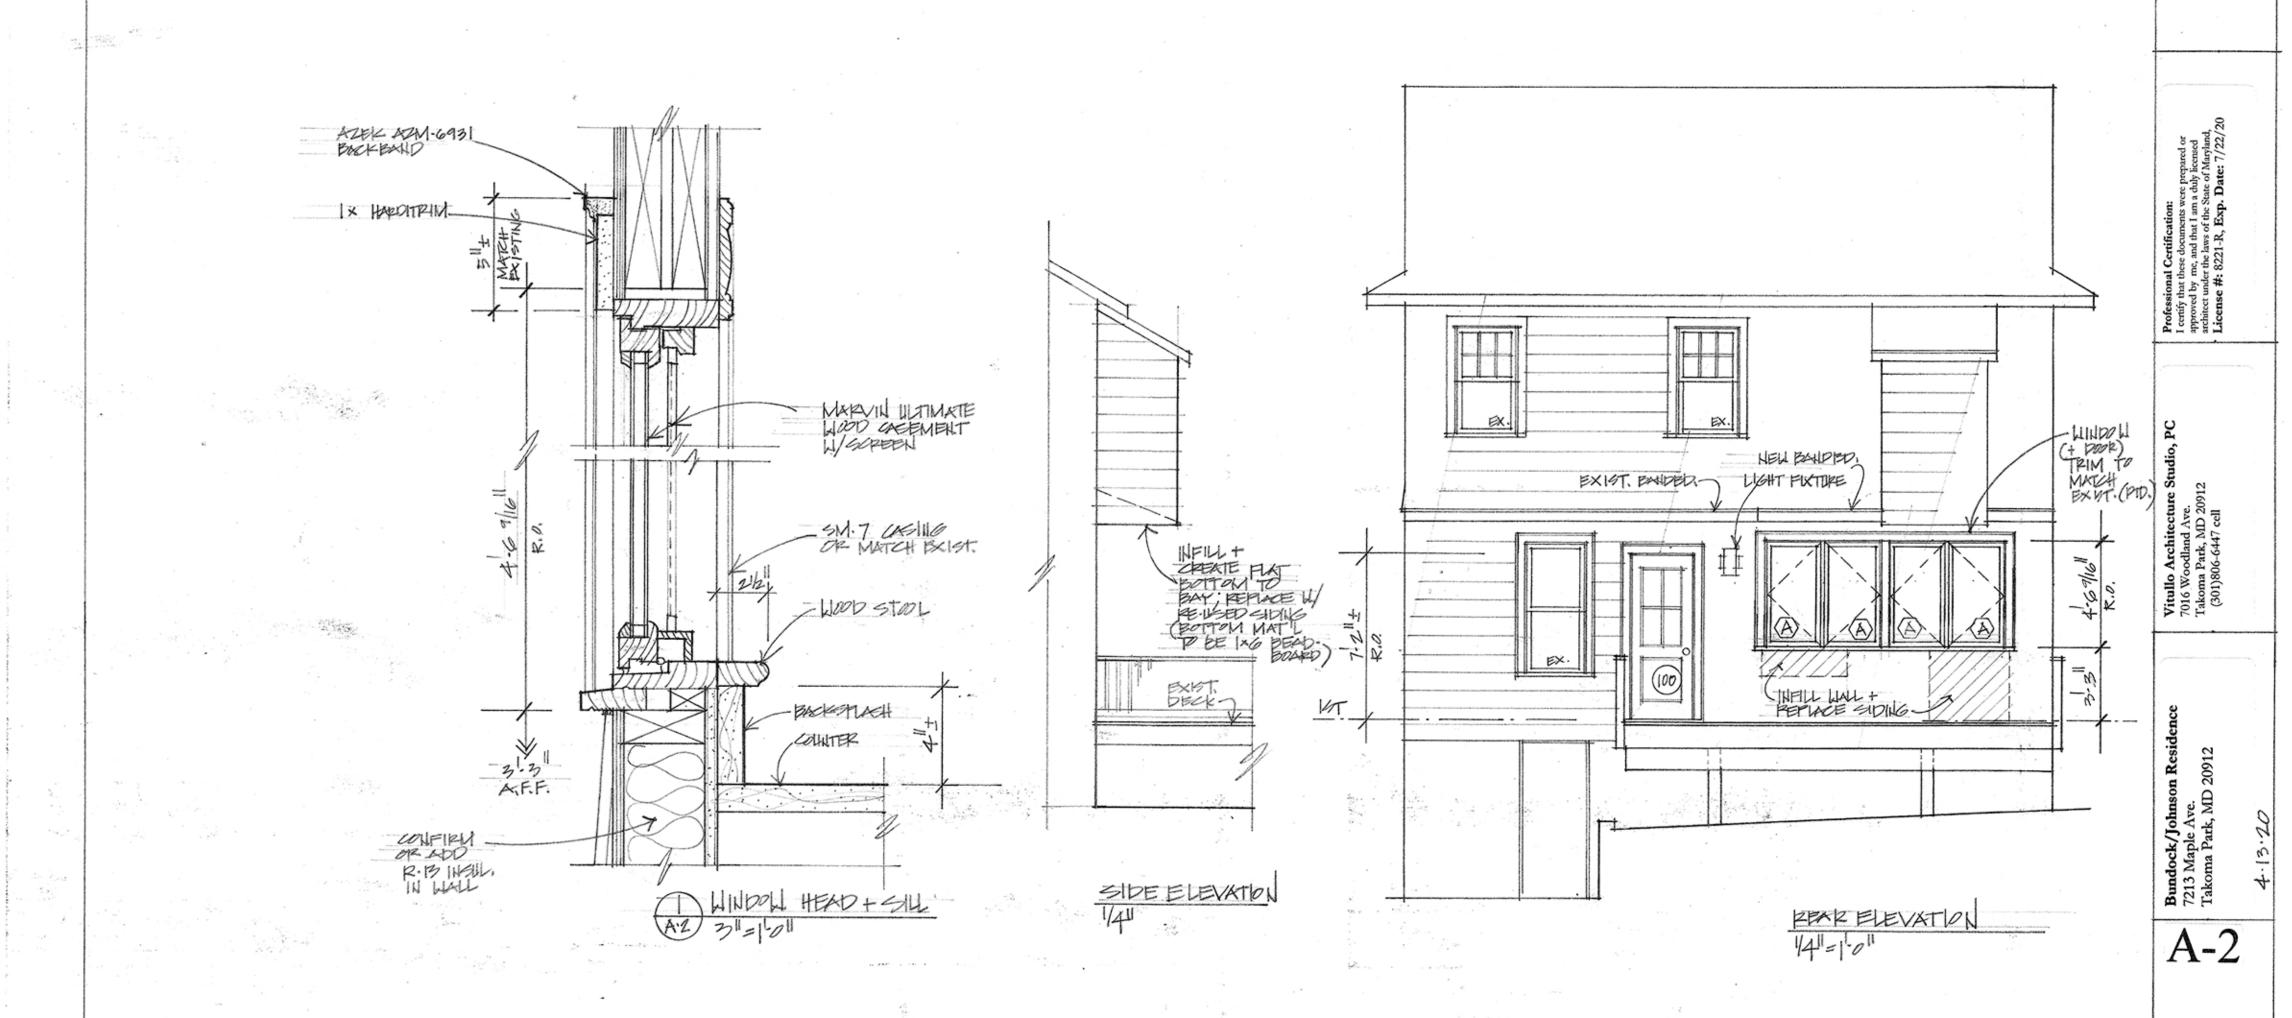

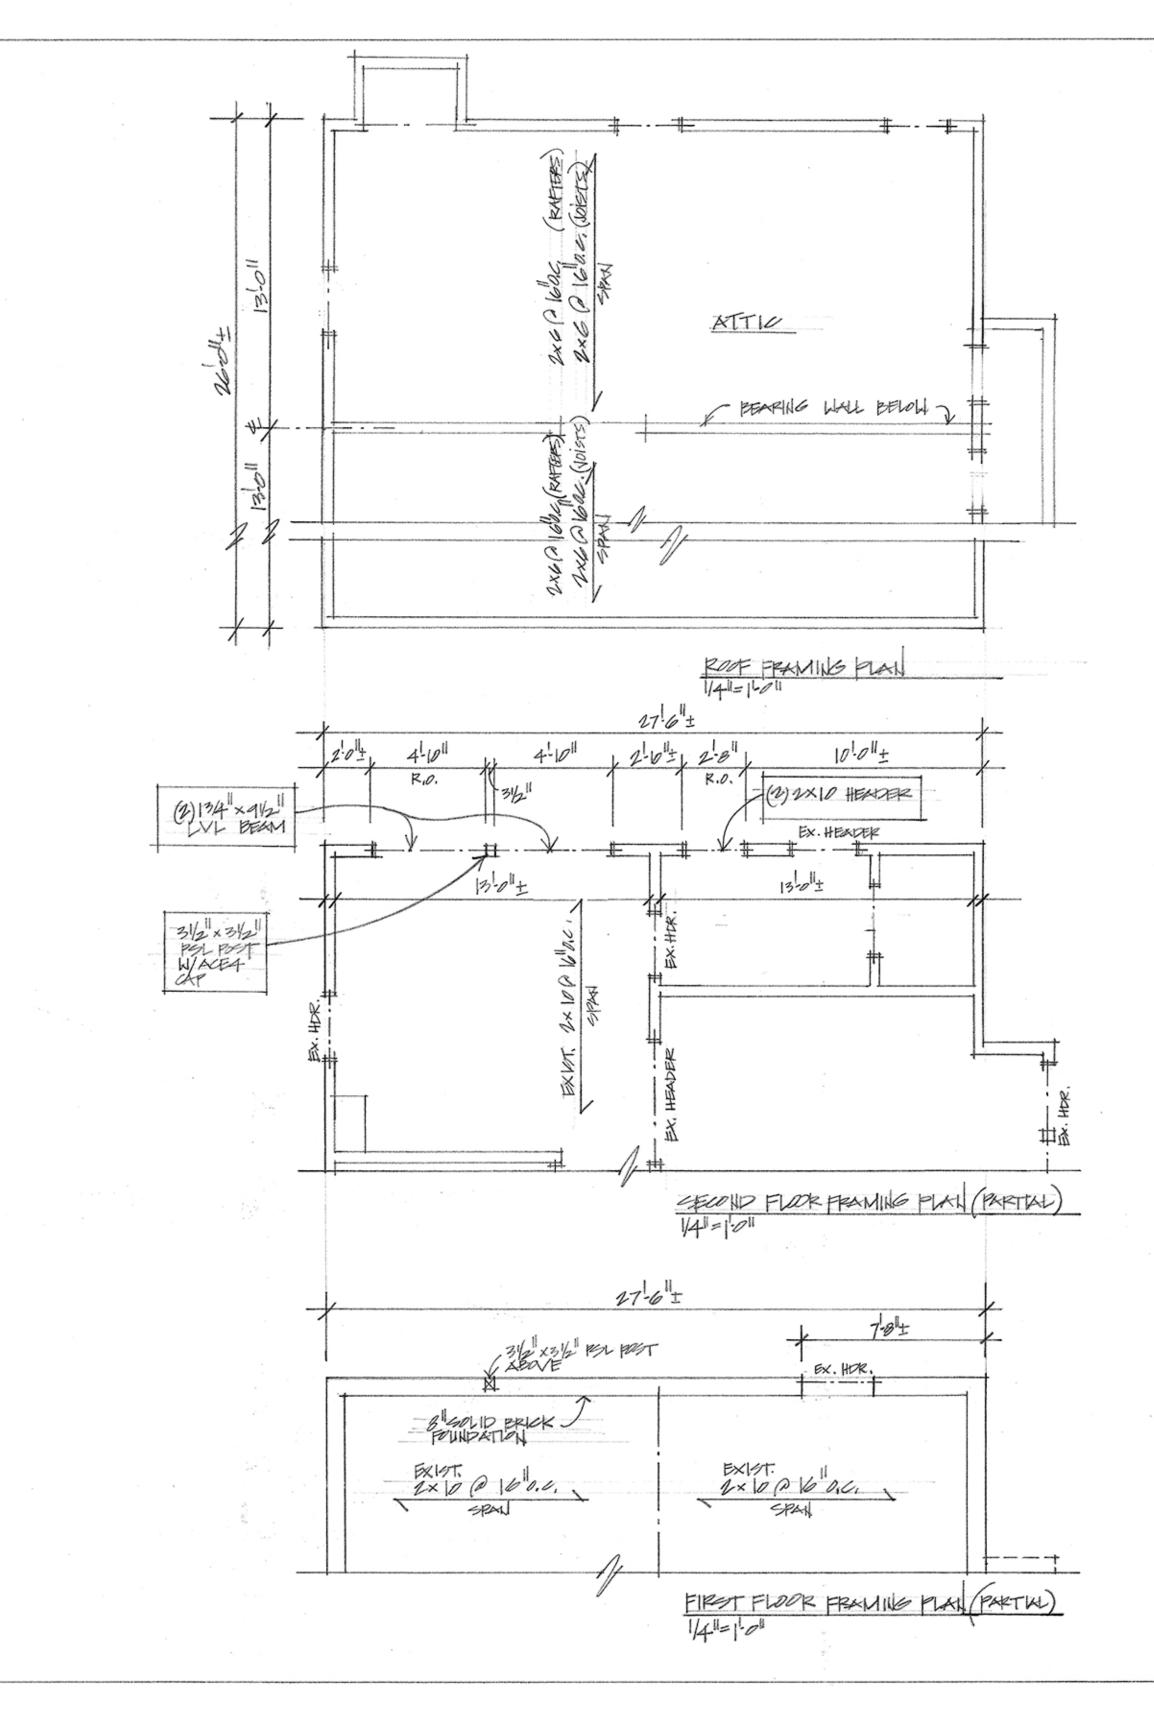APPROVED

Montgomery County

Historic Preservation Commission

REVIEWED

By Dan.Bruechert at 3:52 pm, Apr 14, 2020

Professional Certification:
I certify that these documents were prepared or approved by me, and that I am a duly licensed architect under the laws of the State of Maryland,
License #: 8221-R, Exp. Date: 7/22/20

Vitullo Architecture Studio, PC 7016 Woodland Ave. Takoma Park, MD 20912 (301)806-6447 cell

> Bundock/Johnson Residence 7213 Maple Ave. Takoma Park, MD 20912

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