

HISTORIC PRESERVATION COMMISSION

Marc Elrich County Executive Robert K. Sutton Chairman

Date: May 27, 2021

MEMORANDUM

TO:	Mitra Pedoeem
	Department of Permitting Services
FROM:	Dan Bruechert
	Historic Preservation Section
	Maryland-National Capital Park & Planning Commission
SUBJECT:	Historic Area Work Permit # 951380 - Dormer Addition, Rear Addition, and Other Alterations

The Montgomery County Historic Preservation Commission (HPC) has reviewed the attached application for a Historic Area Work Permit (HAWP). This application was **approved** by the Historic Preservation Commission at the May 26, 2021 HPC meeting.

The HPC staff has reviewed and stamped the attached construction drawings.

THE BUILDING PERMIT FOR THIS PROJECT SHALL BE ISSUED CONDITIONAL UPON ADHERENCE TO THE ABOVE APPROVED HAWP CONDITIONS AND MAY REQUIRE APPROVAL BY DPS OR ANOTHER LOCAL OFFICE BEFORE WORK CAN BEGIN.

Applicant:William CurtainAddress:3 Primrose St., Chevy Chase

This HAWP approval is subject to the general condition that the applicant will obtain all other applicable Montgomery County or local government agency permits. After the issuance of these permits, the applicant must contact this Historic Preservation Office if any changes to the approved plan are made. Once work is complete the applicant will contact Dan Bruechert at 301.563.3400 or <u>dan.bruechert@montgomeryplanning.org</u> to schedule a follow-up site visit.





GENERAL NOTES

- 1. All Work shall be performed in accordance with the IRC 2012, and all other applicable codes, regulations and ordinances as adopted and/or modified by the District of Columbia DCMR 2013.
- 2. All Electrical work to be performed in accordance with the National Electrical Code and the District of Columbia code.
- Dimensions and Notes for a given condition are typical for all similar conditions unless otherwise stated.
- 4. Drawings at a larger scale shall take precedence over drawings of a smaller scale. Notify Architect immediately if a discrepancy should be found.
- 5. Existing walls, columns, floor/ceiling assemblies, etc. are shown unrendered on the plans and sections. Elevations show existing elements windows, doors, roofs, etc. as unrendered outline (new work is shown rendered).
- General Contractor to keep disturbances in existing house to a minimum.
 Protect existing planting during construction with erosion control type fence. Do not remove any trees or shrubs without prior approval of owner. Protect existing driveway from abuse, any damage should be repaired at the expense of the contractor. Provide conveniently located refuse barrels and maintain for workman use.
- 8. General Contractor to inspect existing electrical service and notify Owner and Architect if upgrading is required by code or with the proposed addition/ renovation.
- General Contractor to ensure flush transition from existing work to new work.
 All wall surfaces are to be made flush and smooth prior to painting or installation of wallcovering.
- Verify all measurements and dimensions prior to beginning and throughout progress of Work. Consult Architect for resolution of any discrepancy in measurements or dimensions.
- 12. Prior to cutting or drilling affecting structural members not indicated, submit written notice to Architect specifying location and requesting consent to proceed with cutting or drilling. Contractor shall do cutting and drilling of existing construction required for installation of new work, including cutting of holes for new electrical work. Cover openings temporarily when not in use and patch as soon as work is installed. Refinish all affected areas to their original condition.
- 13. Coordinate the unloading and safe storage of Owner delivered material on site (casework, equipment, etc.). Installation of Owner delivered material is to be included in the base bid (unless noted otherwise).

DEMOLITION NOTES

- 1. Coordinate removal of personal belongings or furnishings from affected areas with owner.
- 2. Protect all interior walls, doors, trim, ceilings, and floors from unnecessary damage during demolition.
- Phase all work to achieve minimum disturbance in work areas. Protect unaffected areas from dust, dirt and noise.
- Salvage equipment, fixtures, counters, cabinets and doors as required by the contract drawings. Reuse as directed on drawings.
- 5. All doors and windows to be salvaged for course of job. Those not reused should be removed by G.C. at end of job as directed by Owner. See door and window schedules for those salvaged and relocated.
- 6. Remove all miscellaneous protrusions in walls, floors, ceilings, windows and doors including, but not limited to nails, hooks, wires, door bells, etc. on first floor.
- 7. The Contractor shall arrange for the proper discontinuance and/or relocation of all public utilites when required, including sewers, water, gas, electric, television, and telephone lines.
- 8. Existing plumbing hook-ups to be shut off immediately prior to demolition work at each location.
- 9. Cap off all abandoned waste and supply lines below floor level, patch where necessary.
- 10. Brace structure as necessary during demolition to prevent structural damage and excessive movement. Protect the existing exterior walls, roof(s), and trim from damage during demolition.
- 11. Prior to cutting or drilling affecting structural members not indicated, submit written notice to Architect specifying location and requesting consent to proceed with cutting or drilling. Contractor shall do no cutting and drilling of existing construction required for installation of new work, including cutting of holes for new electrical work. Cover openings temporarily when not in use and patch as soon as work is installed. Refinish all affected areas to their original condition.
- 12. Contractor shall receive title to materials to be demolished, title shall vest to Contractor upon execution of the Contract. Owner will not be responsible for the condition, loss or damage to material after execution of Contract.
- 13. Debris shall not accumulate on site. Sale or burning of material on site is prohibited. Site and adjacent areas shall be kept clean and free from mud, dirt, and debris at all times.
- 14. Verify all measurements and dimensions prior to beginning and throughout progress of Work. Consult Architect for resolution of any discrepancy in measurements or dimensions.

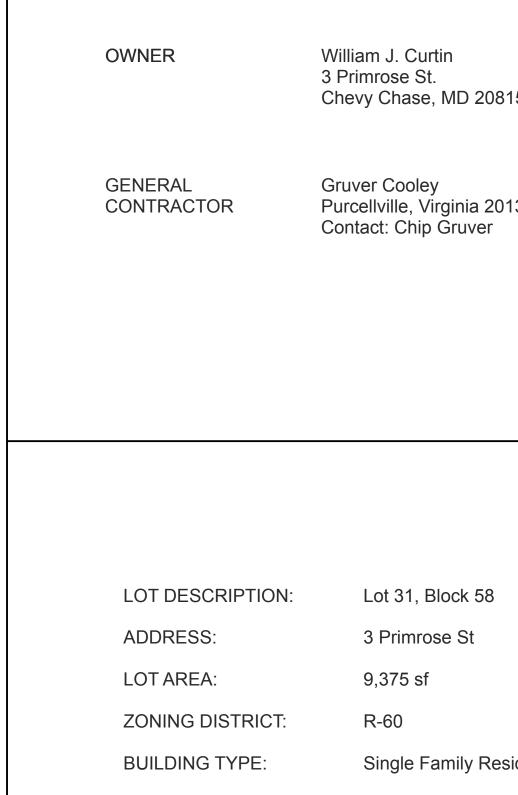

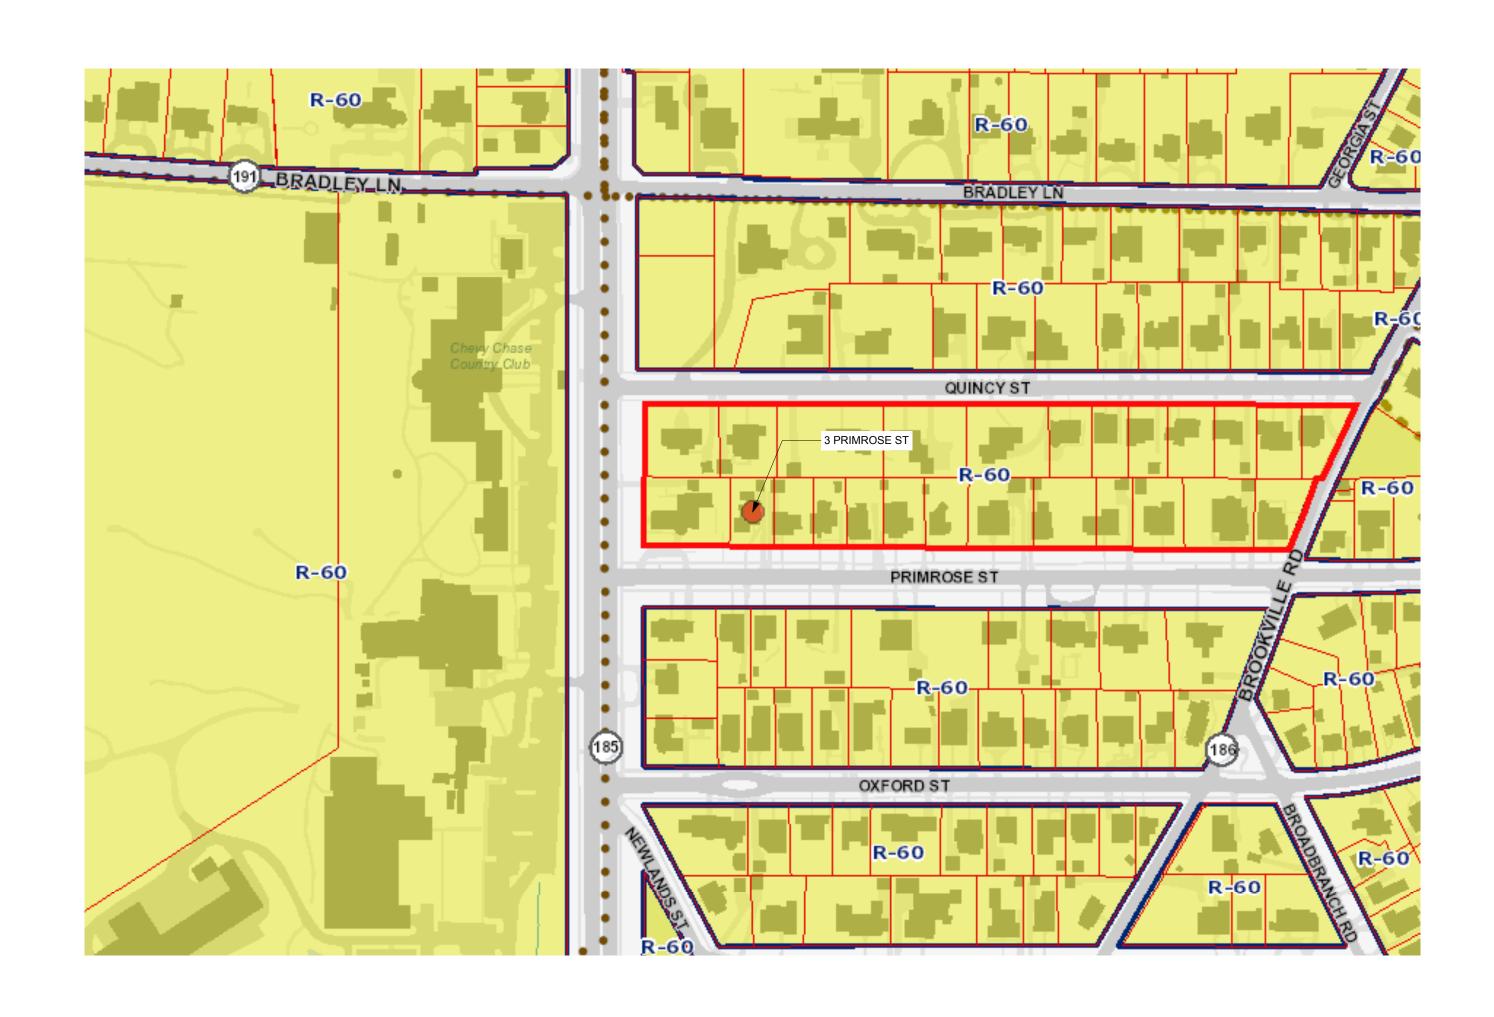

PROJECT TEAM

20815-4228		ARCHITECT	Outerbridge Horsey Associates, PLLC 1228 1/2 31st Street, NW Washington, DC 20007 Contact: Outerbridge Horsey, AIA John Cazayoux	Tel 202.33 oh@outerb john@oute
20134 er	Tel 703.669.5420	STRUCTURAL	Neubauer Consulting Engineers	Tel 301.26
	chip@gruvercooley.com	ENGINEER	4701 Sangamore Rd, # N290 Bethesda, Maryland 20816 Contact: Peter Neubauer	peter@neu

3	PRIMROSE ST.	

	CHEVY CHASE, MD 20815 ZONING CRITERIA	REQUIRED	PROVIDED	cor spe
	MIN. LOT WIDTH:	60 Ft.	75 Ft.	Wr
	MIN. LOT AREA:	6,000 Sf.	9,375 Sf.	Co
	MAX. LOT COVERAGE:	35%	27% Existing, 27.5% Proposed	dra
	MAX. HEIGHT:	35 Ft.	29'-5" Existing and Proposed	The
esidential	FRONT YARD SETBACK: SIDE YARD SETBACK: SUM OF SIDE SETBACKS. REAR YARD SETBACK: PERVIOUS SURFACES MIN:	25 Ft. 8 Ft. 18 Ft. 20 Ft. 20%	 23.75 Ft.(Existing) 11.5 Ft. East (Existing) 19.1 Ft. West (Existing) 25.6 Ft. (Existing) 25.25 Ft. Approx. (Existing) 58% Existing and Proposed 	dise any with cor The cer

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erbridgehorsey.com Iterbridgehorsey.com

263.2727

eubauerengineers.com

SPECIAL NOTE

Existing conditions shown or implied are based on best available but limited information. If conditions are encountered that differ from those shown, noted or implied, all work in that specific area is to stop and the Architect is to be notified. No work is to continue in such areas without the permission of the Architect.

Written dimensions on these drawings shall have precedence over scaled dimensions. Contractors shall verify, and be responsible for all dimensions and conditions on the job and the Architect must be notified of any variation from the dimensions and conditions shown by these drawings.

The above drawings and specifications and the ideas, designs and arrangements represented thereby are, and shall remain the property of the architect. No part thereof shall be copied, disclosed to others, or used in connection with any other work or project by any other person for any purpose other than for the specific project for which they have been prepared and developed without the written consent of the architect. Visual contact with these drawings shall constitute conclusive evidence of acceptance of these restrictions.

The professional seal is for certification of new work only and is not intended for general certification of preexisting conditions.

LIST OF DRAWINGS

SHEET	TITLE
G001	COVER SHEET
Z100	ZONING/ SOIL AND EROSION PLAN
D100	EXISTING CONDITIONS PLANS
D200	EXISTING SOUTH AND WEST ELEVATIONS
D201	EXISTING NORTH AND EAST ELEVATIONS
A100	FIRST AND SECOND FLOOR PLANS
A101	ROOF PLAN
A200	SOUTH AND WEST ELEVATIONS
A201	NORTH AND EAST ELEVATIONS
A300	BUILDING SECTIONS
A400	WALL SECTIONS
A503	MUDROOM PLAN AND ELEVATIONS / DETAILS
S100	STRUCTURAL PLANS
E100	ELECTRICAL PLANS

APPROVED Montgomery County Historic Preservation Commission


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REVIEWED By Dan.Bruechert at 2:34 pm, May 27, 2021

OUTERBRIDGE HORSEY ASSOCIATES, PLLC

1228 ¹/₂ 31st STREET, NW WASHINGTON, DC 20007 TEL 202-337-7334 FAX 202-337-7331 www.outerbridgehorsey.com

CONSULTANTS:

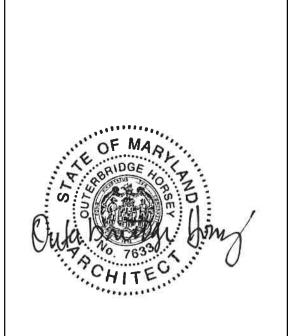

3 PRIMROSE S	Г

CHEVY CHASE, MD 20815

DRAWING TITLE:



SCALE: AS NOTED

ISSUE	DATE

PRINT DATE 5/3/21

SHEET NO.

G001

LOT DESCRIPTION:	Lot 31, Block 58
ADDRESS:	3 Primrose St
LOT AREA:	9,375 sf
ZONING DISTRICT:	R-60
BUILDING TYPE:	Single Family Res
ZONING CRITERIA	REQUIR
MIN. LOT WIDTH:	60 Ft.

MIN. LOT AREA:

MAX. HEIGHT:

MAX. LOT COVERAGE:

FRONT YARD SETBACK:

SUM OF SIDE SETBACKS.

PERVIOUS SURFACES MIN:

REAR YARD SETBACK:

SIDE YARD SETBACK:

Residential UIRED 60 Ft. 6,000 Sf. 35% 35 Ft.

25 Ft.

18 Ft. 20 Ft.

20%

8 Ft.

PROVIDED


75 Ft.


9,375 Sf.


27% Existing, 27.5% Proposed


29'-5" Existing and Proposed


23.75 Ft.(Existing) 11.5 Ft. East (Existing) 19.1 Ft. West (Existing) 25.6 Ft. (Existing) 25.25 Ft. Approx. (Existing) 58% Existing and Proposed

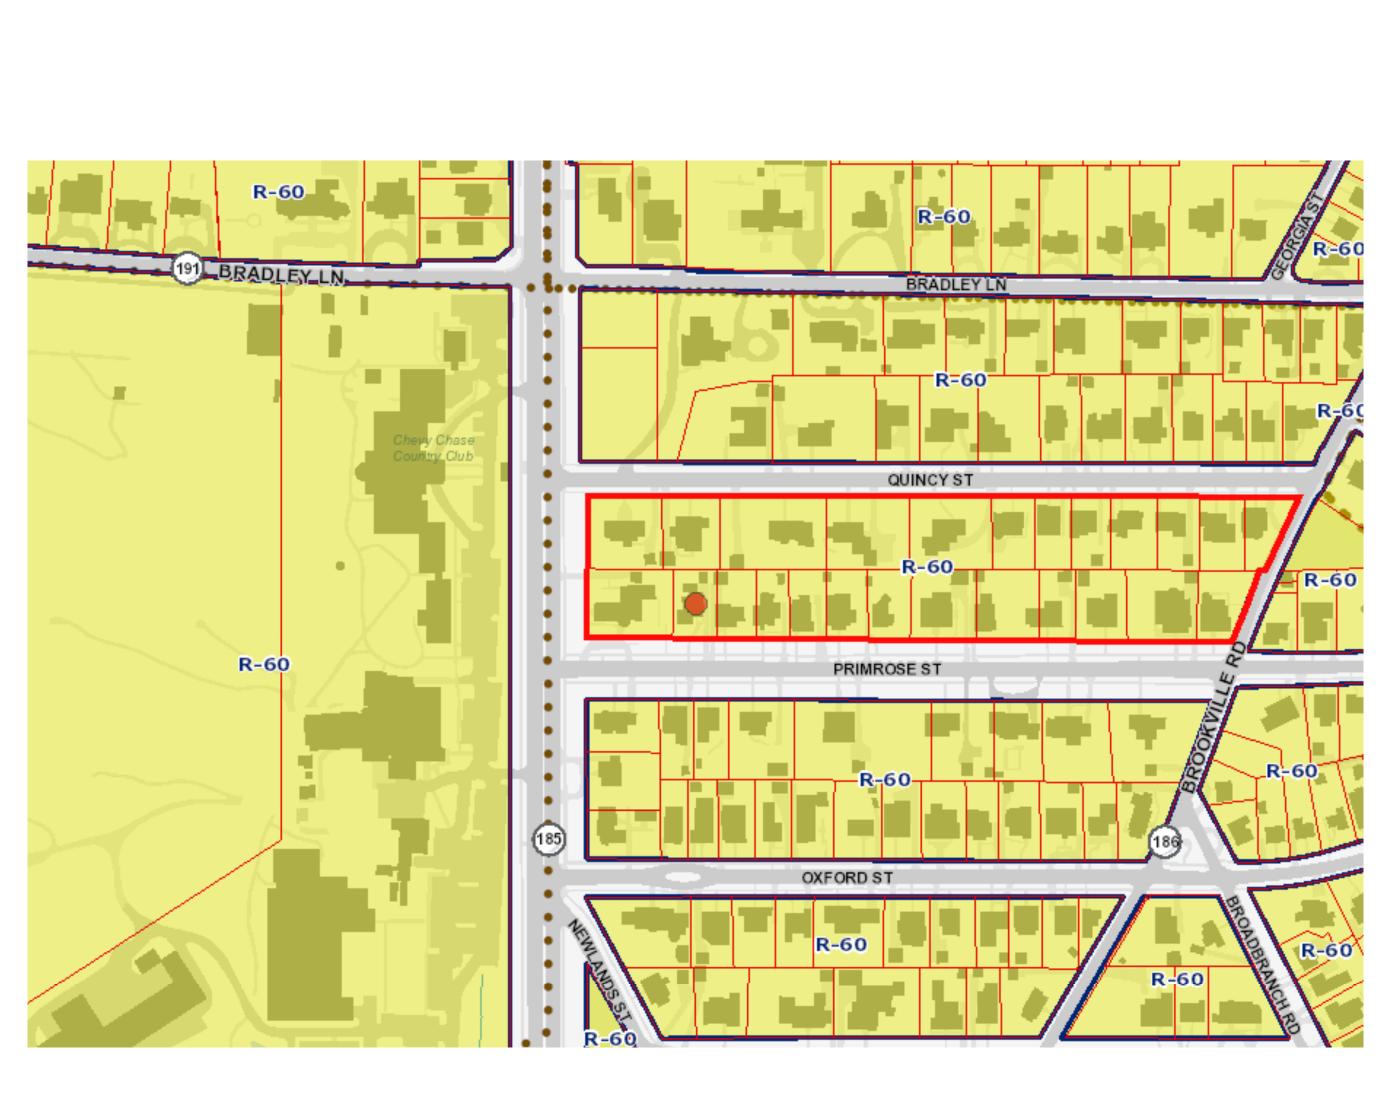

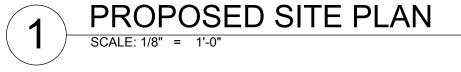

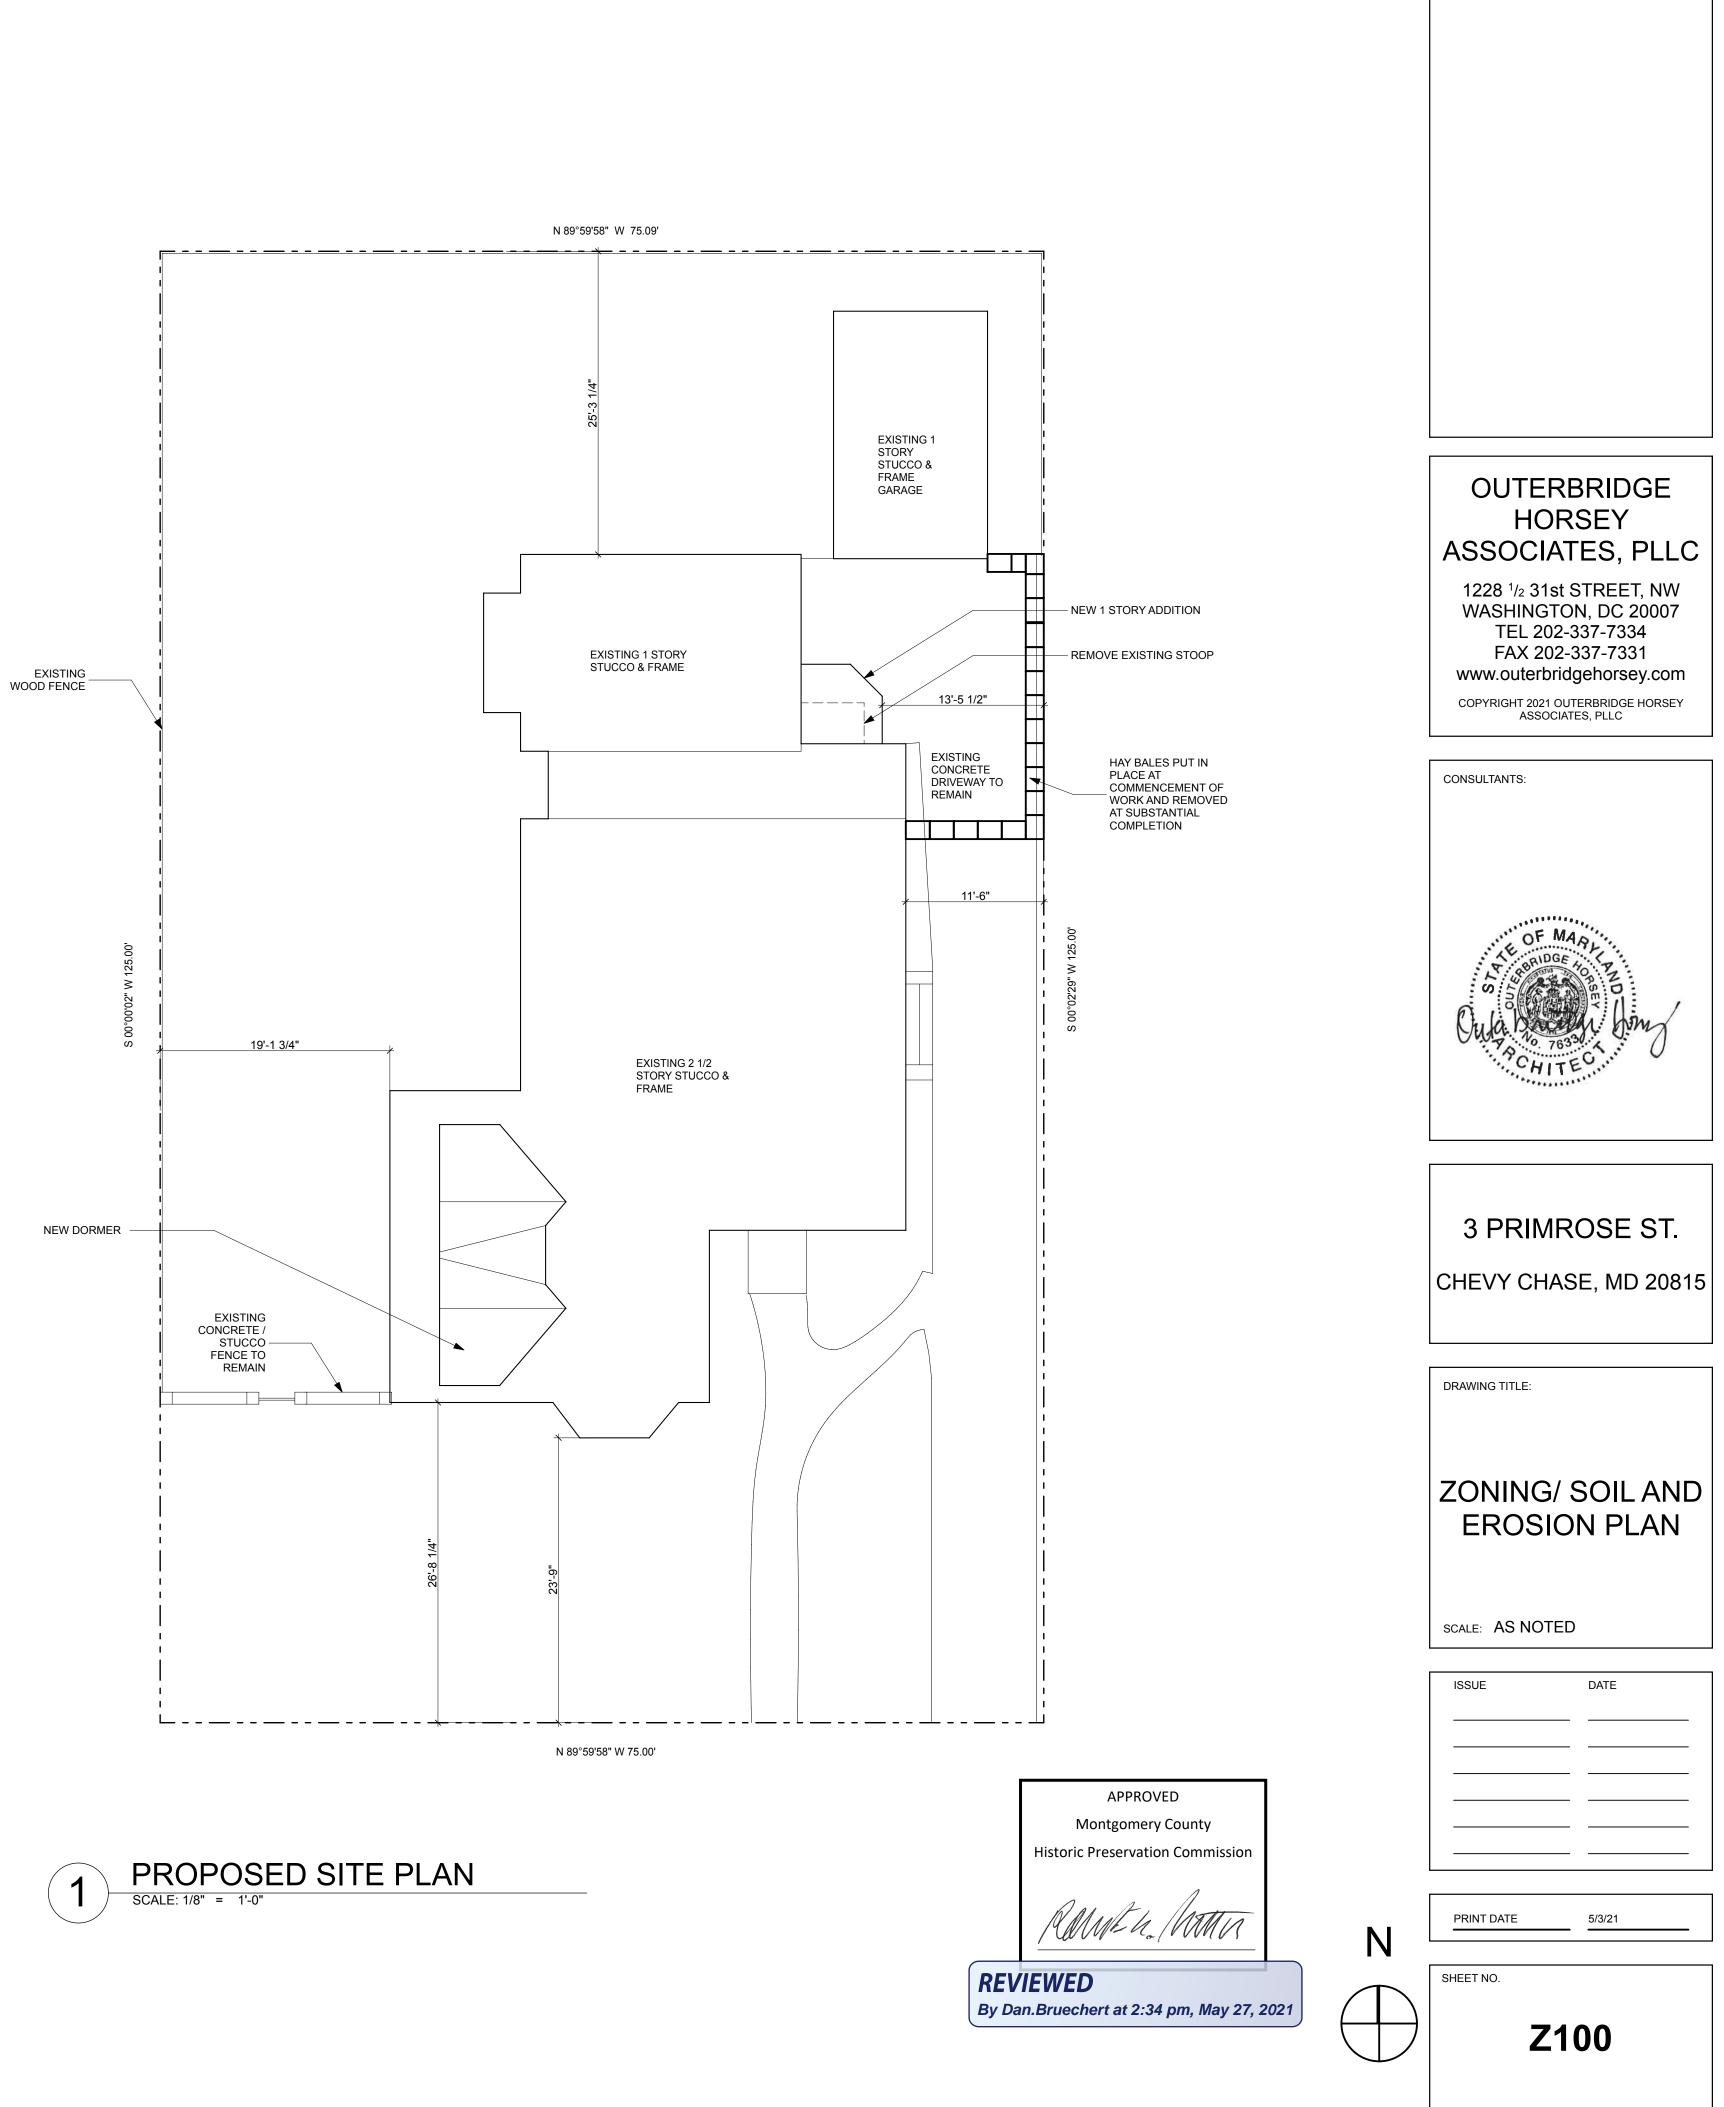

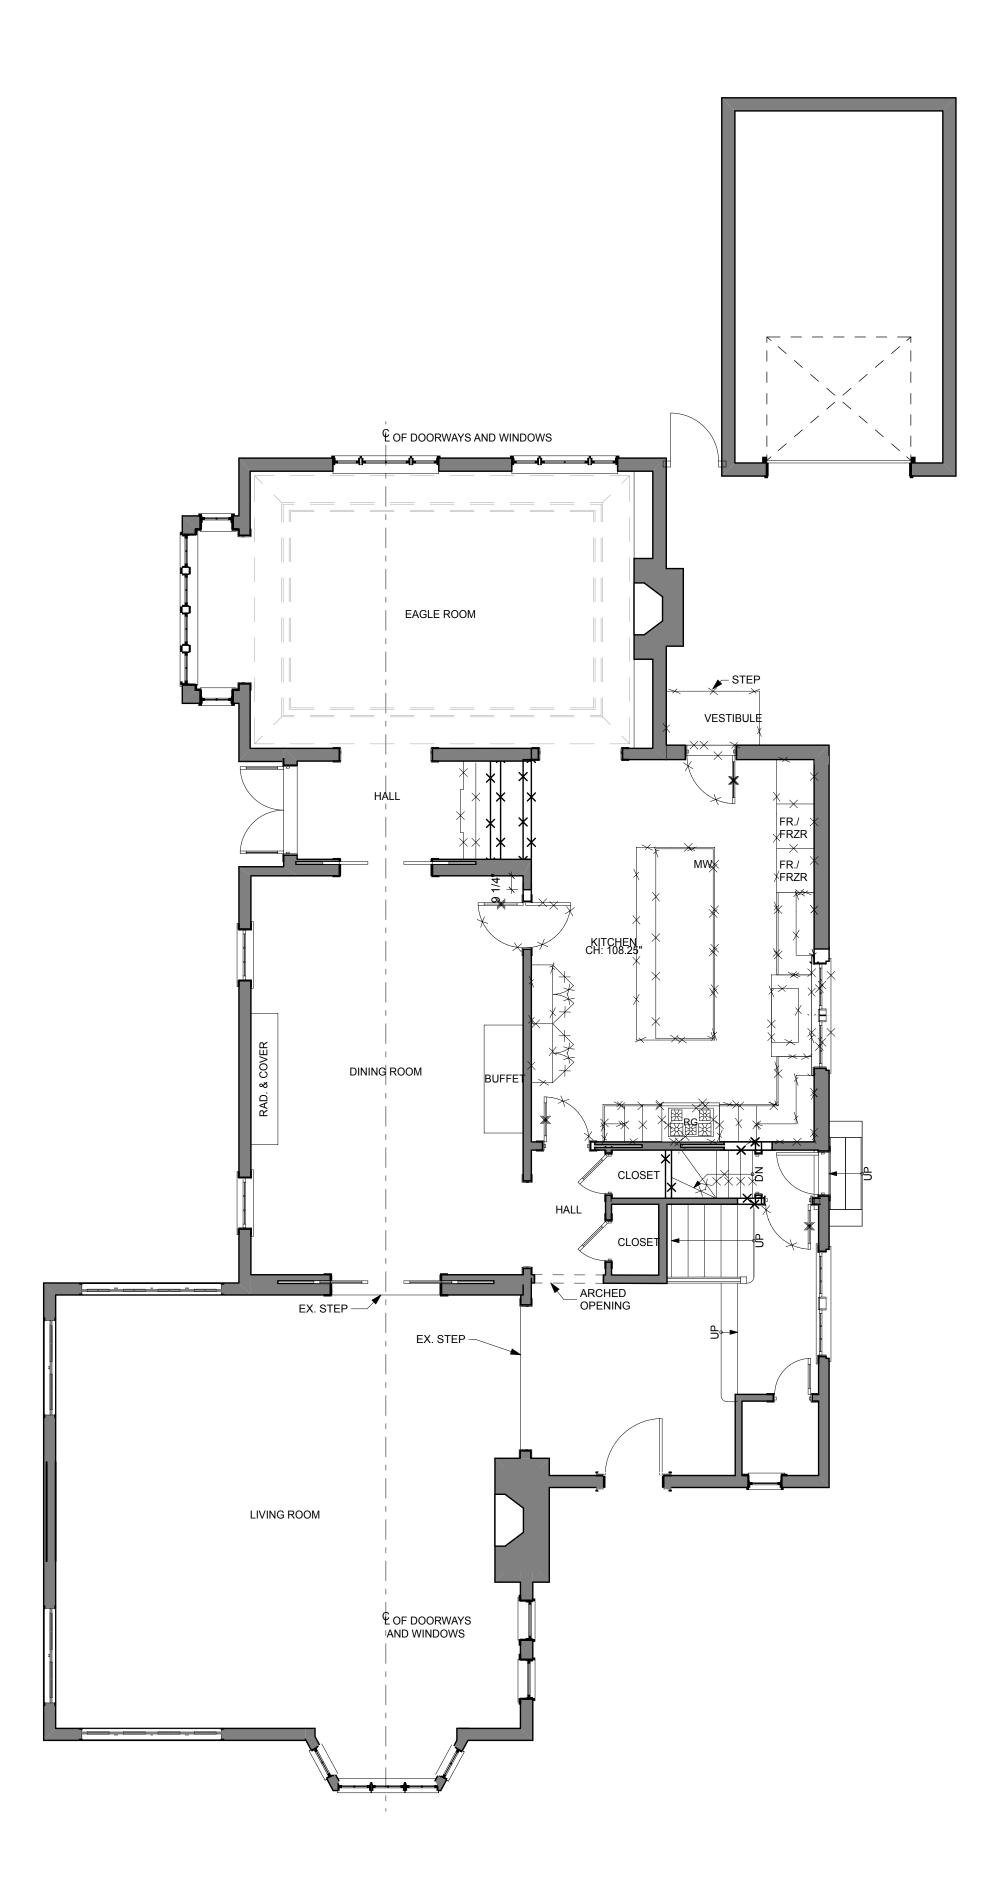

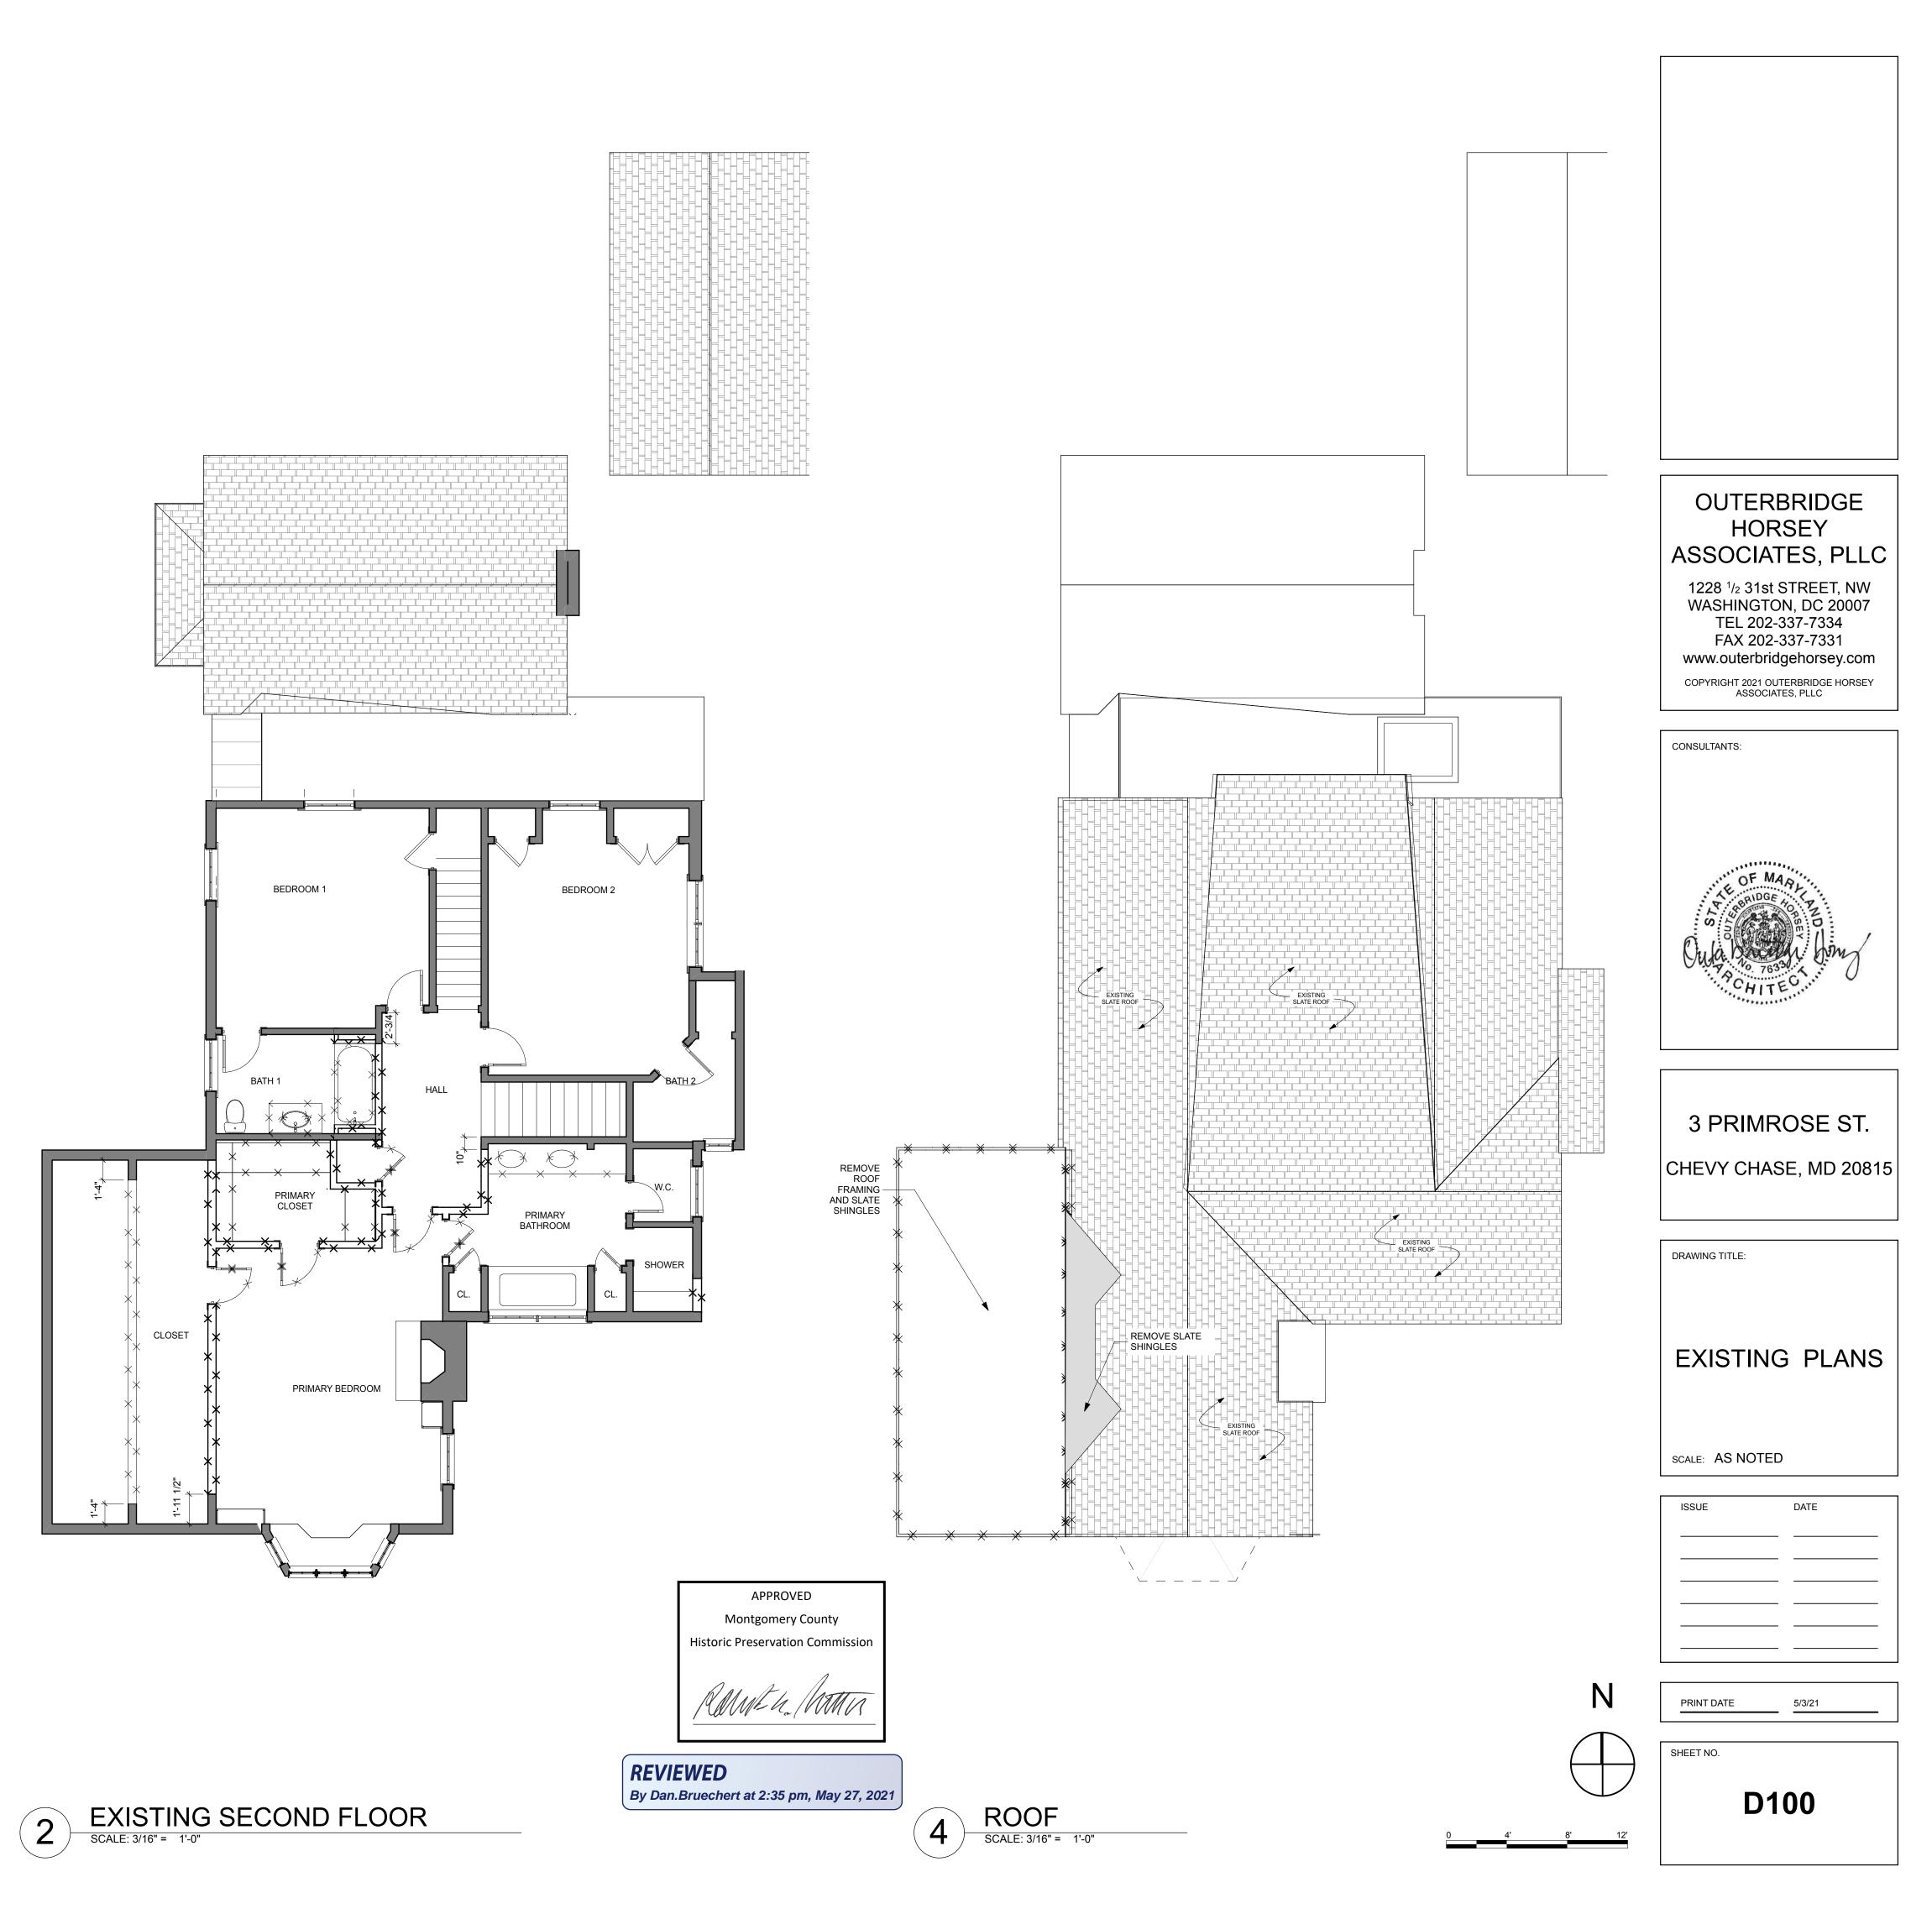




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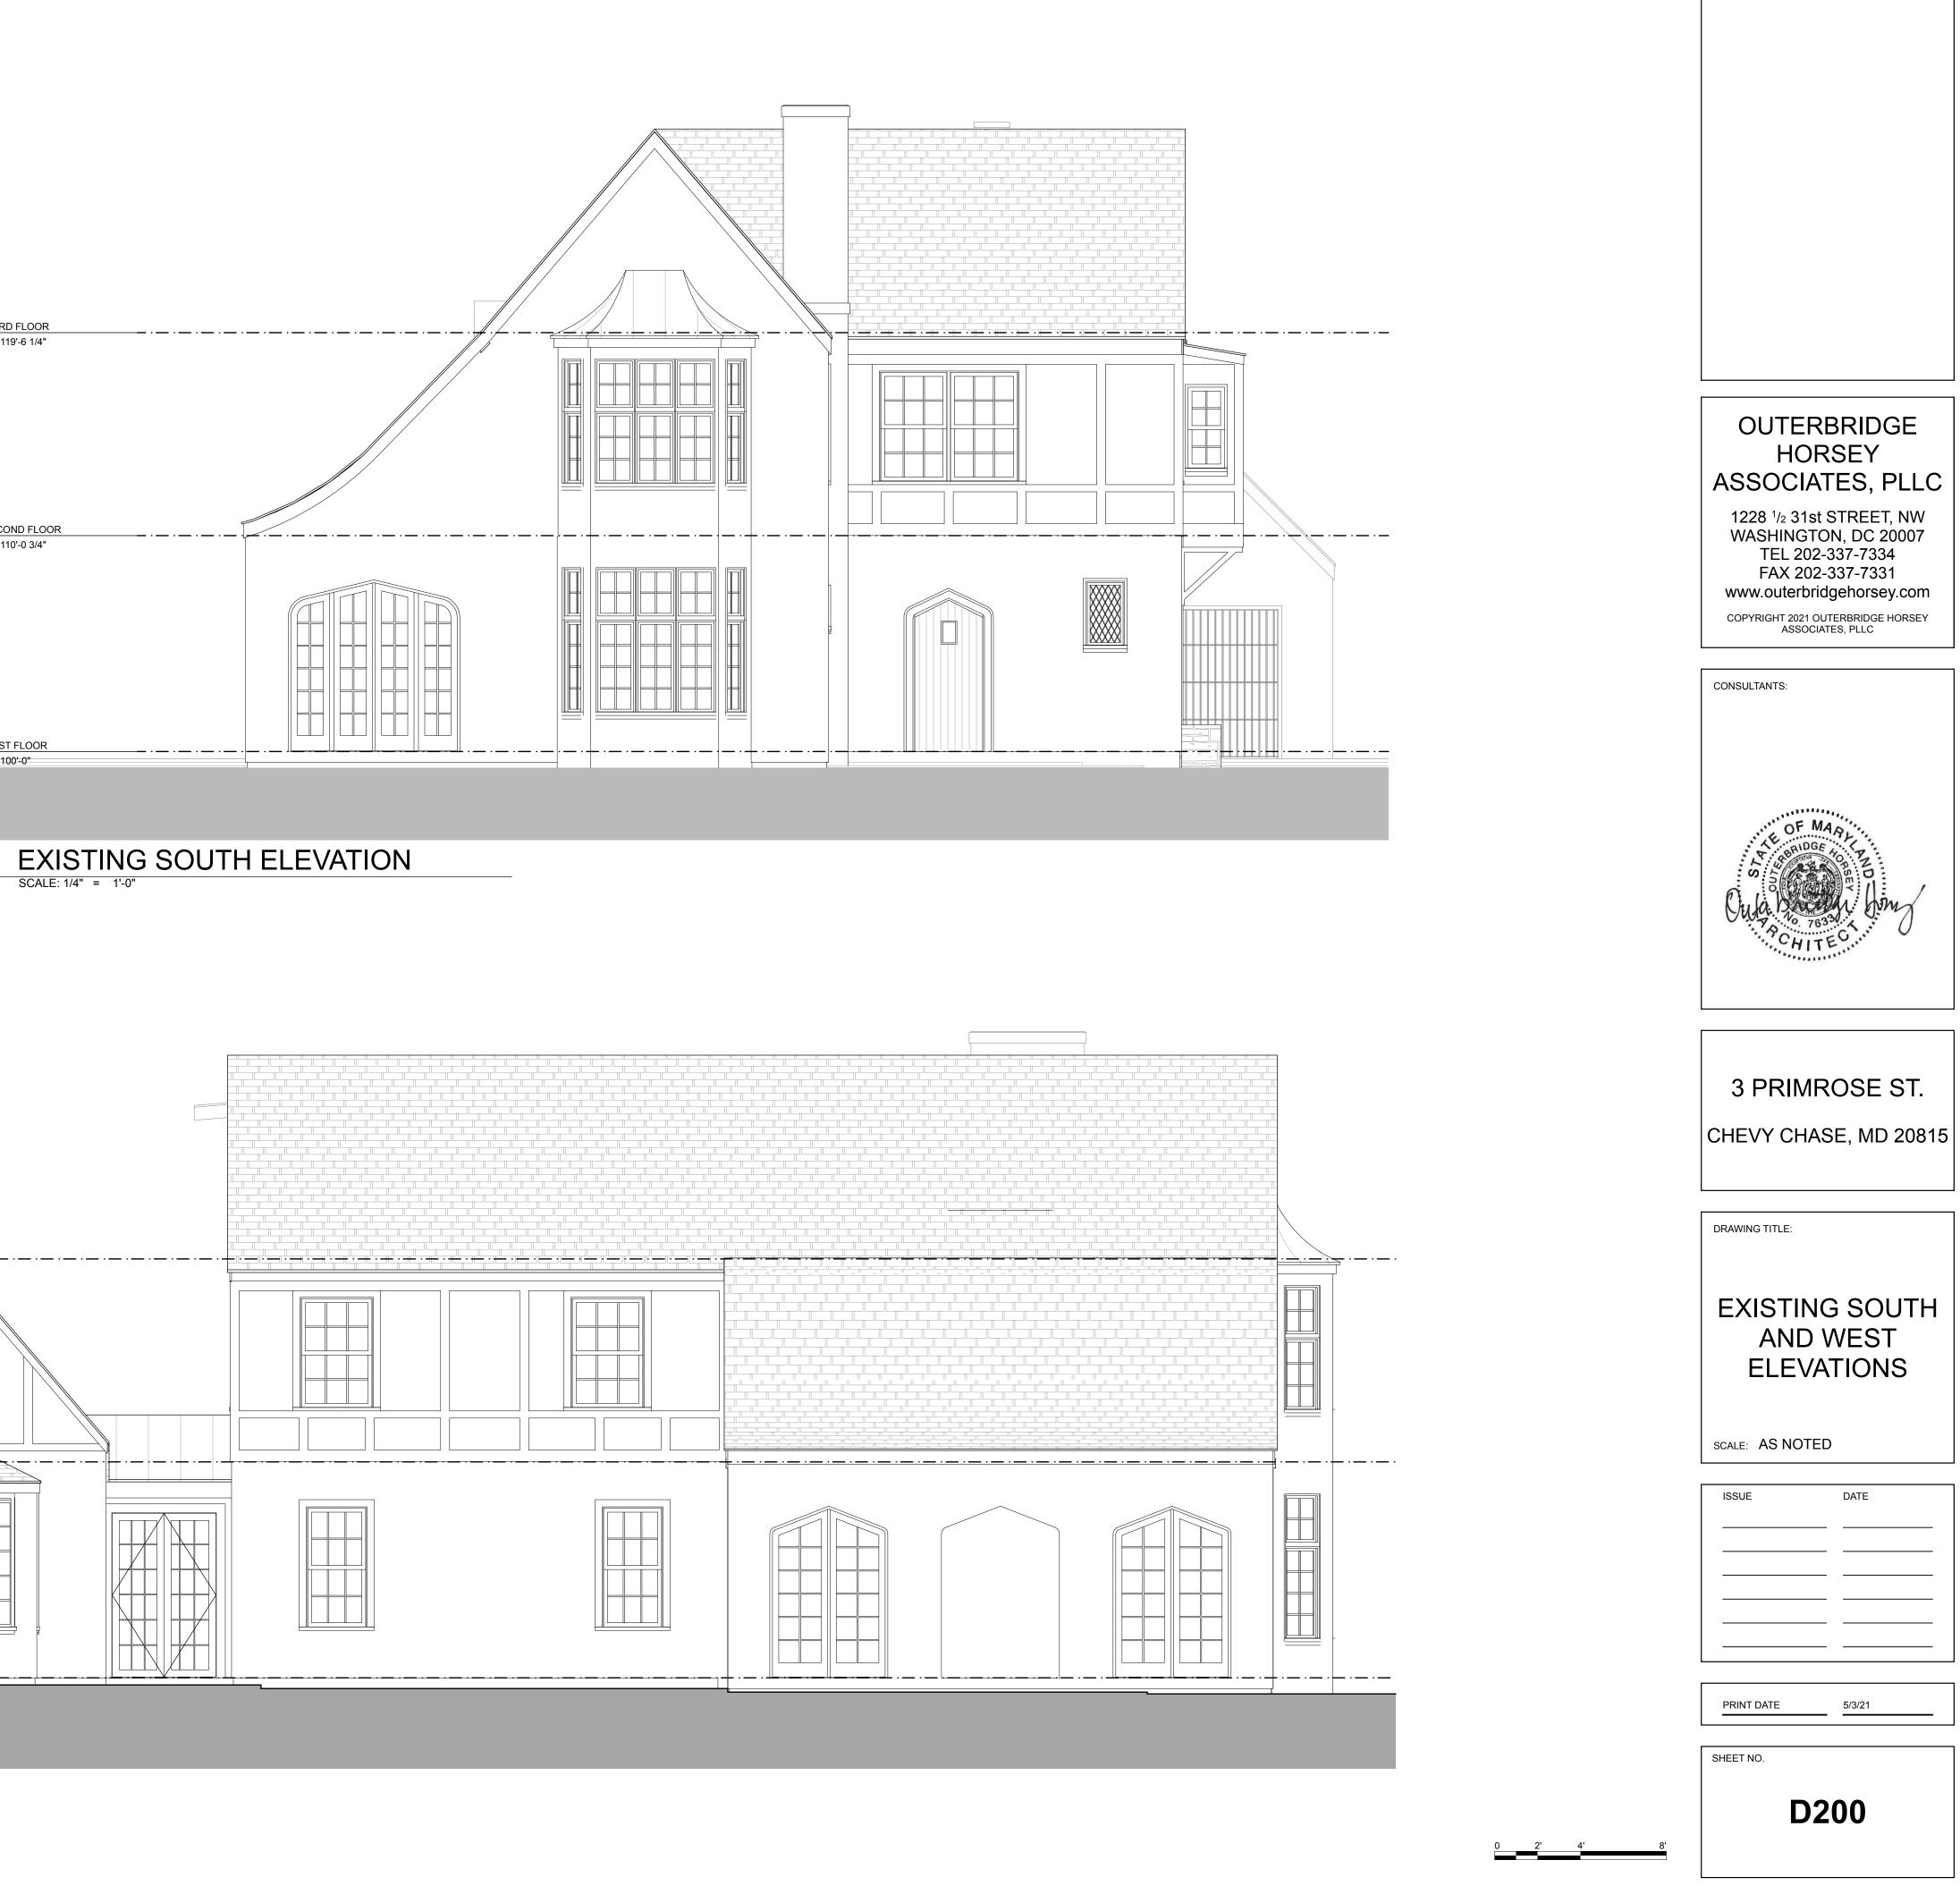
Montgomery County

Historic Preservation Commission


2 EXISTING WEST ELEVATION SCALE: 1/4" = 1'-0"

AMME 4. MATTA	7		
n.Bruechert at 2:35 pm,	May 27, 2021		
THIRD FLOOR EL. 119'-6 1/4"			
EL. 110'-0 3/4"			
		ŧ	ť
FIRST FLOOR			·




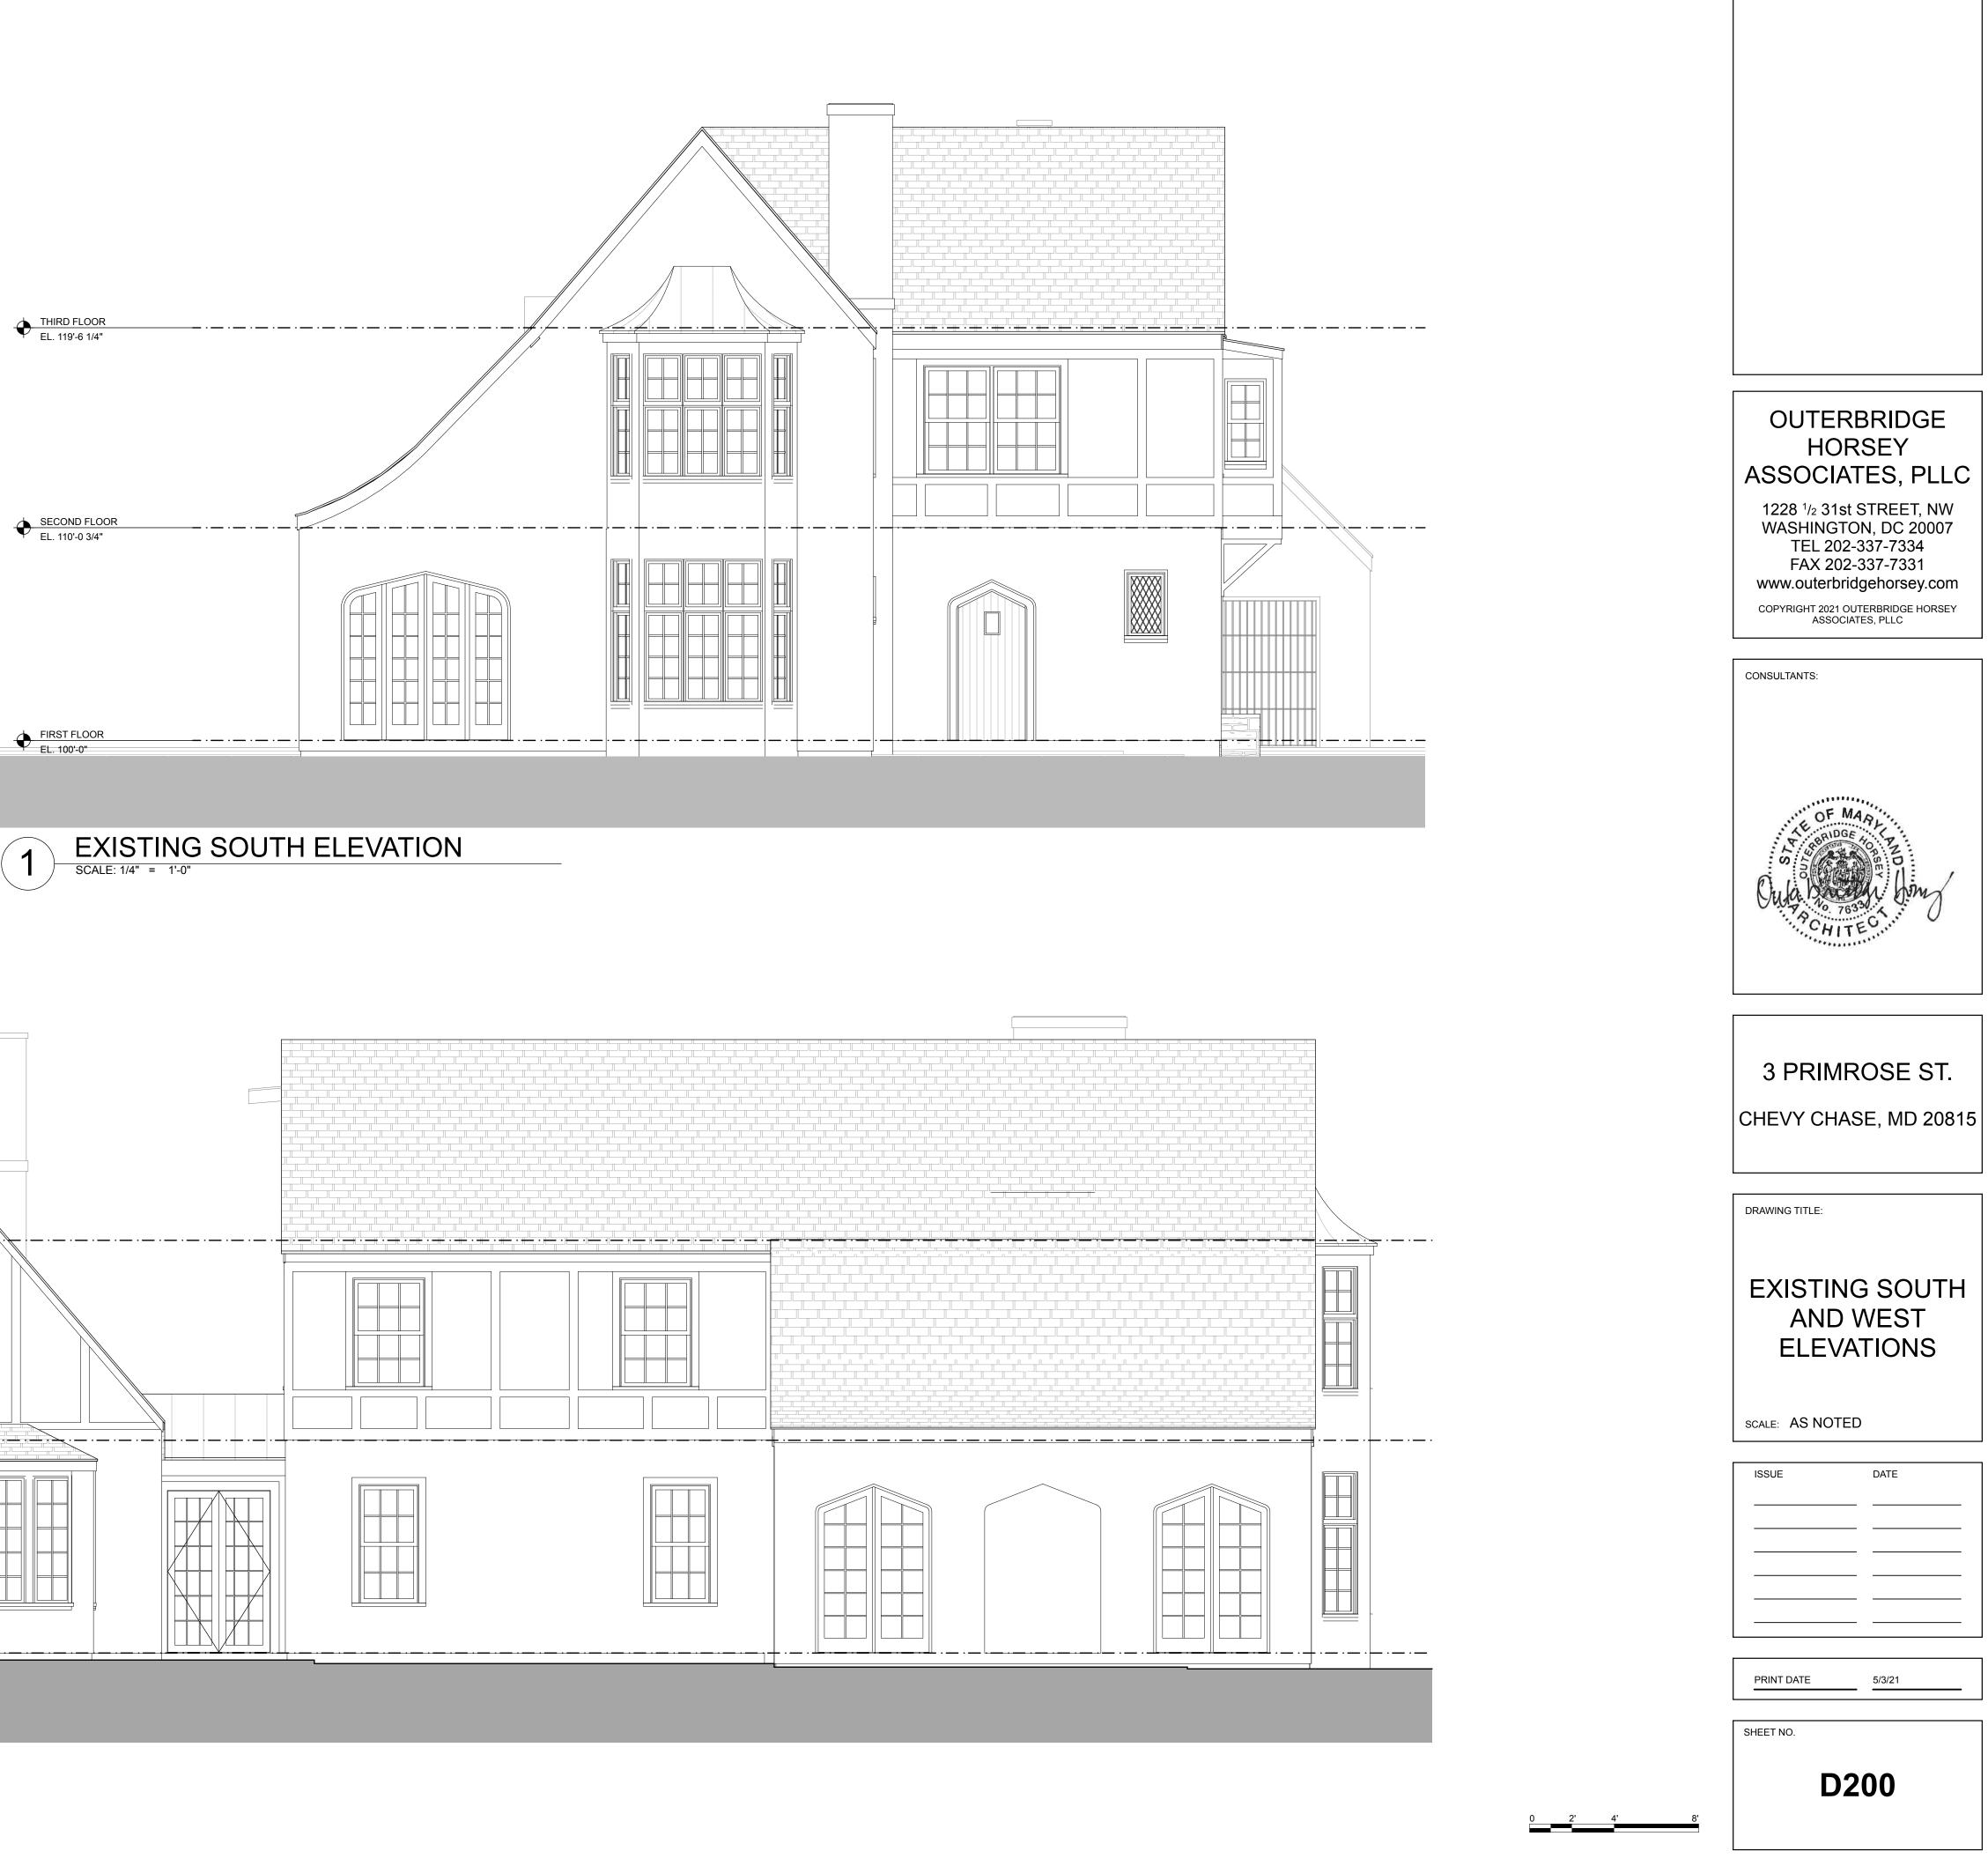




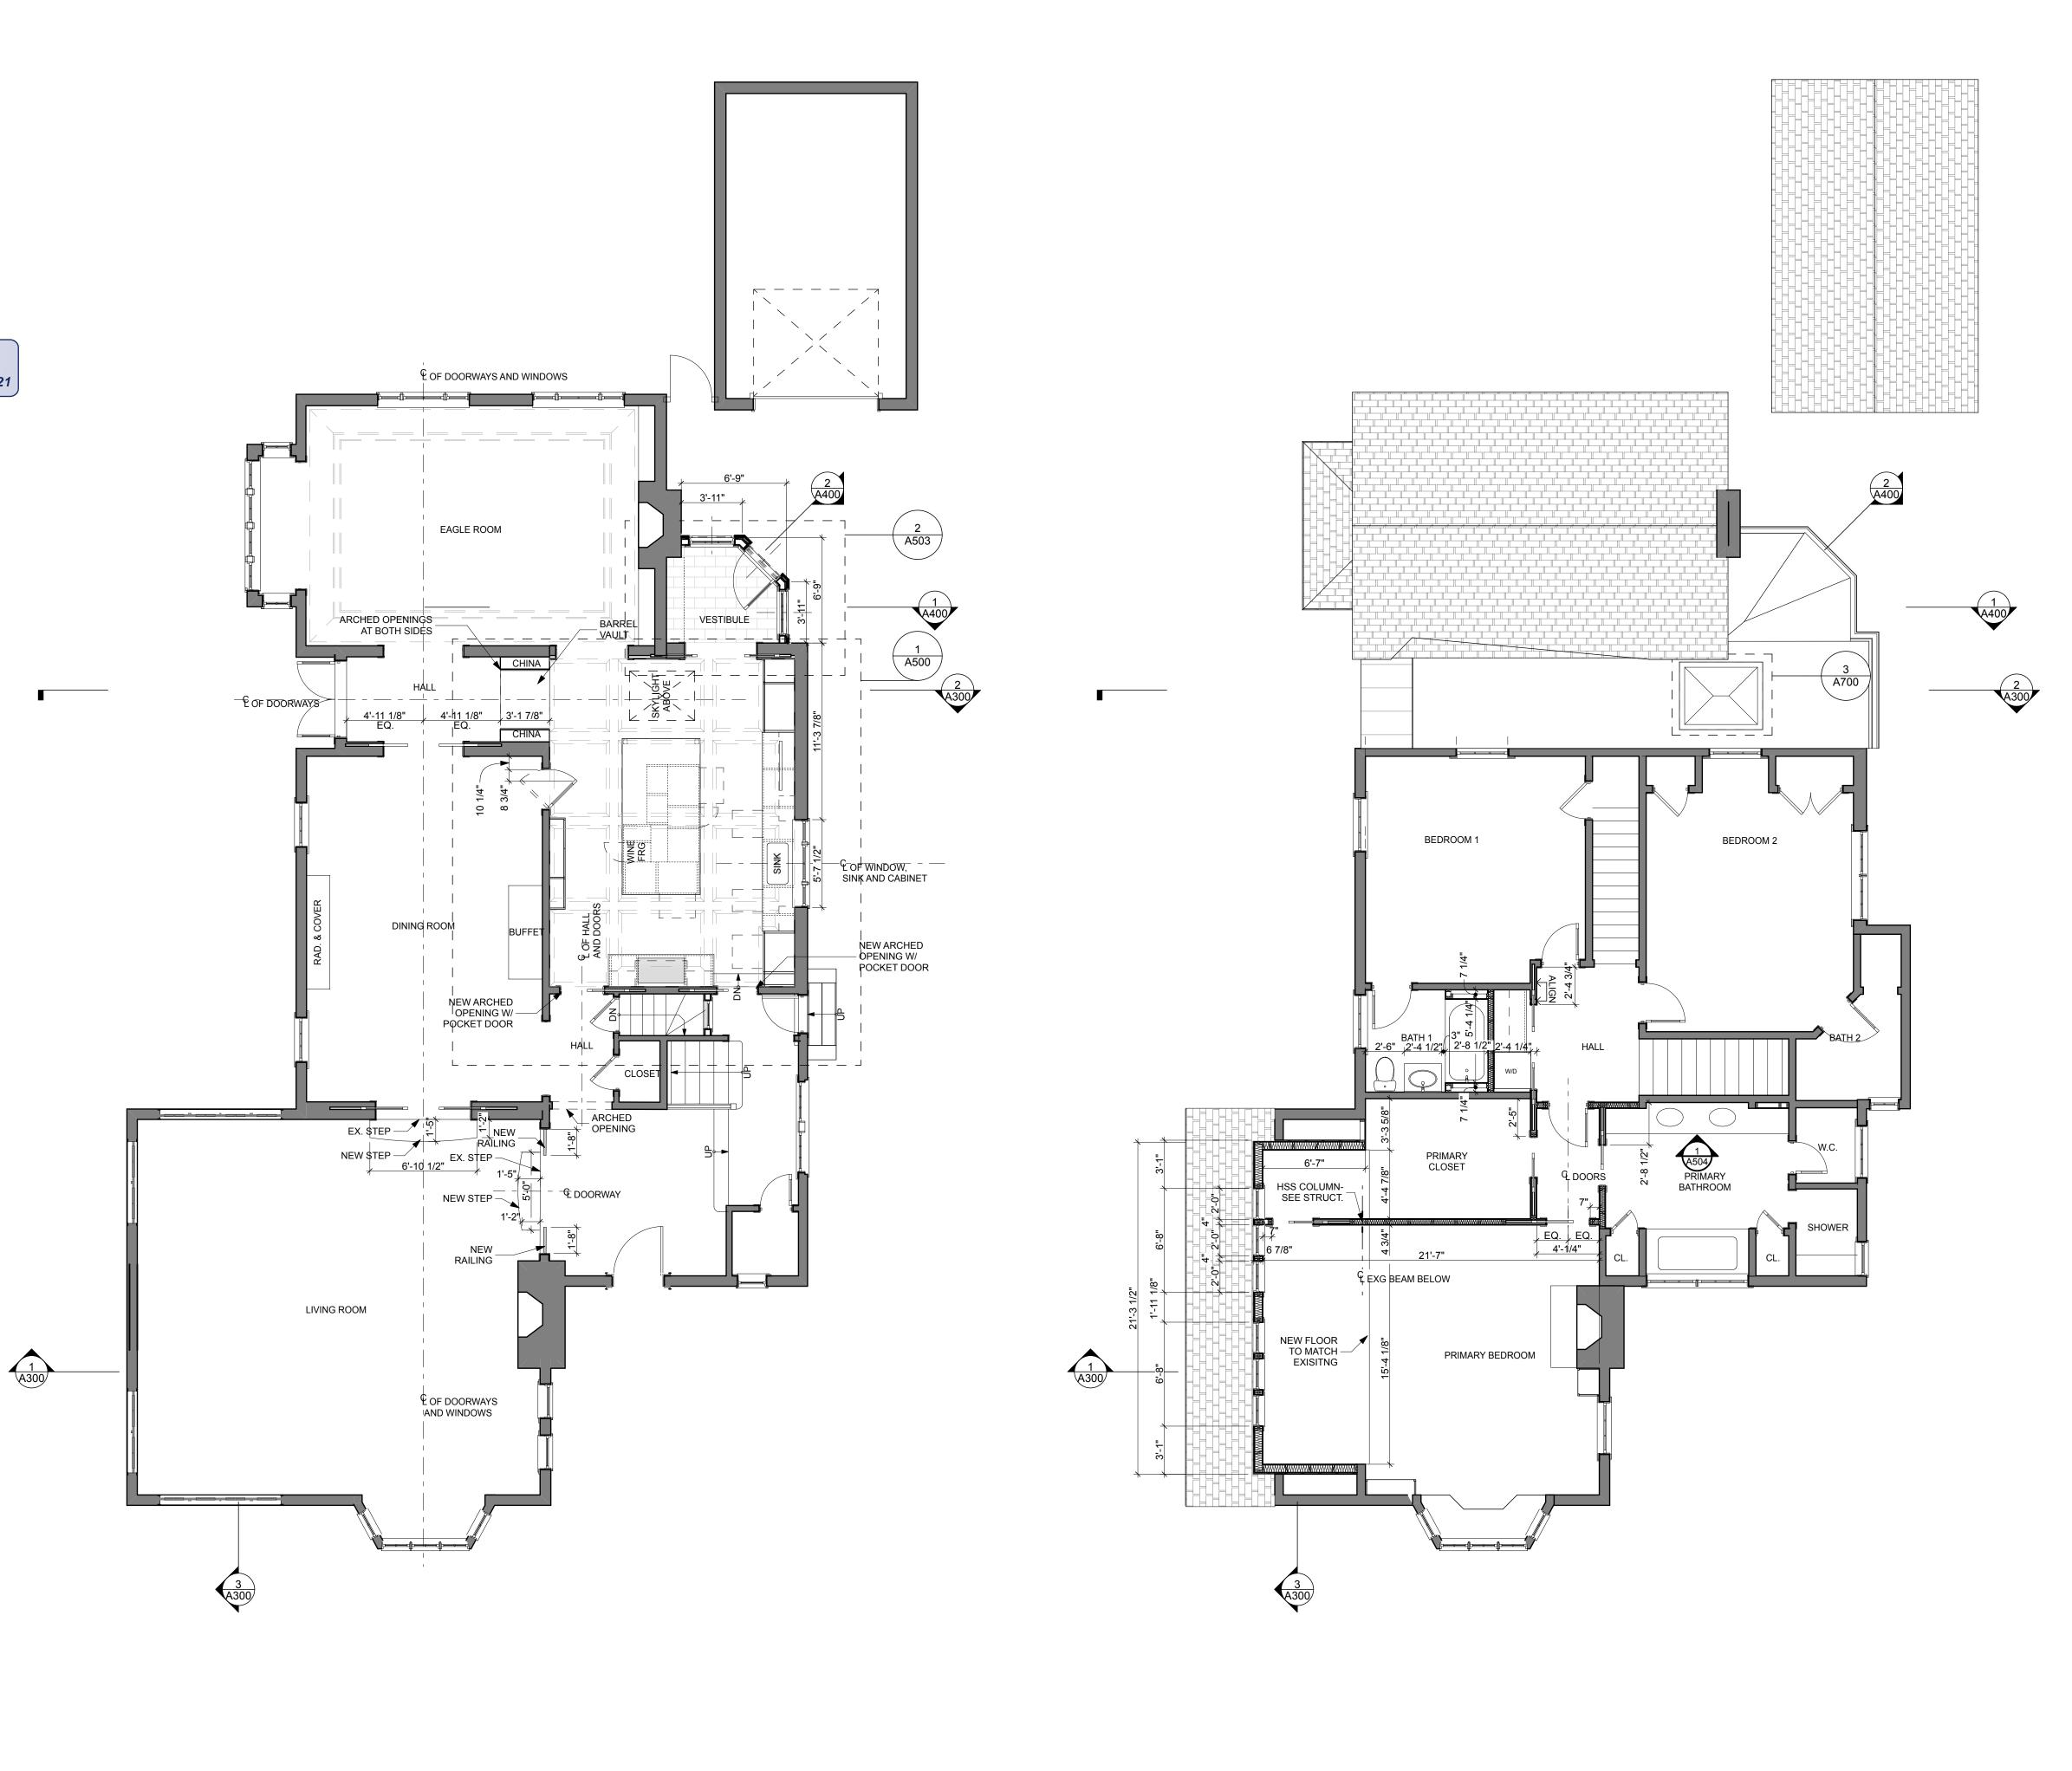




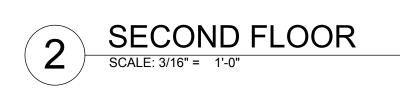


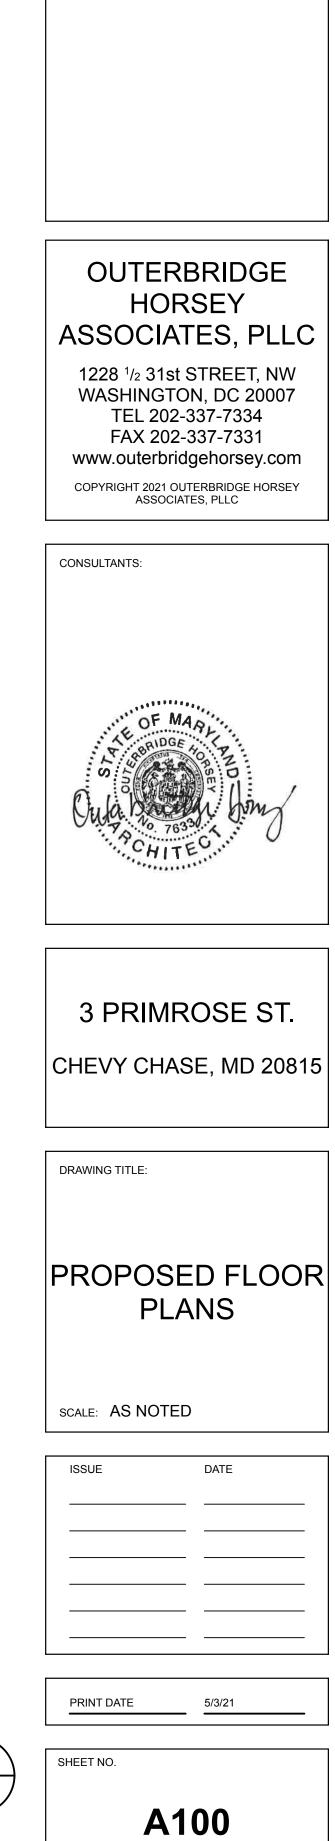



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		$\left(\right)$	\mathbb{D}
0	4'	8'	12'

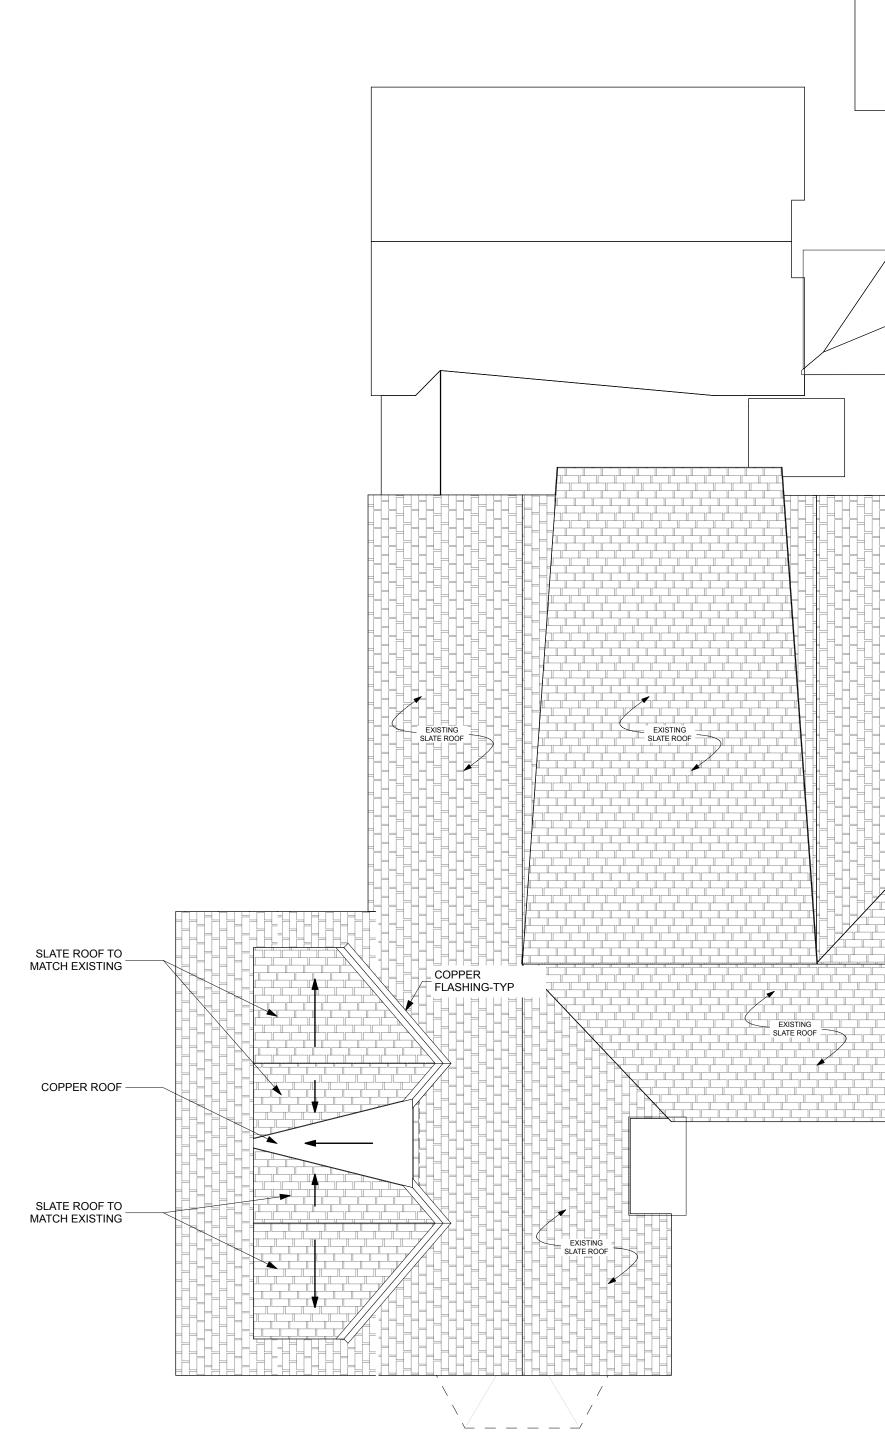


1 ROOF SCALE: 3/16" = 1'-0"

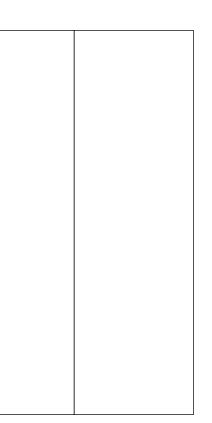

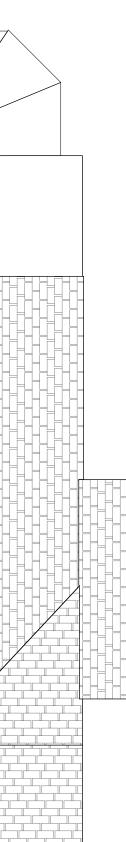

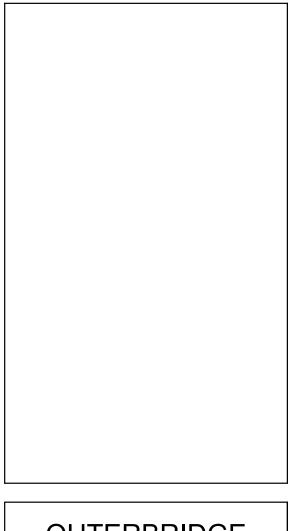

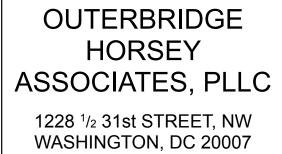

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3 PRIMROSE ST.
CHEVY CHASE, MD 20815
DRAWING TITLE:



SCALE: AS NOTED

ISSUE	DATE
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PRINT DATE	5/3/21

SHEET NO.

APPROVED Montgomery County Historic Preservation Commission MMMMa MMMA REVIEWED By Dan.Bruechert at 2:35 pm, May 27, 2021


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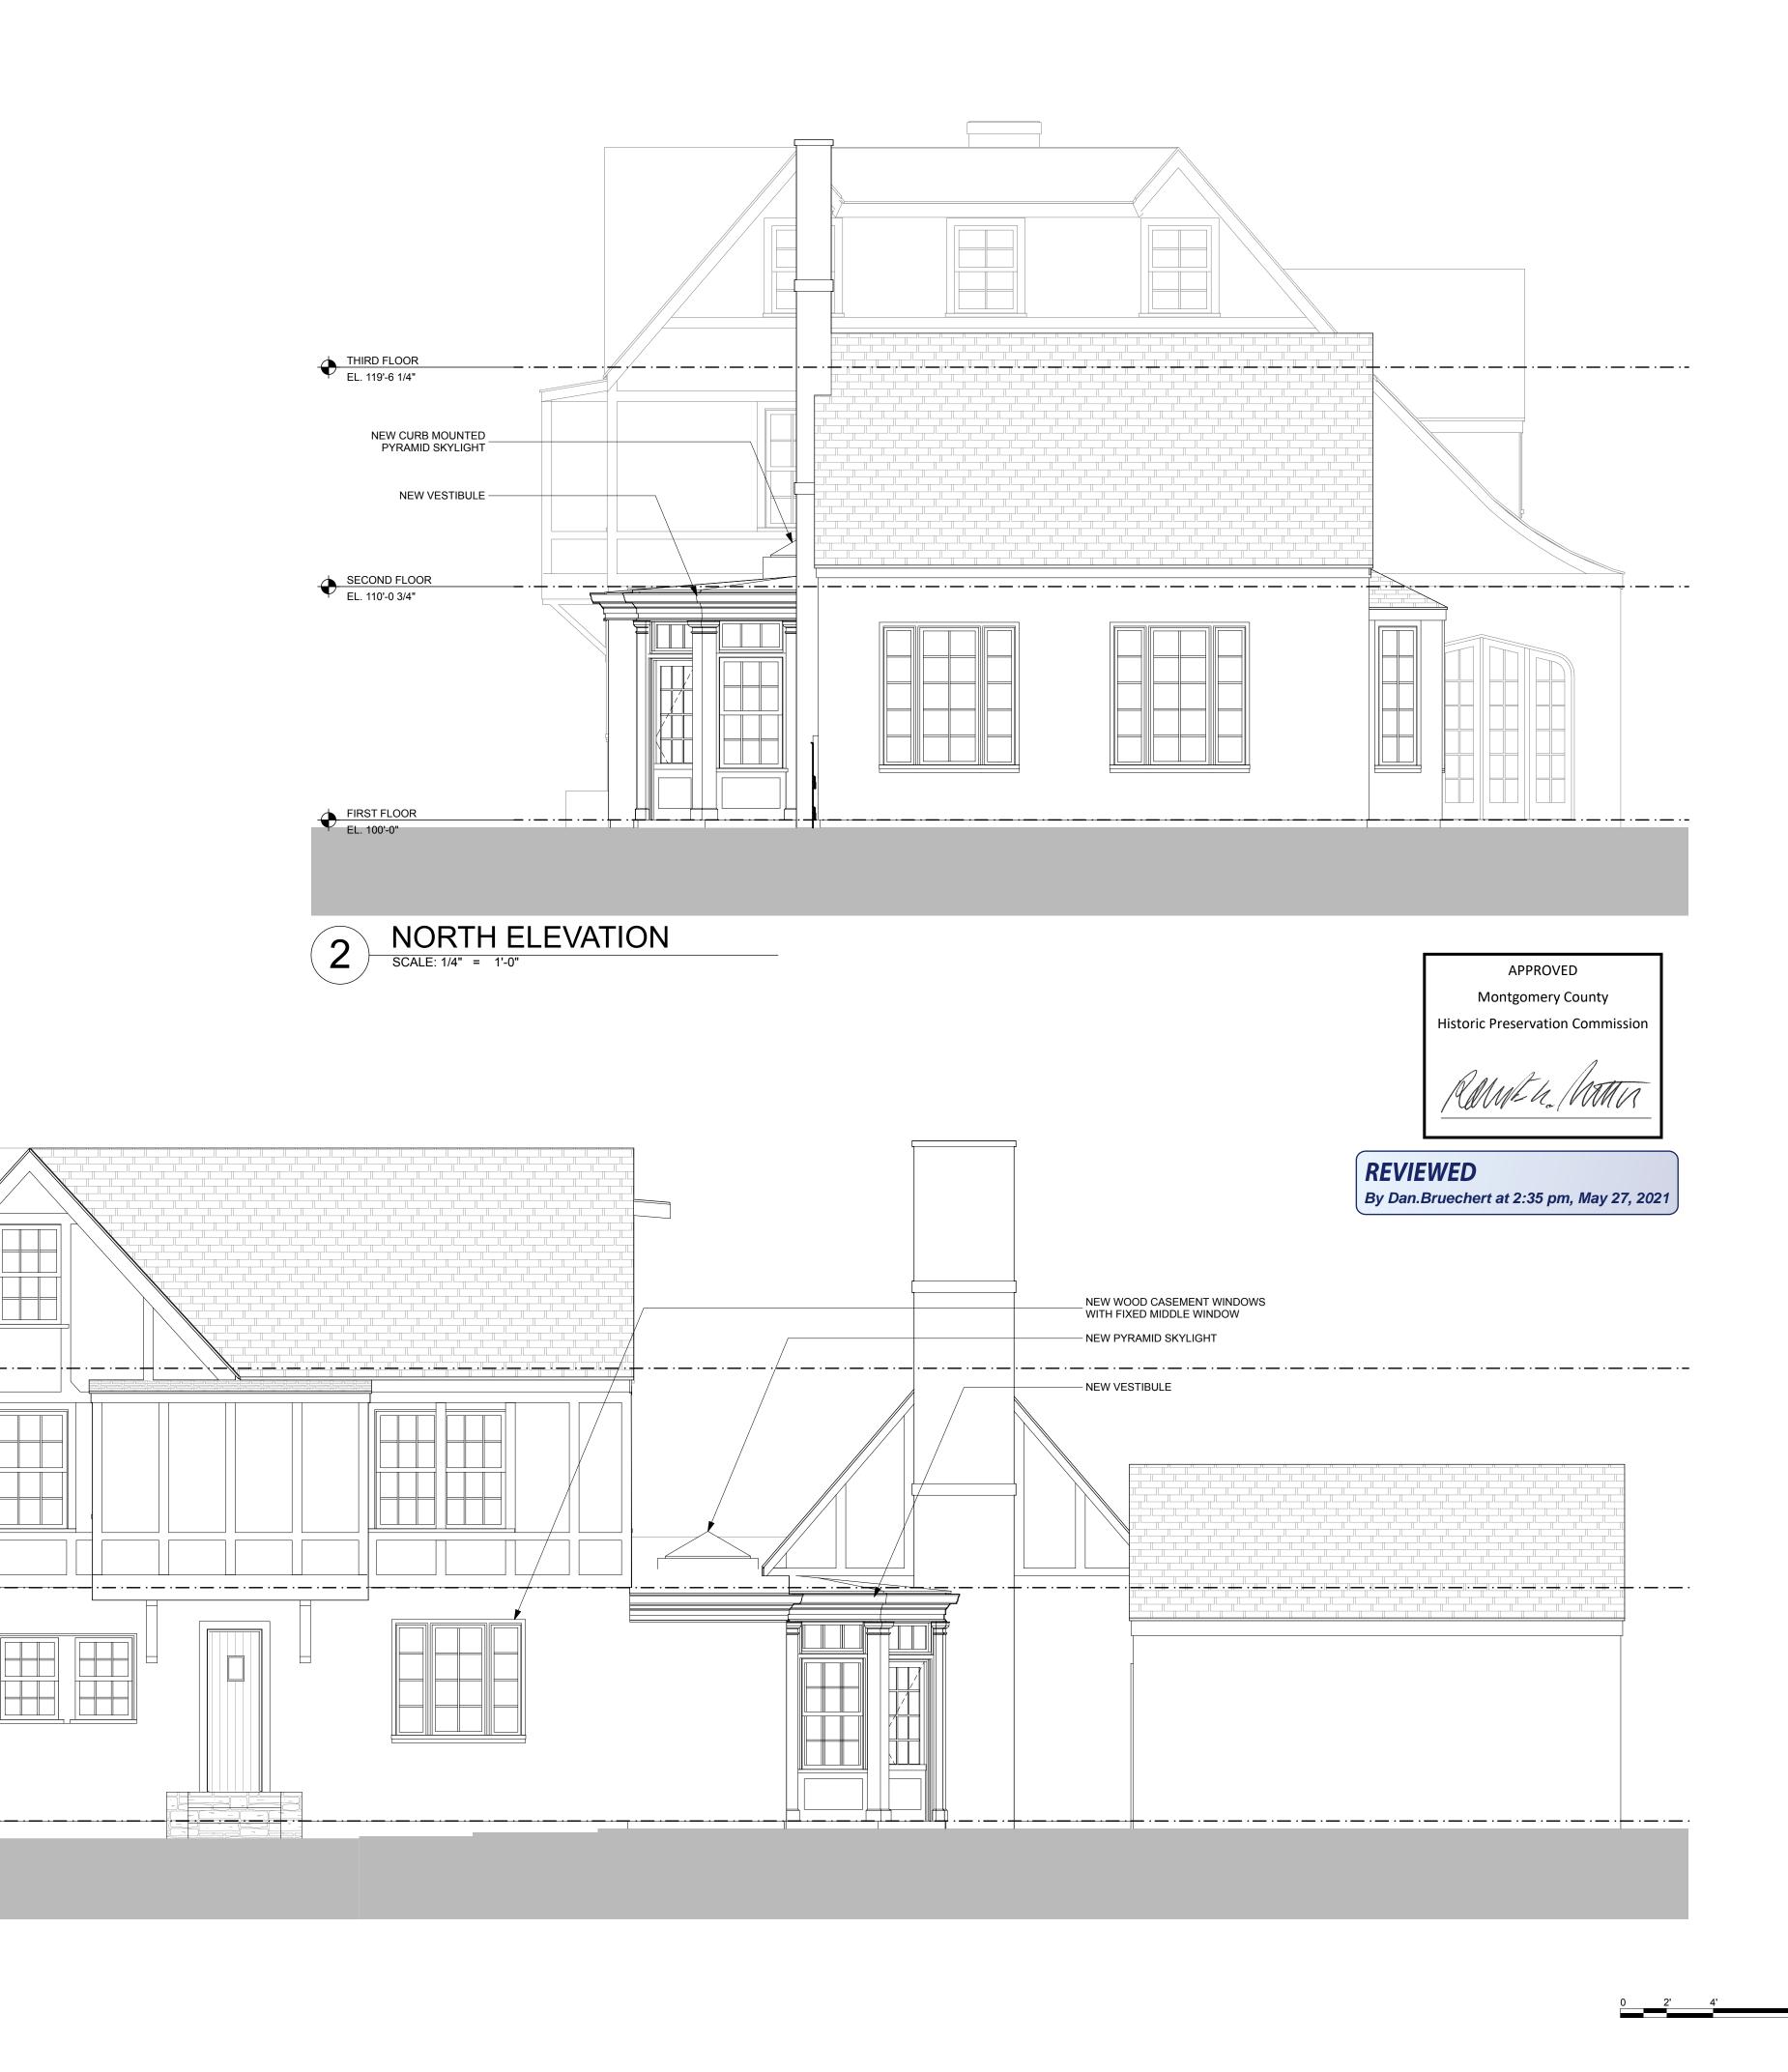



Montgomery County Historic Preservation Commission





SCALE: 1/4" = 1'-0"




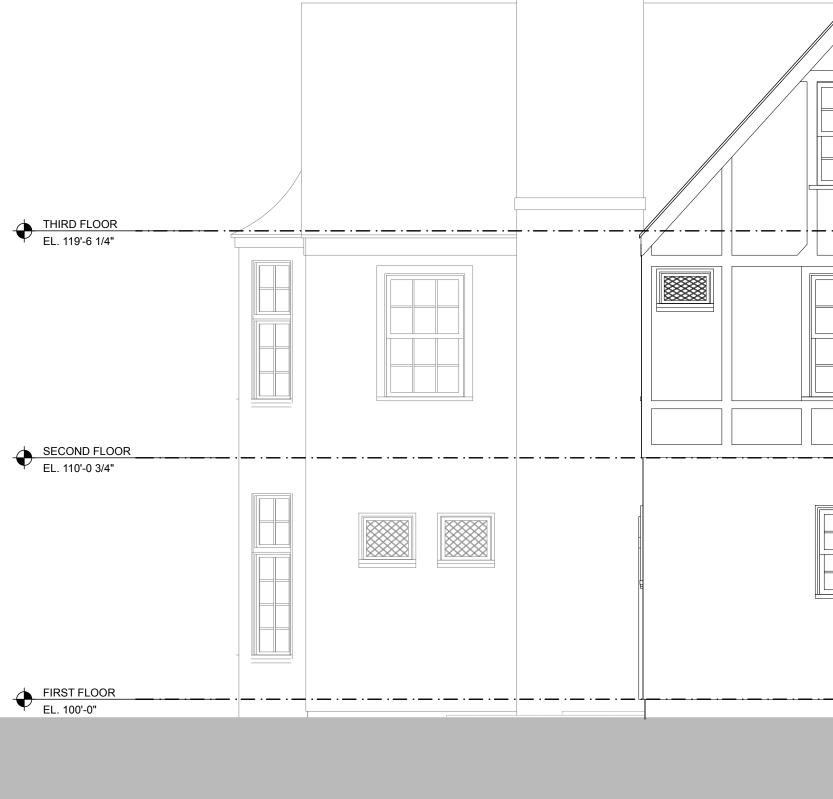


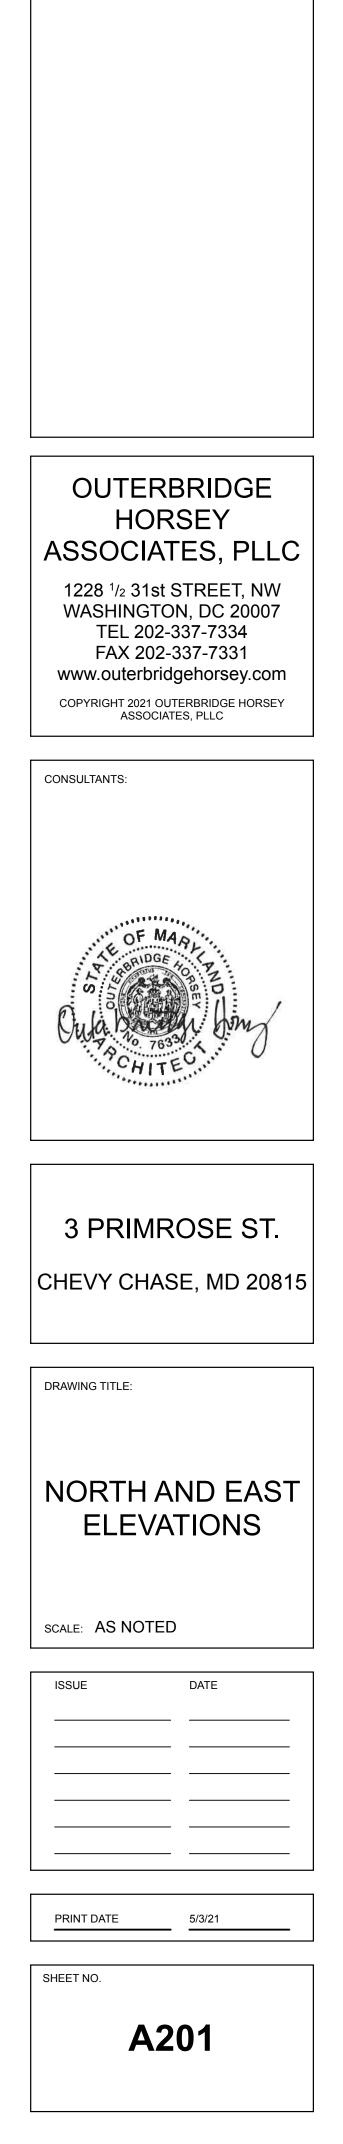


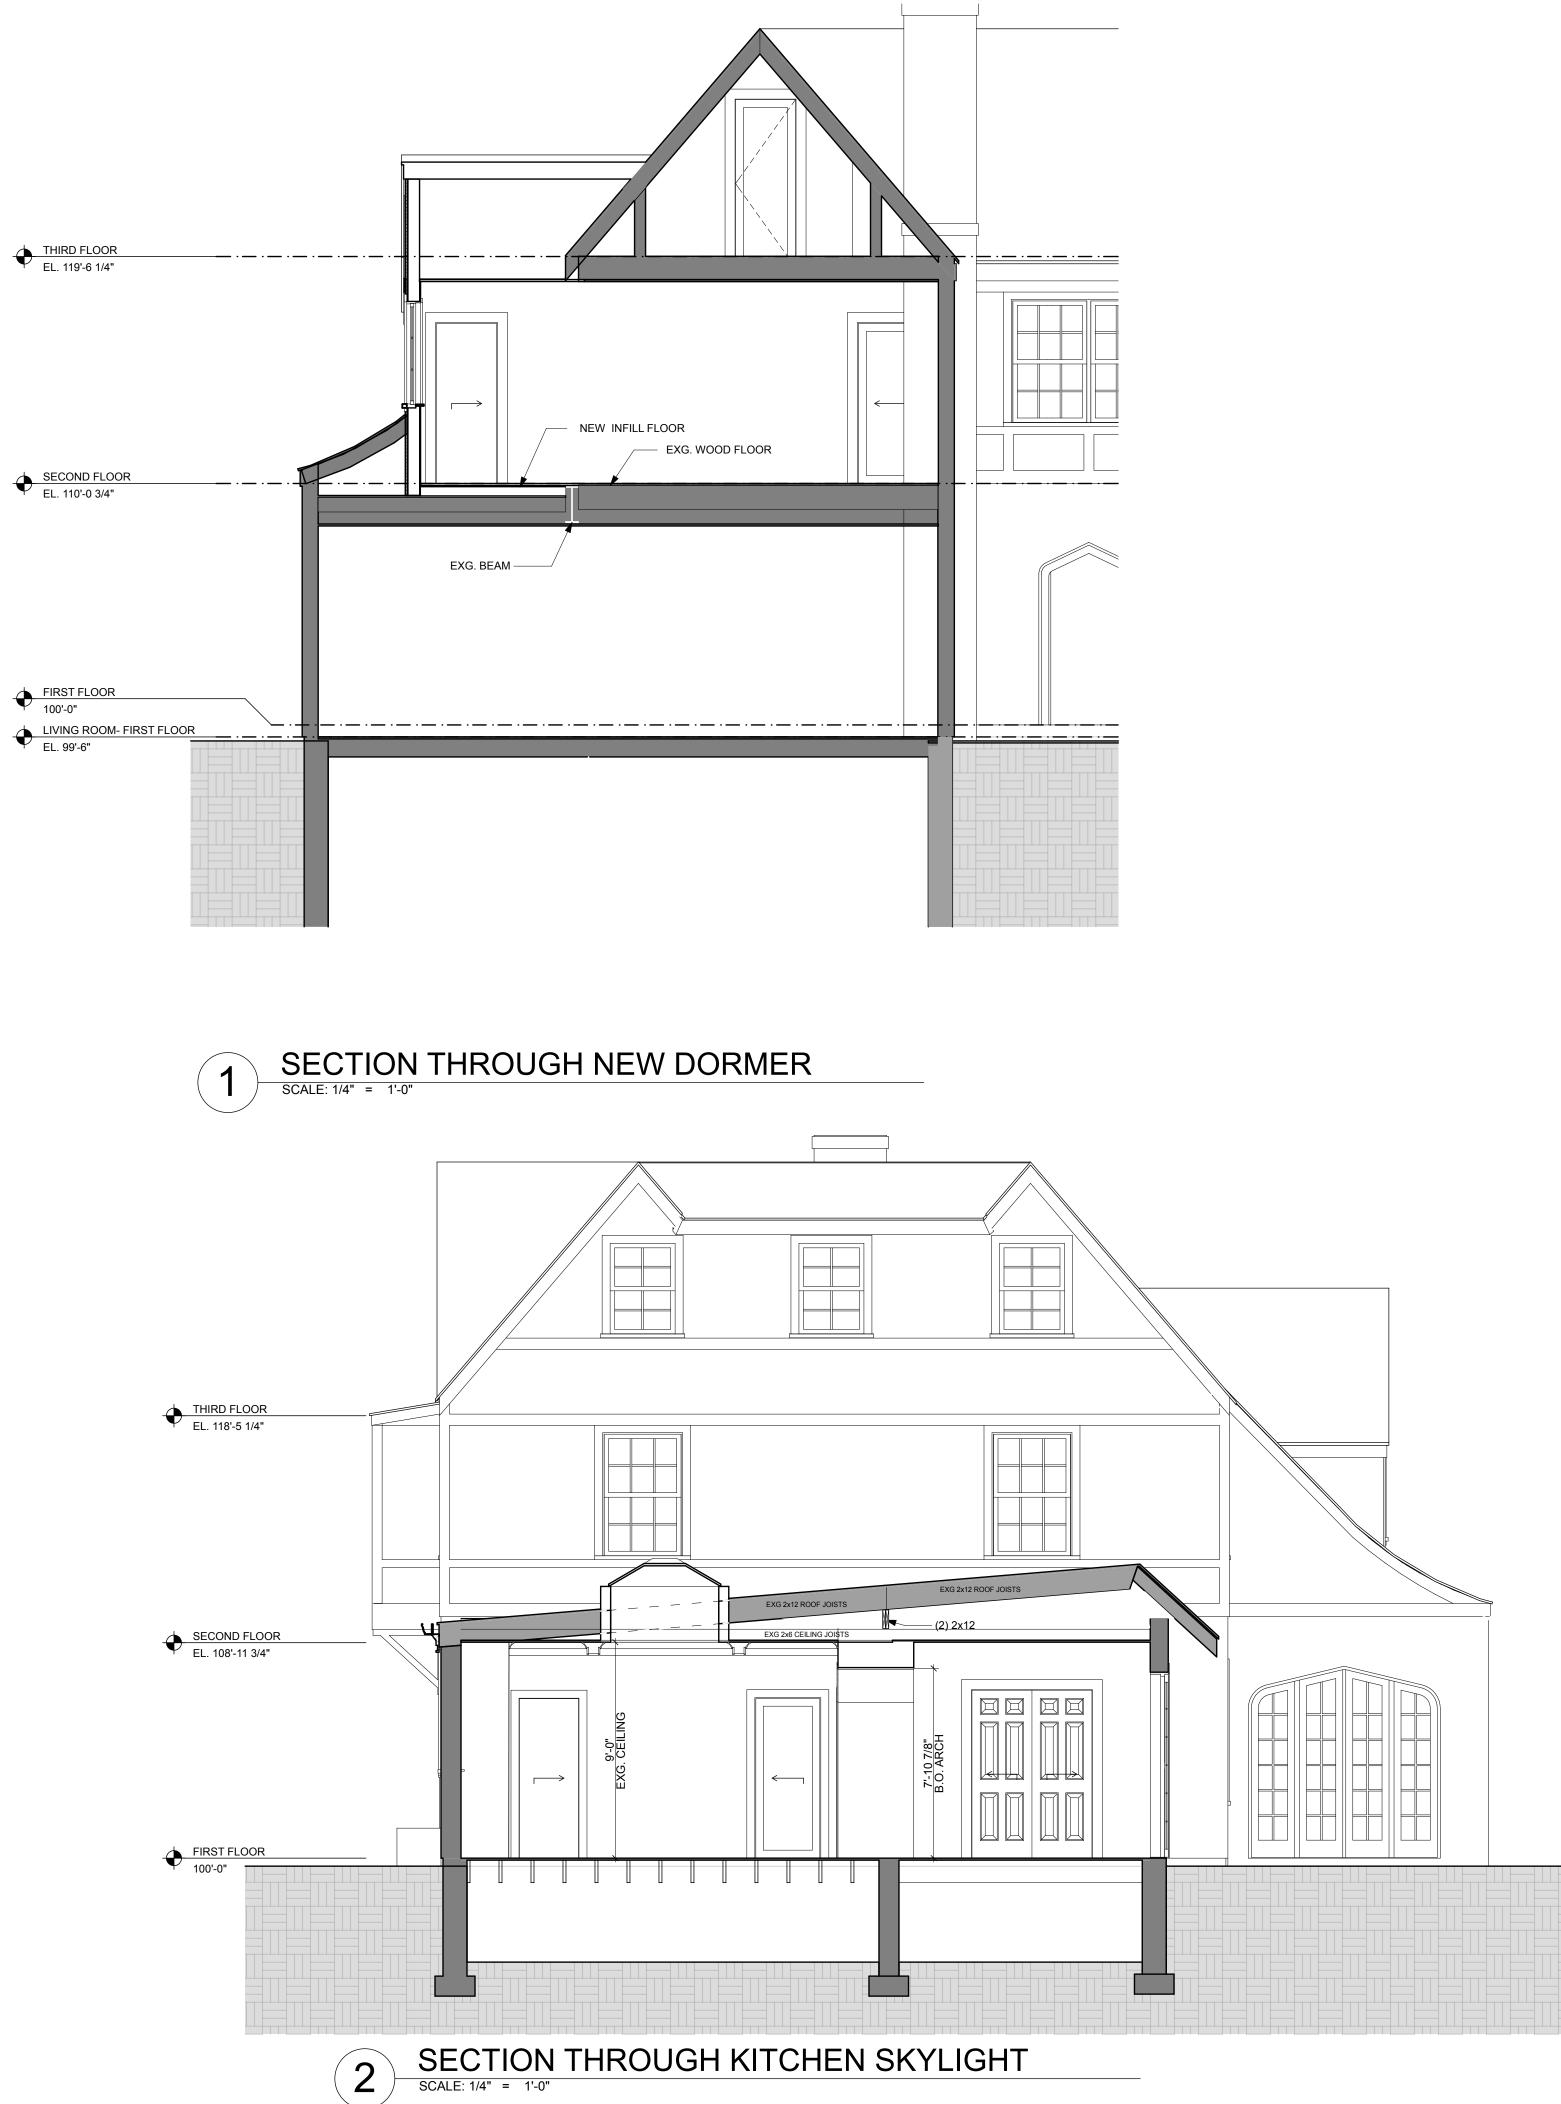

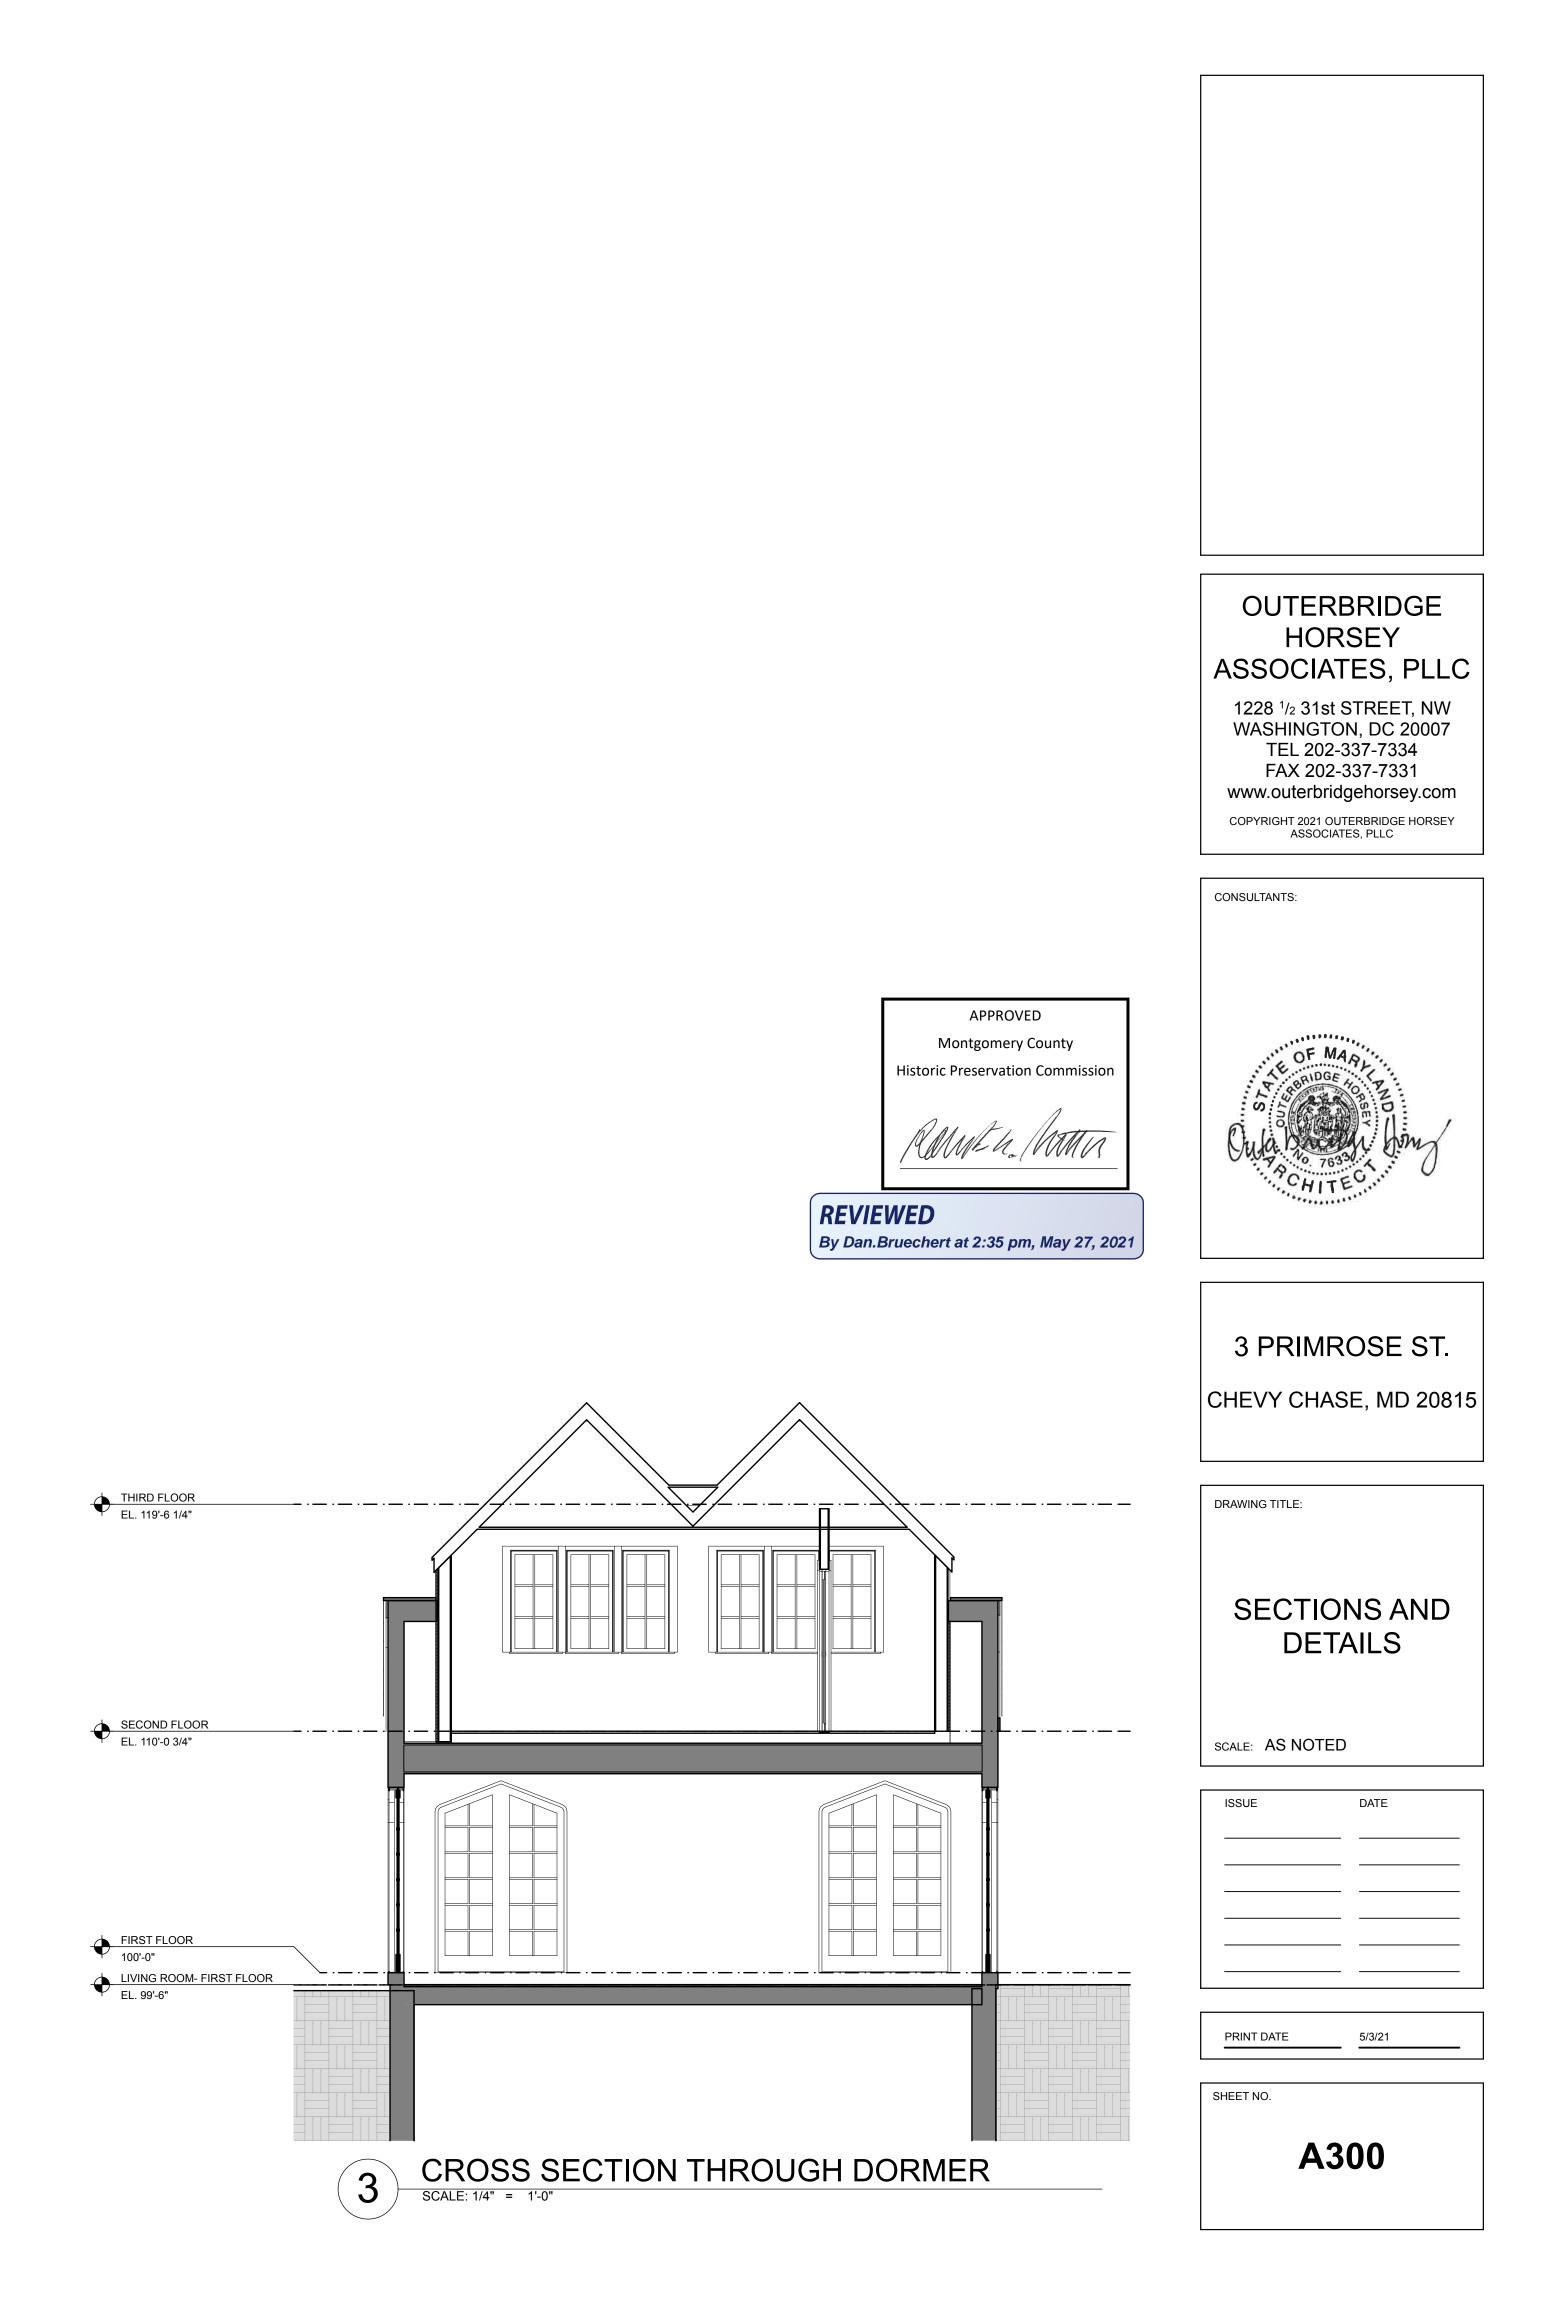

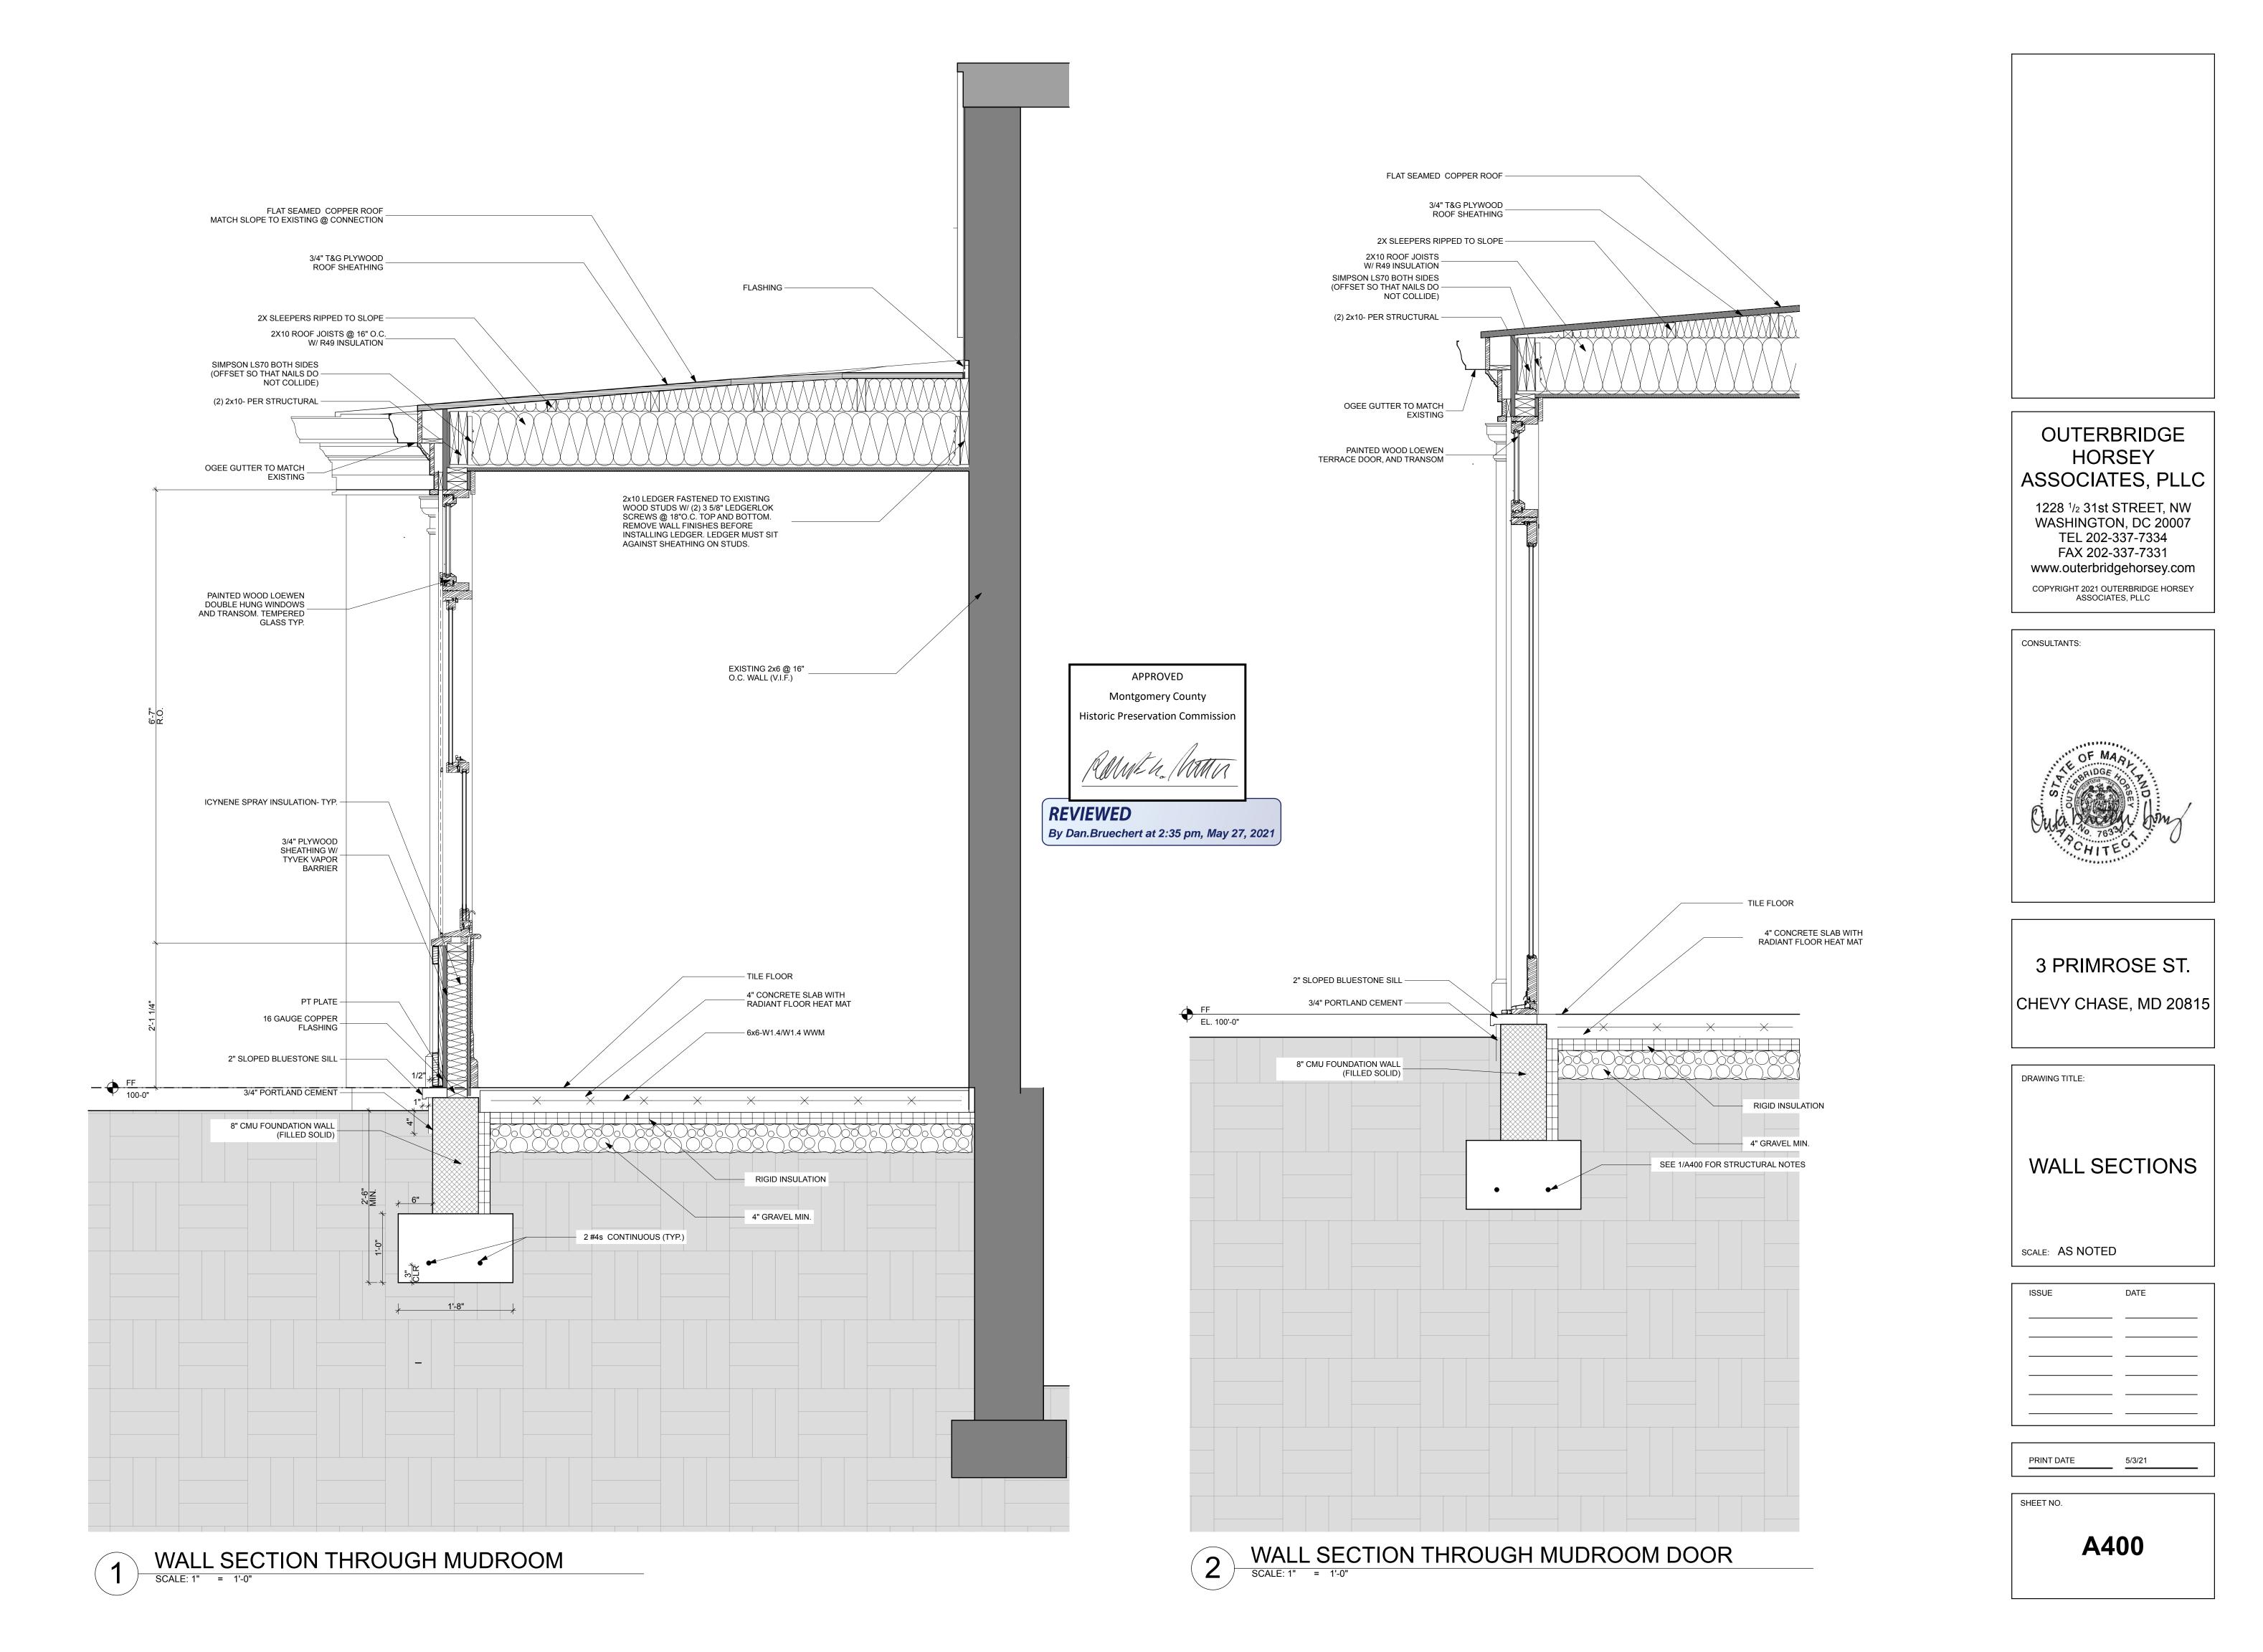


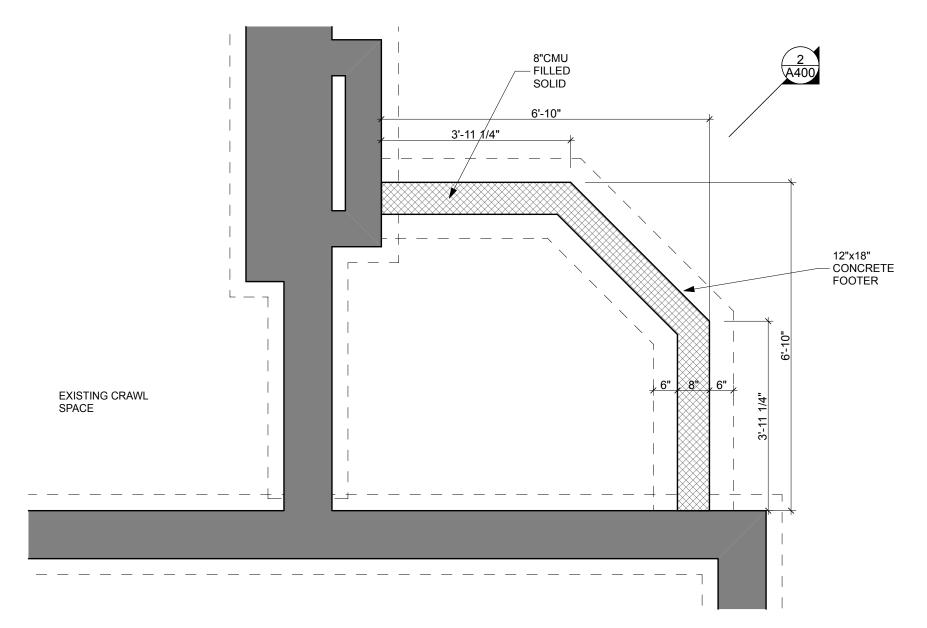

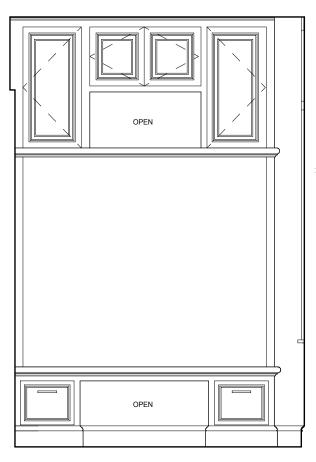


WEST


BASEMENT/ FOUNDATION PLAN SCALE: 1/2" = 1'-0" 1

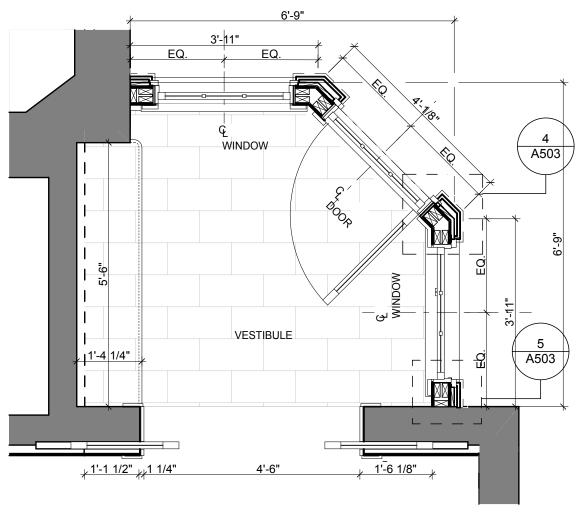




SCALE: 1/2" = 1'-0"

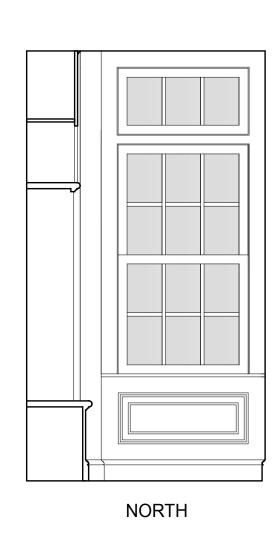


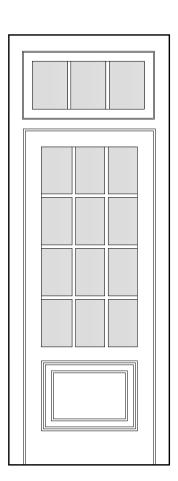

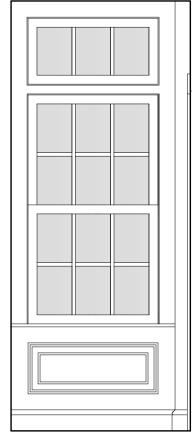

NORTHEAST


EAST

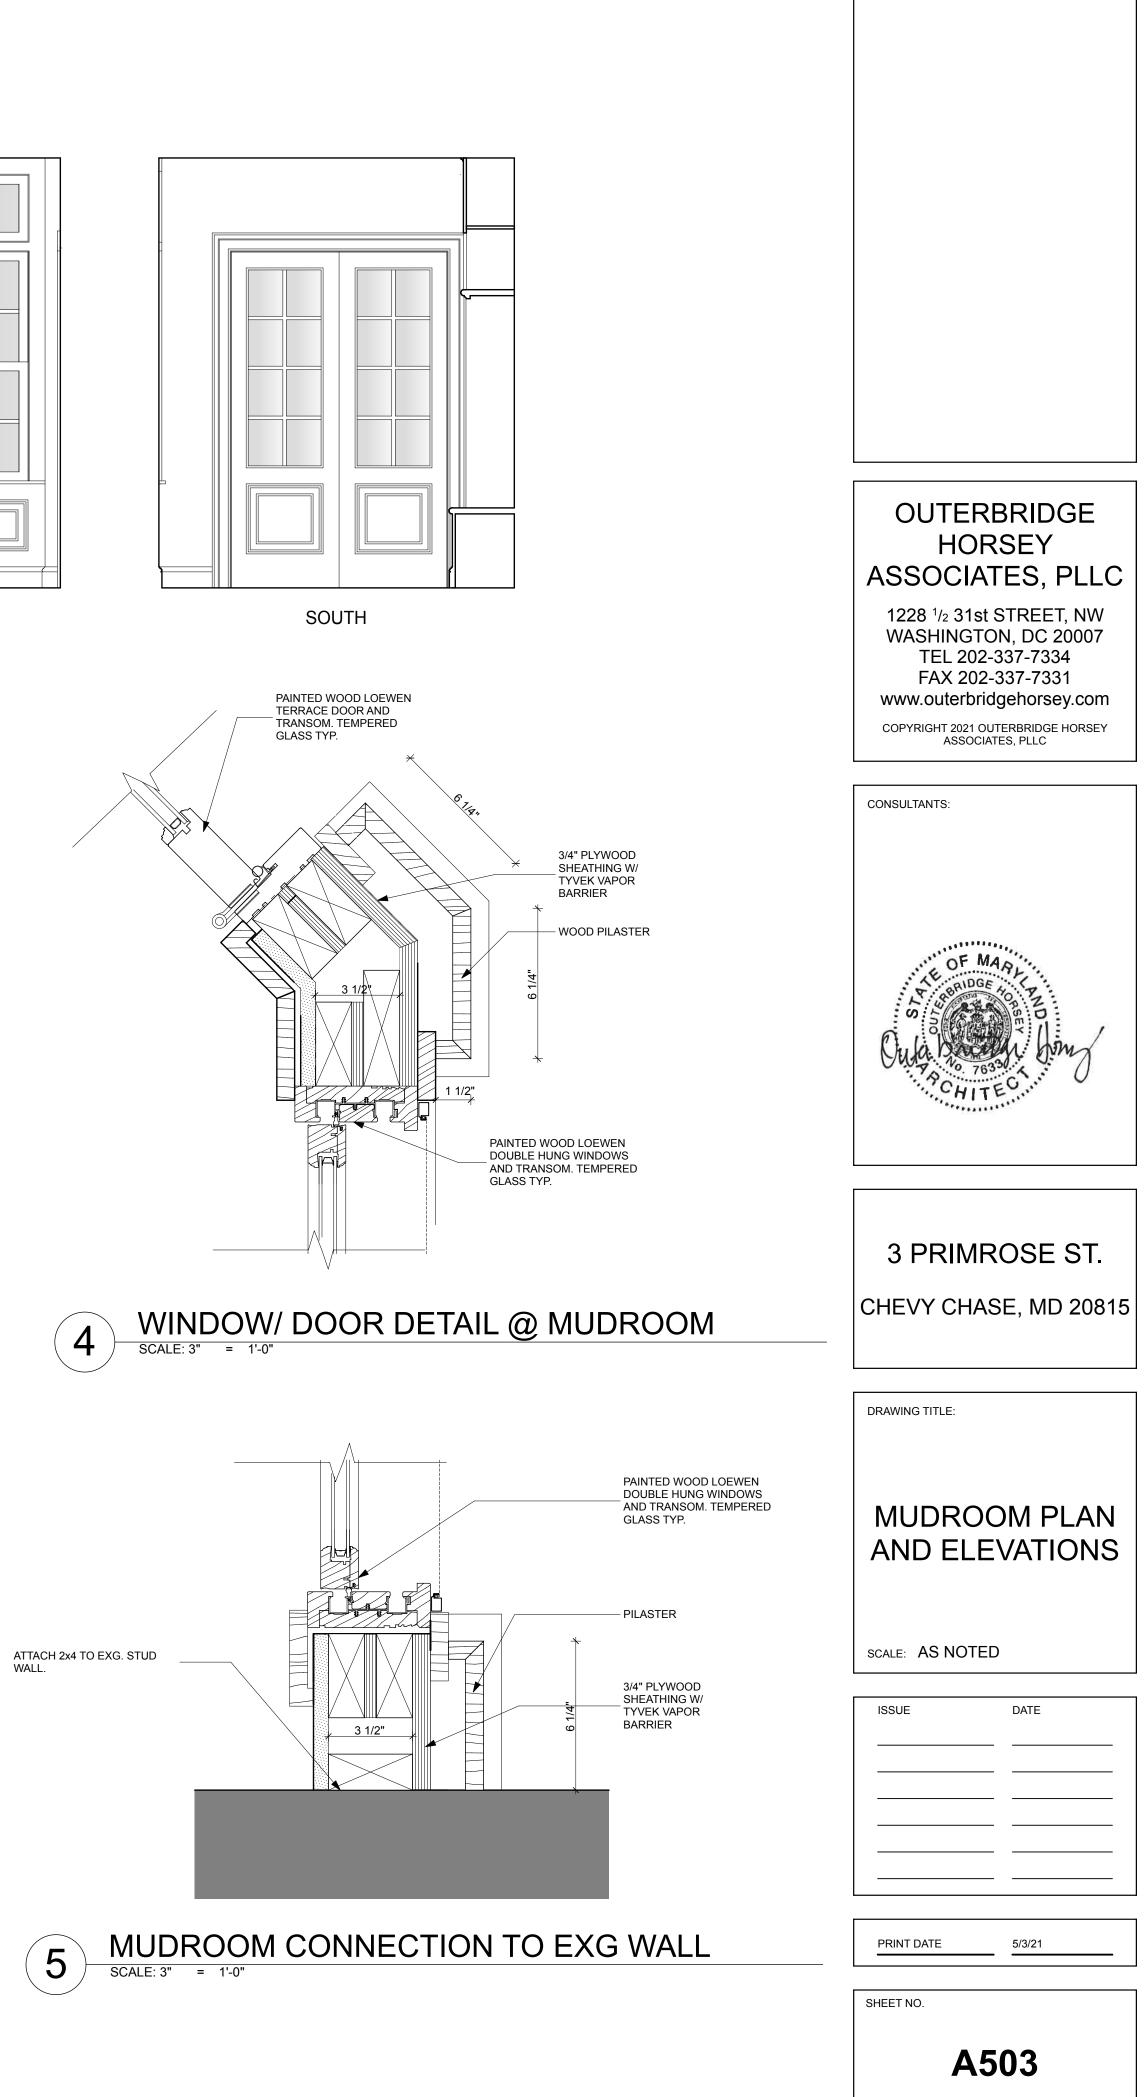

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REVIEWED By Dan.Bruechert at 2:36 pm, May 27, 2021



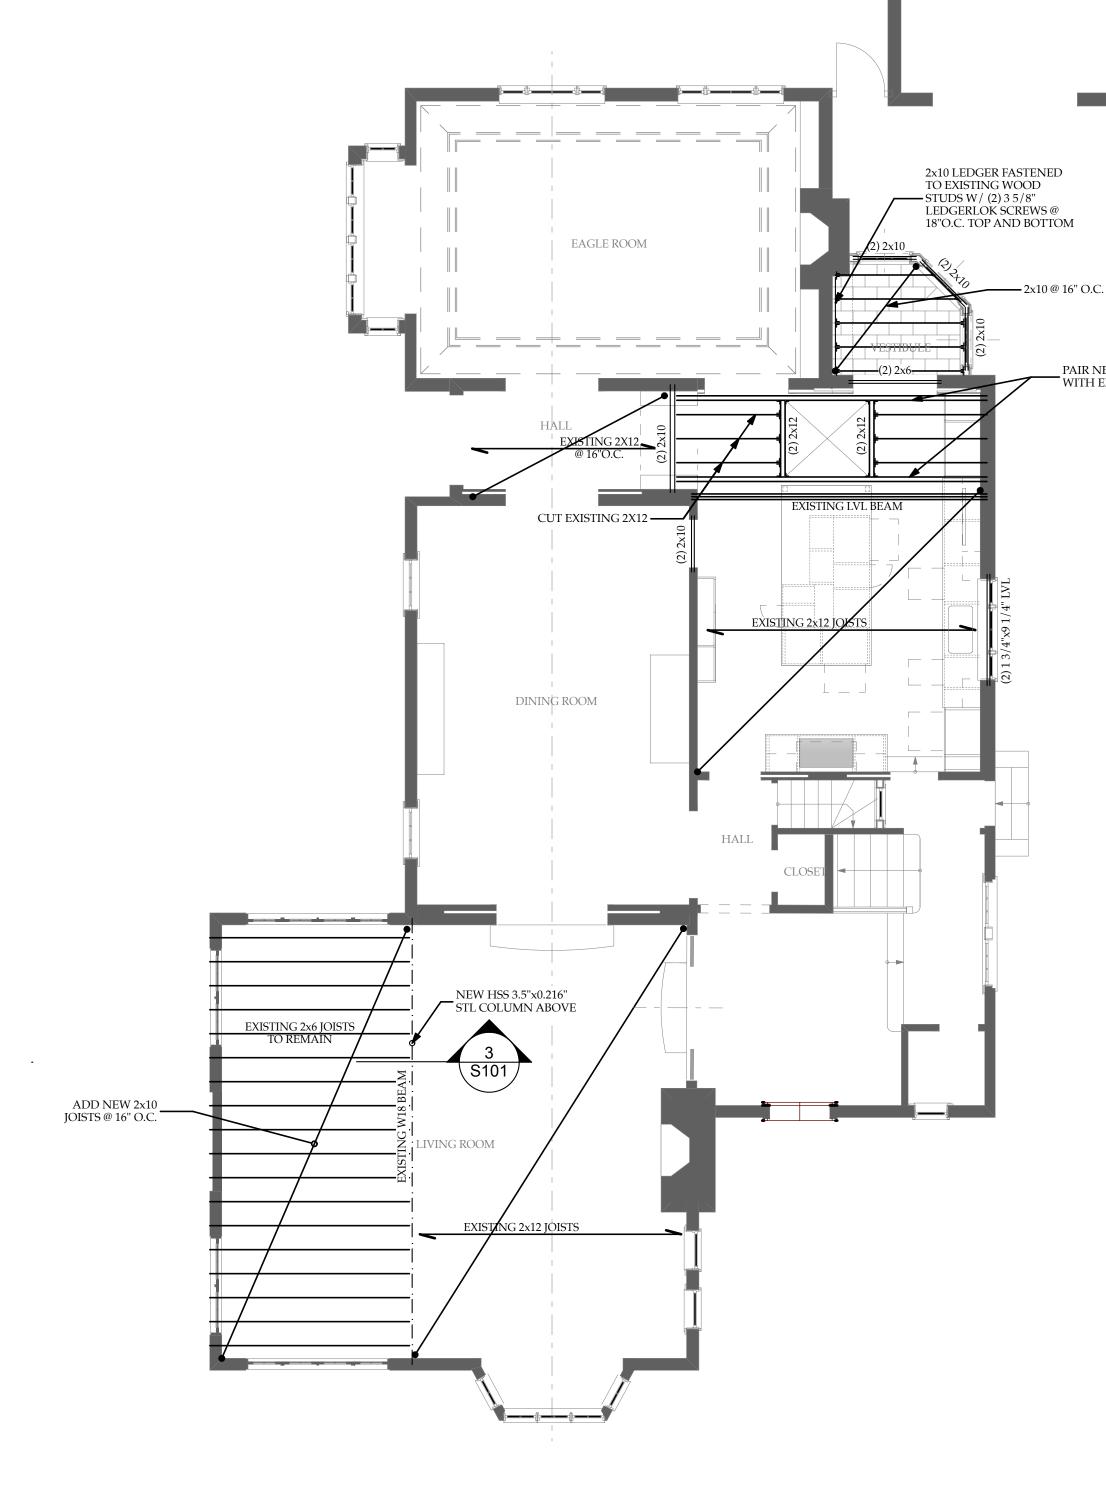

KITCHEN SKYLIGHT AND VESIBULE ROOF FRAMING SCALE: 3/16" = 1'-0"

EXG CONCRETE FOUNDATION WALL AND FOOTER GEILING JOISTG A400 8"CMU - FILLED SOLID 12"x18" - CONCRETE FOOTER EXISTING CRAWL SPACE " SLAB ON GRADE 6x6-W1.4/W1.4 WWM PAIR NEW 2X12 WITH EXG. 2X12 EXG CONCRETE EXISTING CRAWL - FOUNDATION WALL SPACE AND FOOTER MUDROOM FOUNDATION PLAN 4 NEW SUBFLOOP SCALE: 3/16" = 1'-0" And an and a second 2×8 LEDGER FASTENED 3 - NEW HSS 3.5×0.216" PIPE TO STUDS W/(2) RONG COL. DOWN TO EX. WIS 160 HAILS @ 16" O.C. BELOW (2)2×4 POST (TYP.) 2×10 RIDGE 1. 2×00160.0 IN CRICKET 122×84 -- 2xFL ON EX. RAFTERS FASTEN W/ 2-16 d NBILG 2×10RIDGE PER PAFTER -WIOX17 EX. ATTIC JOISTS AND PAFTERS -2×6 CIL O.C. PAFTERS (TYP. C DORMER) ARCHED RAFTERS @ 16" O.C. ---- 2×8 VALLEY (TTP RIP FROM 2X MATERIAL TO A DEPTH OF 51/2" MIN.


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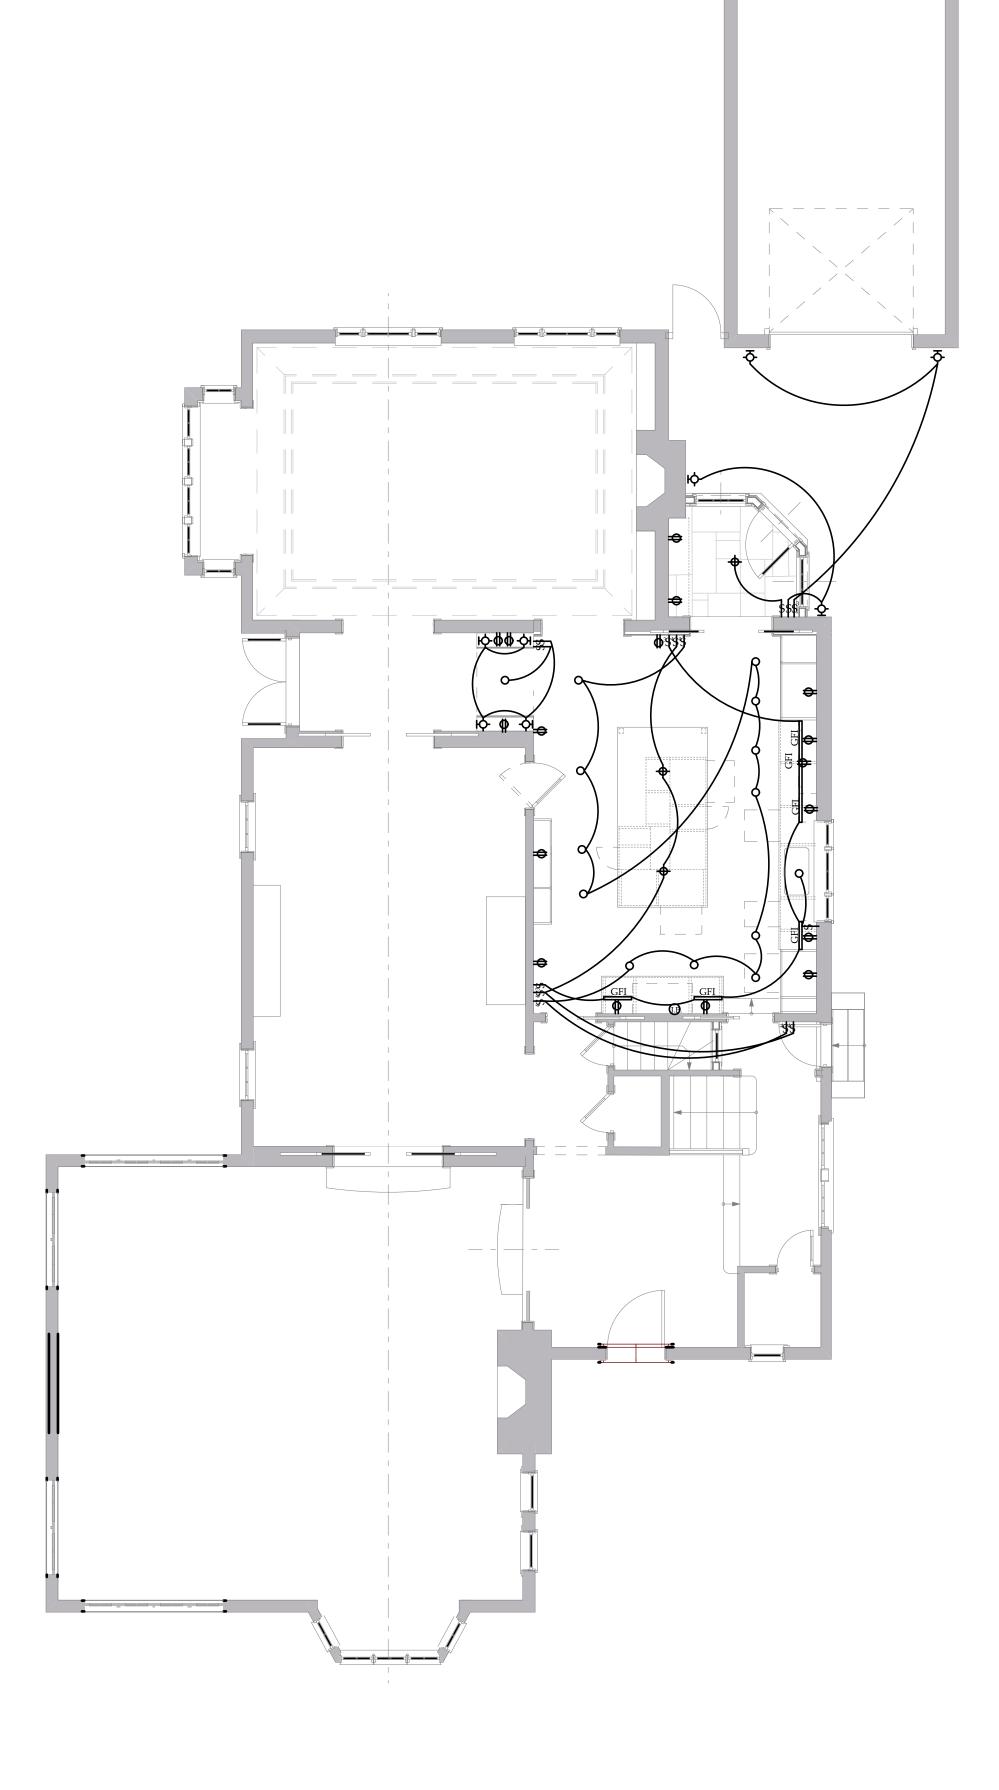
DORMER FRAMING PLAN SCALE: 3/16" = 1'-0"

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REVIEWED By Dan.Bruechert at 2:36 pm, May 27, 2021


10. 11. 12. 13. 14. 15. 16. 17. 18. 19. 20. 21. 22. 23. 24. 25. 26. 27. 28. 29. 30. 31. 32. 33. 34. 35. 36.



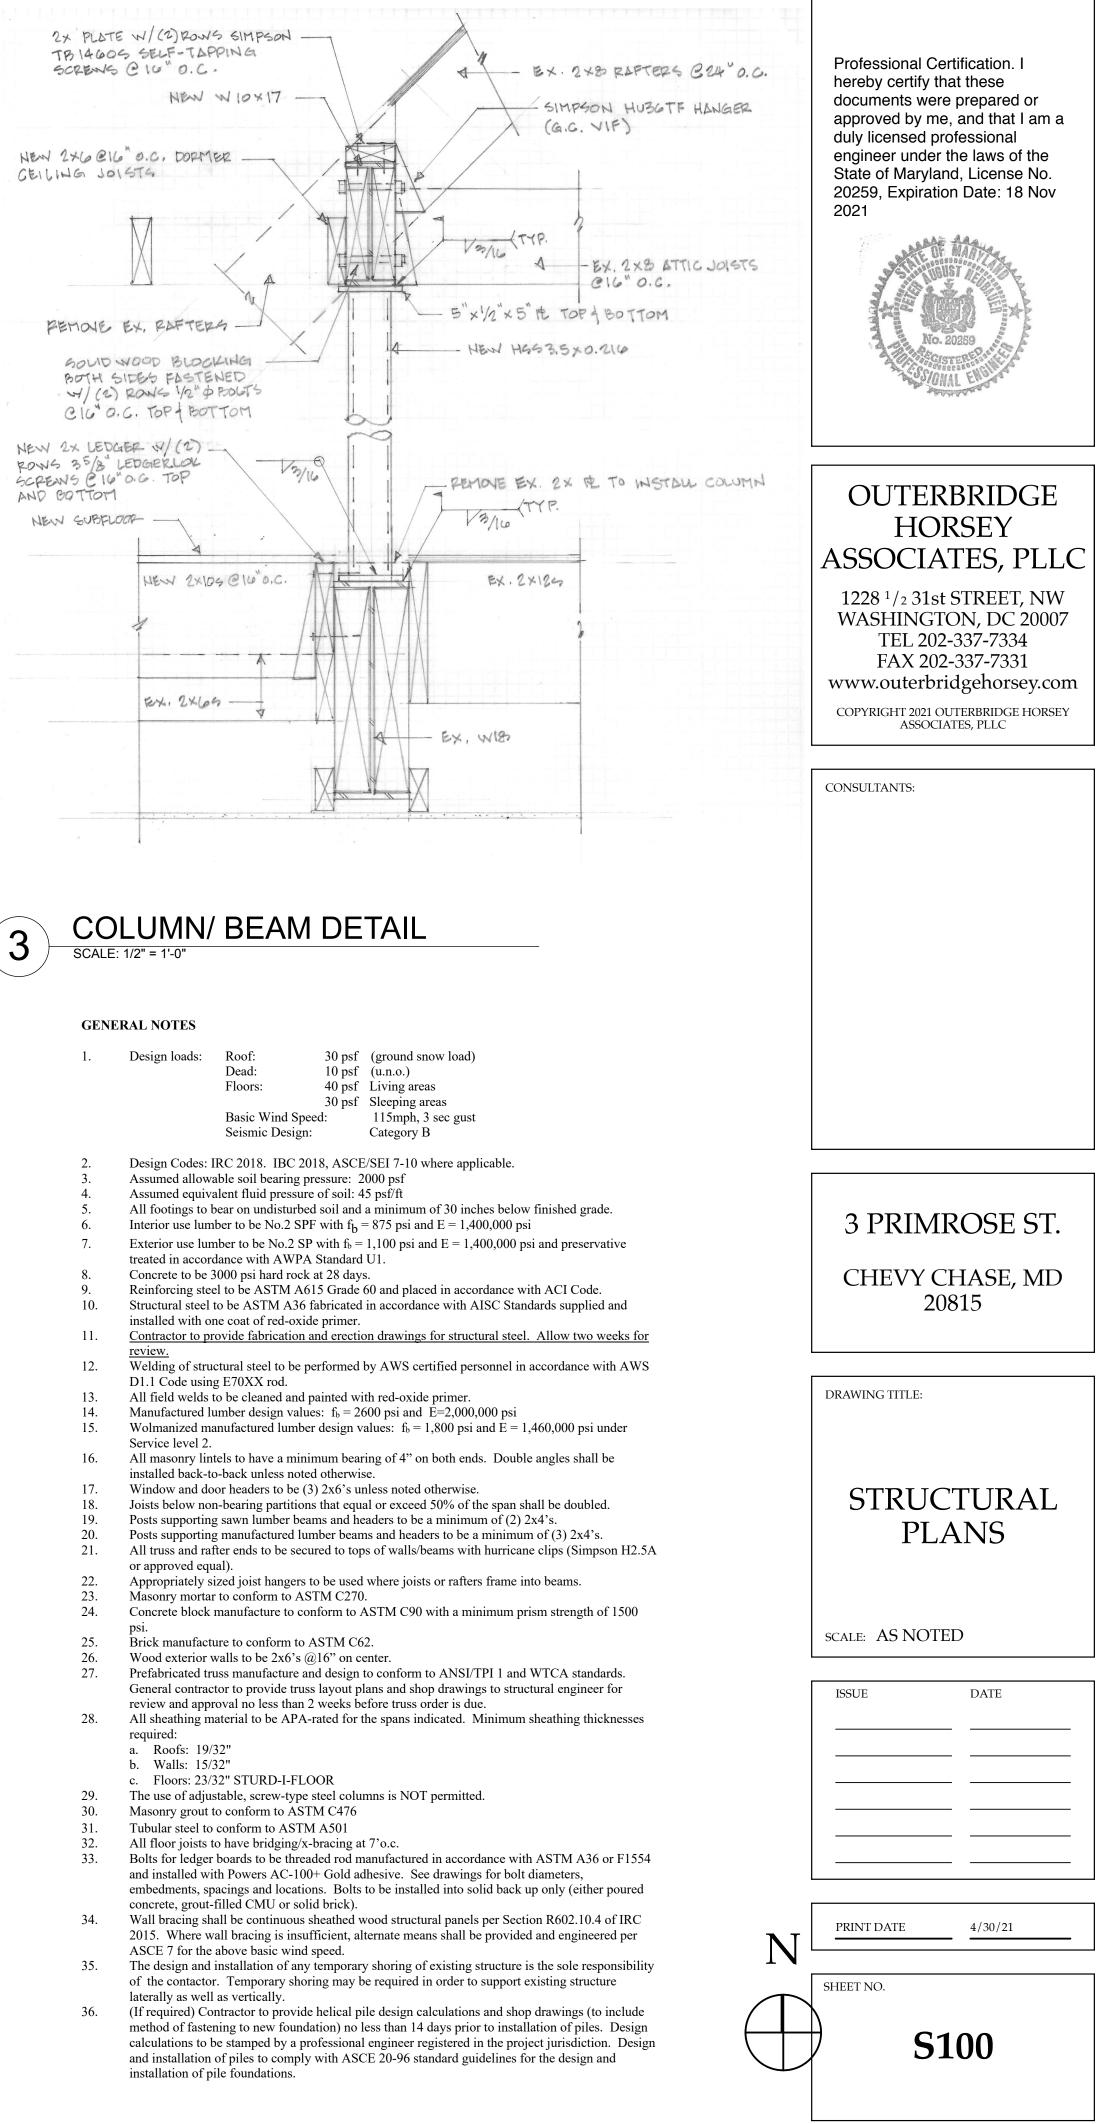

1 FIRST FLOOR ELECTRICAL PLAN (NEW WORK ONLY) SCALE: 3/16" = 1'-0"



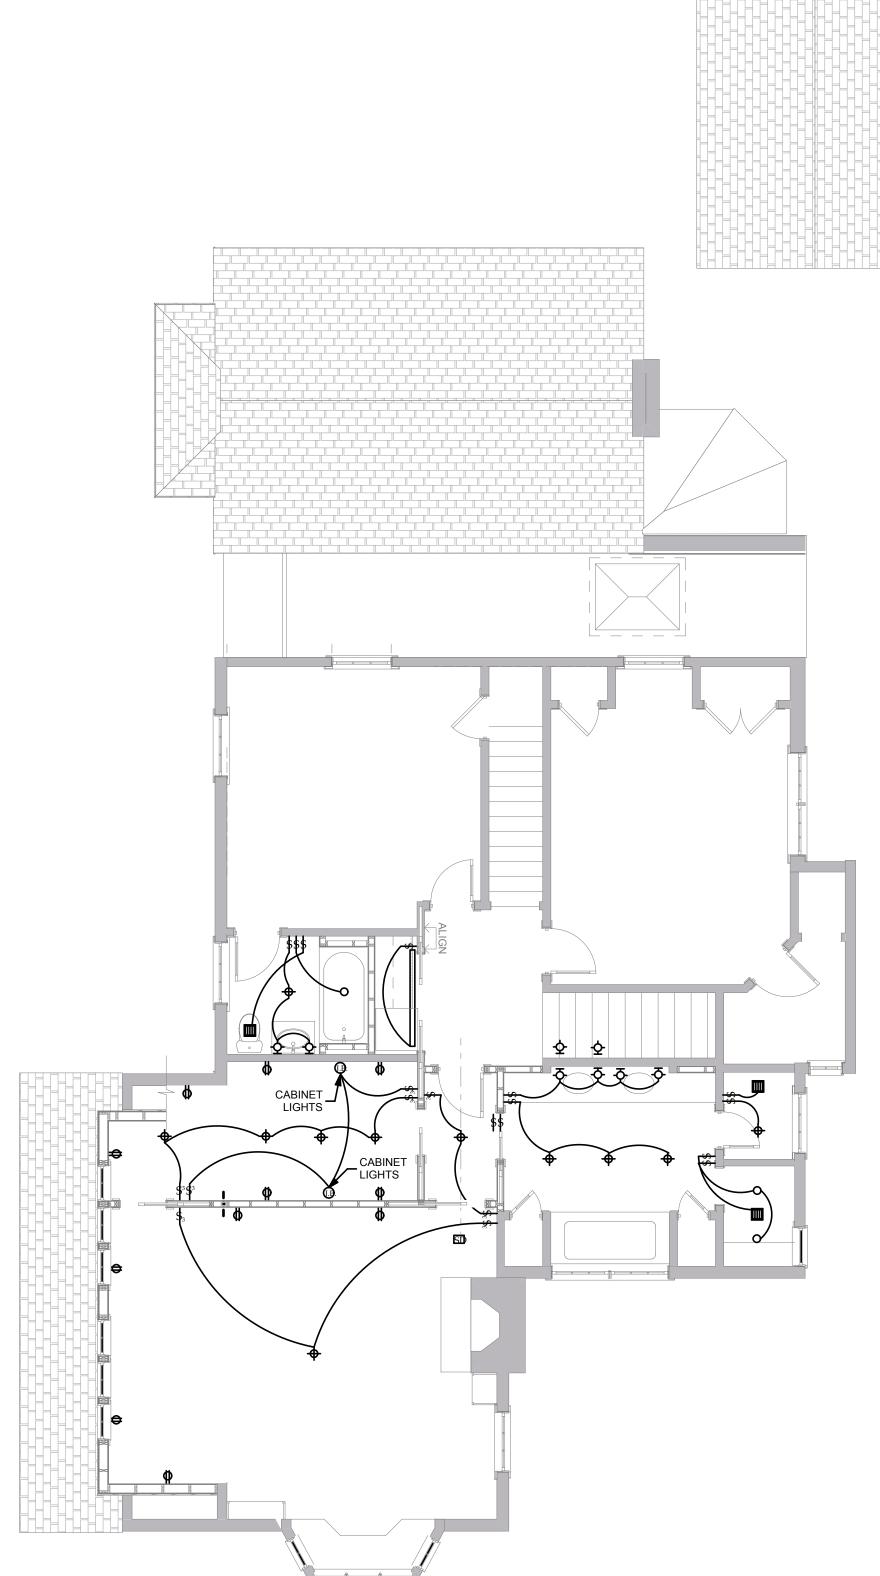

| ELECTRICAL SYMBOLS | | | | | |
|--------------------|--|-----------------|--------------|---|--|
| ⊕ | - DUPLEX FLOOR OUTLET | _ | _ | - UNDER-CABINET FIXTURE | |
| -0 | - SINGLE OUTLET | \triangleleft | 1 T | - TELEPHONE JACK | |
| € | - DUPLEX OUTLET | < | 1 F | - FAX JACK | |
| - | - HALF-SWITCHED OUTLET | < | 1 D | - DATA JACK | |
| GEI | - DUPLEX OUTLET ON GROUND
FAULT INTERRUPT | | 1 CAT | V - CABLE TV JACK | |
| ₩ 5 | - QUADRUPLEX OUTLET ON GROUND
FAULT INTERRUPT | · ዓ - | ф | - WALL SCONCE OR BRACKET
PER ARCHITECT | |
| £ | - WIRE COILED BEHIND WALL FOR
FUTURE USE | | φ- | - DECORATIVE SURFACE FIXTURE
PER ARCHITECT | |
| \$ _c | - LIGHTING CONTROL LOCATION AS
SCHEDULED | (| 0 | - RECESSED DOWNLIGHT OR
ACCENT LIGHT | |
| L1 | - LAMP DEBUZZING COIL AS SCHEDULED | 4 | \bigcirc | - RECESSED DOWNLIGHT-
WALLWASHER | |
| (B) | - HARD-WIRED JUNCTION | 4 | \Diamond | - CORNER WALL WASHER | |
| SD | - HARD-WIRED SMOKE DETECTOR | ~ | Q | - HALF WALL WASHER | |
| Т | - REMOTE TRANSFORMER AS REQUIRED | | | -FLUORESCENT OR LOW VOLTAGE
STRIPLIGHT | |
| В | - DOOR BELL | Ć | Ç | -SPOTLIGHT | |
| \bigcirc | - DECORATIVE PENDANT FIXTURE PER ARCHITECT | (| T | -THERMOSTAT | |
| $ \oplus\rangle$ | - SWING-ARM LAMP PER ARCHITECT | | | - EXHAUST FAN BY CONTRACTOR | |
| | - BOOKCASE LIGHT PER ARCHITECT | (| (WP) | -WATER PROOF | |
| | | | | | |


LIGHTING CONTROL SCHEDULE

SINGLE POLE DECORA-STYLE SWITCH \$₃ 3-WAY SWITCH

| | 13 | 0 1111 0 1111 011 | | | | |
|--|-----------------|-------------------|--------------------------------|--|--|--|
| | \$ 4 | 4-WAY SWITCH | | | | |
| | \$ _A | DV-600P-* | SINGLE POLE, 600W INCANDESCENT | | | |
| | \$ _B | DV-603P-* | 3-WAY, 600W INCANDESCENT | | | |
| | \$ _C | DV-103P-* | 3-WAY, 1000W INCANDESCENT | | | |
| | \$ _D | DVLV-10P-* | SINGLE 800W LOW VOLTAGE | | | |
| L | L1 | LDC-1.7-TCP | LAMP DEBUZZING | | | |
| | L2 | LDC-3.3-TCP | | | | |
| * COLOR TO BE SELECTED BY ARCHITECT
CATALOG NUMBERS ARE FOR LUTRON
EQUIPMENT | | | | | | |

APPROVED Montgomery County Historic Preservation Commission

MMEL. MATTA REVIEWED By Dan.Bruechert at 2:36 pm, May 27, 2021

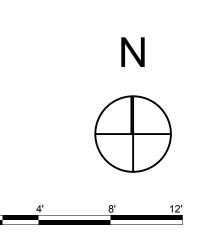



OUTERBRIDGE HORSEY ASSOCIATES, PLLC

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CONSULTANTS:

3 PRIMROSE ST.

CHEVY CHASE, MD 20815

DRAWING TITLE:



SCALE: AS NOTED

| ISSUE | DATE |
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5/3/21 PRINT DATE

SHEET NO.

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