

HISTORIC PRESERVATION COMMISSION

Marc Elrich
County Executive

Robert Sutton
Chairman

Date: August 9, 2023

MEMORANDUM

TO: Rabbiah Sabbakhan

Department of Permitting Services

FROM: Michael Kyne

Historic Preservation Section

Maryland-National Capital Park & Planning Commission

SUBJECT: Historic Area Work Permit: #1031400 - New accessory building, fence, and hardscape alterations.

The Montgomery County Historic Preservation Commission (HPC) has reviewed the attached application for a Historic Area Work Permit (HAWP). This application was **Approved with four (4) conditions** at the June 14, 2023 Historic Preservation Commission meeting.

Conditions:

- 1. The applicant shall submit all material specifications for the accessory building as outlined by staff on page 5 of this report.
- 2. The applicant shall submit all details and material specifications for the stone patio, concrete stairs, and drain bed as outlined in page 5 of this report.
- 3. The applicant shall submit all details and material specifications for the wood privacy fence as outlined in page 6 of this report.
- 4. The applicant shall submit a Tree Impact Assessment to the City of Takoma Park, forward the response to staff, and follow all recommendations and requirements of the urban forester.

The HPC staff has reviewed and stamped the attached construction drawings.

THE BUILDING PERMIT FOR THIS PROJECT SHALL BE ISSUED CONDITIONAL UPON ADHERENCE TO THE ABOVE APPROVED HAWP CONDITIONS AND MAY REQUIRE APPROVAL BY DPS OR ANOTHER LOCAL OFFICE BEFORE WORK CAN BEGIN.

Applicant: Justin & Catherine Ramsdell (Richard J. Vitello – Architect)

Address: 7310 Maple Avenue, Takoma Park

This HAWP approval is subject to the general condition that the applicant will obtain all other applicable Montgomery County or local government agency permits. After the issuance of these permits, the applicant must contact this Historic Preservation Office if any changes to the approved plan are made. Once work is complete the applicant will contact Michael Kyne at 301.563.3403 or michael.kyne@montgomeryplanning.org to schedule a follow-up site visit.



New Accessory Building, Hardscaping & Fence

Ramsdell Residence

7310 Maple Avenue, Takoma Park, MD 20912

By Michael Kyne at 1:48 pm, Aug 09, 2023


APPROVED Montgomery County Historic Preservation Commission Raluth / Willin

GENERAL CONSTRUCTION NOTES:

- 1. These drawings are to show only materials and layout of the design; means and methods are to be determined by contractor. The contractor shall fully acquaint him/herself with the conditions relating to construction and labor so that he/she understands the issues relating to the execution of the work.
- 2. Contractor shall provide all materials, labor and equipment and pay all freight charges, taxes, and handling of materials necessary for the full implementation of the work herein described on these drawings unless noted otherwise.
- 3. Contractor to verify all dimensions and assumed conditions in the field; bring any discrepancies, omissions, ambiguities or conflicts to the attention of the architect and owner as soon as possible before proceeding with any of this work in question.
- 4. Contractor to notify architect if any existing underground pipes (or any other relevant item) that are revealed by demolition and are scheduled to be removed or re-routed for the new plan are determined to be not easily moved, or removed.
- All construction will meet or exceed all applicable building and health codes, unless a code modification approval is granted.
- 6. The owner's written authorization will be required before any work is executed or materials ordered that involve a change from the original specifications affecting the
- 7. All plan dimensions on drawings are set to edge of framing members; all finishes are not taken into account unless otherwise noted. If dimension is taken to a finish surface, it shall be noted as "FINISH DIMENSION", "FIN. DIM.", or "CLEAR DIM.".
- 8. Solid blocking required under posts or any bearing from above to solid bearing below; match bearing area of post above to bearing below; cut bearing blocks to minimum 1/16" deeper than joists.

sill gasket underneath all sill plates.

- Install solid blocking in walls for receipt of hardware, cabinets, etc., as necessary. 10. All wood in contact with masonry/concrete surfaces shall be pressure-treated; install
- 11. Contractor shall not backfill against walls until supporting floors are securely in place; brace all walls until adequately supported by structure. Backfill of walls shall be performed by lightweight equipment, with a maximum of 1-ton total weight allowed within the critical zone (defined as beginning at the base of the wall and widening 1347 s.f. out from wall at a 1:1 slope (45-degree angle).
 - 12. New doors, windows and hardware, are to be provided and installed by contractor; verify window and door manufacturers' rough opening dimensions prior to framing.
- 13. If house-wrap and or building paper is used, apply and lap in a shingle-fashion so that upper courses lap over lower courses; any window and door flashing is integrated 432 s.f. into this system in the same manner. Apply Z-flashing at all heads and apply pan
- 1779 s.f. 14. All new wall surfaces are to be prepared for painting to be smooth and free of cracks; walls to be primed and painted (2 coats, min.) with color to be selected by owner, as 432 s.f.
 - 15. Install new hard-wired interconnected AC-powered smoke and CO detectors as per drawings and per code, as necessary.
 - 16. All electrical outlets at exterior to be ground fault circuit interrupters (GFCI); in all rooms, all-fault circuit interrupters (AFCI) to be installed.
 - 17. Electrical switches (dimmers, toggles, etc.), and telephone/modem to be approved by owner, installed by contractor. All decorative light fixtures to be selected by owner, installed by contractor.
 - 18. All recessed light enclosures and junction boxes installed in thermal/insulated ceilings shall be IC-rated for insulation contact and are to be sealed against air infiltration. Seal all openings in box with fire-rated foam (3M Fire Block Foam FB-Foam; meets ASTM E 84 Class 1).

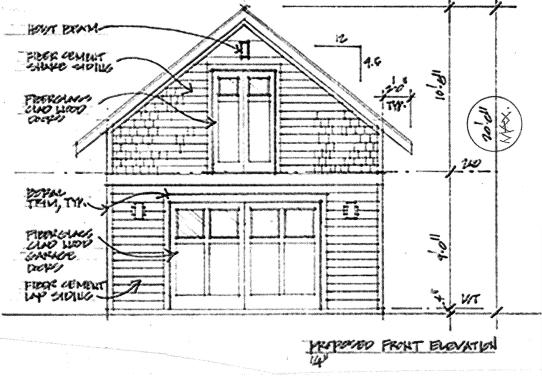

SPECIFICATIONS:

- 1. Exterior wall/roof sheathing: Huber Engineered Woods LLC, "Zip System" combination wall sheathing, water-resistive barrier, and air barrier, thicknesses as specified in drawings: 7/16" for wall sheathing, 5/8" for roof sheathing.
- 2. Lap Siding: HardiPlank Fiber Cement Primed Lap Siding; 7 1/2" (6" exposure) x 0.312" thickness; primed and pre-painted, UNO (unless noted otherwise). (Painted)

Cedar shakes, tapersawn, with a 1/2-inch minimum dimension on bottom of shake. 6-inch minimum exposure, stained or painted.

- 4. Exterior Trim: Boral poly-ash "TruExterior Trim", or HardieTrim Boards, 4/4 and 5/4 NT3
- 5. Trim Accessories: Azek PVC (drip caps, rake moulding, etc.) (Painted)
- 6. Undersoffit/Porch Ceiling: Boral "TruExterior Beadboard"; 5/8" x 6 x 16'. (Painted)
- 7. Roofing: 40-year CertainTeed Architectural asphalt shingles. Color TBD.
- 8. Garage Doors, Upper Floor Exterior Doors & Side Entry Door: RealCraft Carriage Doors, all wood doors (see Window & Door schedule for sizes, etc.), or equivalent
- 9. Windows: Marvin Elevate windows (see Window & Door schedule for sizes, etc.)
- 10. Lighting Fixtures (flanking each side of garage doors): Lumens "Lighthouse Wall Lantern", by Generation Lighting (small size).
- 11. Lighting Fixture (over side entry door): Kichler "Pier Outdoor Wall Light", Finish: "Olde
- 12. Linear Trench Drain: Trenchify 6" wide NDS Duraslope HDPE Grate Trench Drain, Model #NDL150-661-32. 32'-0" long; Color #661-Gray; pre-slope channels, or equi

All other selections by owner and/or architect TBD.

Sheet No. Sheet Title

Cover Site Plan/Project Description / General Notes

C-1 Drainage Plan (1"=10'-0")

A-1 1st Floor Plan $(1/4"=1'-0")/2^{nd}$ Floor Plan (1/4"=1'-0") Roof Plan (1/4"=1'-0")Electrical & Lighting Legend

A-2 Exterior Elevations (1/4"=1'-0")/

A-3 Building Sections (1/4"=1'-0")/ Wall Section @ Side (1"=1'-0")

A-4 Window & Door Schedule/ Rake Detail Section (1"=1'-0")

EC-1 Air Barrier, Insulation & Thermal Barrier Schedule And Diagrams

S-000 Calculations/Structural Notes

S-100 Foundation, 2nd Floor & Roof Framing Plans (1/4"=1'-0")

S-200 Wind Brace Plans & Schedule

Ramsdell Res 7310 Maple Av Takoma Park, l

COVER

Project Information: "Contributing Resource" property in the Takoma Park Historic District; construct new 2-story Garage with 432 s.f. footprint in rear yard. Install new 728 SF stone/concrete patio at rear yard adjacent to new Garage HAWP (#1031400) approved at HPC meeting on 6/14/23.

Address: 7310 Maple Ave., Takoma Park, MD 20912

13 72° 70 00 1 1 268 42.00

MAPLE AVE.

Residential Code Information:

Site Plan

House/Site Information:

Year built: 1888

Historic District: Takoma Park

Zoning: R-60

Block: 5

1" = 20'-0"

Lot: 19

All construction shall be in conformance with the International Residential Code (IRC), 2018 Edition, as Amended by Mont. Co., Reg. 31-19, adopted 5/20/2020.

% of Lot Coverage:

PROPOSED (net, after garage built):

(Garage): (House + Garage): % of Lot Coverage:

TOTAL NET NEW ROOF AREA:

AREA CALCULATIONS

EXISTING:

Lot Area: Lot Coverage/Building Area (House):


18,400 s.f.


7.3%


9.6%

Lot Coverage/Building Area

Lot Coverage/Building Area

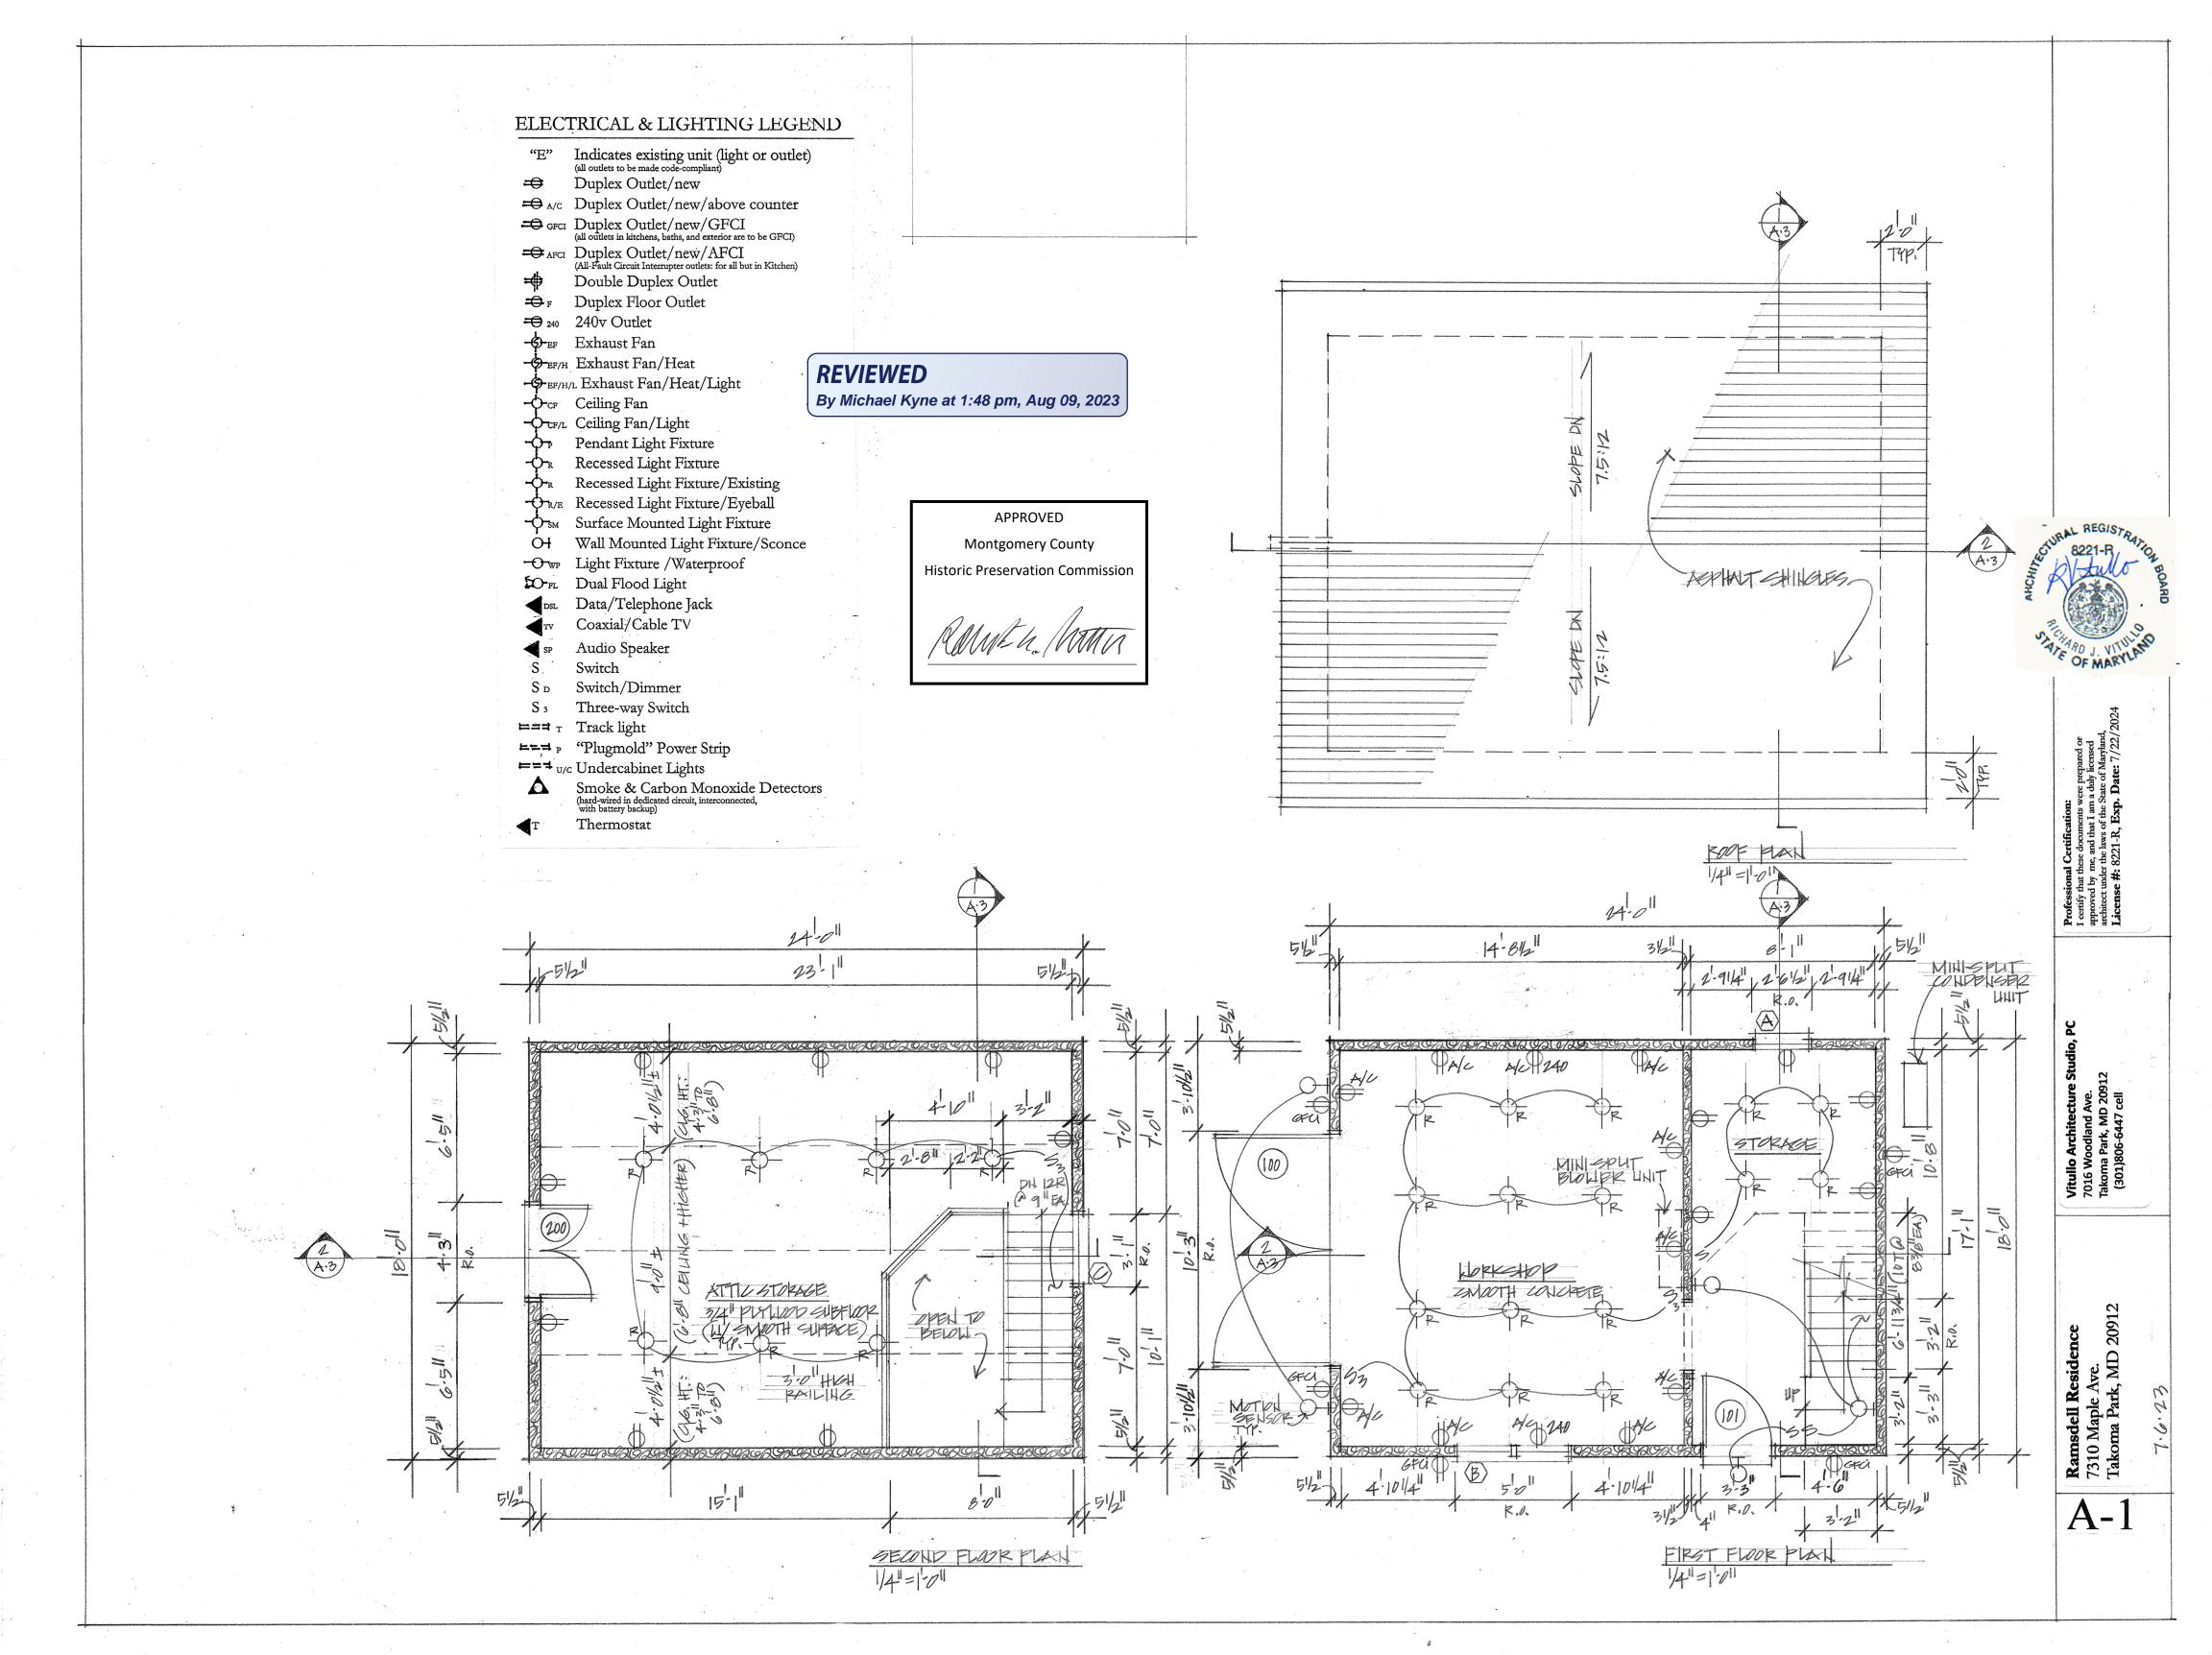

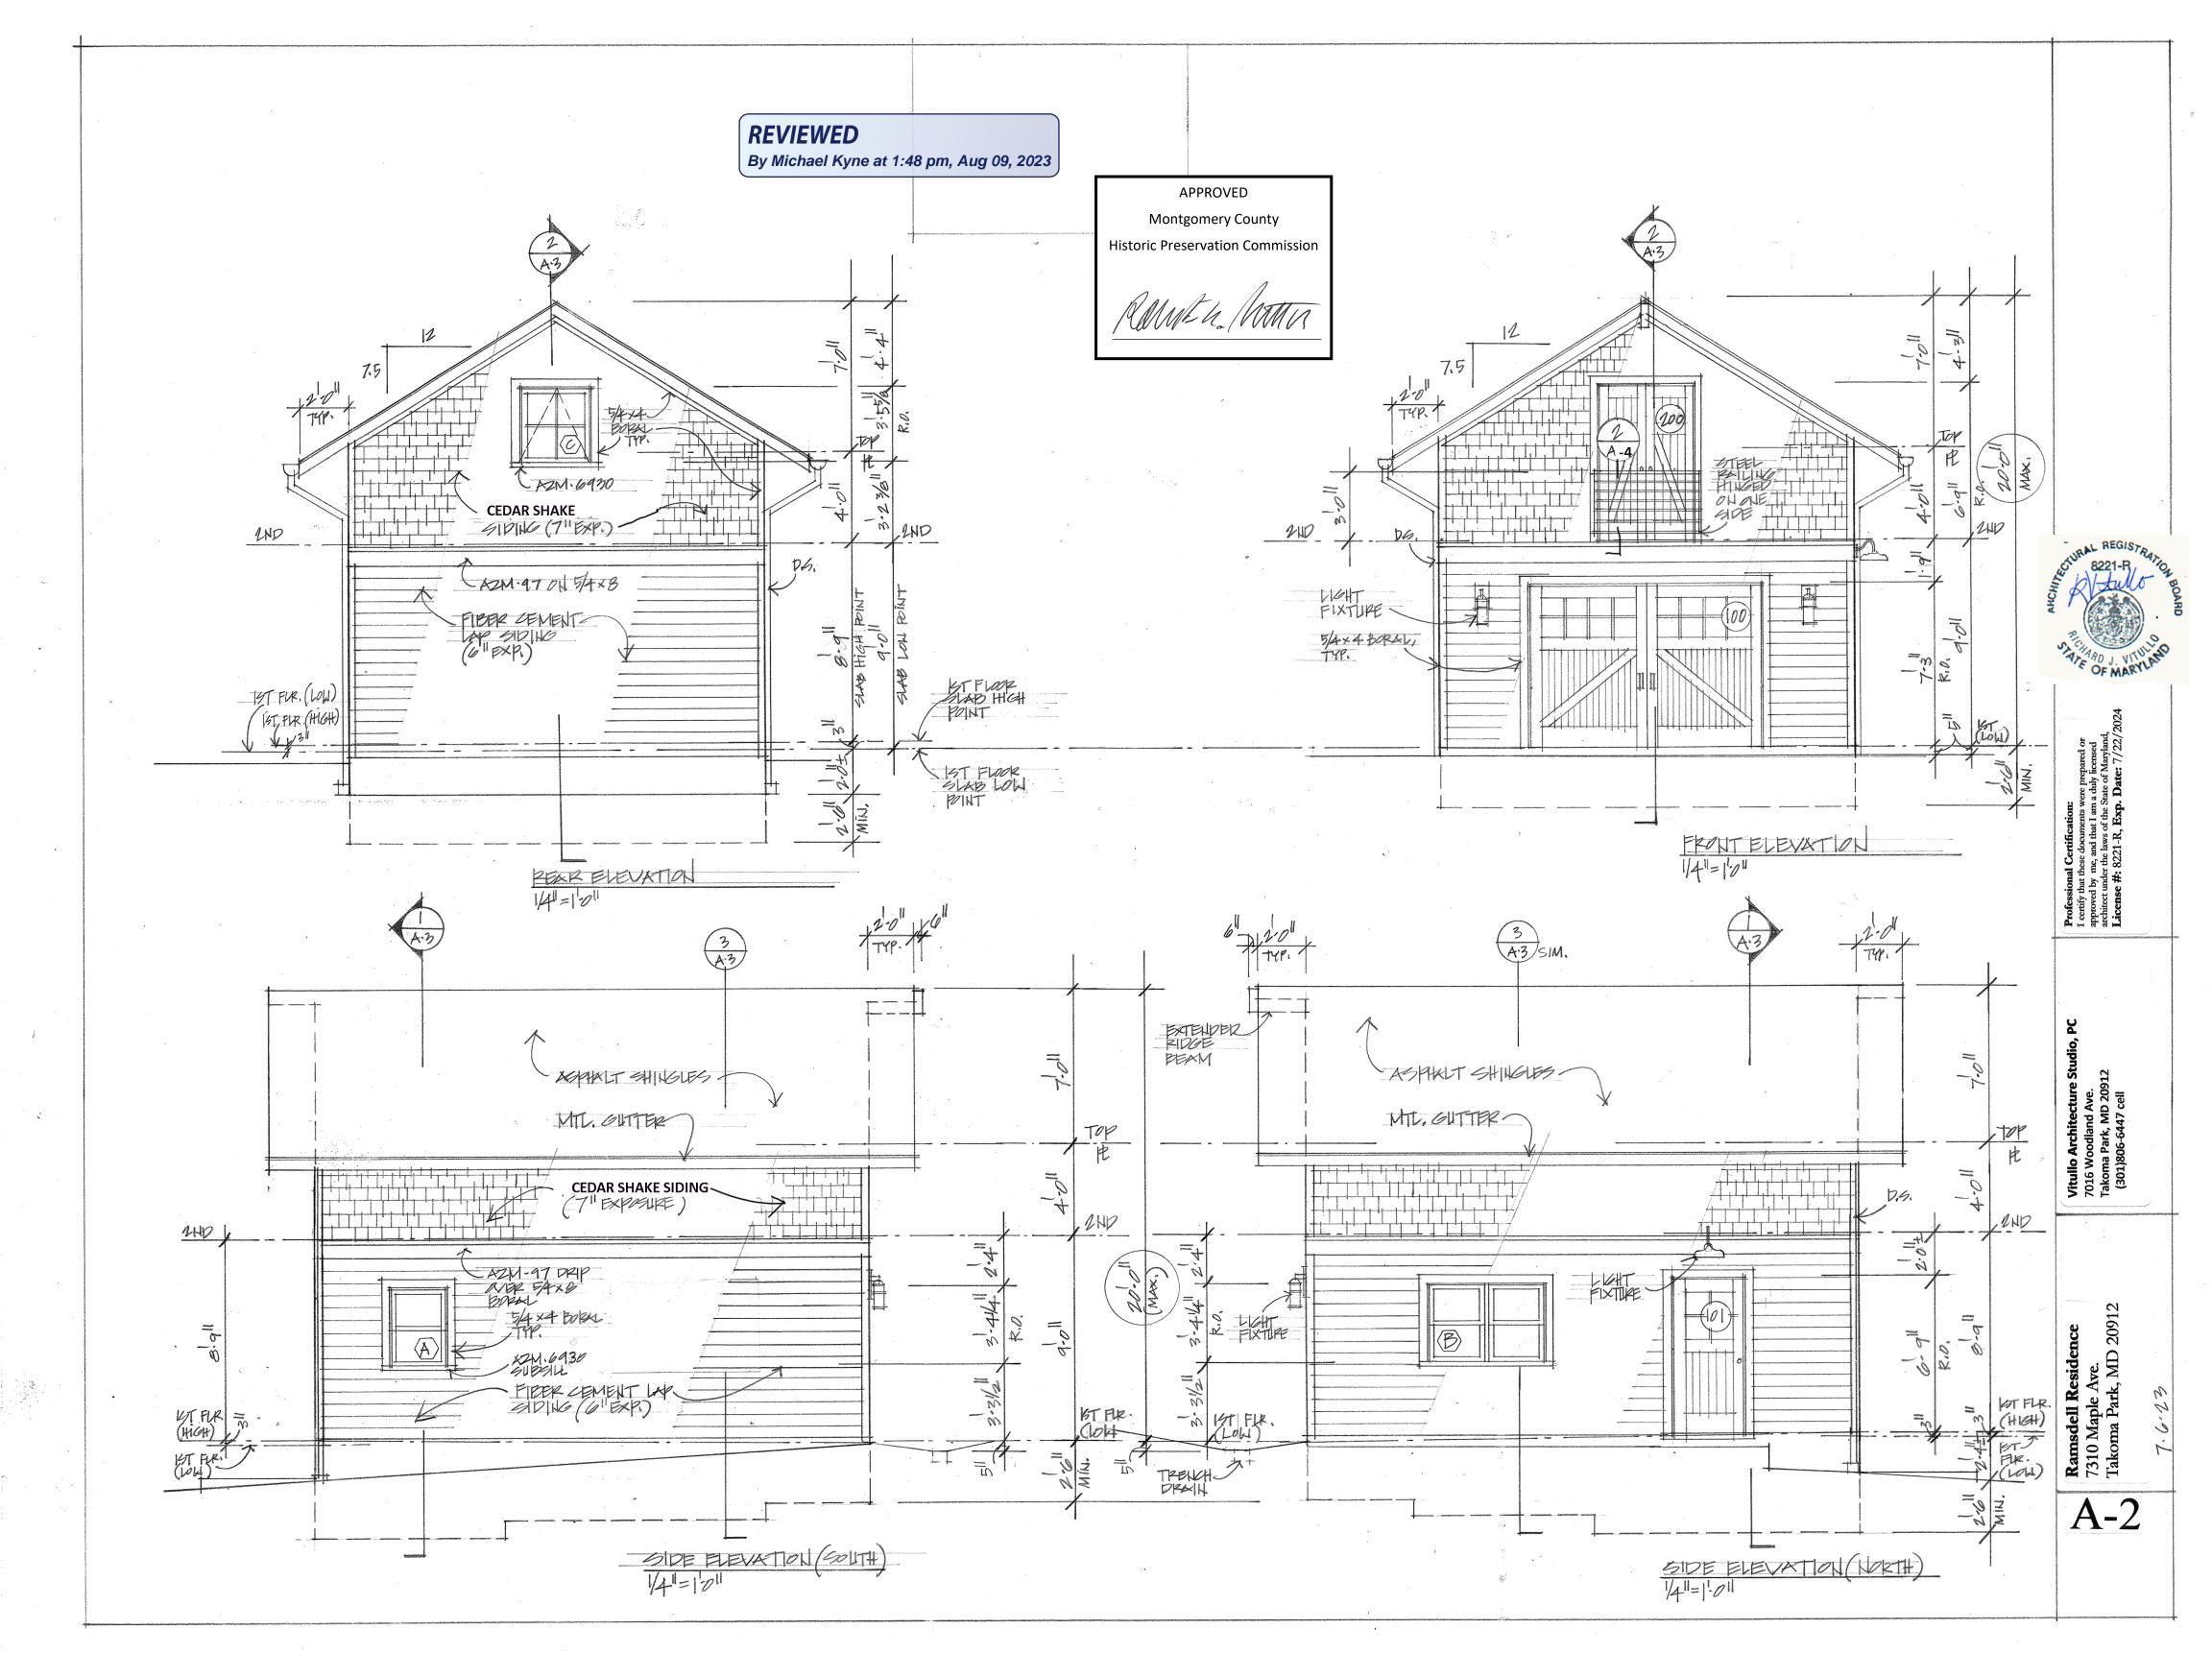

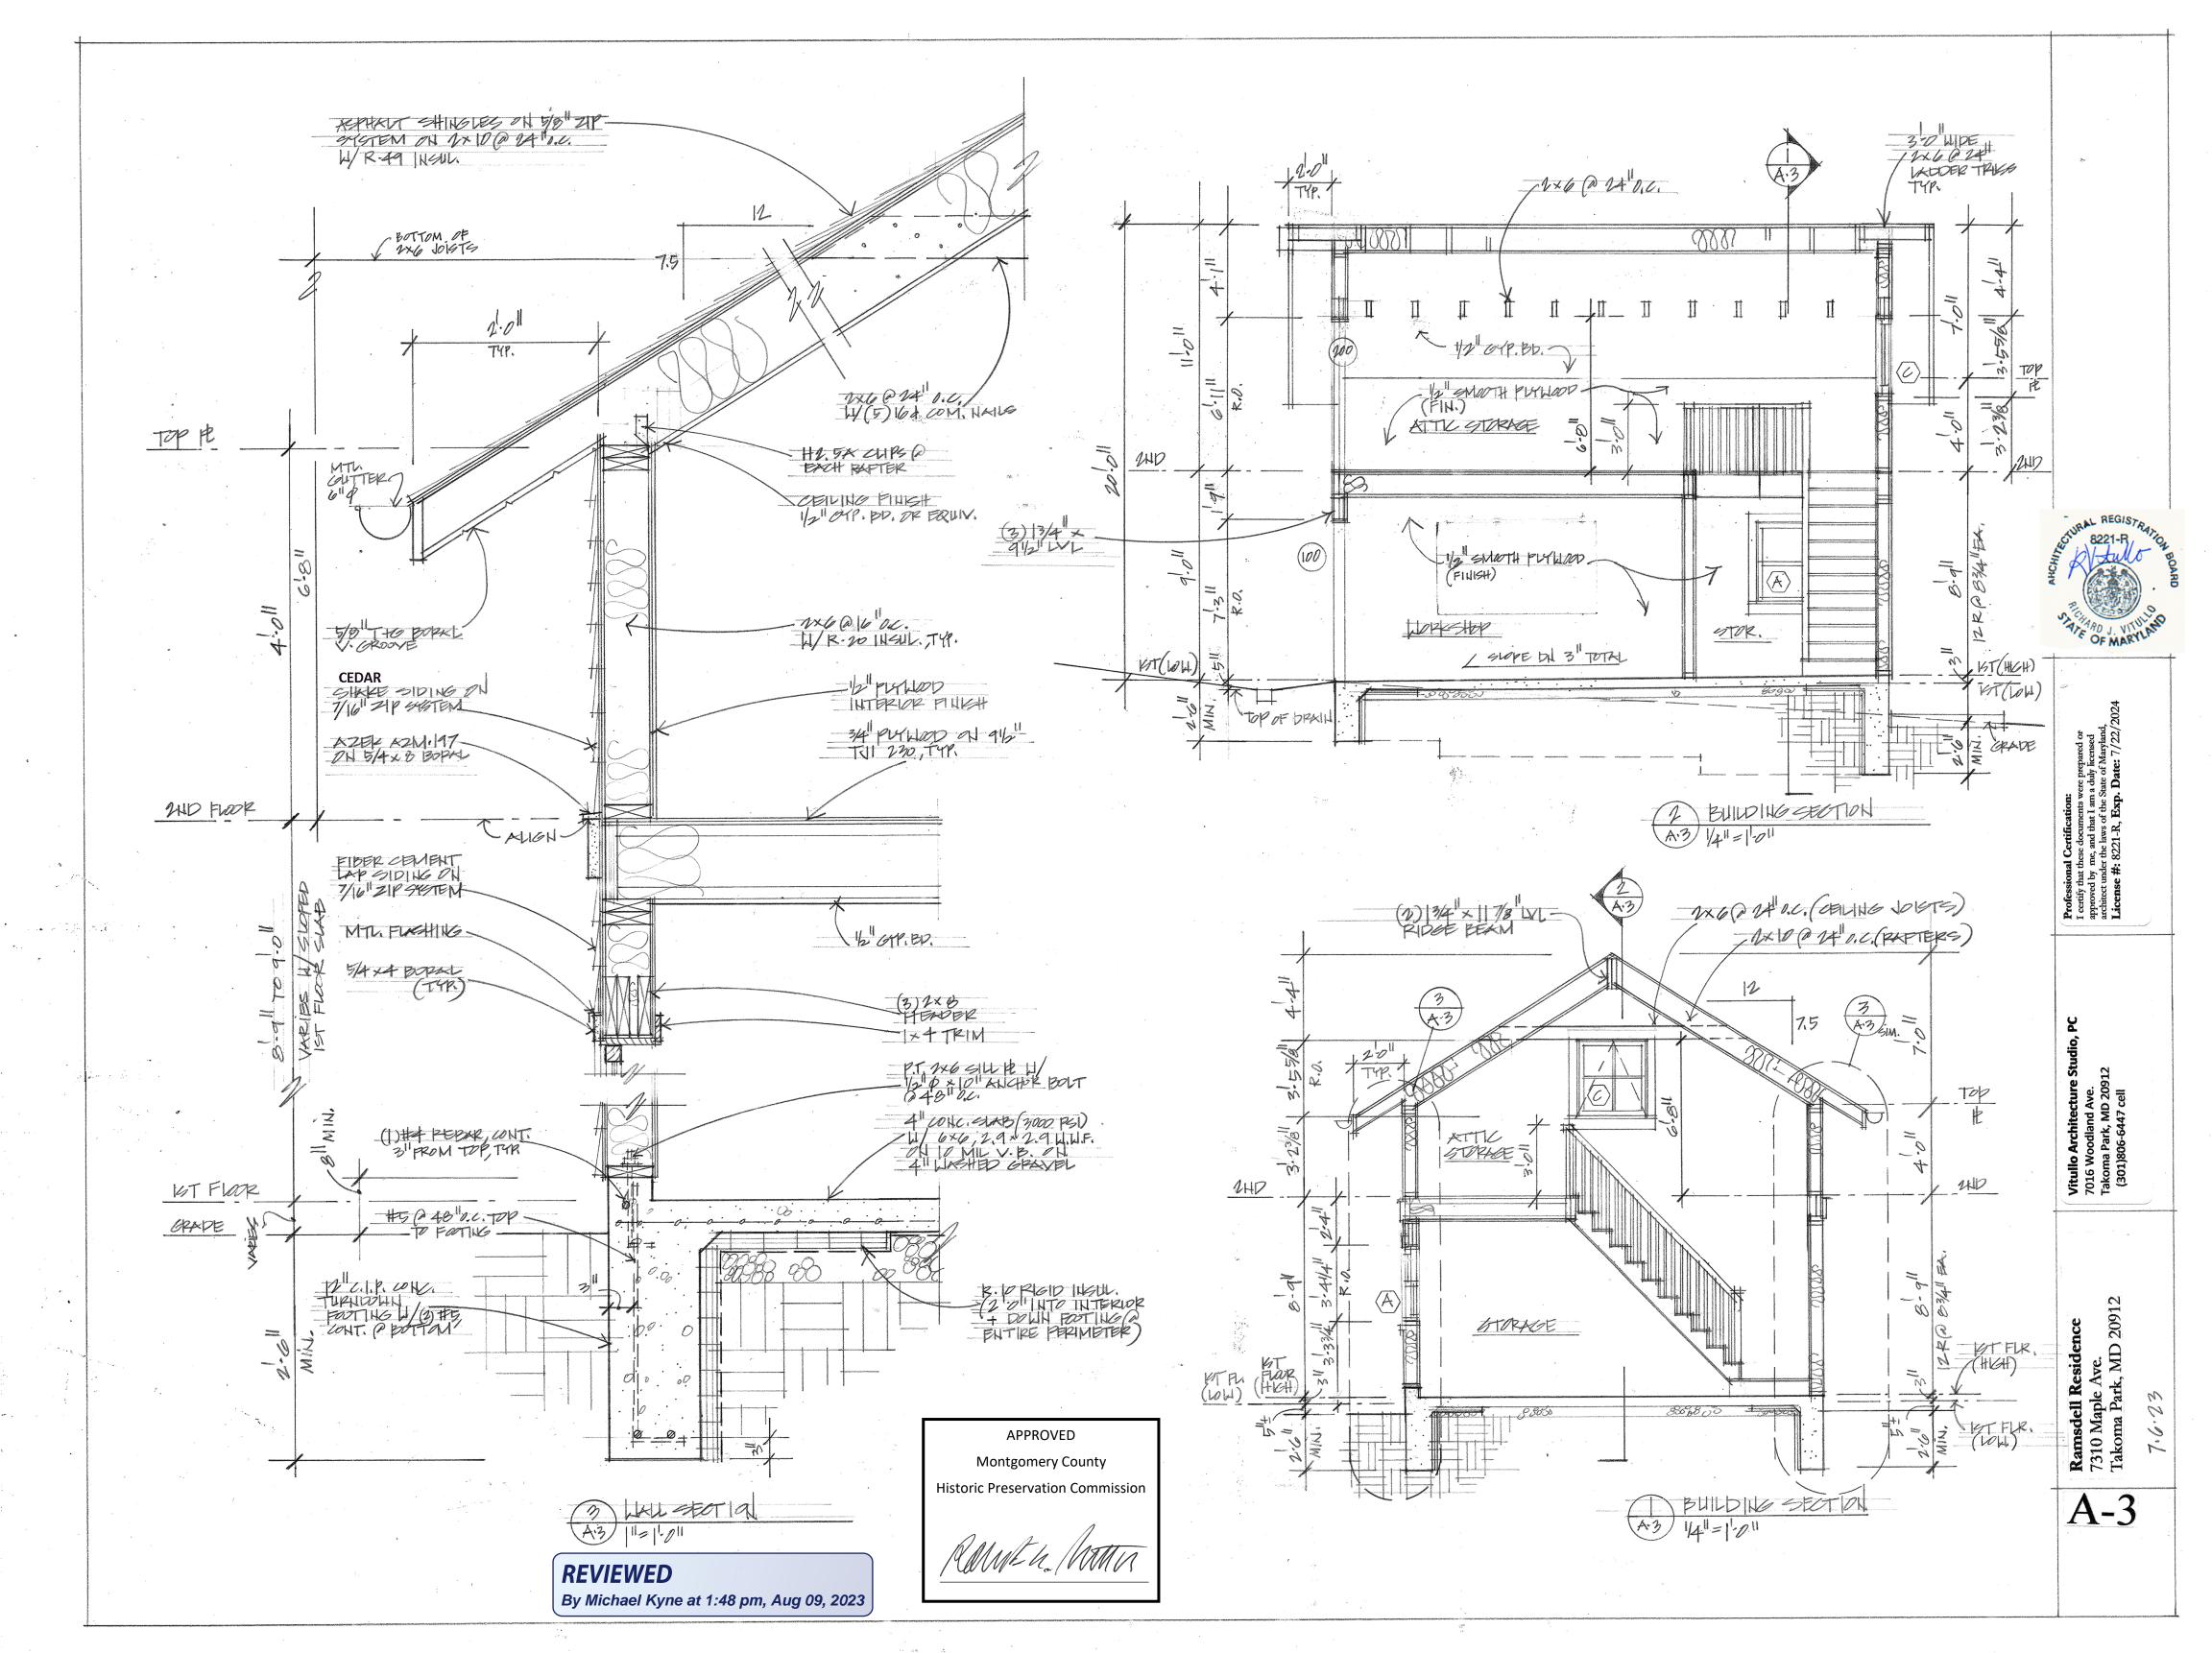

	WINDOW SCHEDULE Mfr. Window Line/ Model			. A.		Manufacturer-	Windows:	Marvin Ele	vate							
No.	Mfr. Window Line/ Model No.	Height, Unit (R.O.)	Width, Unit (R.O.)	Jamb Depth	Window Type/Material	Glazing Type	Grille Structure	Mullion Divisions	Interior Color	Exterior Clad Color	Screens / Screen Door	Hardware	SHGC- value Total Unit	U-value Total Unit	Egress window	Quant.
Α	Elevate ELDH 3040	3'-3 3/4" (3'-4 1/4" R.O.)	2'-5 1/2" (2'-6 1/2" R.O.)	2 X 6 wall	DOUBLE HUNG /wood interior & fiberglass-clad exterior	TEMPERED 11/16" Insulating glass Low E2 w/ Argon	none	none	White	White	YES	TBD	0.27	0.27	n/a	1
В	Elevate ELDH 3040 2W	3'-3 3/4" (3'-4 1/4" R.O.)	4'-11" (5'-0" R.O.)	2 X 6 wall	DOUBLE HUNG /wood interior & fiberglass-clad exterior	TEMPERED 11/16" Insulating glass Low E2 w/ Argon	none	none	White	White	YES	TBD	0.27	0.27	n/a	1 pair
С	Elevate ELAWN 3739	3'-3 1/8" (3'-5 5/8" R.O.)	3'-0" (3'-1" R.O.)	2 X 6 wall	AWNING /wood interior & fiberglass- clad exterior	TEMPERED 11/16" Insulating glass Low E2 w/ Argon	7/8" SDL	4 lites	White	White	YES	TBD	0.27	0.27	n/a	1
SUBTOTAL						•							0.28 avg.	0.27 avg.		3 units
	DOOR SCHEDULE					Manufacturer- Doors: TBD										
No.	Mfr. No.	Height, Unit (R.O.)	Width, Unit (R.O.)	Jamb Depth	Door Type / Material	Glazing Type	Grille Structure	Mullion Divisions	Interior Color	Exterior Clad Color	Screens / Screen Door	Hardware/ Sill Material	SHGC-value Total Unit	U-value Total Unit	Swing direction (shown from outdside room)	Quant.
100	TBD	7'-0" (7'-1" R.O.)	Pair of 5'-0" (10'-2" R.O.)	2 x 6 wall	OUTSWING Garage Doors	TEMPERED Clear Glass	n/a	8 lites each door	TBD	Paintable (TBD)	n/a	TBD	0.27	0.28	n/a	1 pair
101	TBD	7'-0" (7'-1" R.O.)	3'-0" (3'-2 1/2" R.O.)	2 x 6 wall	INSWING Door	n/a	n/a	4 lites	TBD	Paintable (TBD)	n/a	TBD	n/a	n/a	n/a	1
200	TBD	6'-8" (6'-9" R.O.)	Pair of 2'-0" (4'-2" R.O.)	2 x 6 wall	INSWING Upper Barn Doors	n/a	n/a	none	TBD	Paintable (TBD)	n/a	TBD	n/a	n/a	Left Hand	1 pair
SUBTOTALS										<u> </u>			0.28 avg.	0.28 avg.		3 units
TOTALS							1						1	0.27 avg.		6 units

STATE OF MARYLAND

REVIEWED


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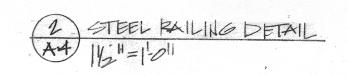
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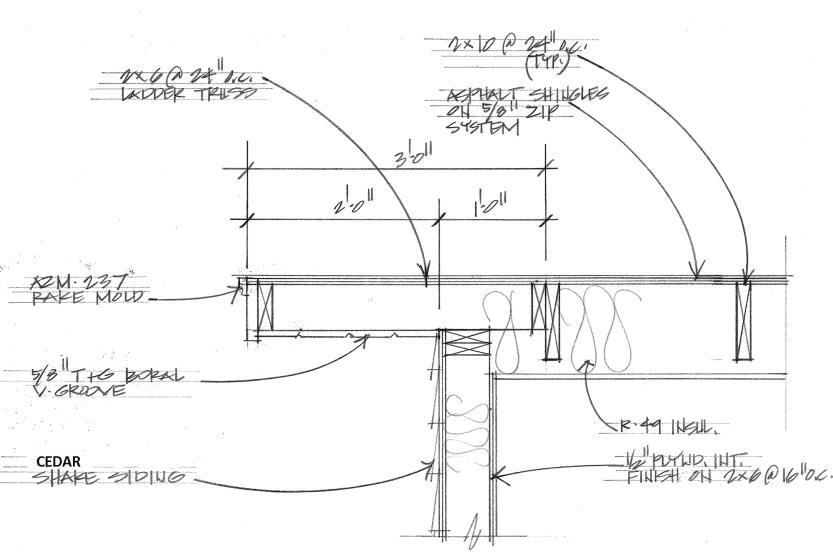
Montgomery County

Historic Preservation Commission

Rame La Manus





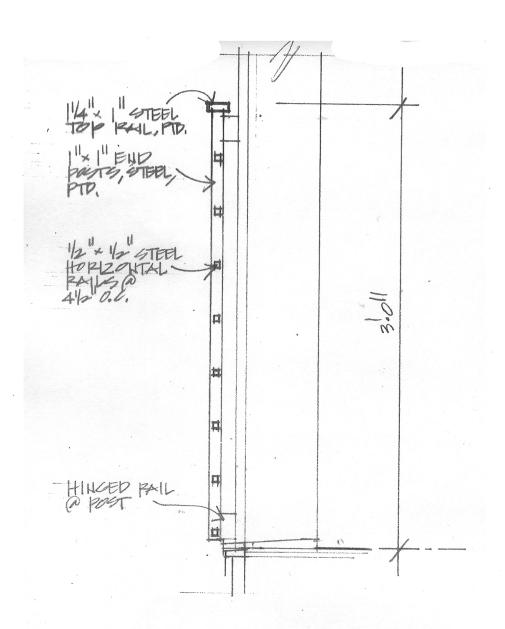

PAKE DETAIL SECTION

Professional Certification:

I certify that these documents were prepared or approved by me, and that I am a duly licensed architect under the laws of the State of Mayland I architect under the laws of the State of Mayland

Vitulio Architecture Studio, PC 7016 Woodland Ave. Takoma Park, MD 20912 (301)806-6447 cell

Ramsdell Residence 7310 Maple Ave. Takoma Park, MD 20912

A-4

