

#### HISTORIC PRESERVATION COMMISSION

Marc Elrich
County Executive

Robert K. Sutton Chairman

Date: December 22, 2023

#### **MEMORANDUM**

TO: Rabbiah Sabbakahn, Director

Department of Permitting Services

FROM: Michael Kyne

**Historic Preservation Section** 

Maryland-National Capital Park & Planning Commission

SUBJECT: Historic Area Work Permit #1039884 - Rear Alterations, Door Replacement, &

Hardscape alterations.

The Montgomery County Historic Preservation Commission (HPC) has reviewed the attached application for a Historic Area Work Permit (HAWP). This application was **Approved** at the September 6, 2023 HPC meeting

The HPC staff has reviewed and stamped the attached construction drawings.

THE BUILDING PERMIT FOR THIS PROJECT SHALL BE ISSUED CONDITIONAL UPON ADHERENCE TO THE ABOVE APPROVED HAWP CONDITIONS AND MAY REQUIRE APPROVAL BY DPS OR ANOTHER LOCAL OFFICE BEFORE WORK CAN BEGIN.

Applicant: Clark Pettig & Liz Pardue Address: 99 Elm Ave., Takoma Park

This HAWP approval is subject to the general condition that the applicant will obtain all other applicable Montgomery County or local government agency permits. After the issuance of these permits, the applicant must contact this Historic Preservation Office if any changes to the approved plan are made. Once work is complete the applicant will contact Michael Bruechert at 301.563.3408 or dan.bruechert@montgomeryplanning.org to schedule a follow-up site visit.



# Pardue/Pettig Residence

99 Elm Avenue, Takoma Park, MD 20912

Sheet No. Sheet Title

**Demolition Notes** 

**A-3** Wall Section (1"=1'-0")/

Finish Schedule

M/E/P Notes

Specifications

Cover Site Plan/Project Description /

Electrical & Lighting Legend

DM-1 Basement Demolition Plan (1/4"=1'-0")/

Basement Floor Plan (1/4"=1'-0")/

2<sup>nd</sup> Floor Bath Elevations (3/8"=1'-0")

Basement Bath Elevations (3/8"=1'-0")

2nd Floor Plan (1/4"=1'-0")/

Building Sections (1/4"=1'-0")

EC-1 Air Barrier, Insulation & Thermal Barrier

2<sup>nd</sup> Floor Wind Brace Plan & Schedule

Structural Specifications, Drawing Index &

Foundation & 1<sup>st</sup> Floor Framing Plan (1/4"=1'-0")

2<sup>nd</sup> Floor & Roof Floor Framing Plan (1/4"=1'-0")/

A-2 Exterior Elevations (1/4"=1'-0")/


Window & Door Schedule

A-5 General Construction Notes

Schedule/ Diagrams

Structural Calculations


2nd Floor Demolition Plan (1/4"=1'-0")/

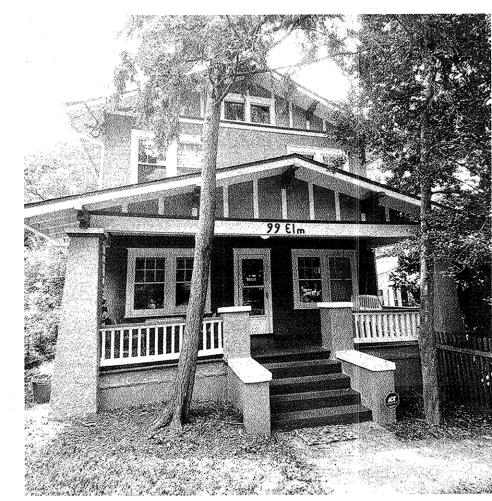



Pardue/Pettig Residence 99 Elm Ave. Takoma Park, MD 20912

**COVER** 

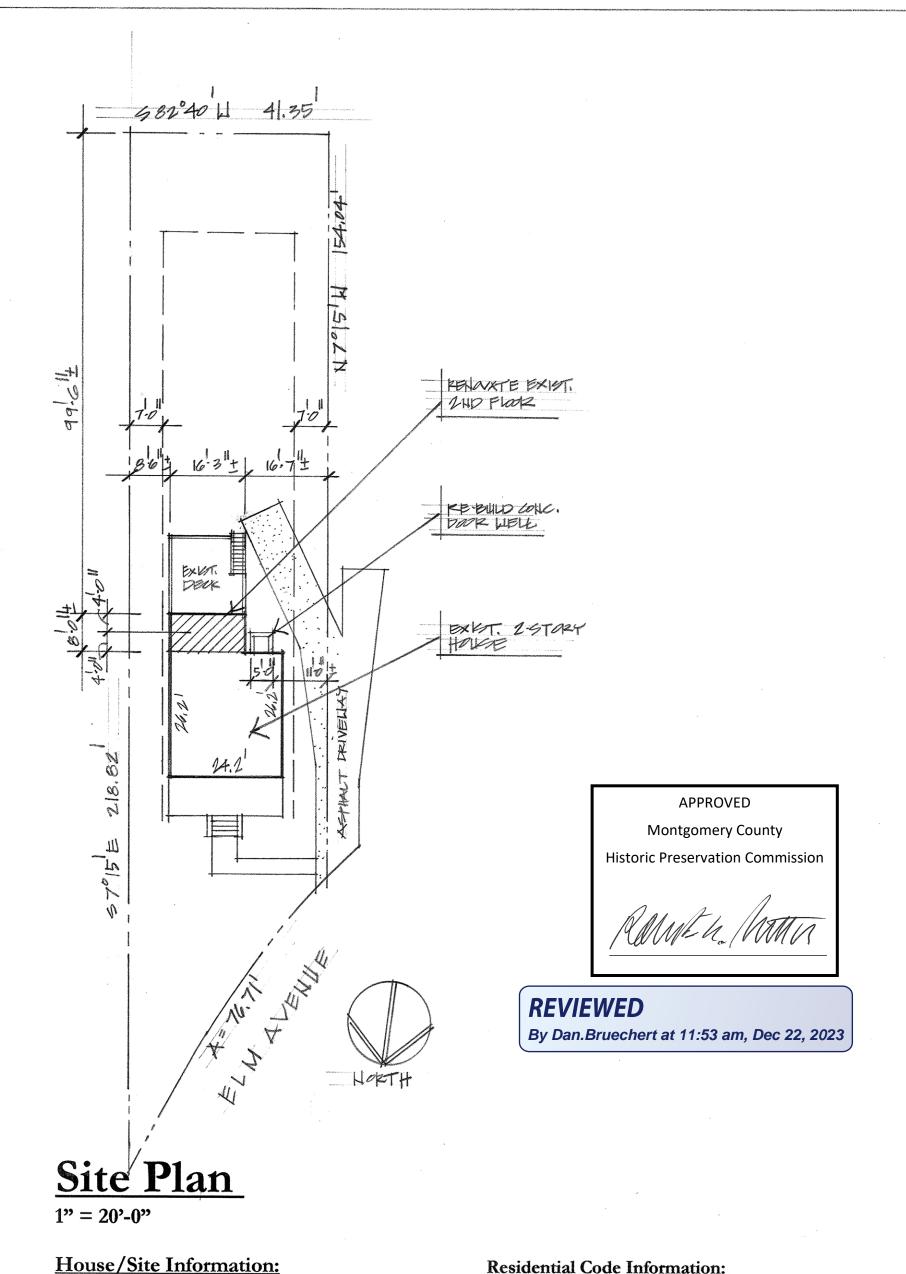

## **Residential Code Information:**

All construction shall be in conformance with the International Residential Code (IRC), 2018 Edition, as Amended by Mont. Co., Reg. 31-19, adopted 5/20/2020.

## **AREA CALCULATIONS**

## **EXISTING:**

7643 s.f. Lot Area: Lot Coverage/Building Area: % of Lot Coverage: 12.3%

#### **PROPOSED:**

Lot Coverage/Building Area (net gain):

# 946 s.f.

0 s.f.

# === u/c Undercabinet Lights

Thermostat

Smoke & Carbon Monoxide Detectors (hard-wired in dedicated circuit, interconnected, with battery backup)

# ELECTRICAL & LIGHTING LEGEND

Indicates existing unit (light or outlet) (all outlets to be made code-compliant)

Duplex Outlet/new

A/c Duplex Outlet/new/above counter

GFCI Duplex Outlet/new/GFCI (all outlets in kitchens, baths, and exterior are to be GFCI)

AFCI Duplex Outlet/new/AFCI (All-Fault Circuit Interrupter outlets: for all but in Kitchen)

Double Duplex Outlet

Duplex Floor Outlet

240v Outlet Exhaust Fan

Эег/н Exhaust Fan/Heat

Фег/н/L Exhaust Fan/Heat/Light

Ceiling Fan

Фсг/L Ceiling Fan/Light

Pendant Light Fixture

Recessed Light Fixture

Recessed Light Fixture/Existing

\*\*Recessed Light Fixture/Eyeball

Surface Mounted Light Fixture

Wall Mounted Light Fixture/Sconce

Owp Light Fixture / Waterproof

Dual Flood Light

Data/Telephone Jack

Coaxial/Cable TV

Audio Speaker

Switch Switch/Dimmer

S 3

Three-way Switch

⊨== т Track light

=== P "Plugmold" Power Strip

TOTAL: 754 s.f.

Total renovation S.F., by floor:

**Basement:** 

1<sup>st</sup> floor:

2<sup>nd</sup> floor:

Block: 16

Subdivision: B.F. Gilbert's Addition to Takoma Park

Address: 99 Elm Ave., Takoma Park, MD 20912

**Basement:** Renovate existing 624 SF basement.

2<sup>nd</sup> floor: Renovate existing 130 SF rear addition; add

HAWP (#1039884) approved at HPC meeting on 9/6/23.

0 s.f.

130 s.f.

Year built: 1920

Historic District: Takoma Park


new full Bathroom.

Zoning: R-60

**Project Information:** 

1<sup>st</sup> Floor: No work.


**Lot:** 84

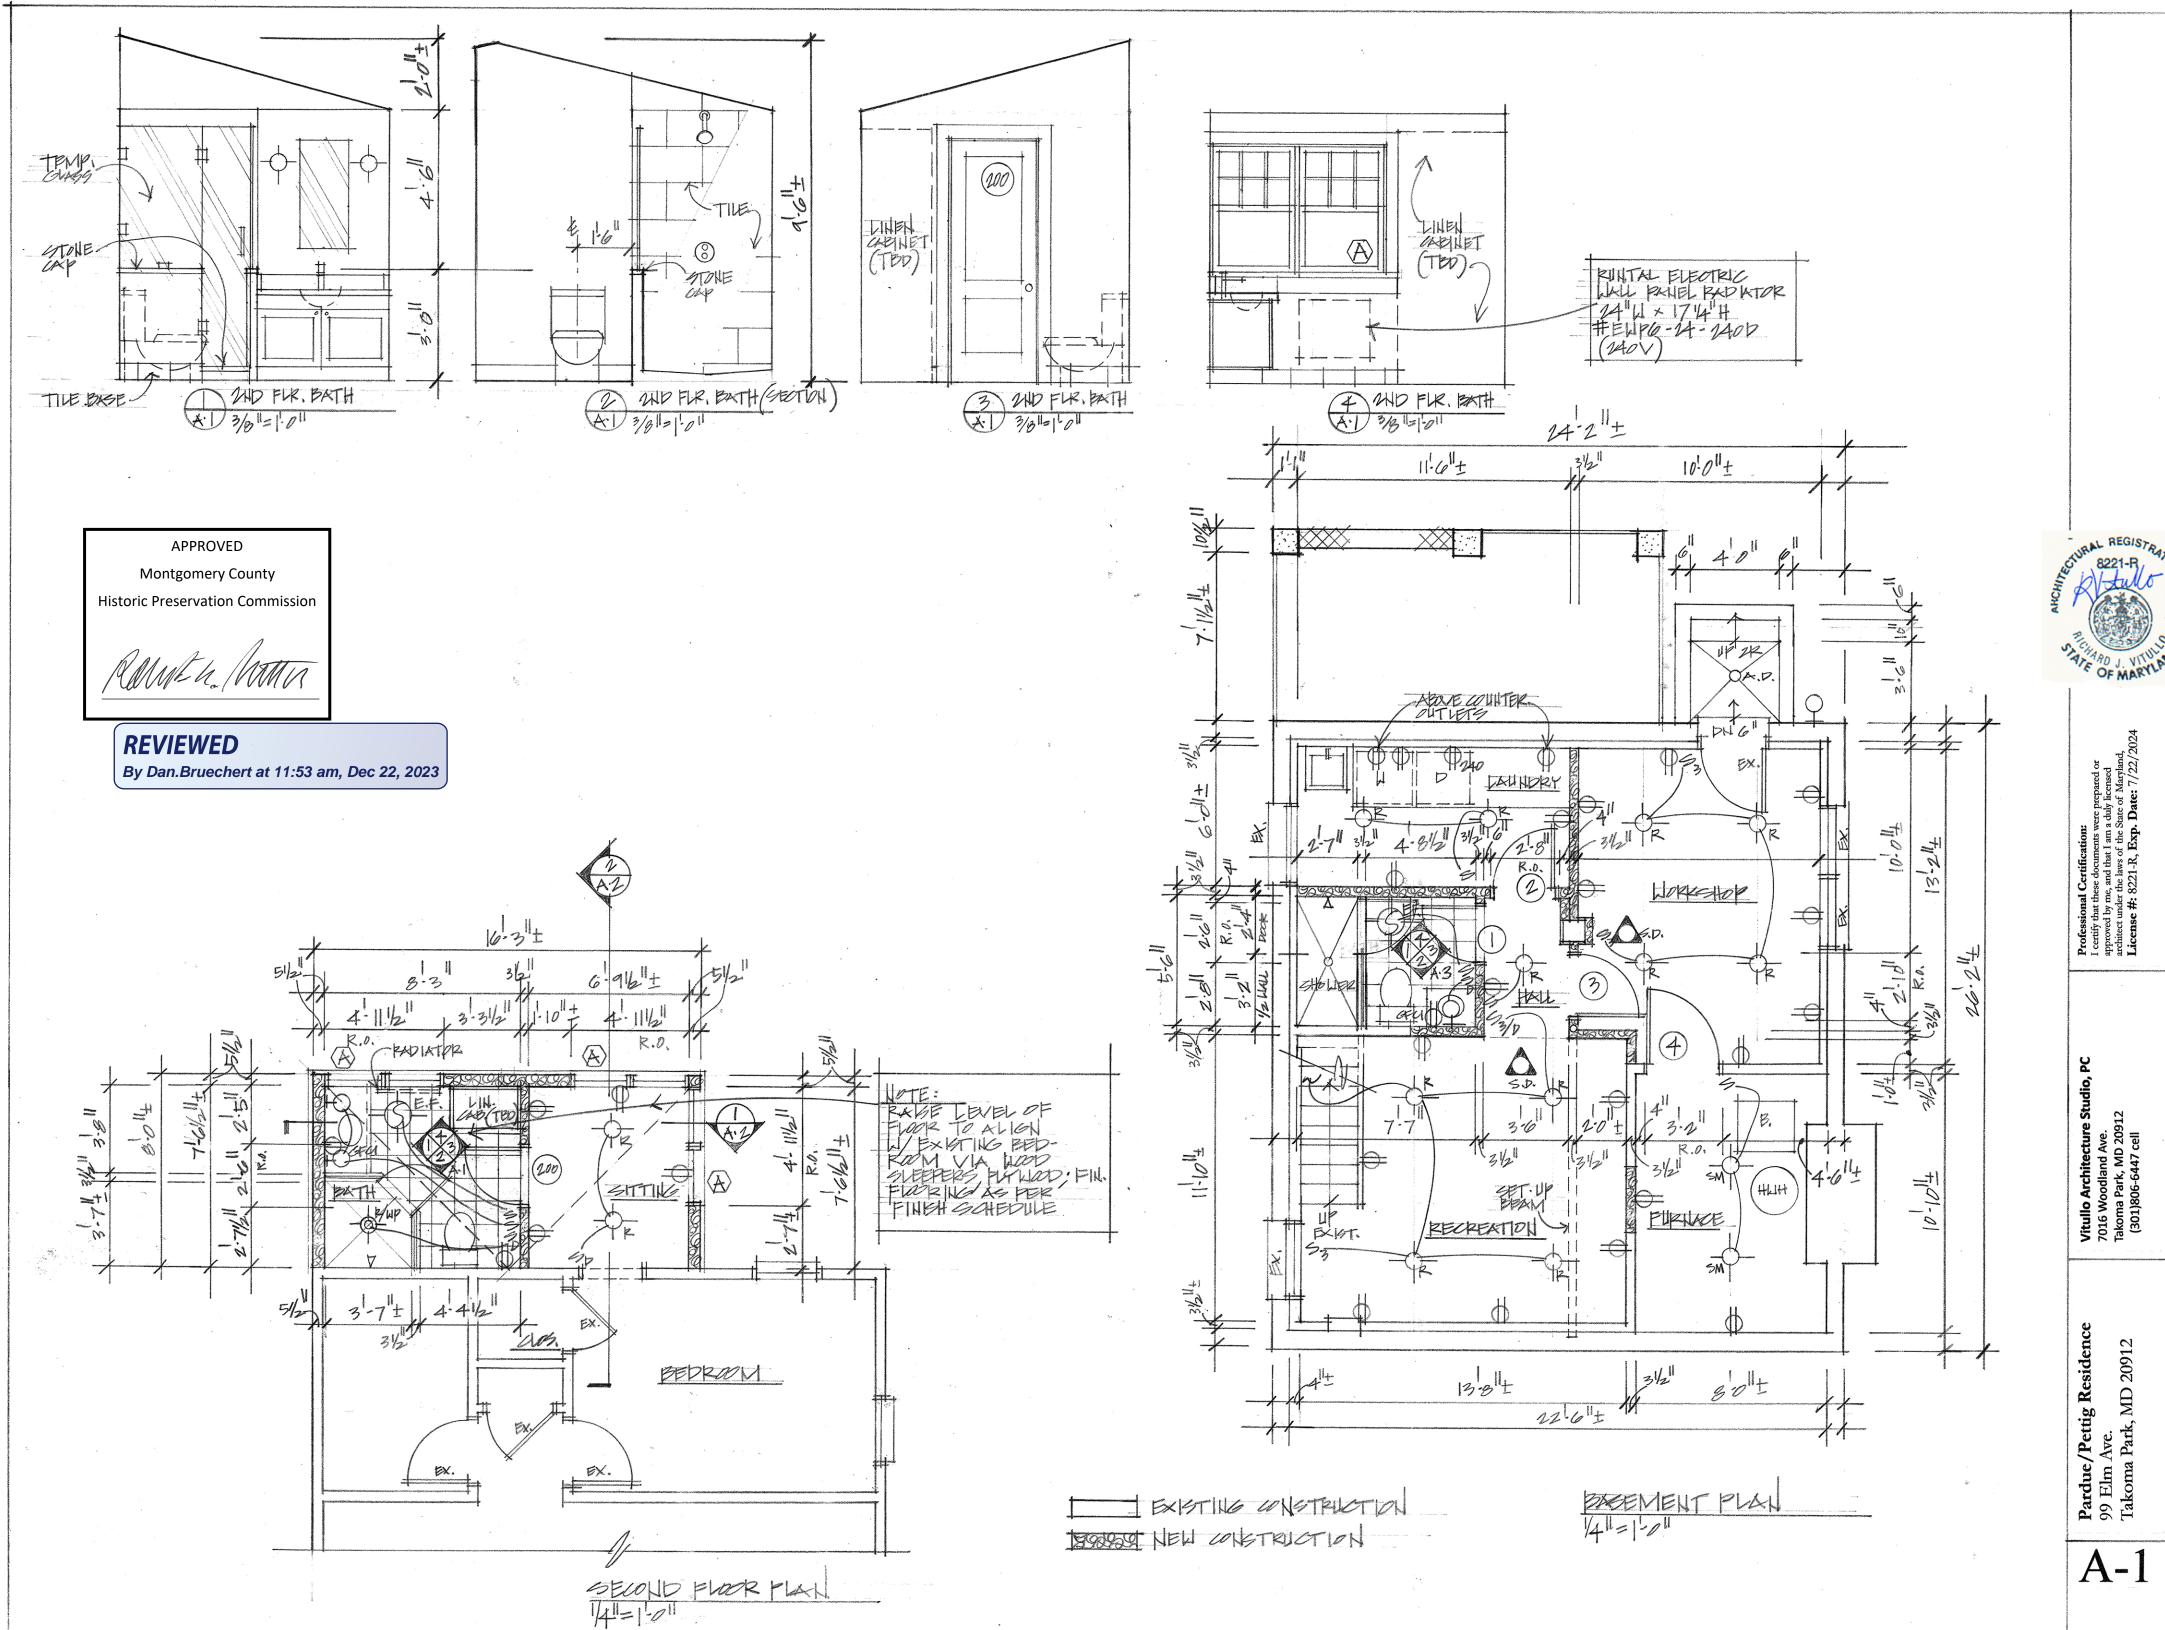


Vitullo Archite 7016 Woodland Takoma Park, M (301)806-6447

Pardue/Pettig Residence 99 Elm Ave. Takoma Park, MD 20912


**A-1** 

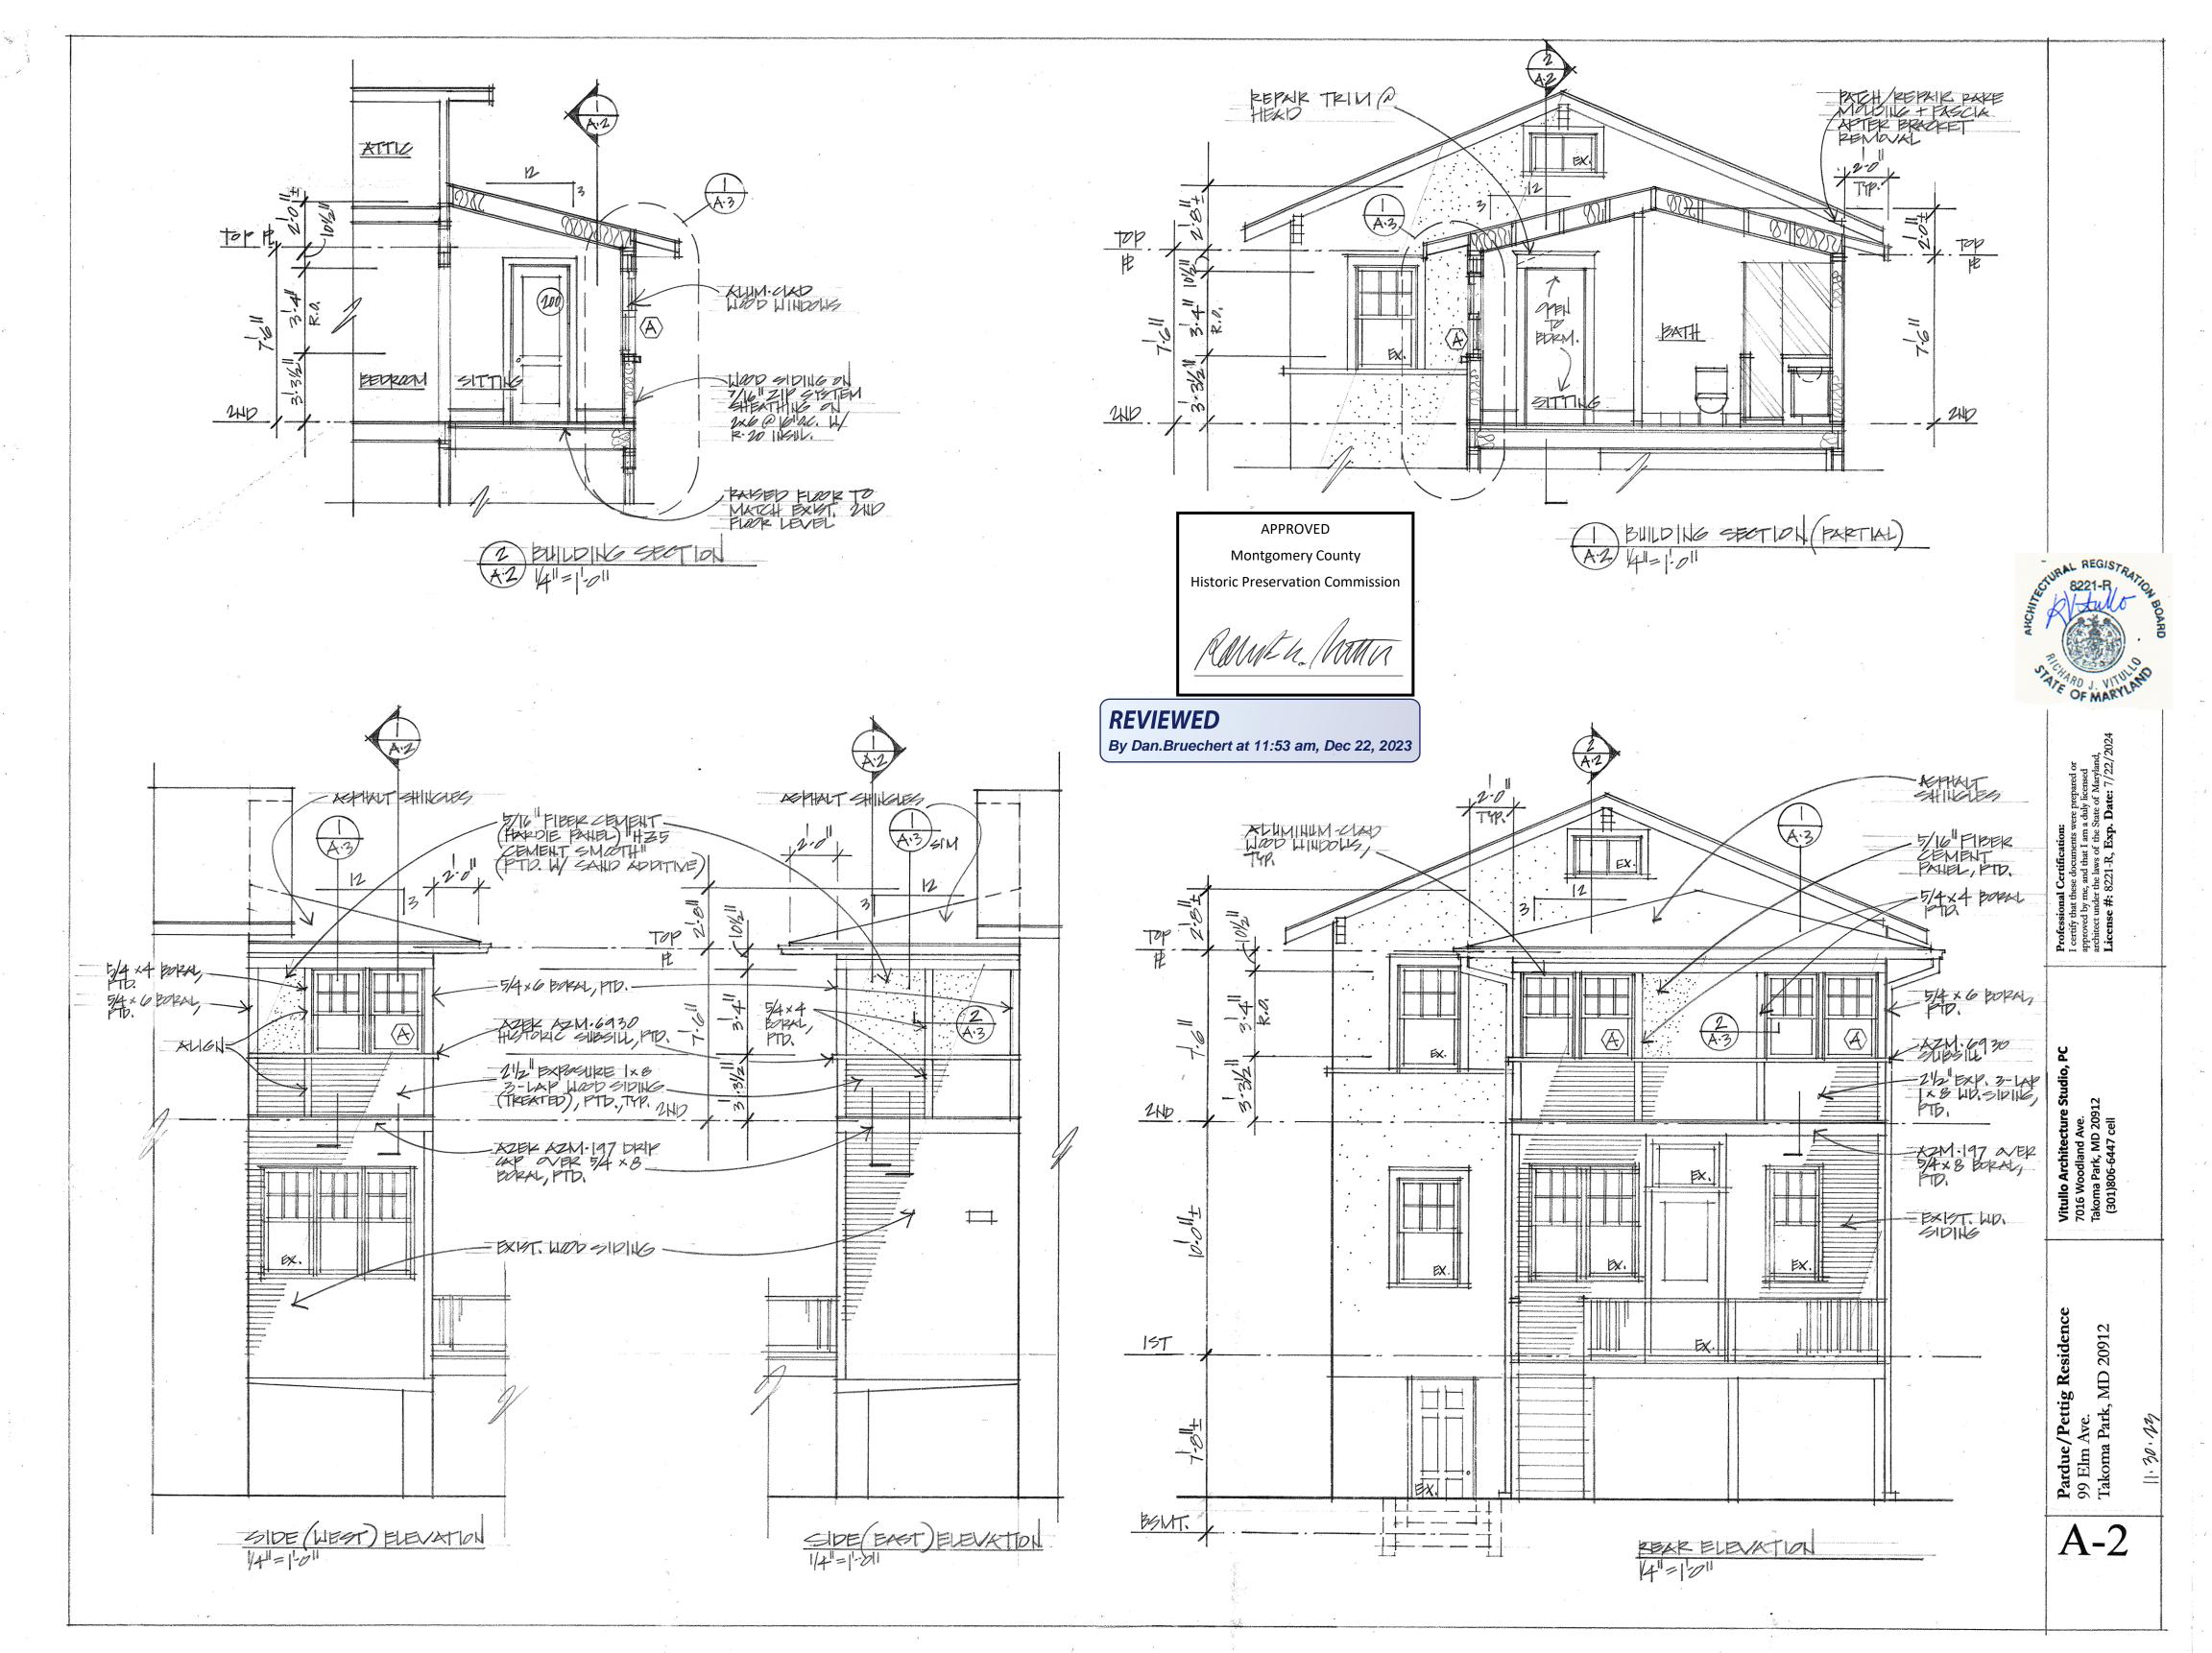

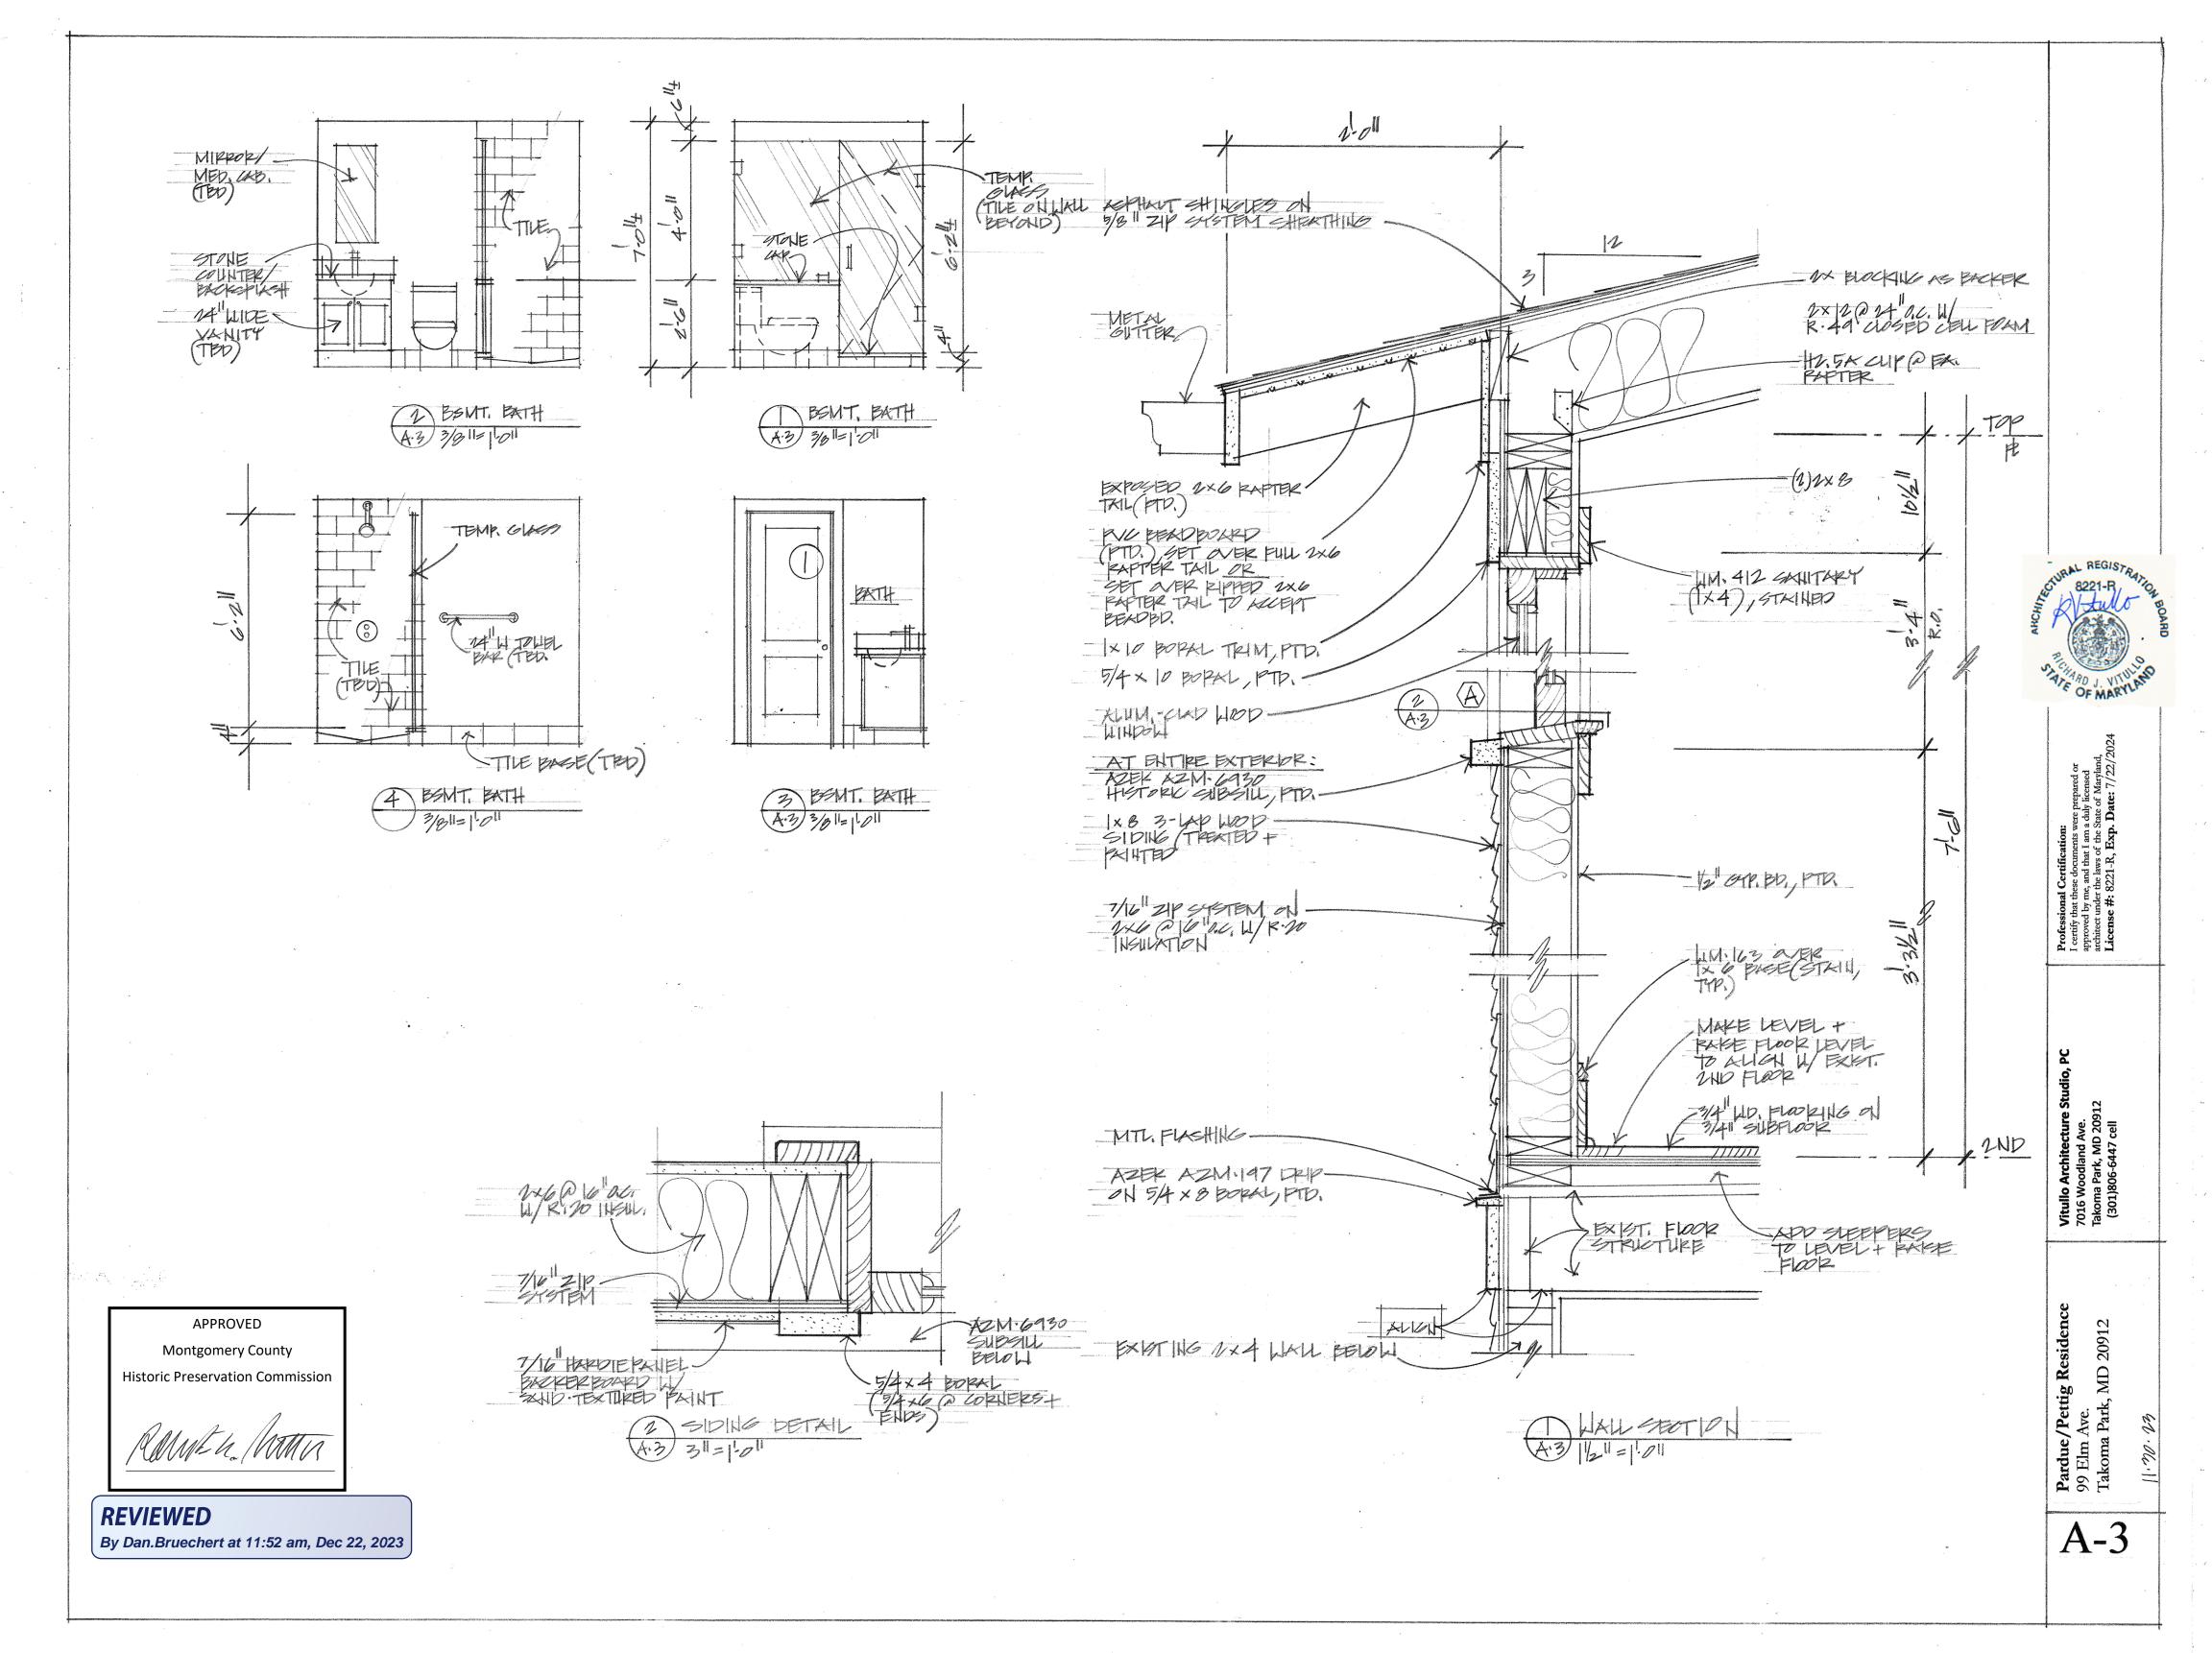

<b>E</b> 6 T	
Δ_4	

WINDOW SCHEDULE					Manufacture	r- Windows: Marvin Ultimate			,						T	,
/lfr. Window Line/ Model No.	Height, Unit (R.O.)	Width, Unit (R.O.)	Jamb Depth	Window Type/Material	Glazing Type	Grille Structure	Mullion Divisions	Interior Color	Exterior Clad Color	Screens / Screen Door	Hardware	SHGC- value Total Unit	U-value Total Unit	Egress window	Quant.	Remarks
Ultimate UDHG2 2416	3'-3 1/2" (3'-4" R.O.)	2'-5 1/4" (2'-6 1/4" R.O.); Windows to be mulled together into 3 pairs with total R.O.: 4'-11 1/2" wide each	2 X 6 wall	DOUBLE HUNG /wood interior & aluminum-clad exterior	TEMPERED 7/8" Insulating glass Low E2 w/ Argon	5/8" SDL, w/ spacer bar/ Ogee Profile	6-over-1	Factory-primed & painted White	"Stone White"	YES	TBD	0.3	0.3	n/a	6	6 windows to be mulle together into 3 pairs
DC	OR SCHEDU	LF			Manu	facturer Deere	TPD					0.30 avg.	0.30 avg.		6 units	ACCURATION AND ADDRESS OF THE PROPERTY OF THE
					, Itlania	lacturer- Doors.	עפו			<del>de Grand and Action and Action</del>				acadierika yika yika karan Dorka karan kali karinga ya ya ka a		AND THE RESIDENCE OF THE PROPERTY OF THE PROPE
Mfr. No.	Height, Unit (R.O.)	Width, Unit (R.O.)	Jamb Depth	Door Type / Material	Glazing Type	Grille Structure	Mullion Divisions	Interior Color	Exterior Clad Color	Screen	Hardware/ Sill Material			Swing direction (shown from outdside room)	Quant.	
TBD	6'-8" (6'-9" R.O.)	2'-4" (2'-6" R.O.)	2 x 4 wall	Solid Wood 2-Panel SWING Door (match exist.)	n/a	n/a	n/a	TBD	n/a	n/a	TBD	n/a	n/a	Right hand	1	Interior Door
TBD	6'-8" (6'-9" R.O.)	2'-6" (2'-8" R.O.)	2 x 4 wall	Solid Wood 2-Panel SWING Door (match exist.)	n/a	n/a	n/a	TBD	n/a	n/a	TBD	n/a	n/a	Right hand	1	Interior Door
TBD	6'-8" (6'-9" R.O.)	2'-8" (2'-10" R.O.)	2 x 4 wall	Solid Wood 2-Panel SWING Door (match exist.)	n/a	n/a	n/a	TBD	n/a	n/a	TBD	n/a	n/a	Right hand	1	Interior Door
TBD	6'-8" (6'-9" R.O.)	3'-0" (3'-2" R.O.)	2 x 4 wall	Solid Wood Flush SWING Door	n/a	n/a	n/a	TBD	n/a	n/a	TBD	n/a	n/a	Left hand	1	Interior Door
TBD	6'-8" (6'-9" R.O.)	2'-4" (2'-6" R.O.)	2 x 4 wall	Solid Wood 2-Panel SWING Door (match exist.)	n/a	n/a	n/a	TBD	n/a	n/a	TBD	n/a	n/a	Right hand	1	Interior Door
												0.00	0.00		Fi4c	
										8						
	Model No.  Itimate UDHG2 2416  DC  Mfr. No.  TBD  TBD  TBD  TBD	Model No.  Height, Unit (R.O.)  Stimate UDHG2 2416  DOOR SCHEDU  Mfr. No. Height, Unit (R.O.)  TBD 6'-8" (6'-9" R.O.)  TBD 6'-8" (6'-9" R.O.)  TBD 6'-8" (6'-9" R.O.)  TBD 6'-8" (6'-9" R.O.)	Model No.  Height, Unit (R.O.)  Width, Unit (R.O.)  Itimate UDHG2 2416  DOOR SCHEDULE  Mfr. No.  Height, Unit (R.O.)  Width, Unit (R.O.); Windows to be mulled together into 3 pairs with total R.O.: 4'-11 1/2" wide each  Width, Unit (R.O.)  Width, Unit (R.O.)  TBD 6'-8" (6'-9" R.O.)  TBD 6'-8" (6'-9" R.O.)	Model No.   Height, Unit (R.O.)   Width, Unit (R.O.)   Jamb Depth	Model No.   Height, Unit (R.O.)   Width, Unit (R.O.)   Jamb Depth   Window Type/Material	Model No.   Height, Unit (R.O.)   Width, Unit (R.O.)   Jamb Depth   Window Type/Material   Glazing Type	Model No.   Height, Unit (R.O.)   Width, Unit (R.O.)   Jamb Depth   Window Type/Material   Glazing Type   Grille Structure	Model No.   Height, Unit (R.O.)   Width, Unit (R.O.)   Jamb Depth   Window Type/Material   Glazing Type   Grille Structure   Mullion   Divisions	Model No.   Height, Unit (R.O.)   Samb Depth   Window Type/Material   Glazing Type   Grille Structure   Mullion Divisions   Interior Color Divisions   Int	Model No.   Height, Unit (R.O.)   Width, Unit (R.O.)   Jamb Depth   Window Type/Material   Glazing Type   Grille Structure   Divisions   Interior Color   Exterior Clad   Color   Co	Model No.   Height, Unit (R.O.)   Samb Depth   Window Type/Material   Glazing Type   Grille Structure   Divisions   Interior Color   Extend Clad   Screen   Door	Middle No.   Meight, Unit (R.O.)   Midth, Unit (R.O.)   Jamb Depth   Window Type/Material   Glazing Type   Grille Structure   Divisions   Interior Color   Color C	Model No.   Height, Unit (R.O.)   Surface   Wildth, Unit (R.O.)   Jamb Depth   Window Type/Material   Glazing Type   Grille Structure   Divisions   Interior Color   Color	Model No.   Height, Unit (R.C.)   Jamb Depth   Window Type/Material   Glazing Type   Grille Structure   Divisions   Uniterior Color   Color   Color   Door   Door	Model No.   Meight, Unit (R.O.)   Width, Unit (R.O.)   Jamb Depth   Window Type/Material   Glazing Type   Grille Structure   Divisions   Interior Color   Co	Model No.   Meight, Unit (R.O.)   Width, Unit (R.O.)   Window Type/Material   Glazing Type   Grille Structure   Divisions   Interior Color   Divisions   Divisions   Interior Color   Divisions   Interior Color   Divisions   Divisions   Divisions   Divisions   Divisions   Divi

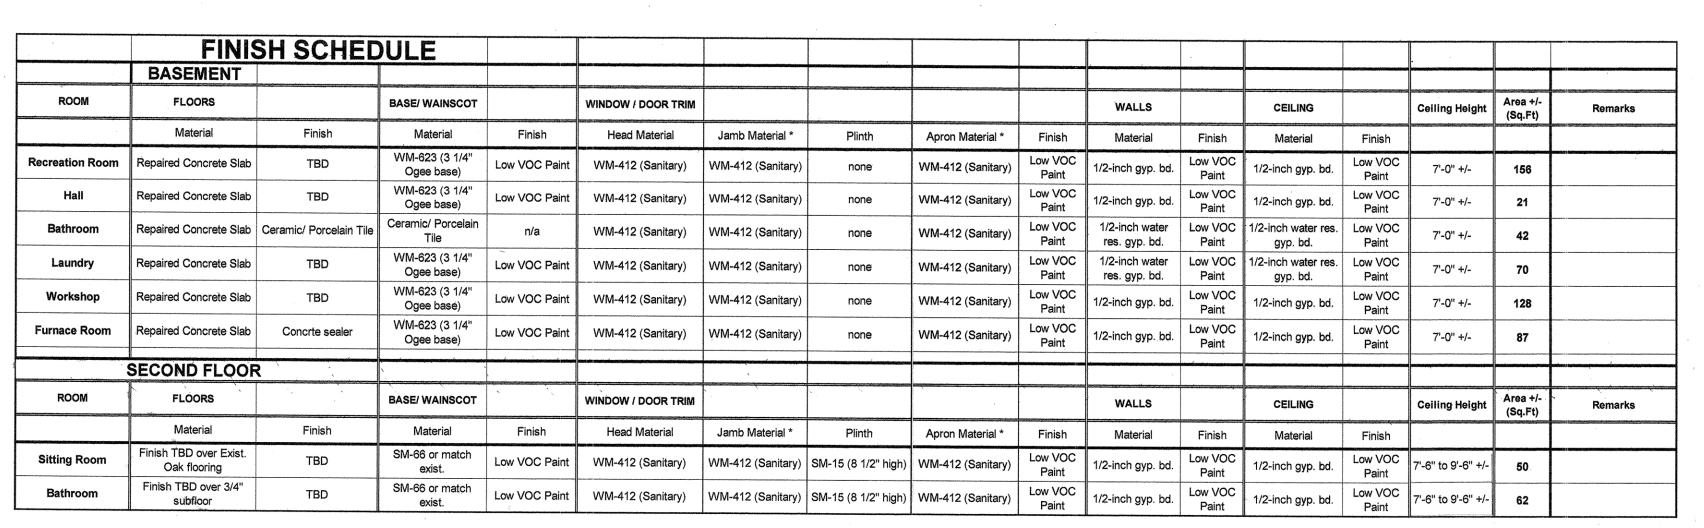

APPROVED Montgomery County **Historic Preservation Commission** 

**REVIEWED** 

By Dan.Bruechert at 11:53 am, Dec 22, 2023


APPROVED

Montgomery County

Historic Preservation Commission

REVIEWED


By Dan.Bruechert at 11:52 am, Dec 22, 2023

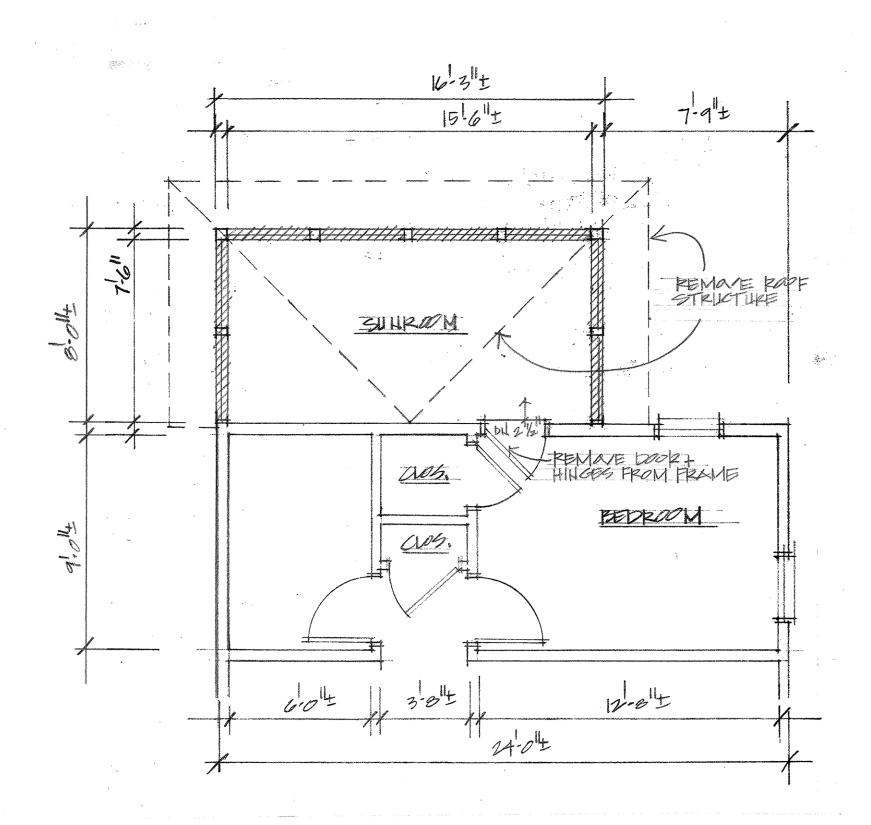


SELOND FLOOR DEMOLITION PLAN

# **GENERAL DEMOLITION NOTES:**

- Remove/re-route plumbing (water supplies, drains, vents and gas lines, radiators, etc.) as necessary to accomplish new plan layout and to minimize their impact on the new space; cap off lines as necessary during construction. If any lines discovered cannot be moved/re-routed easily, notify architect to review solutions.
- 2. Remove all trim, gypsum board/plaster, doors, thresholds, flooring, etc. but only as necessary to implement new layout and design.
- For removal of any lead paint, asbestos tile, etc., a certified asbestos or lead abatement professional must be used. Contractor to ensure that containment barriers are in place to keep debris and dust at a minimum; workers to utilize proper protection equipment from hazards.
- 4. Remove existing wall and/or floor construction as noted on plans as necessary to implement new layout; if walls are bearing walls, use temporary supports to re-direct loads until new bearing elements are constructed. (If walls or other elements that were previously assumed to be non-bearing are actually bearing, notify architect and/or engineer immediately.)
- 5. Remove and salvage (as per owners' request) existing light fixtures to implement new plan layout.
- 6. Remove all electrical outlets, fixtures, smoke alarms, telephone wiring, exposed wiring, etc. that are to be replaced by new work.
- 7. Dispose of all discarded material in a safe and clean manner.
- 8. Protect all surfaces during demolition (and construction) from unnecessary damage.

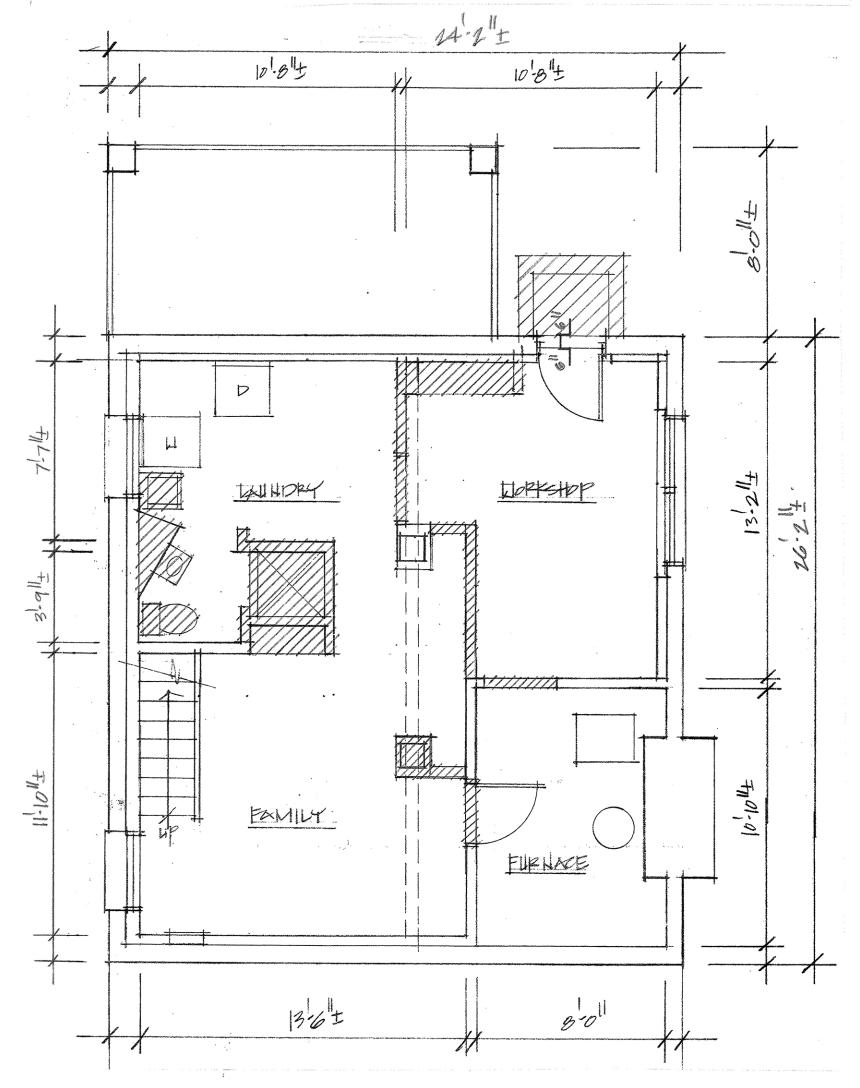



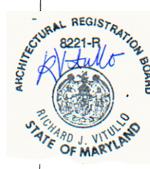

ssional Certification:

y that these documents were prepared or
ed by me, and that I am a duly licensed
at under the laws of the State of Maryland,
see #: 8221-R, Exp. Date: 7/22/2024

Vitulio Architecture Studio, 7016 Woodland Ave. Takoma Park, MD 20912 (301)806-6447 cell

Pardue/Pettig Residence 99 Elm Ave. Takoma Park, MD 20912

DM-1