

HISTORIC PRESERVATION COMMISSION

Marc Elrich County Executive Sandra I. Heiler Chairman

Date: June 10, 2019

MEMORANDUM

TO:	Diane Schwartz Jones
	Department of Permitting Services
FROM:	Michael Kyne
	Historic Preservation Section
	Maryland-National Capital Park & Planning Commission
SUBJECT:	Historic Area Work Permit #869393: Building addition

The Montgomery County Historic Preservation Commission (HPC) has reviewed the attached application for a Historic Area Work Permit (HAWP). This application was <u>Approved</u> at the April 10, 2019 Historic Preservation Commission meeting.

The HPC staff has reviewed and stamped the attached construction drawings.


THE BUILDING PERMIT FOR THIS PROJECT SHALL BE ISSUED CONDITIONAL UPON ADHERENCE TO THE ABOVE APPROVED HAWP CONDITIONS AND MAY REQUIRE APPROVAL BY DPS OR ANOTHER LOCAL OFFICE BEFORE WORK CAN BEGIN.

Applicant: C.J. Rydberg and Katelin Chow (Rick Vitullo, Architect)

Address: 10 Hickory Avenue, Takoma Park

This HAWP approval is subject to the general condition that the applicant will obtain all other applicable Montgomery County or local government agency permits. After the issuance of these permits, the applicant must contact this Historic Preservation Office if any changes to the approved plan are made. Once work is complete the applicant will contact Michael Kyne at 301.563.3400 or michael.kyne@montgomeryplanning.org to schedule a follow-up site visit.



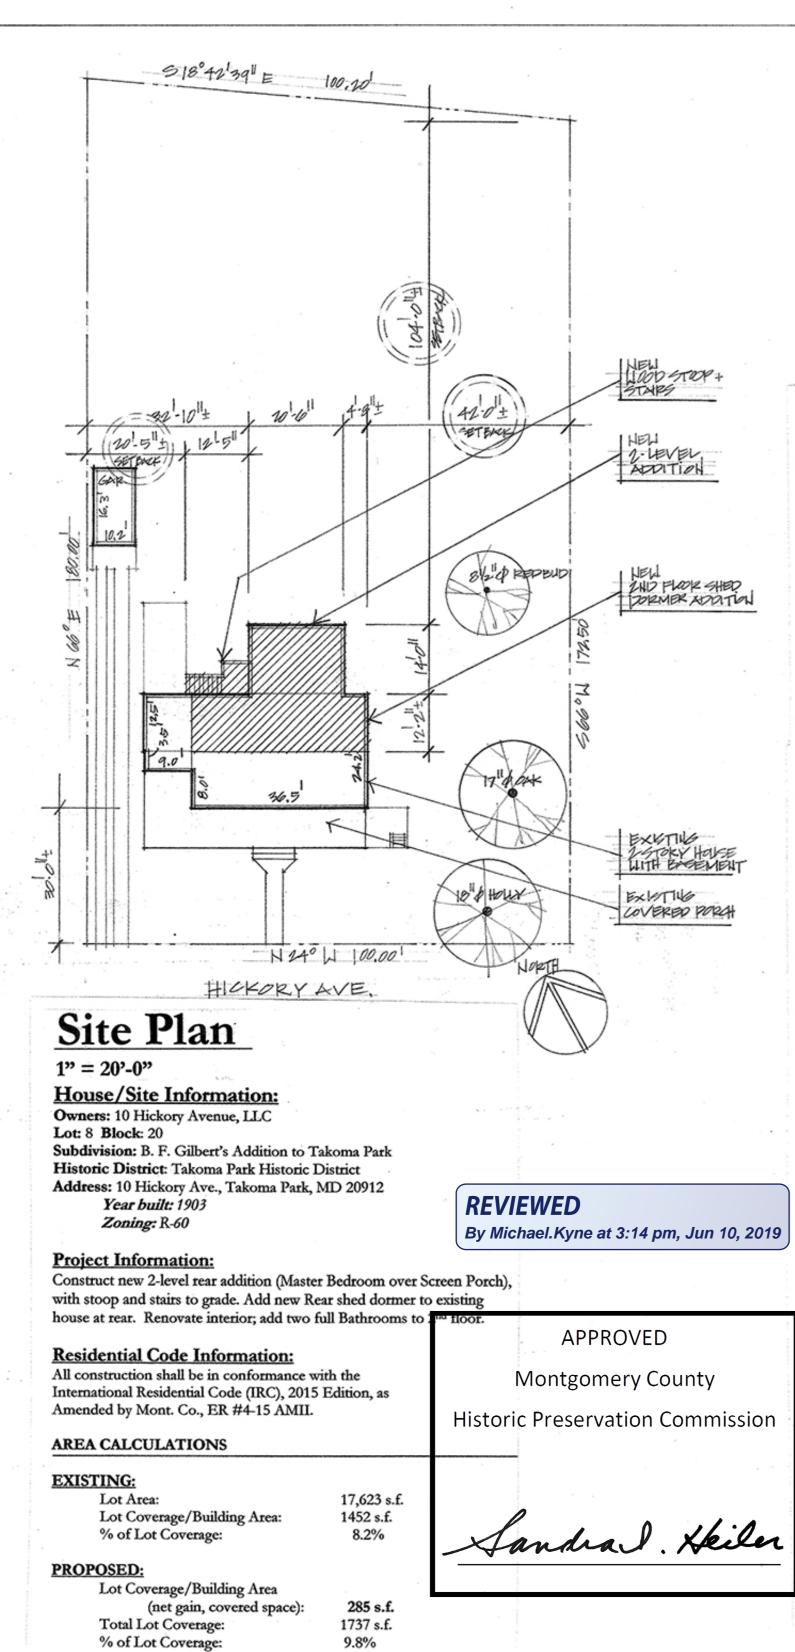

GENERAL CONSTRUCTION NOTES:

- 1. These drawings are to show only materials and layout of the design; means and methods are to be determined by contractor. The contractor shall fully acquaint him/herself with the conditions relating to construction and labor so that he/she understands the issues relating to the execution of the work.
- 2. Contractor shall provide all materials, labor and equipment and pay all freight charges, taxes, and handling of materials necessary for the full implementation of the work herein described on these drawings unless noted otherwise.
- Contractor to verify all dimensions and assumed conditions in the field; bring any discrepancies, omissions, ambiguities or conflicts to the attention of the architect and owner as soon as possible before proceeding with any of this work in question. 4. Contractor to notify architect if any existing pipes, ducts, or structural elements (or any other relevant item) that are revealed by demolition and are scheduled to be removed or re-routed for the new plan are determined to be not easily moved, or
- removed.
- 5. Contractor to notify architect and/or structural engineer if any existing wood joists, sheathing, studs, etc. are damaged or deteriorated from termites, water, etc. 6. All construction will meet or exceed all applicable building and health codes, unless a
- code modification approval is granted.
- 7. The owner's written authorization will be required before any work is executed or materials ordered that involve a change from the original specifications affecting the contract price.
- 8. All plan dimensions on drawings are set to edge of framing members; all finishes are not taken into account unless otherwise noted. If dimension is taken to a finish surface, it shall be noted as "FINISH DIMENSION", "FIN. DIM.", or "CLEAR DIM.". 9. Solid blocking required under posts or any bearing from above to solid bearing below; match bearing area of post above to bearing below; cut bearing blocks to
- minimum 1/16" deeper than joists.
- 10. Install solid blocking in walls for receipt of plumbing fixtures, accessories (towel bars, toilet paper holders, etc.), hardware, cabinets, etc., as necessary; verify rough-in dimensions for plumbing fixtures prior to framing of posts, studs, beams and joists. 11. All wood in contact with masonry/concrete surfaces shall be pressure-treated; install
- sill gasket underneath all sill plates.
- 12. New doors, windows and hardware, are to be provided and installed by contractor; verify window and door manufacturers' rough opening dimensions prior to framing. 13. Install shelves and closet poles in clothes Closets at 5'-6" A.F.F., typ.; sand, prime and paint shelves with gloss paint; color by owner; changes in the configuration of
- shelves in other closets to be confirmed by owner prior to final installation.
- 14. In all newly exposed existing 2 x 4 furring or walls at exterior, insert insulation in any combination of closed cell foam/rockwool/batts for R-13, minimum; at new exterior walls, (2 x 6), insert insulation to R-20, minimum.
- In all newly exposed existing roof rafters where an R-49 insulation level is impossible to achieve, insert insulation in any combination of closed cell foam/rockwool/batts for R-30, minimum, given that the maximum area shall be limited to 500 sf or 20% of the total insulated ceiling area (See IRC 2015 N1102.2.2). At new exterior walls, (2 x 6), insert insulation to R-20, minimum.
- 16. When house-wrap and or building paper is used, apply and lap in a shingle-fashion so that upper courses lap over lower courses; any window and door flashing is integrated into this system in the same manner. Apply Z-flashing at all heads and apply pan flashing at all sills.
- . All new or existing wall surfaces are to be prepared for painting to be smooth and free of cracks, peeling paint, etc.; walls to be primed and painted (2 coats, min.) with color to be selected by owner.
- 8. Any new flooring material (tile, etc.) to be selected by owner, installed by contractor. Make surface smooth and flat for receipt of new flooring. 9. Install new interconnected AC-powered smoke and CO detectors as per drawings
- and per code, as necessary.
- 20. All electrical outlets in bath, kitchen (except refrigerator) and at exterior to be ground fault circuit interrupters (GFCI); in all rooms (except kitchens), all-fault circuit interrupters (AFCI) to be installed.
- Upgrade electrical service as necessary to provide sufficient power for new fixtures, etc.
- Electrical switches (dimmers, toggles, etc.), and telephone/modem to be approved by owner, installed by contractor. All decorative light fixtures to be selected by owner, installed by contractor.

Addition and Renovation to: Chow/Rydberg Residence

10 Hickory Ave., Takoma Park, MD 20912



ELEC	TRICAL & LIGHTING LEGE	Ì
"E"	Indicates existing unit (light or outlet) (all ouslets to be made code-compliant)	
÷	Duplex Outlet/new	
→=⊖ _{A/C}	Duplex Outlet/new/above counter	
= GPCI	Duplex Outlet/new/GFCI (all outlets in kitchens, baths, and exterior are to be GFCI)	
= AFCI	Duplex Outlet/new/AFCI (All-Fault Circuit Interrupter outlets: for all but in Kitchen)	ł
	Double Duplex Outlet	
-07	Duplex Floor Outlet	
	240v Outlet	
-\$-er	Exhaust Fan	
- \$ EP/H	Exhaust Fan/Heat	
-\$-EP/H/	L Exhaust Fan/Heat/Light	
- þ -æ	Ceiling Fan	9
-Quer	Ceiling Fan/Light	

· · ·	/
334	Surface Mounted Light Fixture
н	Wall Mounted Light Fixture/Sco
) WP	Light Fixture /Waterproof
>n	Dual Flood Light
DSL	Data/Telephone Jack
w	Coaxial/Cable TV
57	Audio Speaker
, í	Switch
D	Switch/Dimmer
3	Three-way Switch
₹ т	Track light
si,,	"Plugmold" Power Strip
\$`U/0	Undercabinet Lights
2	Smoke & Carbon Monoxide Dete (http://wird in dedicated circuit, interconnected,

ctors

Thermostat

E

Δ

Recessed Light Fixture/Eyeball

Recessed Light Fixture/Existing

Pendant Light Fixture

Recessed Light Fixture

Sheet Title Sheet No.

Cove	r Site Plan/Project Description /General Notes/
	Electrical & Lighting Legend/
D-1	Basement Demolition Plan/(1/4"=1'-0")/
	Demolition Notes /
D-2	First Floor Demolition Plan/(1/4"=1'-0")/
D-3	Second Floor Demolition Plan/(1/4"=1'-0")/
A-1	Foundation & Basement Plan (1/4"=1'-0")/
	First Floor & Hall Bath Elevations (3/8"=1'-0")
A-2	First Floor Plan (1/4"=1'-0")
	First Floor Bath Elevations (3/8"=1'-0")
A-3	Second Floor Plan (1/4"=1'-0")
	Master Bath Elevations (3/8"=1'-0")
A-4	Roof Plan (1/4"=1'-0")/ Master Bath
	Elevations (3/8"=1'-0")/Building Section (1/4"=1'-0")
	Library Elevation (3/8"=1'-0")
A-5	Exterior Elevations (1/4"=1'-0")/Wall Section (1"=1'-0"
A-6	Exterior Elevation (Side) (1/4"=1'-0")/Wall Section
	(1"=1'-0")/ Rake Overhang Details (1"=1'-0")
A-7	Exterior Elevation (Rear) (1/4"=1'-0")/
	Air Barrier, Insulation & Thermal Barrier Schedule
	And Diagrams
A-8	Building Section (1/4"=1'-0")/ Finish Schedule
A-9	Window & Door Schedule/ Mech., Electrical &
	Plumbing Notes/Kitchen Elevations (3/8"=1'-0")
S-1	First Floor Framing Plan (1/4"=1'-0")
S-2	Second Floor Framing Plan (1/4"=1'-0")
S-3	Roof Framing Plan (1/4"=1'-0")/Wind Brace
	Diagram & Schedule/ Structural Calculations

Vitullo , 7016 Wc Takoma (301)8 Chow/Rydberg Residence 10 Hickory Ave. Takoma Park, MD 20912 61.62 COVER

