

5 EAST MELROSE STREET, CHENY CHASE
HPC CASE # 35[B-13 KK]
CHENY CHASE VILLAGE HD.



HISTORIC PRESERVATION COMMISSION

Isiah Leggett
County Executive

William Kirwan
Chairperson

Date: January 15, 2014

MEMORANDUM

TO: Diane R. Schwartz Jones, Director
Department of Permitting Services

FROM: Josh Silver, Senior Planner *(TS)*
Historic Preservation Section
Maryland-National Capital Park & Planning Commission

SUBJECT: Historic Area Work Permit #654911, construction of rear addition and other alterations

The Montgomery County Historic Preservation Commission (HPC) has reviewed the attached application for a Historic Area Work Permit (HAWP). This application was approved with conditions at the December 4, 2013 meeting.

1. *The applicant's project must comply with the Chevy Chase Village side yard setback requirements. The applicant must obtain an approved variance from Chevy Chase Village prior to submitting the permit set of plans to HPC staff for final review. Denial of a variance from Chevy Chase Village may result in the applicant's resubmission of a revised Historic Area Work Permit application to the HPC for review and approval.*
2. *The proposed east and west elevation walls of the addition must be inset 12" where they meet the historic massing. The gutter line and soffit of the addition be maintained to match the overhang of the existing roof. Consult HPC approved building permit set of plans for final roof and wall measurements and details.*
3. *The applicant will submit a sample of the existing and proposed replacement siding to HPC staff for final review and approval prior to submitting the permit set of drawings.*
4. *The building permit set of plans must show all window trim details and match those on the historic massing.*

Applicant: Patrick Conway

Address: 5 East Melrose Street, Chevy Chase





DPB - #8

HISTORIC PRESERVATION COMMISSION
301/563-3400APPLICATION FOR
HISTORIC AREA WORK PERMITContact Email: Patrick@Lock7Development.com Contact Person: Patrick Conway
Daytime Phone No.: 202-249-8033Tax Account No.: _____
Name of Property Owner: Patrick Conway Daytime Phone No.: 301-706-5146
Address: 5 East Melrose St Cherry Chase, MD 20815
Street Number: _____ City: _____ State: _____ Zip Code: _____
Contractor: Will Pinto Phone No.: 240-464-4749
Contractor Registration No.: _____
Agent for Owner: Patrick Conway Daytime Phone No.: 202-249-8033LOCATION OF BUILDING/PREMISES
House Number: 5 Street: East Melrose St
Town/City: Cherry Chase Nearest Cross Street: Connecticut Ave
Lot: _____ Block: _____ Subdivision: _____
Liber: _____ Folio: _____ Parc: _____

PART ONE: TYPE OF PERMIT/ACTIVITY/USE

1A. CHECK ALL APPLICABLE:

- Construct Extend Alter/Renovate
 Move Install Wreck/Raze
 Revision Repair Revocable.

CHECK ALL APPLICABLE:

- A/C Slab Room Addition Porch Deck Shed
 Solar Fireplace Woodburning Stove Single Family
 Fence/Wall (complete Section 4) Other: _____

1B. Construction cost estimate: \$ 500,000

1C. If this is a revision of a previously approved active permit, see Permit # _____

PART TWO: COMPLETE ONLY FOR FENCE/RETAINING WALL

2A. Type of sewage disposal: 01 WSSC 02 Septic 03 Other: _____2B. Type of water supply: 01 WSSC 02 Well 03 Other: _____

PART THREE: COMPLETE ONLY FOR FENCE/RETAINING WALL

3A. Height _____ feet _____ inches _____

3B. Indicate whether the fence or retaining wall is to be constructed on one of the following locations:

- On party line/property line Entirely on land of owner On public right of way/easement

I hereby certify that I have the authority to make the foregoing application, that the application is correct, and that the construction will comply with plans approved by all agencies listed and I hereby acknowledge and accept this to be a condition for the issuance of this permit.

Patrick M. Conway
Signature of owner or authorized agent _____ Date _____

Approved: ✓ w/ conditions For Chairperson, Historic Preservation Commission
Disapproved: _____ Signature: W. H. Date: 1/15/14
Application/Permit No.: 054911 Date Filed: 11/13/13 Date Issued: 11/13/13

MONTGOMERY COUNTY HISTORIC PRESERVATION COMMISSION
STAFF REPORT

| | | | |
|---------------------|---|-----------------------|-------------|
| Address: | 5 East Melrose Street, Chevy Chase | Meeting Date: | 12/4/13 |
| Resource: | Contributing Resource Chevy Chase Village Historic District | Report Date: | 11/27/13 |
| Applicant: | Patrick Conway | Public Notice: | 11/20/13 |
| Review: | HAWP | Tax Credit: | None |
| Case Number: | 35/13-13KK | Staff: | Josh Silver |

PROPOSAL: Construction of rear addition and other alterations

STAFF RECOMMENDATION

Staff recommends that the HPC approve with conditions this HAWP application:

1. *The applicant's project must comply with the Chevy Chase Village side yard setback requirements. The applicant must obtain an approved variance from Chevy Chase Village prior to submitting the permit set of plans to HPC staff for final review. Denial of a variance from Chevy Chase Village may result in the applicant's resubmission of a revised Historic Area Work Permit application to the HPC for review and approval.*

ARCHITECTURAL DESCRIPTION

SIGNIFICANCE: Contributing Resource within the Chevy Chase Village Historic District

STYLE: Colonial Revival/Four Square

DATE: 1898

PROPOSAL

The applicant is proposing to construct a two story, approximately 485 square foot addition over a full basement at the rear of the historic massing. The details and materials for the addition include:

- A hipped roof form. The proposed addition roof is a continuation of the hipped roof of the historic massing. The proposed roof engages the existing roof at the ridge line and terminates with a hip at the rear. A single dormer is proposed in the rear hip.
- A 12" inset at the both sides of the historic massing
- Concrete foundation wall
- Wooden cedar shake siding
- Asphalt shingle roofing
- Aluminum gutters
- Wooden (interior/exterior), 6/1, simulated-divided light and casement windows and doors.

The applicant is also proposing to remove and replace an existing window on the east (right) elevation, 1st floor, of the historic massing with a single-hung, full light, wooden door. This change is requested to improve vertical circulation on the interior of the house.

A deck fabricated from a paintable composite material is proposed at the rear of the new addition along with the installation of a brick patio.

APPLICABLE GUIDELINES

When reviewing alterations within the Chevy Chase Village Historic District several documents are to be utilized as guidelines to assist the Commission in developing their decision. These documents include the *Chevy Chase Village Historic District Master Plan – Expansion*, approved and adopted in August 1997, *Montgomery County Code Chapter 24A (Chapter 24A)* and the *Secretary of the Interior's Standards for Rehabilitation (Standards)*. The pertinent information in these documents is outlined as follows:

Chevy Chase Village Historic District Master Plan

The *Guidelines* break down specific projects into three levels of review - Lenient, Moderate and Strict Scrutiny.

“Lenient Scrutiny” means that the emphasis of the review should be on issues of general massing and scale, and compatibility with the surrounding streetscape, and should allow for a very liberal interpretation of preservation rules. Most changes should be permitted unless there are major problems with massing, scale or compatibility.

“Moderate Scrutiny” involves a higher standard of review than “lenient scrutiny.” Besides issues of massing, scale and compatibility, preserving the integrity of the resource is taken into account. Alterations should be designed so that the altered structure still contributes to the district. Use of compatible new materials, rather than the original building materials, should be permitted. Planned changes should be compatible with the structure’s existing design, but should not be required to replicate its architectural style.

“Strict Scrutiny” means that the planned changes should be reviewed to insure that the integrity of the significant exterior architectural or landscaping features and details is not compromised. However, strict scrutiny should not be “strict in theory but fatal in fact” i.e. it does not mean that there can be no changes but simply that the proposed changes should be reviewed with extra care.

The *Guidelines* state three basic policies that should be adhered to, including:

Preserving the integrity of the contributing structures in the district. Alterations to contributing structures should be designed in such a way that the altered structure still contributes to the district.

Design review emphasis should be restricted to changes that will be visible from the front or side public right-of-way, or that would be visible in the absence of vegetation or landscaping.

Alterations to the portion of a property that are not visible from the public right-of-way should be subject to very lenient review. Most changes to rear of the properties should be approved as a matter of course.

The *Guidelines* that pertain to this project are as follows:

Doors should be subject to moderate scrutiny if they are visible from the public right-of-way, lenient scrutiny if they are not.

Exterior trim (such as moldings on doors and windows) on contributing resources should be subject to moderate scrutiny if it is visible from the public right-of-way, lenient scrutiny if it is not.

Gutters are not currently subject to review and should not be reviewed.

Lot coverage should be subject to strict scrutiny, in view of critical importance of preserving the Village's open park-like character.

Major additions should, where feasible, be placed to the rear of the existing structure so that they are less visible from the public right-of-way.

Roofing materials should be subject to moderate scrutiny if they are visible from the public right-of-way, lenient scrutiny if they are not. In general, materials differing from the original should be approved for contributing resources. However, the application should be reviewed with consideration given to economic hardship. Furthermore, as technology continues to change and improve, other building materials may become available to provide an appropriate substitute for replacement in-kind, and the reviewing agency should be open to considerations of these alternative solutions.

Windows (including window replacement) should be subject to moderate scrutiny if they are visible from the public right-of-way, lenient scrutiny if they are not.

Montgomery County Code; Chapter 24A-8

- (a) The commission shall instruct the director to deny a permit if it finds, based on the evidence and information presented to or before the commission that the alteration for which the permit is sought would be inappropriate, inconsistent with or detrimental to the preservation, enhancement or ultimate protection of the historic site or historic resource within an historic district, and to the purposes of this chapter.
- (b) The commission shall instruct the director to issue a permit, or issue a permit subject to such conditions as are found to be necessary to insure conformity with the purposes and requirements of this chapter, if it finds that:
 - (1) The proposal will not substantially alter the exterior features of an historic site or historic resource within an historic district; or
 - (2) The proposal is compatible in character and nature with the historical, archeological, architectural or cultural features of the historic site or the historic district in which an historic resource is located and would not be detrimental thereto or to the achievement of the purposes of this chapter; or
 - (3) The proposal would enhance or aid in the protection, preservation and public or private utilization of the historic site or historic resource located within an historic district in a manner compatible with the historical, archeological, architectural or cultural value of the historic site or historic district in which an historic resource is located; or
 - (4) The proposal is necessary in order that unsafe conditions or health hazards be remedied; or
 - (5) The proposal is necessary in order that the owner of the subject property not be deprived of reasonable use of the property or suffer undue hardship; or
 - (6) In balancing the interests of the public in preserving the historic site or historic resource located within an historic district, with the interests of the public from the use and benefit of the alternative proposal, the general public welfare is better served by granting the permit.
- (c) It is not the intent of this chapter to limit new construction, alteration or repairs to any 1 period or architectural style.
- (d) In the case of an application for work on an historic resource located within an historic district, the commission shall be lenient in its judgment of plans for structures of little historical or design significance or for plans involving new construction, unless such plans would seriously impair the historic or architectural value of surrounding historic resources or would impair the character of the historic district. (Ord. No. 9-4, § 1; Ord. No. 11-59.)

Secretary of the Interior's Standards for Rehabilitation:

- #9 New additions, exterior alterations, or related new construction will not destroy historic materials, features, and spatial relationships that characterize the property. The new work shall be differentiated from the old and will be compatible with the historic materials, features, size, scale and proportion, and massing to protect the integrity of the property and its environment.
- #10 New additions and adjacent or related new construction will be undertaken in such a manner that, if removed in the future, the essential form and integrity of the historic property and its environment would be unimpaired.

STAFF DISCUSSION

Staff recommends approval of the HAWP application as submitted with the condition specified on page 1 of the staff report.

The addition as proposed does not conform with Chevy Chase Village's side yard setback requirements. The gutter and soffit on the east (right) elevation encroaches into the side yard setback. The applicant has submitted a variance request to the Village Board. The applicant's request is scheduled for Board's consideration at their December 9, 2013 meeting. The Village Manager has reviewed the plans and indicated the applicant's request is very much in keeping with previously granted Board decisions and no major concerns in the hearing of the case are anticipated. (See page 29 of the staff packet).

Staff finds that consistent with Chevy Chase Village Historic District Guidelines, the proposed work as being consistent with the *Guidelines*, identified above.

The proposed material treatments and design details are appropriate for construction of a rear yard addition to a Contributing Resource property.

Although the removal and replacement of historic materials such as windows and doors and alteration of an original window opening is generally discouraged, staff finds the applicant's proposal to remove and replace the existing east (right) elevation window with a door and associated enlargement of the opening, as being consistent with *Guidelines*.

The *Guidelines*, state: "*Design review emphasis should be restricted to changes that will be visible from the front or side public right-of-way, or that would be visible in the absence of vegetation or landscaping.*" The existing window location is visible from the public right-of-way. The *Guidelines*, state: "Windows (including window replacement) should be subject to moderate scrutiny if they are visible from the public right-of-way, lenient scrutiny if they are not." The *Guidelines*, define "Moderate Scrutiny" as:

"Involving a higher standard of review than "lenient scrutiny." Besides issues of massing, scale and compatibility, preserving the integrity of the resource is taken into account. Alterations should be designed so that the altered structure still contributes to the district. Use of compatible new materials, rather than the original building materials, should be permitted. Planned changes should be compatible with the structure's existing design, but should not be required to replicate its architectural style."

Applying the "Moderate Scrutiny" principle staff finds the following: the subject window location is on a secondary elevation, and just above the foundation level, and within close proximity to the adjacent property. These factors reduce visibility of the window from the public right-of-way, and therefore replacing the window with a door would have negligible impact.

The proposed wooden replacement door style and material is compatible with the structure's existing design. The removal of this non-character defining feature and installation of a new door, will result in negligible impact to the structure's architectural integrity, and therefore should be approved as submitted.

The applicant has demonstrated with photographic evidence the presence of side yard doors throughout the historic district. (See page 25 of the staff report).

STAFF RECOMMENDATION

Staff recommends that the Commission approve with condition specified on page 1 the HAWP application under the Criteria for Issuance in Chapter 24A-8(b), having found that the proposal is consistent with the Chevy Chase Village Historic District Guidelines identified above, and therefore will not substantially alter the exterior features of the historic resource and is compatible in character with the district and the purposes of Chapter 24A;

and with the Secretary of the Interior's Standards for Rehabilitation;

and with the general condition that the applicant shall present the **3 permit sets of drawings, if applicable to Historic Preservation Commission (HPC) staff for review and stamping** prior to submission for the Montgomery County Department of Permitting Services (DPS) building permits;

and with the general condition that the applicant shall notify the Historic Preservation Staff if they propose to make **any alterations** to the approved plans. Once the work is completed the applicant will contact the staff person assigned to this application at 301-563-3400 or joshua.silver@mncppc-mc.org to schedule a follow-up site visit.



HISTORIC PRESERVATION COMMISSION
301/563-3400

**APPLICATION FOR
HISTORIC AREA WORK PERMIT**

Contact Email: Patrick@lock7development.com Contact Person: Patrick Conway
Daytime Phone No.: 202-249-8033

Tax Account No.: _____
Name of Property Owner: Patrick Conway Daytime Phone No.: 301-706-5146
Address: 5 East Melrose St Chevy Chase, MD 20815
Street Number: _____ City: _____ Street: _____ Zip Code: _____
Contractor: Will Pinto Phone No.: 240-464-4749

Contractor Registration No.: _____
Agent for Owner: Patrick Conway Daytime Phone No.: 202-249-8033

LOCATION OF BUILDING/PREMISE
House Number: 5 Street: East Melrose St
Town/City: Chevy Chase Nearest Cross Street: Connecticut Ave
Lot: _____ Block: _____ Subdivision: _____
Liber: _____ Folio: _____ Parc: _____

PART ONE: INFORMATION ABOUT THE PROJECT

1A. CHECK ALL APPLICABLE:

- Construct Extend Alter/Renovate
 Move Install Wreck/Raze
 Revision Repair Revocable.

CHECK ALL APPLICABLE:

- A/C Slab Room Addition Porch Deck Shed
 Solar Fireplace Woodburning Stove Single Family
 Fence/Wall (complete Section 4) Other: _____

1B. Construction cost estimate: \$ 500,000

1C. If this is a revision of a previously approved active permit, see Permit # _____

PART TWO: COMPLETE ONLY FOR NEW CONSTRUCTION AND EXPANSION/ADDITIONS

2A. Type of sewage disposal: 01 WSSC 02 Septic 03 Other: _____

2B. Type of water supply: 01 WSSC 02 Well 03 Other: _____

PART THREE: COMPLETE ONLY FOR FENCE/RETAINING WALL

3A. Height _____ feet _____ inches

3B. Indicate whether the fence or retaining wall is to be constructed on one of the following locations:

- On party line/property line Entirely on land of owner On public right of way/assessment

I hereby certify that I have the authority to make the foregoing application, that the application is correct, and that the construction will comply with plans approved by all agencies listed and I hereby acknowledge and accept this to be a condition for the issuance of this permit.

Patrick M. Conway
Signature of owner or authorized agent

11/13/13

Date

Approved: _____ For Chairperson, Historic Preservation Commission

Disapproved: _____ Signature: _____ Date: _____

Application/Permit No.: 054911 Date Filed: 11/13/13 Date Issued: _____

Josh Silver

Senior Planner

Montgomery County Planning Department

8787 Georgia Avenue

Suite 204

Silver Spring, MD. 20910

Re: Conway Residence

5 East Melrose Street

Chevy Chase, MD. 20815

Project Description:

The proposed project at the above mentioned address will involve the renovation and addition to an existing two and a half story wood framed single family home. The existing house has a painted wood shingle exterior. We are proposing to replace this with new hand split cedar shake siding with a semi-gloss stain finish. The entire exterior trim of the house will be painted per the directions of the attached drawings. The exterior of the existing garage will receive the same treatment as the existing house. The addition will be 17'-0" deep and will be inset from the existing building by 1'-0" on either side. The addition will include a Cellar, First Floor, Second Floor, and an Attic. The new rear entry will have a small deck and stair leading to the driveway and patio. All exterior windows and doors will be wood. We are proposing to replace one existing window on the East façade of the house with a new wood door. This change will drastically improve the vertical circulation of the house. Please see the attached drawings for a more detailed description of the project

Sincerely,

Kevin Donohoe, AIA

Square 134 Architects

1410 Q Street, NW, Washington, DC. 20009

202) 328-0134



HAWP APPLICATION: MAILING ADDRESSES FOR NOTIFYING
 [Owner, Owner's Agent, Adjacent and Confronting Property Owners]

| | |
|---|--|
| Owner's mailing address 3204 Stephenson Place NW Washington, DC 20015 | Owner's Agent's mailing address ← same |
| Adjacent and confronting Property Owners mailing addresses | |
| Mr. & Mrs. Norman Asher 1 East Melrose St Chevy Chase, MD 20815 | Mr & Mrs Joseph Coffey 7 East Melrose St Chevy Chase, MD 20815 |
| Mr. & Mrs. Tim Overcash 2 East Melrose St Chevy Chase, MD 20815 | Mr & Mrs. William Scott 6 East Melrose St. Chevy Chase, MD 20815 |

ALTERATION, REPAIR, AND ADDITION TO AN EXISTING SINGLE FAMILY RESIDENCE
5 EAST MELROSE STREET
 CHEVY CHASE, MD. 20815

Square 134 Architects
 1100 Sherman Way, Studio D, 20004
 402-888-6200 Fax: 402-888-6201


CONWAY RESIDENCE
 5 East Melrose Street
 Chevy Chase, MD. 20815

COVER SHEET


DRAWING TITLE

PROJECT NO.: 13025
 DRAWN BY: _____
 SCALE: 3/16" = 1'-0"
 DATE: 11/12/2013
 CIVIC NO.: _____
 GENERAL CONTRACTOR:
 COMPANY NAME: _____
 ADDRESS: _____
 PHONE: _____
 CONTACT: _____

A0.00

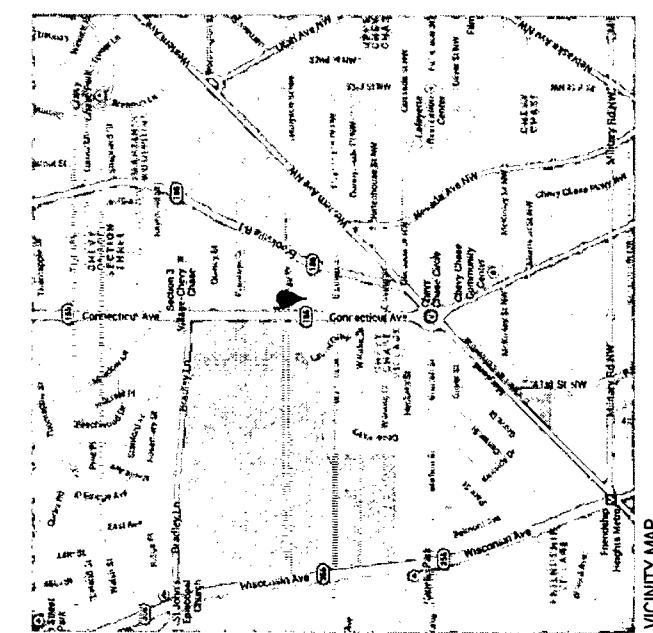

VICINITY MAP

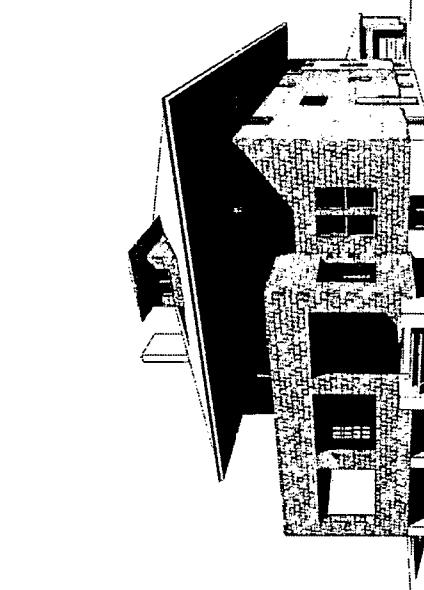

BUILDING DATA

PROJECT: 5 East Melrose Street

CHEVY CHASE, MD. 20815

SCOPE OF WORK:

This project involves the alteration, repair, and addition to an existing two and a half story plus cellar wood framed single family residence.

APPLICABLE BUILDING CODES:

This project conforms to all applicable building codes pertaining to Maryland or Montgomery County and the Village of Chevy Chase.

Building: International Residential Code - 2012

Electric: NFPA National Electrical Code - 2008

Energy: International Energy Conservation Code - 2012

Announcements: Montgomery County, Larchmont Regulation No. 0-14

Zoning: Montgomery County Zoning Ordinance - Chapter 59

PROJECT TEAM:

OWNER: Owner: Chevy Chase, MD. 20815
 5 East Melrose Street
 Chevy Chase, MD. 20815
 P: 202) 249-0313
 CONTACT - Patrick Conway

MEP ENGINEER: PE: Abdelfattah, LLC
 HVAC & Mechanical
 5100 Wisconsin Ave., NW
 Washington, DC. 20003
 P: (202) 453-9311
 P: (202) 453-4338
 CONTACT - Faith Abdelfattah, PE

STRUCTURAL ENGINEER: PE: Abdelfattah, LLC
 5100 Wisconsin Ave., NW
 Washington, DC. 20003
 P: (202) 453-9311
 P: (202) 453-4338
 CONTACT - Faith Abdelfattah, PE

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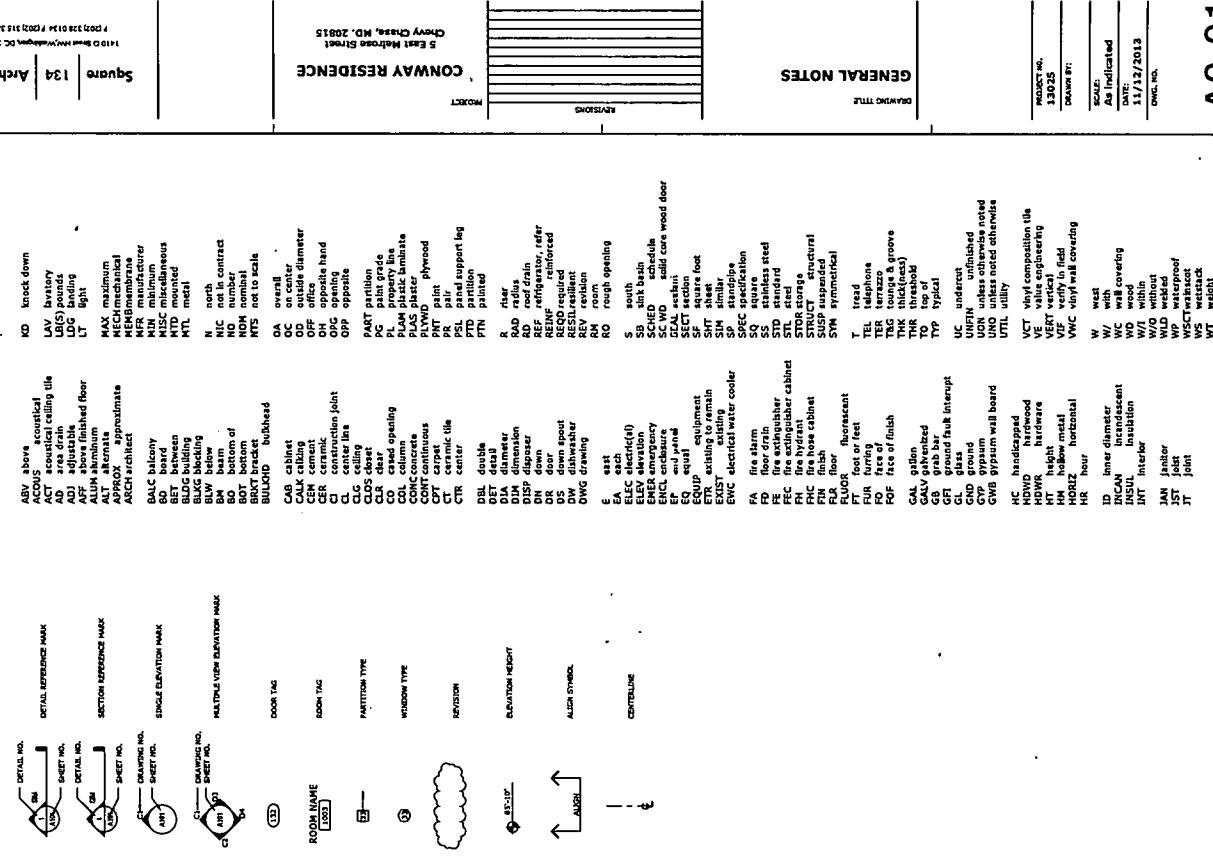
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GENERAL NOTES:

1. The Construction Documents are to include AIA document A201 "General Conditions of the Contract for Construction - Less Seven Deviations; A The Landlord, and a copy of the General Conditions, Supplementary Conditions, the Specifications, Drawings, Addendum, and Contract Modifications, Building Rules and Regulations & any other documents required by the Owner.
2. The General Contractor shall be both licensed and bonded in the District of Columbia and shall provide documents upon the requirements it requests.
3. The Work shall be done in accordance with all rules and regulations of all applicable safety and building codes, the General Contractor is responsible for securing and paying for all permits required for the Work and for the scheduling of all required inspections during the course of the Work.
4. The General Contractor shall review the existing conditions, Landlord Rules & Regulation & Base Building Construction Document from the Landlord and shall comply with all base building requirements or ambiguities discovered.
5. The General Contractor shall provide protection, and be responsible for any existing fixtures to remain and shall retain any fixtures any damaged areas as a result of this work. All existing fixtures to remain shall be cleaned at the completion of construction.
6. Materials and systems shall be installed as per manufacturer's specifications and all construction shall be of industry standard or better. The Architect shall be ultimate judge of quality.
7. Only new items of recent manufacture, of standard quality, free from defects, will be permitted in the Work, unless otherwise noted. Rejected items shall be removed immediately from the Work and replaced with items of the quality specified. Failure to remove rejected materials and equipment shall not relieve the General Contractor of responsibility for quality of items saved from any other disposition required by the Owner.
8. Do not scale drawings. Stated & written dimensions govern. The General Contractor shall verify all dimensions in the field and shall be responsible for the accuracy. No extra charge or compensation shall be provided for changes in the scope of the Work due to errors in the General Contractor's drawings or plans submitted to the Architect for decision prior to ordering manufacturing or proceeding with the Work. Horizontal dimensions indicated are to be measured from a true front face of GIB, unless otherwise specified. Vertical dimensions are not adjustable from top of floor slab except where noted as above finished floor (AF). Dimensions are not adjustable without approval of the Architect.
9. In the event of conflict between drawings shown on the specification, the general contractor shall provide a written statement detailing which drawing takes precedence over which drawing. The General Contractor shall verify all dimensions taken from drawings of larger scope. Should the General Contractor at any time discover an error in a drawing or specification, or any discrepancy, or variation between a drawing and a specification, he shall immediately advise the General Contractor in writing of the conflict and shall not proceed with the Work until the General Contractor has been advised of the error. The General Contractor shall provide a written statement detailing which drawing takes precedence over which drawing. In case of an inconsistency between Drawings and Specifications within either Document, not clarified by addendum, the more specific shall provide precedence over less specific. Better quality or greater quantity of Work will be provided to a General Contractor who provides the better quality or quantity of Work, unless otherwise specified. Details of dimensions, drawings, etc., are to be determined by the General Contractor and Owner.
10. General Contractor shall verify that no conflicts exist in locations of any and all mechanical, telephone, electrical, plumbing and similar equipment located in piping, duct work, structural columns, beams, walls, etc. that are to be determined and reviewed with the Architect prior to work proceeding. Contractor to coordinate new work with existing conditions.
11. The General Contractor shall provide shop drawings for the Architect's review and approval for the Work. Shop drawings shall be submitted in the form of 2 sets of prints. Shop drawings shall not be reproductions of Contract Documents, Material Submittals (3 samples) shall be provided.
12. The General Contractor shall provide to the Architect with materials, cut sheets and specifications for wood, acrylic, tile, base, paint, laminate and any other materials indicated in the shop drawing.
13. The General Contractor shall provide to the Architect with materials, cut sheets and specifications for fasteners, supplementary heating and cooling elements, all hardware and security equipment.
14. Contractor shall include all x-ray and core drill costs. All core drilling of the slab shall be approved by the Landlord Structural Engineer prior to proceeding with the Work. Contractor shall submit proposed locations to Architect and Structural Engineer for review prior to proceeding with the work.
15. Patch, repair and install all fireproofing as required by code. Repair any new penetrations required by the work.
16. The General Contractor to coordinate and review size and location of all slab penetrations. All required penetrations shall be made in accordance with the Owner's standard approval procedures and methods. The General Contractor shall be responsible for improving them according to applicable codes.
17. The General Contractor shall continuously check architectural and structural clearances for accessibility of equipment and mechanical and electrical systems. No obstructions of any kind will be made for the General Contractor's equipment to cross means of installing equipment into place.
18. The finished work shall be firm, well anchored, in true alignment, plumb, level, with smooth, clean, uniform, appearance without waves, distortion, holes, marks, creases, stains, or discoloration. Joining shall be close fitting, naked and well seated. The finished work shall have no opaque, unsightly anchors or fasteners and shall not present hazards, unsafe corners. All work shall have the provision for expansion, contraction and drainage as necessary to prevent cracks, bending, and warping due to temperature and humidity conditions.
19. Attachments, connections or fasteners of any nature are to be properly and permanently secured in conformance with best practice and the General Contractor is responsible for improving them accordingly. The fasteners shall be highly acceptable of standard quality and no means shall be used every connection. Start of installation shall always be made with a minimum of 10% of the total length of the fastener.
20. General Contractor shall waive "Contract Practice" and "Contract Usage" as construction criteria whenever details and Contract documents is governing codes, ordinances, etc. require a quantity or better quality than common practice or common usage a would require.

SYMBOLS LEGEND



ABBREVIATIONS

5IVE FIVE INC 202024
1010 888 888 0000
1010 888 888 0000
134 Architects

5 EASY Street, MD, 20815
CONWAY RESIDENCE
Square
WORT

CHRY Cross, MD, 20815
CONTRACTOR'S
DETAIL NO.
DETAIL REFERENCE MARK
SHEET NO.
DETAIL NO.
DETAIL NO.
SECTION REFERENCE MARK
SHEET NO.
DRAWING NO.
SHEET NO.
SINGLE ELEVATION MARK
MULTIPLE ELEVATION MARK
DRAWING NO.
DRAWING NO.
DRAWING NO.

GENERAL NOTES

Project No.: 102035
Owner: 1010 888 888 0000
Date: 1/17/2013
Architect: DW
As Indicated
DWG, Inc.

AO.01

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CODE ANALYSIS**BUILDING DATA**

PROJECT
ADDRESS: Chevy Chase, MD. 20815

SCOPE OF WORKS

This project involves the alteration, repair, and addition to an existing two and half-story plus cellar wood framed single family residence.

APPLICABLE BUILDING CODES:

This project conforms to the applicable building codes and zoning regulations for Montgomery County and the Village of Chevy Chase.

Building: International Residential Code - 2012

Electrical: NFPA National Electrical Code - 2008

Energy: International Energy Conservation Code - 2012

Amendments: Montgomery County Executive Regulation No. E-12

Zoning: Montgomery County Zoning Ordinance - Chapter 59

PERMITTED BUILDING HEIGHT

Two and a half stories plus a cellar

| FIRE-RESISTANT CONSTRUCTION TABLE E802.1 EXTERIOR WALLS | | | |
|---|--------------------------------|----------------------------------|--|
| EXTERIOR WALL ELEMENT | MINIMUM FIRE-RESISTANCE RATING | MINIMUM FIRE SEPARATION DISTANCE | |
| WALLS | 0 HOURS | > 5 FEET | |
| PROJECTIONS | 0 HOURS | 5 FEET | |
| OPENINGS IN WALLS | 0 HOURS | 5 FEET | |
| PENETRATIONS | None Required | 5 FEET | |

ZONING ANALYSIS**LOT - S / BLOCK - 47 / SECTION - 2 / CHEVY CHASE / R-60 - ZONING**

| REGULATION | EXISTING | PROPOSED | LOT COVERAGE - EXISTING | GROSS SQUARE FEET | EXISTING | PROPOSED | EXISTING + PROPOSED (TOTAL) | | |
|--|--------------------------|--------------|-------------------------|-------------------|-------------------------|----------------|--------------------------------|----------|-------------------|
| | | | CARAGE LESS | CELLAR - | FIRST LEVEL - | SECOND LEVEL - | ATTIC (1/2 LEVEL) - | TOTAL - | FLOOR AREA RATIO: |
| MINIMUM LOT AREA: | 7,500 SF | 7,500 SF | - | 335 SF | 1,043 SF | 476 SF | 1,519 SF | 476 SF | |
| MINIMUM LOT WIDTH: | 60 FT | 60 FT | 60 FT | 240 SF | 1,391 SF | 476 SF | 1,767 SF | 476 SF | |
| -AT FRONT OF BUILDING | 25 FT | 25 FT | 25 FT | 95 SF | 1,032 SF | 1,031 SF | 1,031 SF | 476 SF | 1,521 SF |
| MINIMUM SETBACK FROM STREET: (INTERIOR LOT) | 8 FT | 7'-6" | 7'-6" | 1,397 SF | TOTAL - | 387 SF | 245 SF | 632 SF | |
| SIDEYARD SETBACK (MAIN BUILDING): | 8 FT | 8 FT | 8 FT | 1,930 SF | TOTAL LOT - | 3,772 SF | 1,673 SF | 5,445 SF | |
| -MAIN STORY | 18 FT | 20' - 6 1/2" | 21' - 6 1/2" | 19% | 19% | 1,043 SF | 476 SF | 1,519 SF | |
| -SUM OF 2 SIDEYARDS (MINIMUM) | 18 FT | 20' - 6 1/2" | 21' - 6 1/2" | | LOT COVERAGE - PROPOSED | 1,043 SF | 476 SF | 1,519 SF | |
| -AT ADDITION | 20 FT | 52' - 10" | 42' - 10 1/2" | | CARAGE LESS | 335 SF | 476 SF | 1,767 SF | |
| -MINIMUM REAR YARD | | | | | CELLAR - | 1,391 SF | 1,051 SF | 1,521 SF | |
| SIDEYARD SETBACK (VILLAGE OF CHEVY CHASE) | 7'-0" | 7'-0" | 7'-0" | | FIRST LEVEL - | 245 SF | 387 SF | 632 SF | |
| -MINIMUM REAR YARD | | | | | SECOND LEVEL - | 476 SF | 476 SF | 1,327 SF | |
| AT EXISTING BUILDING | | | | | ATTIC (1/2 LEVEL) - | | | | |
| -AT ADDITION | | | | | TOTAL - | 3,772 SF | 1,673 SF | 5,445 SF | |
| SIDEYARD SETBACK (COVERED) | 5'-0" | 3'-6" | 3'-6" | | | | | | |
| -MINIMUM SIDEYARD SETBACK | | | | | | | | | |
| -AT EXISTING BUILDING (NO CUTTER) | | | | | | | | | |
| -AT ADDITION (NO CUTTER) | | | | | | | | | |
| -AT ADDITION (WITH CUTTER) | | | | | | | | | |
| MATERIAL BUILDING HEIGHT: | 30'-35 FT | 32' - 9 1/2" | 32' - 9 1/2" | | | | | | |
| MATERIAL BUILDING COVERAGE: | 35% | 19% | 24% | | | | | | |
| PARKING: | 2 UFS STREET | 2 | 2 | | | | | | |
| | SPACES FOR DWELLING UNIT | | | | | | | | |

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|---|--|
| PROJECT NO.: 13A | Architects: sqdquare |
| ADDRESS: 5 East Meade Street, Chevy Chase, MD. 20815 | PHONE: 301-961-5200 |
| SCOPE OF WORKS: This project involves the alteration, repair, and addition to an existing two and half-story plus cellar wood framed single family residence. | CLIMATE: Climate Zone 4A |
| APPLICABLE BUILDING CODES: This project conforms to the applicable building codes and zoning regulations for Montgomery County and the Village of Chevy Chase. | U-Factor: 0.40 |
| Building: | R-value: 0.75 |
| Electrical: | Glassed Penetrations SHCC (U-Factor): 0.40 |
| Energy: | Calling (R-value): 30 |
| Amendments: | Frame Wall (R-value): 1.3 |
| Zoning: | Mass Wall (R-value): 5/10 |
| | Floor (R-value): 1.9 |
| | Basement Wall (R-value): 10/13 |
| | Slab (R-value and Depth): 10, 2FT |
| | Crawl Space Wall (U-Factor and R-value): 0.055 |
| | 10/13 |
| COMPLIANCE WITH 2012 INTERNATIONAL ENERGY CONSTRUCTION CODE: | |
| CHERRY MEADE STREET, CHEVY CHASE, MD. 20815 | |
| 5 EAST MEADE STREET | |
| ANALYSIS | |
| ZONING AND CODE | |
| DRAWING TITLE | |
| DRAWING NO. A0.02 | |
| DATE: 11/17/2013 | |
| SCALE: 3/8" = 1'-0" | |
| DRAFT. NO. | |

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A0.05

12

| | | | | |
|---------------|-----|------------------------|-----|---|
| Architects | 13A | Squares | 13B | POLYGRAPHIC LTD 3135 S 3000 W, SUITE 110, UTAH, 84116 |
| Daytime Title | | Architect | | CONWAY RESIDENCE |
| Date: | | Architectural Drawings | | 5 East Main Street, Suite 110, Conway, NC 28615 |

DOOR AND WINDOW SCHEDULE

DRAWING TITLE: DOOR AND WINDOW

| Door Number | Code No. | Panel | Type | Dimensions | Series | MATERIAL | FINISH | Point |
|-------------|----------|-------|------|------------|--------|----------|--------|-------|
| 1 | 140 | 140 | 140 | 140 | 140 | 140 | 140 | 140 |
| 2 | 140 | 140 | 140 | 140 | 140 | 140 | 140 | 140 |
| 3 | 140 | 140 | 140 | 140 | 140 | 140 | 140 | 140 |

| Door Number | Code No. | Panel | Type | Dimensions | Series | MATERIAL | FINISH | Point |
|-------------|----------|-------|------|------------|--------|----------|--------|-------|
| 4 | 140 | 140 | 140 | 140 | 140 | 140 | 140 | 140 |
| 5 | 140 | 140 | 140 | 140 | 140 | 140 | 140 | 140 |
| 6 | 140 | 140 | 140 | 140 | 140 | 140 | 140 | 140 |
| 7 | 140 | 140 | 140 | 140 | 140 | 140 | 140 | 140 |

DOOR SCHEDULE

DOOR SCHEDULE

Door Number

Code No.

Panel

Type






Dimensions

Series

MATERIAL

FINISH

Point

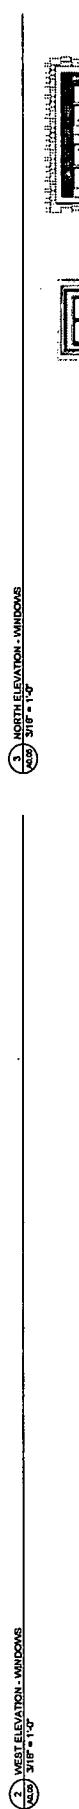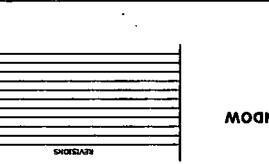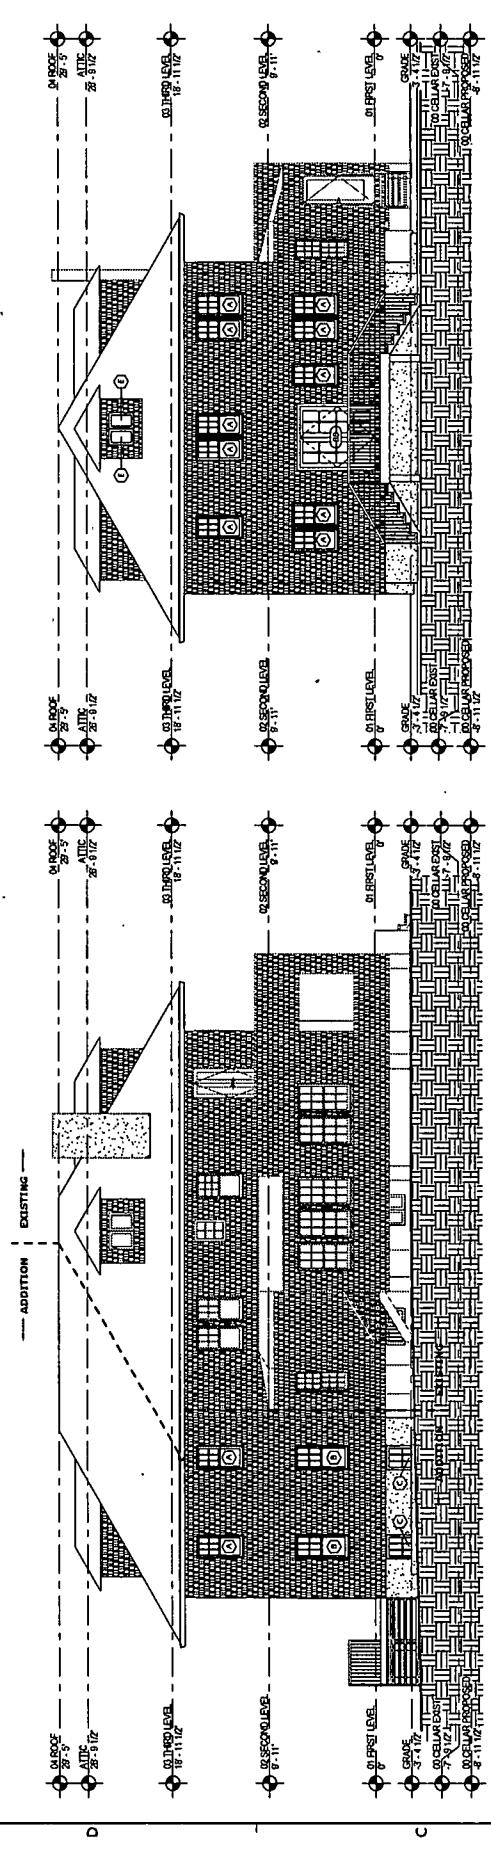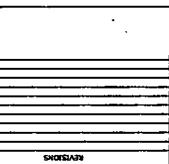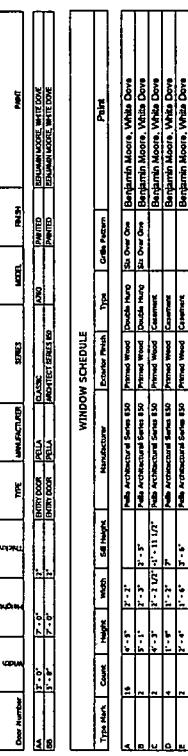

DOOR AND WINDOW SCHEDULE

DRAWING TITLE: DOOR AND WINDOW

| | | | | |
|-----------|-----|------------------------|-----|---|
| Architect | 13A | Squares | 13B | POLYGRAPHIC LTD 3135 S 3000 W, SUITE 110, UTAH, 84116 |
| Date: | | Architectural Drawings | | CONWAY RESIDENCE |
| Date: | | Architect | | 5 East Main Street, Suite 110, Conway, NC 28615 |

| | | | | |
|---------------|--|-----------|--|---|
| Daytime Title | | Architect | | POLYGRAPHIC LTD 3135 S 3000 W, SUITE 110, UTAH, 84116 |
| Date: | | Architect | | CONWAY RESIDENCE |
| Date: | | Architect | | 5 East Main Street, Suite 110, Conway, NC 28615 |

13


A0.06

PROJECT NO. 130125
DRAWING NO. 11/11/2013
SCALE: As Indicated
DATE: 11/11/2013
DRAFT. NO.

SITE PLAN


CONWAY RESIDENCE
5 East Melrose Street
Chevy Chase, MD 20815
1100 Connecticut Avenue, NW, Washington, DC 20008

Architects
square 134 Architects
FIRECODE 2010 10/2010 01/15 2011

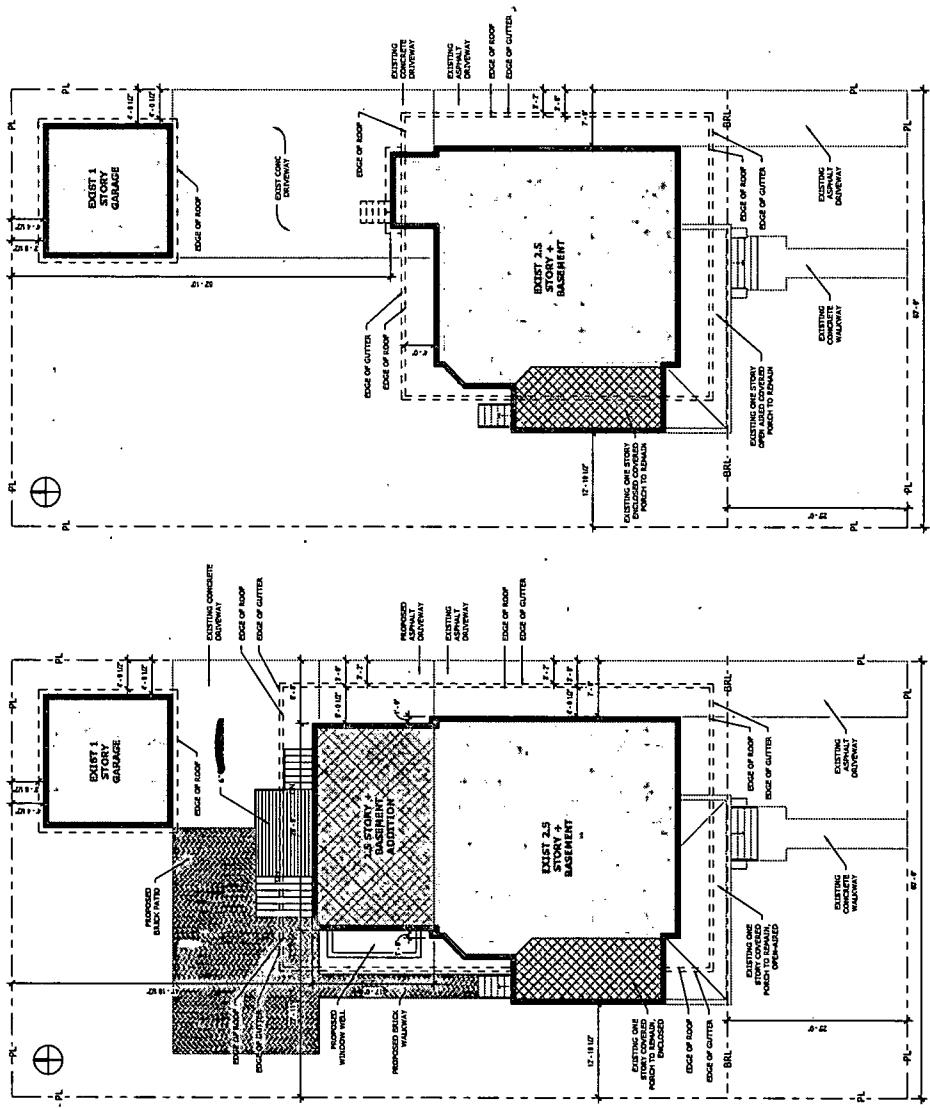

1 SITE PLAN - EXISTING

2 SITE PLAN - PROPOSED

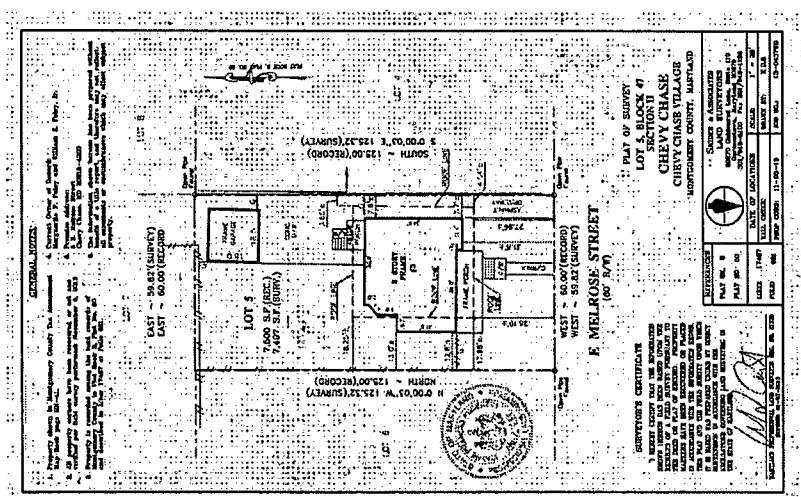

3 SURVEY
1" = 20'-0"

(13)

A0.D1

① 10 CELLAR - DEMO
14'-0" X 14'-0"

② 1st FLOOR - DEMO
14'-0" X 14'-0"

14

DEMOLITION PLANS -

LEVEL CELLAR AND FIRST

DEMOLITION TITLE

CONWAY RESIDENCE


5 East Monroe Street

Chevy Chase, MD 20811

1410 Sherman Way, Washington, DC 20007


4000 32nd Street NW, Washington, DC 20007

4000 32nd Street NW, Washington, DC 20007

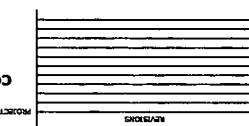

REINFORCING

WALLS

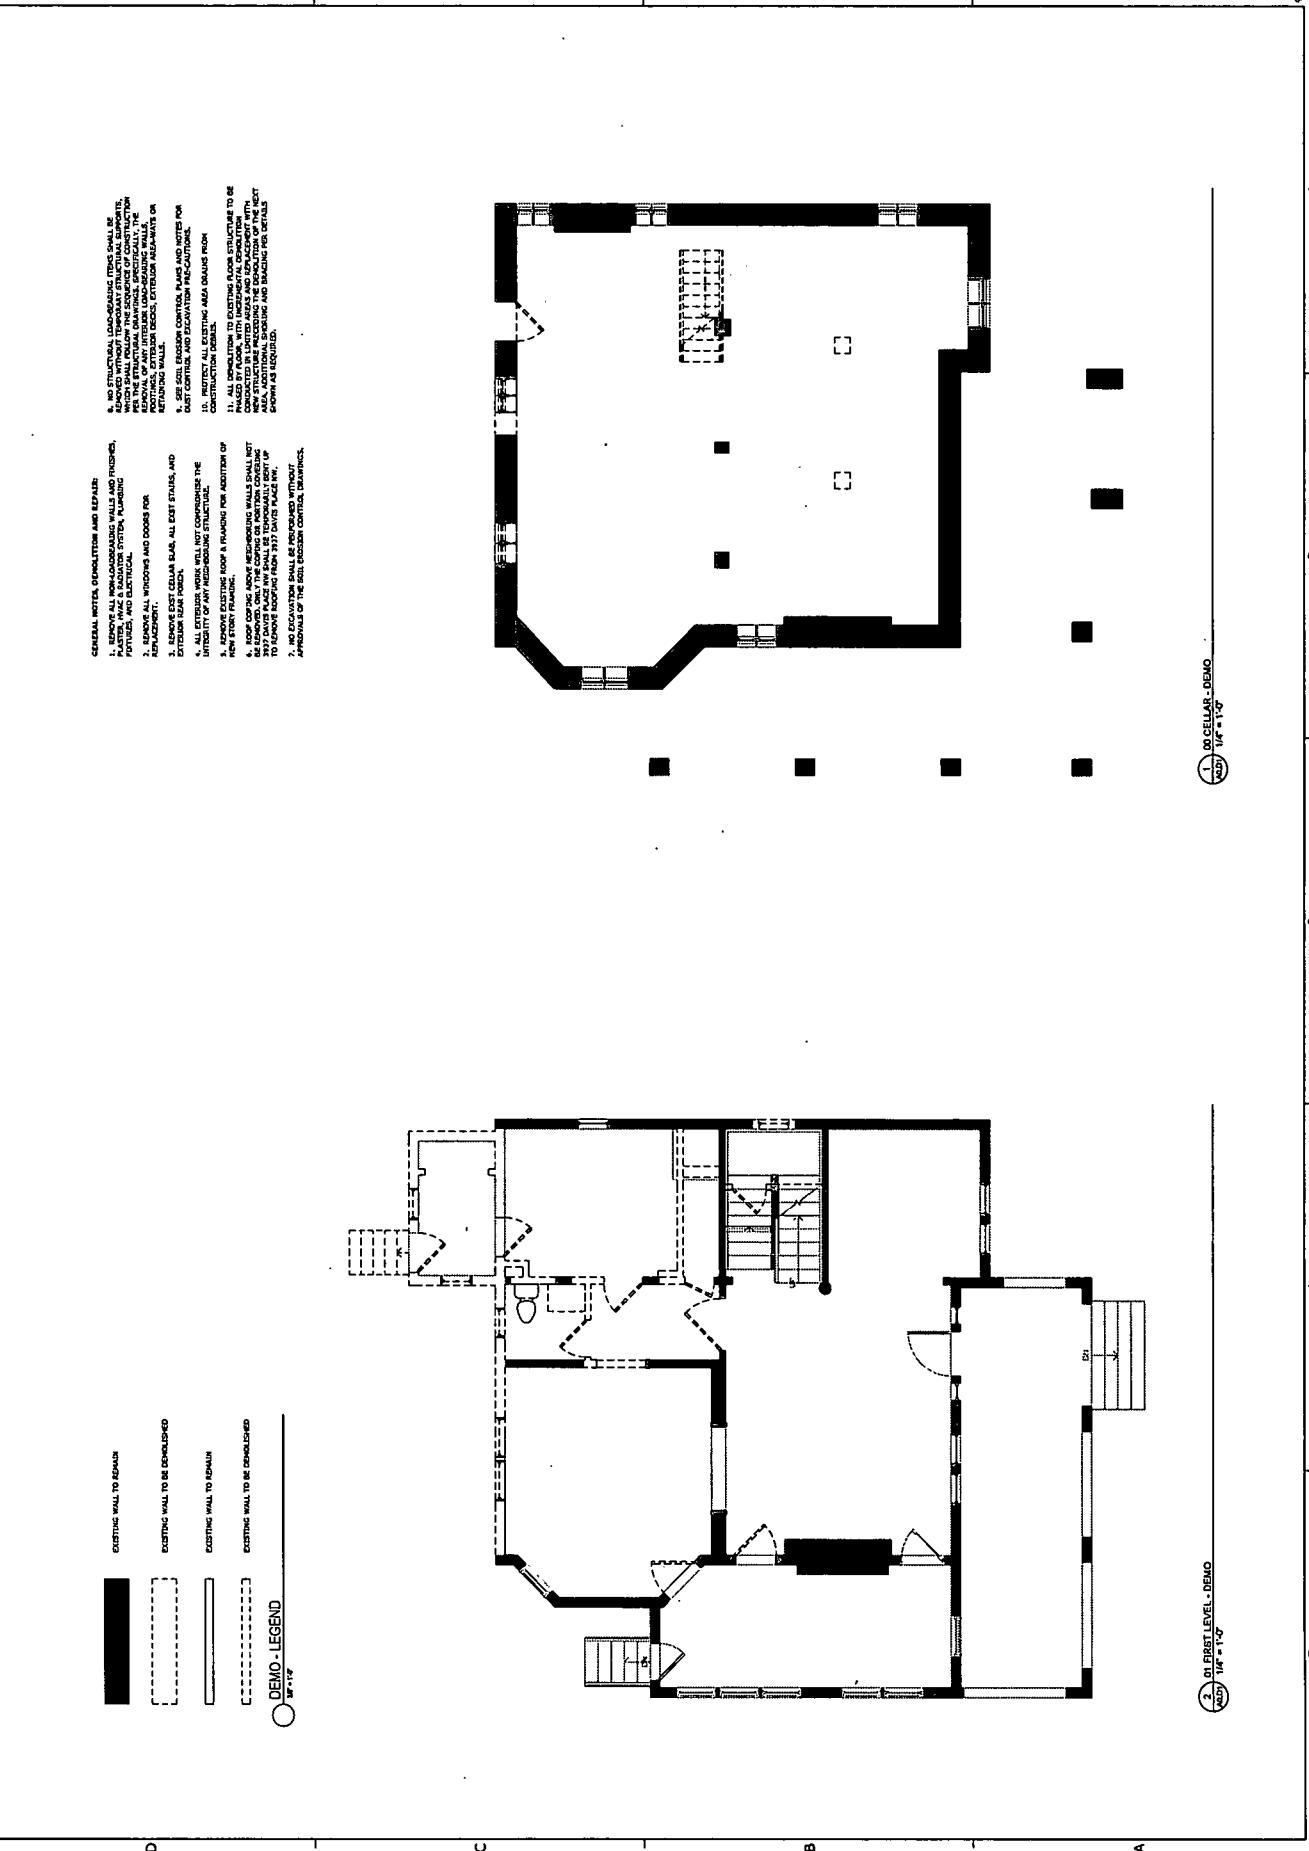

A0.D2

1/2 SECOND LEVEL DEMO

1/2 THIRD LEVEL DEMO

SECTION: 13025
DRAWN BY:
SCALE: AS Indicated
DATE: 11/17/2013
CIVIC NO.




DEMOLITION PLANS -
SECOND AND THIRD
LEVEL

DEMOLITION TITLE

CONWAY RESIDENCE
REVISIONS

2 EASY MELT-OUT DRAFTS
CHWY-QM-A1-HD-10005

4/2013 10/14/2013 10/14/2013
14100 SW 34TH AVENUE, MIAMI, FL 33175
SQUARE 134 Architects

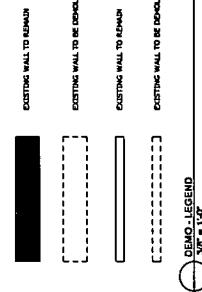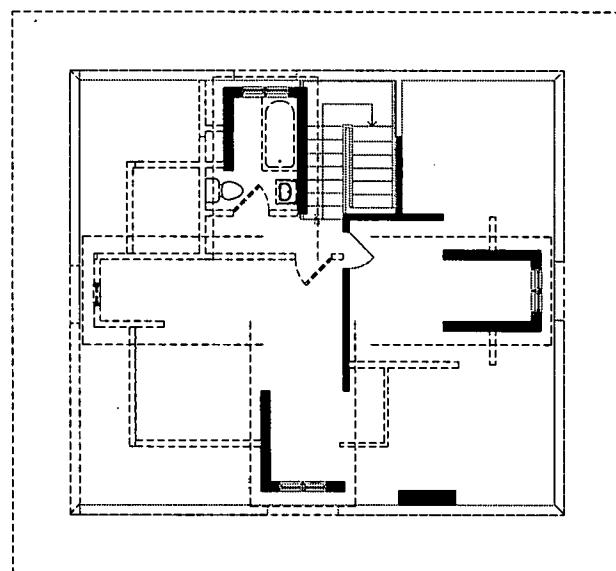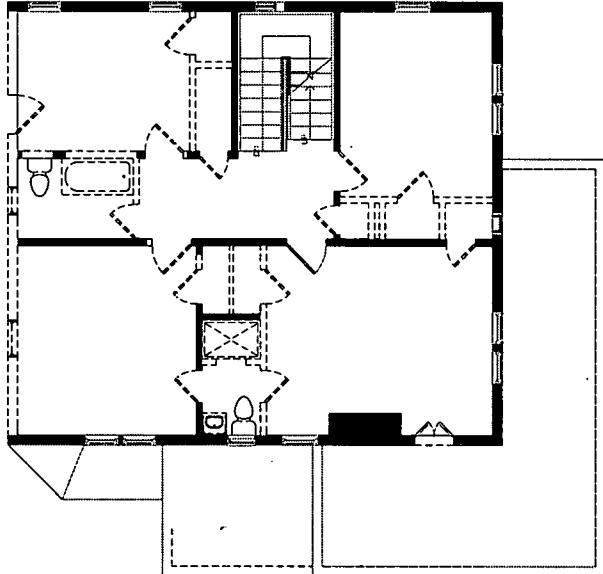

D

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15

A1.00

1 DO CELLAR



2 1ST LEVEL

PROJECT NO. 13025
DRAWN BY:
SCALE: As Indicated
DATE: 11/27/2013
DWC, INC.

CONWAY RESIDENCE
5 East Market Street
Cherry Creek, CO 80009
DRAWING TITLE: FLOOR PLANS - CELLAR
SQUARES 134 ARCHITECTS

1110 Sante Fe Dr., Suite 1100
Boulder, CO 80303
(303) 449-1313

GENERAL NOTES - Poured Concrete
 1. EXTERIOR GRADE TO EXISTING MORTARS TO BE FIELD
LEVELLED FLAT TO EXFILLATION.
 2. INTERIOR OF PERIMETER WALLS & LADDER FLORS TO BE
PLASTERED WITH PLASTERATIVE TREATED LUMBER, WATER,
PLASTER-COAT WITH PLASTERATIVE TREATED LUMBER, WATER,
PLASTER-COAT WITH PLASTERATIVE TREATED LUMBER, WATER,
REINFORCED WITH 10# GAGE METAL GUARDIAN TO CODE
REINFORCED WITH 10# GAGE METAL GUARDIAN TO CODE.
 3. ALL WOOD FRAMES TO CODE 7# MAX SIZES, 11# MIN THROZ DEPTH.
 4. CONCRETE SLAB TO BE CEMENT FINISHING.
 5. CONCRETE SLAB TO BE CEMENT FINISHING.
 6. EXTERIOR DOORS TO SWING OUTWARD, PINE SOLID/1/2" THICK
 7. NEW PAINTED CONCRETE SLAB w/ CONCRETE EXTRUSION STAIRS TO
 GROUND.

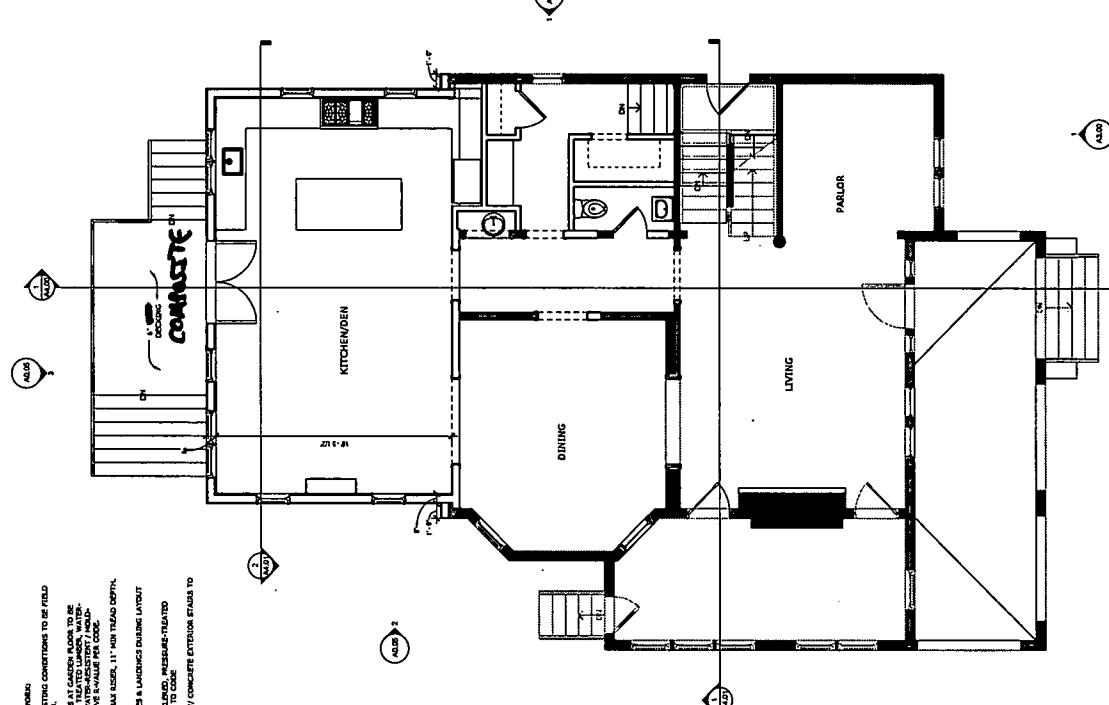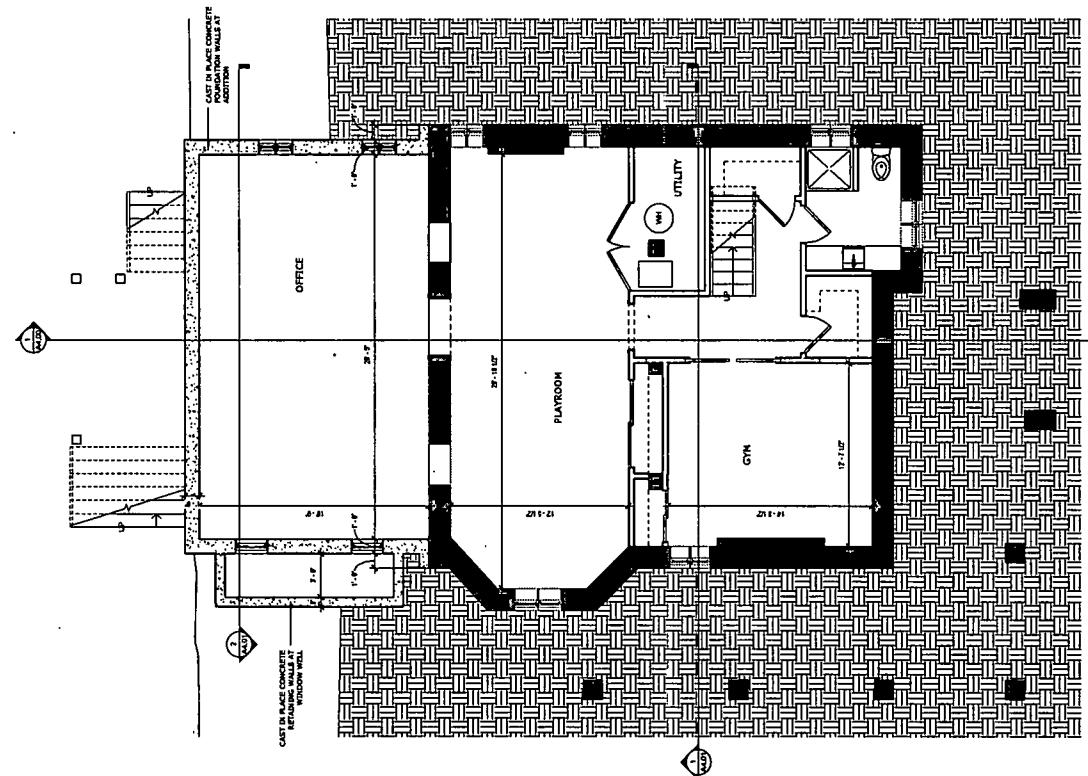

Detailed Notes - Poured Concrete

1. EXTERIOR GRADE TO EXISTING MORTARS TO BE FIELD
LEVELLED FLAT TO EXFILLATION.
2. INTERIOR OF PERIMETER WALLS & LADDER FLORS TO BE
PLASTERED WITH PLASTERATIVE TREATED LUMBER, WATER,
PLASTER-COAT WITH PLASTERATIVE TREATED LUMBER, WATER,
PLASTER-COAT WITH PLASTERATIVE TREATED LUMBER, WATER,
REINFORCED WITH 10# GAGE METAL GUARDIAN TO CODE
REINFORCED WITH 10# GAGE METAL GUARDIAN TO CODE.
3. ALL WOOD FRAMES TO CODE 7# MAX SIZES, 11# MIN THROZ DEPTH.
4. CONCRETE SLAB TO BE CEMENT FINISHING.
5. CONCRETE SLAB TO BE CEMENT FINISHING.
6. EXTERIOR DOORS TO SWING OUTWARD, PINE SOLID/1/2" THICK
7. NEW PAINTED CONCRETE SLAB w/ CONCRETE EXTRUSION STAIRS TO
GROUND.

D

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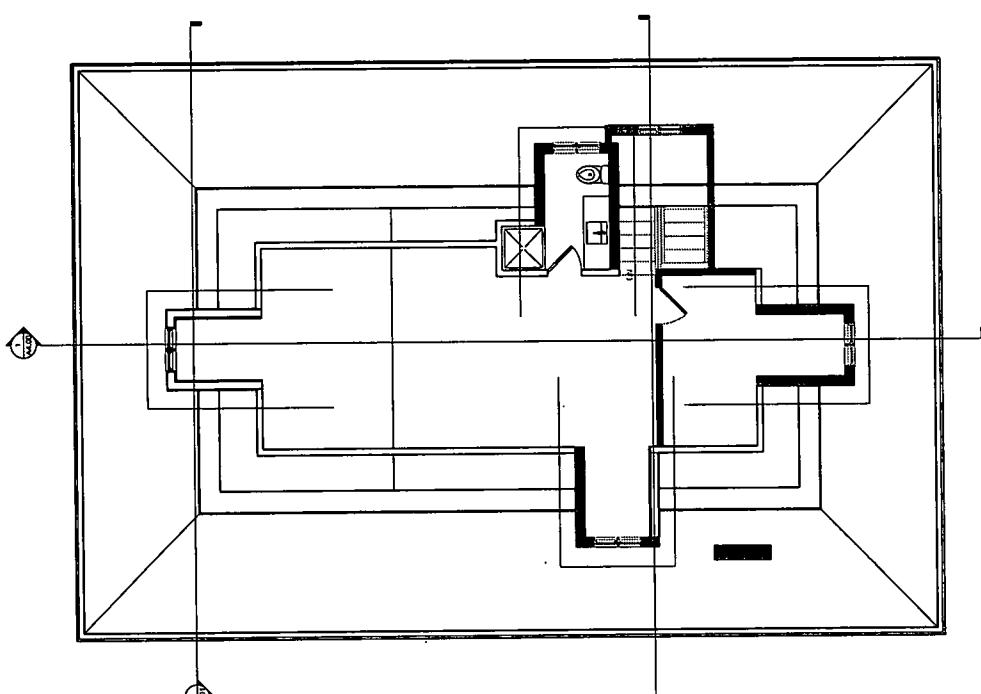
16

A1.01

Architects
Square 134
1410 Morris Street
Cherry Creek, MD, 20815
5 EASY STEPS
1410 Morris Street
Cherry Creek, MD, 20815
1410 Morris Street
Cherry Creek, MD, 20815
1410 Morris Street
Cherry Creek, MD, 20815

CONWAY RESIDENCE
DRAWING TITLE
FLOOR PLANS - SECOND
AND THIRD LEVEL
DRAWING DATE
11/12/2013
DRAFTS
SCALE
As Indicated
DATE:
11/12/2013
DWG. NO.
13025
DRAWN BY:

GENERAL NOTES - PREPARED WORK
1. DIMENSIONS RELATIVE TO EXISTING CONDITIONS TO BE MADE
VERIFIED PRIOR TO INSTALLATION.
2. DETAILS OF PIERCED WALLS AT GROUND FLOOR TO BE
PLACED ON ATTACHED SHEET TO DRAWING NUMBER 13025.
3. ALL NEW STUCCO TO HAVE 1/4" MIN THICKNESS.
4. CONCRETE SLAB TO HAVE 11" MIN THICKNESS.
5. EXTERIOR DOORS TO BE SUBSTITUTED AS INDICATED
6. NEW Poured CONCRETE SLAB w/ CONCRETE EXTERIOR STUDS TO
EXISTING CONCRETE SLAB.



(2) ON THIRD LEVEL
1/4" = 1'-0"

D I C L B A

A

A1.02

PROJECT NO. 13035
DRAWN BY: DATE 2/23/2013
SCALE: 1/4" = 1'-0"
DRAFT. INC.

FLOOR PLANS - ROOF

CONWAY RESIDENCE
5 Elmira Street
Chevy Chase, MD 20815
1100 Shady Woods Drive, Bethesda, MD 20815
FAX: 301-961-3415


Architect

Square

134

Notes:

ROOFING MATERIAL
HANSONS

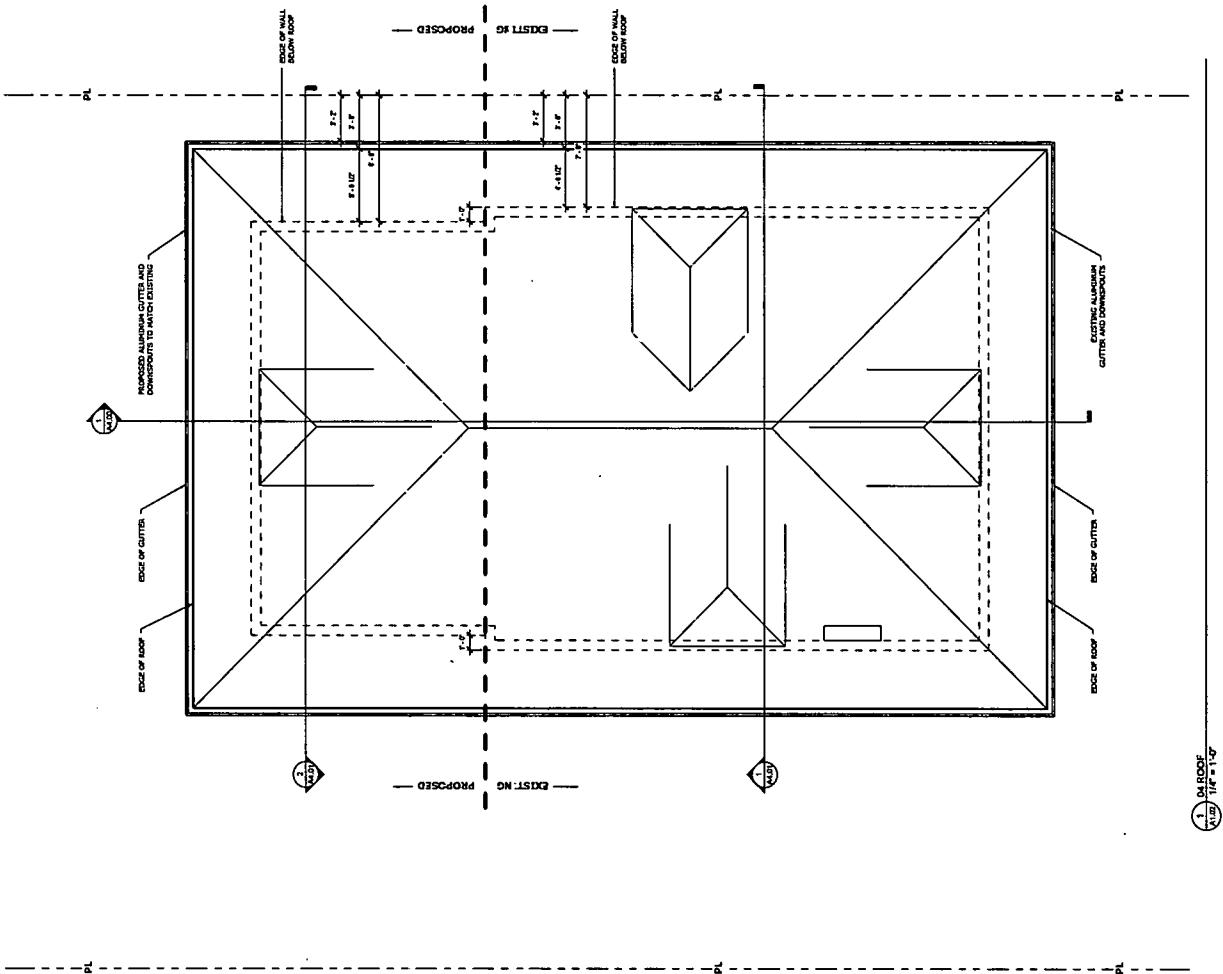

1

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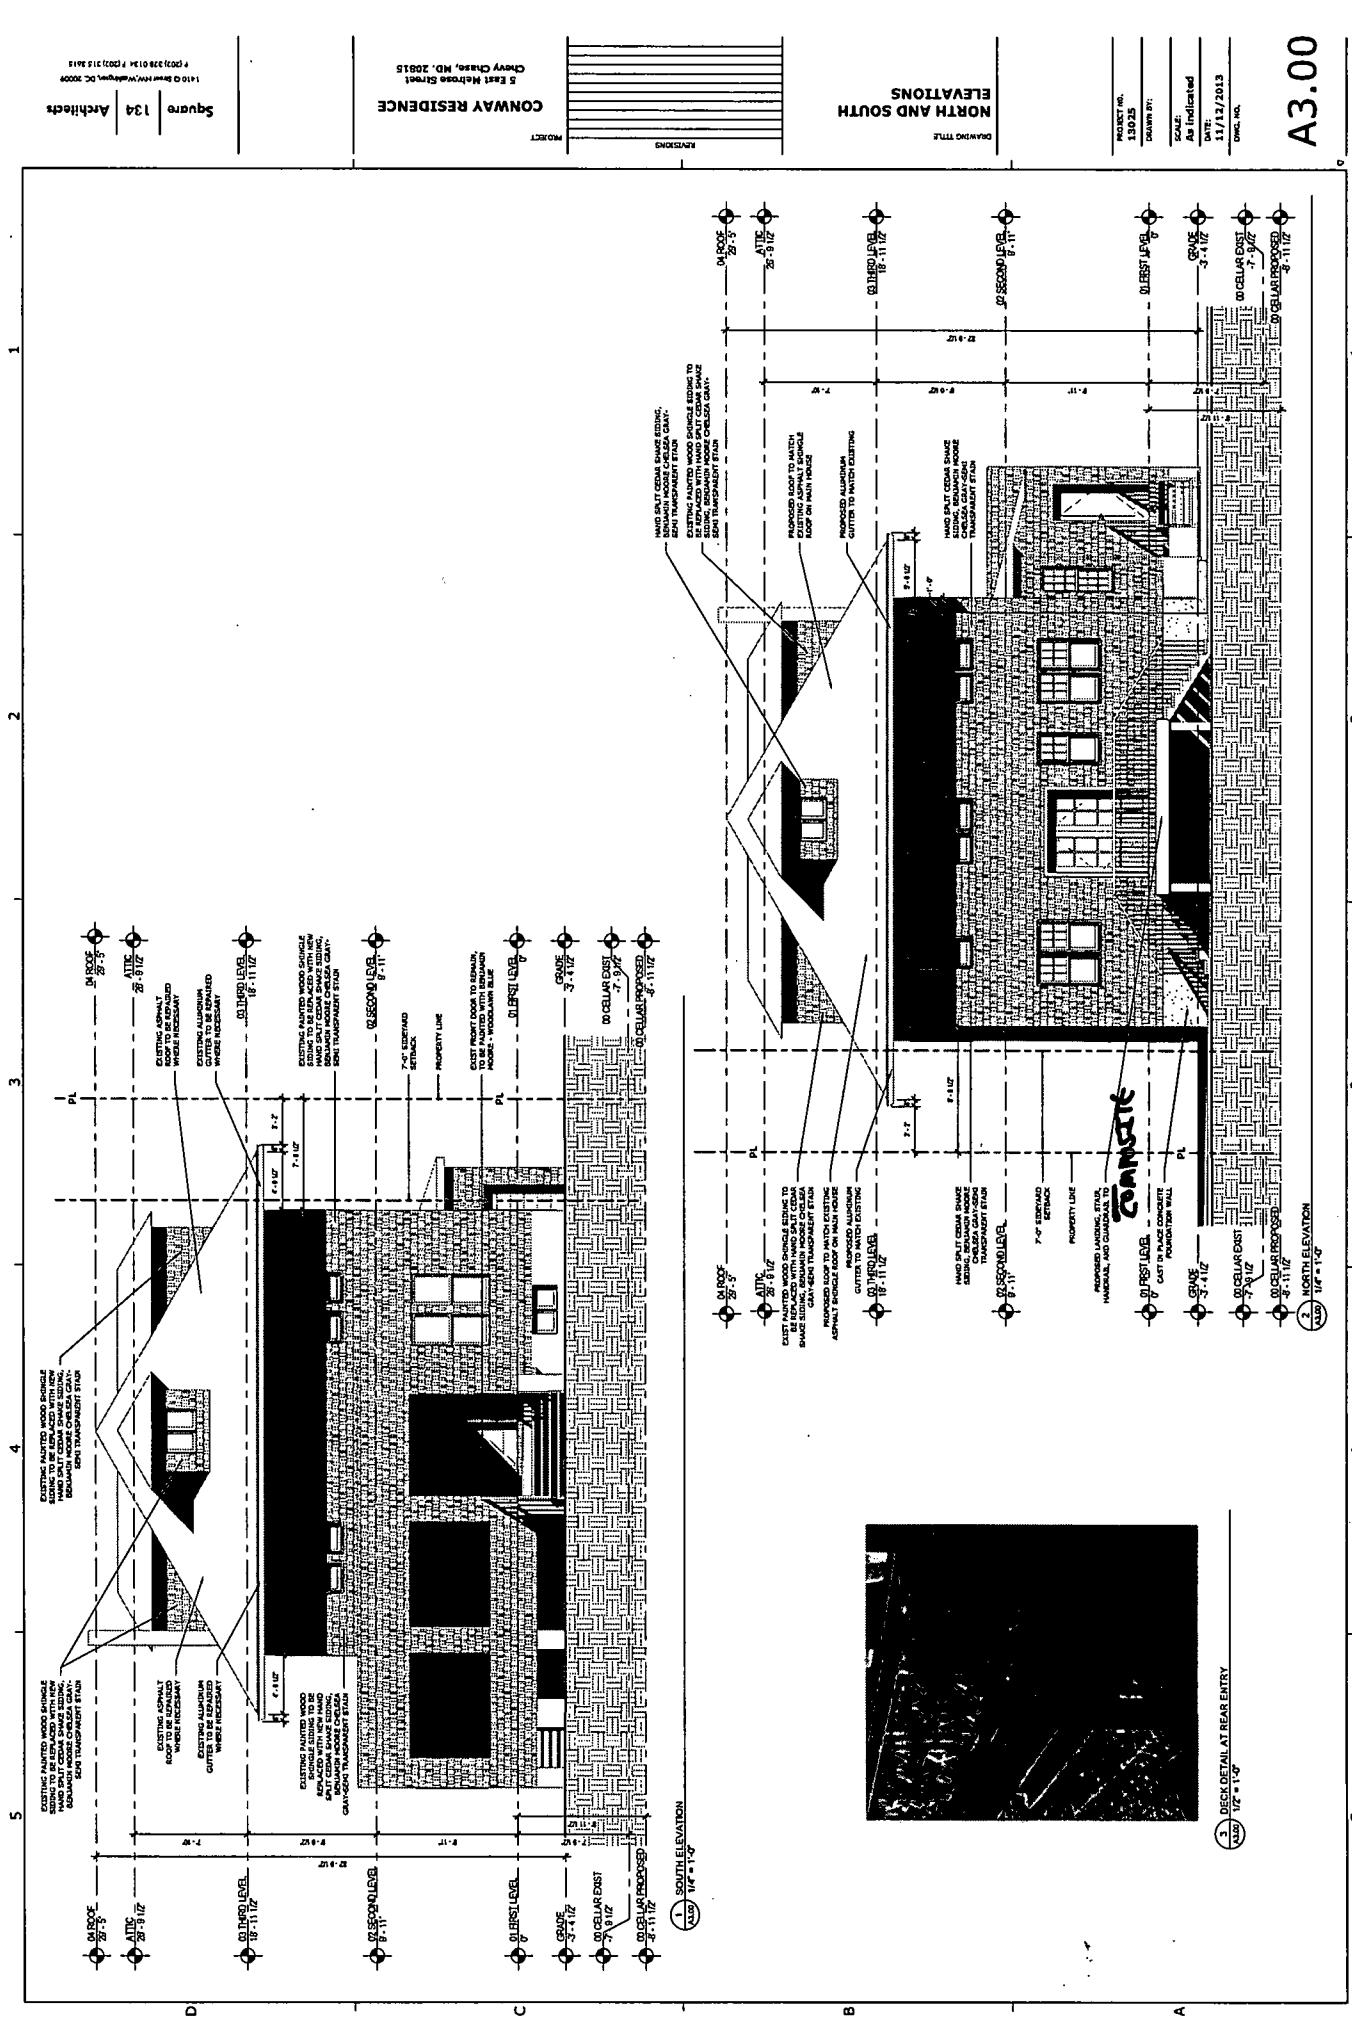
D

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A3.00



A3.01

PROJECT NO.
130235
DRAWING SET:
1/4" = 1'-0"
DATE:
11/14/2013
DRAFTS:


EAST ELEVATION
14'-1"

A

CNWAY RESIDENCE
5 EAST MULRONE STREET
CHERRY CREEK, MD, 20201
1100 SARASINA WAY, WOODBURN, OR 97045
4 PAGES
13A Square Architects

LEVELS: GROUND FLOOR, 1ST FLOOR, 2ND FLOOR, ROOF

SECTION: ELEVATION, EAST ELEVATION

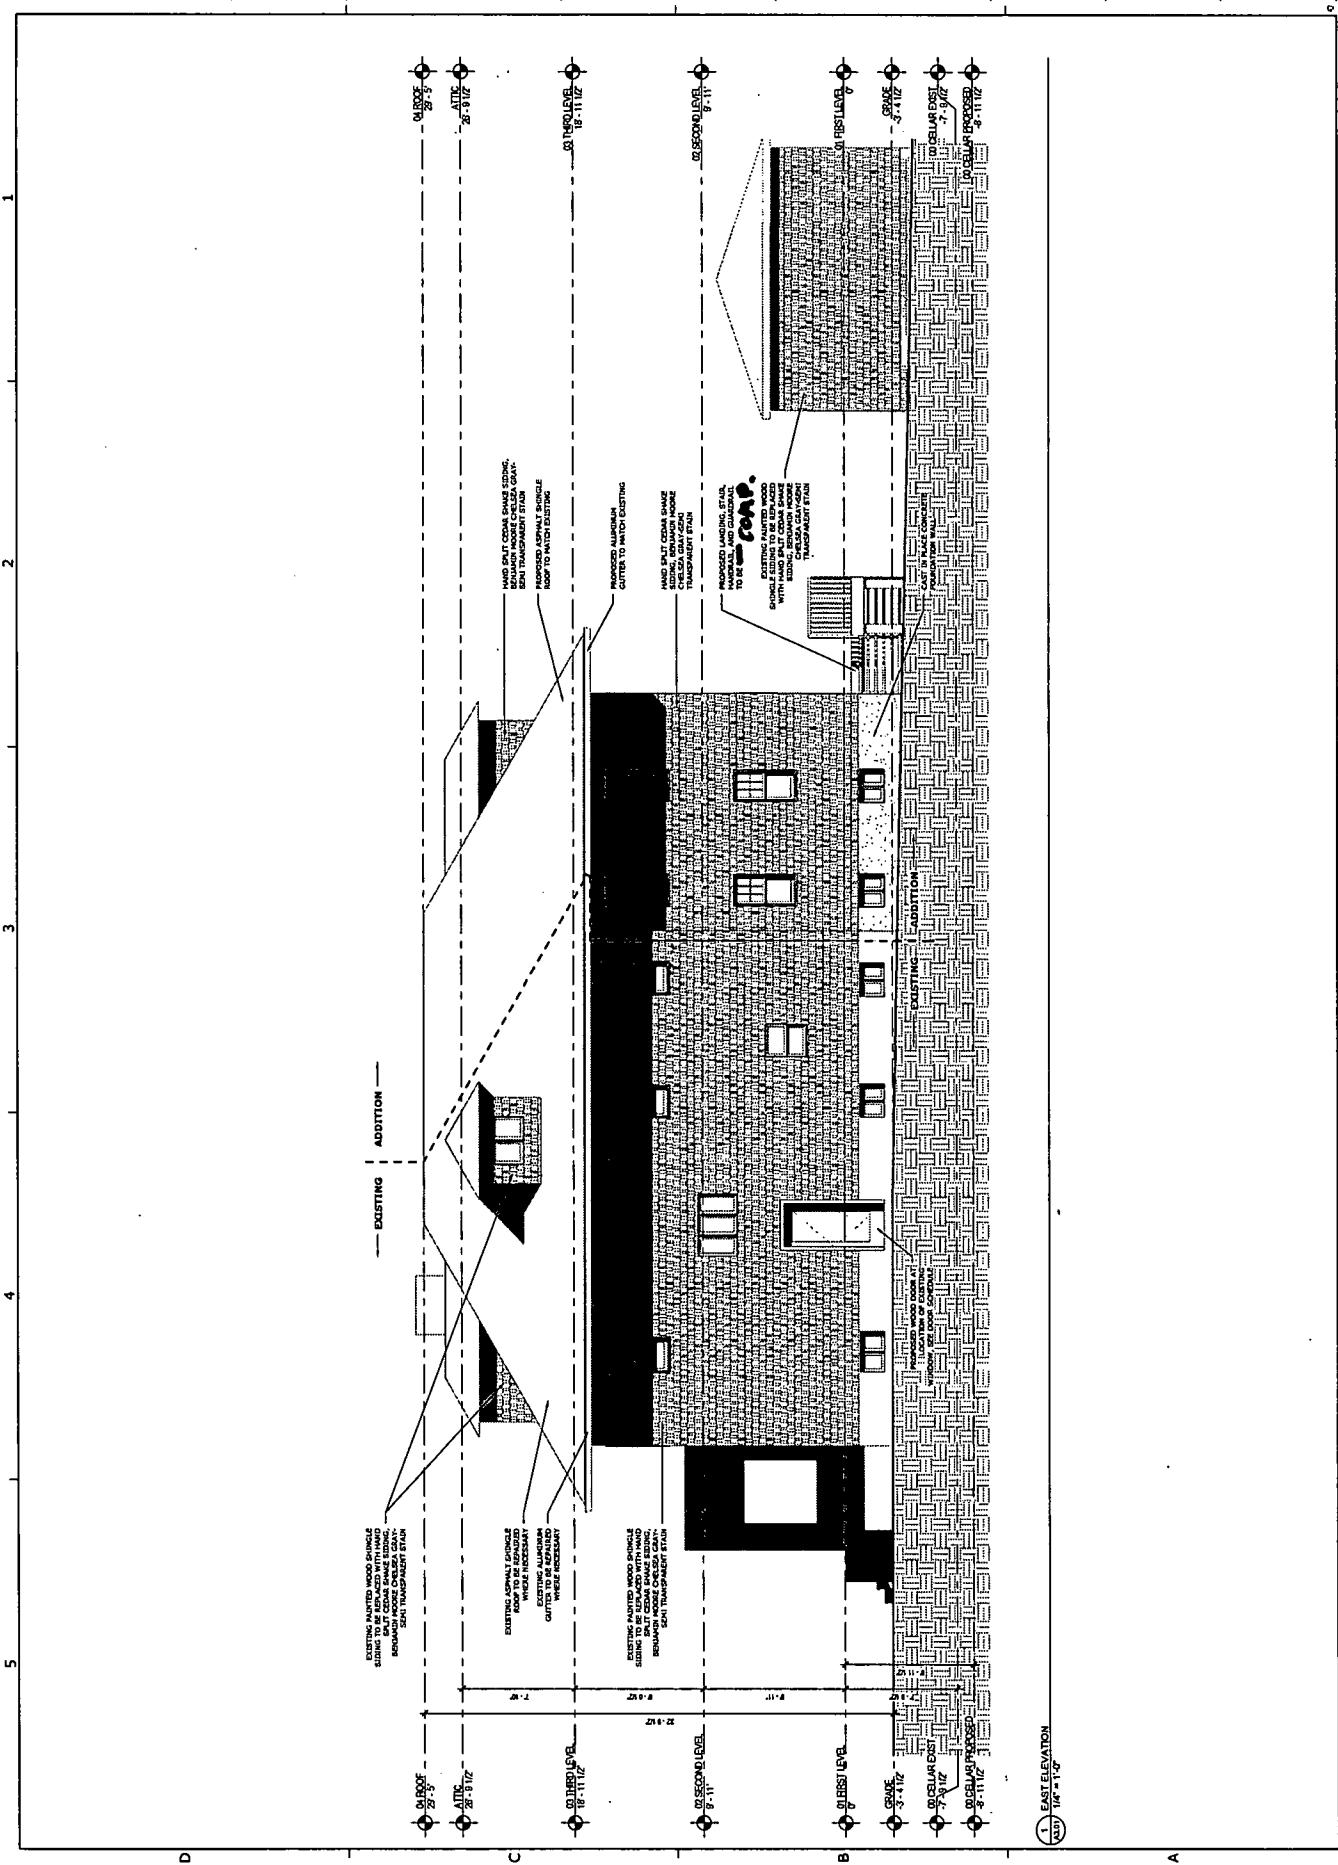


20

A3.02

(21)

WEST ELEVATION
1/4" = 1'-0"

PROJECT NO.: 13325
DRAWN BY: DATE: 11/17/2013
SCALE: 1/4" = 1'-0"
CIVIL NO.

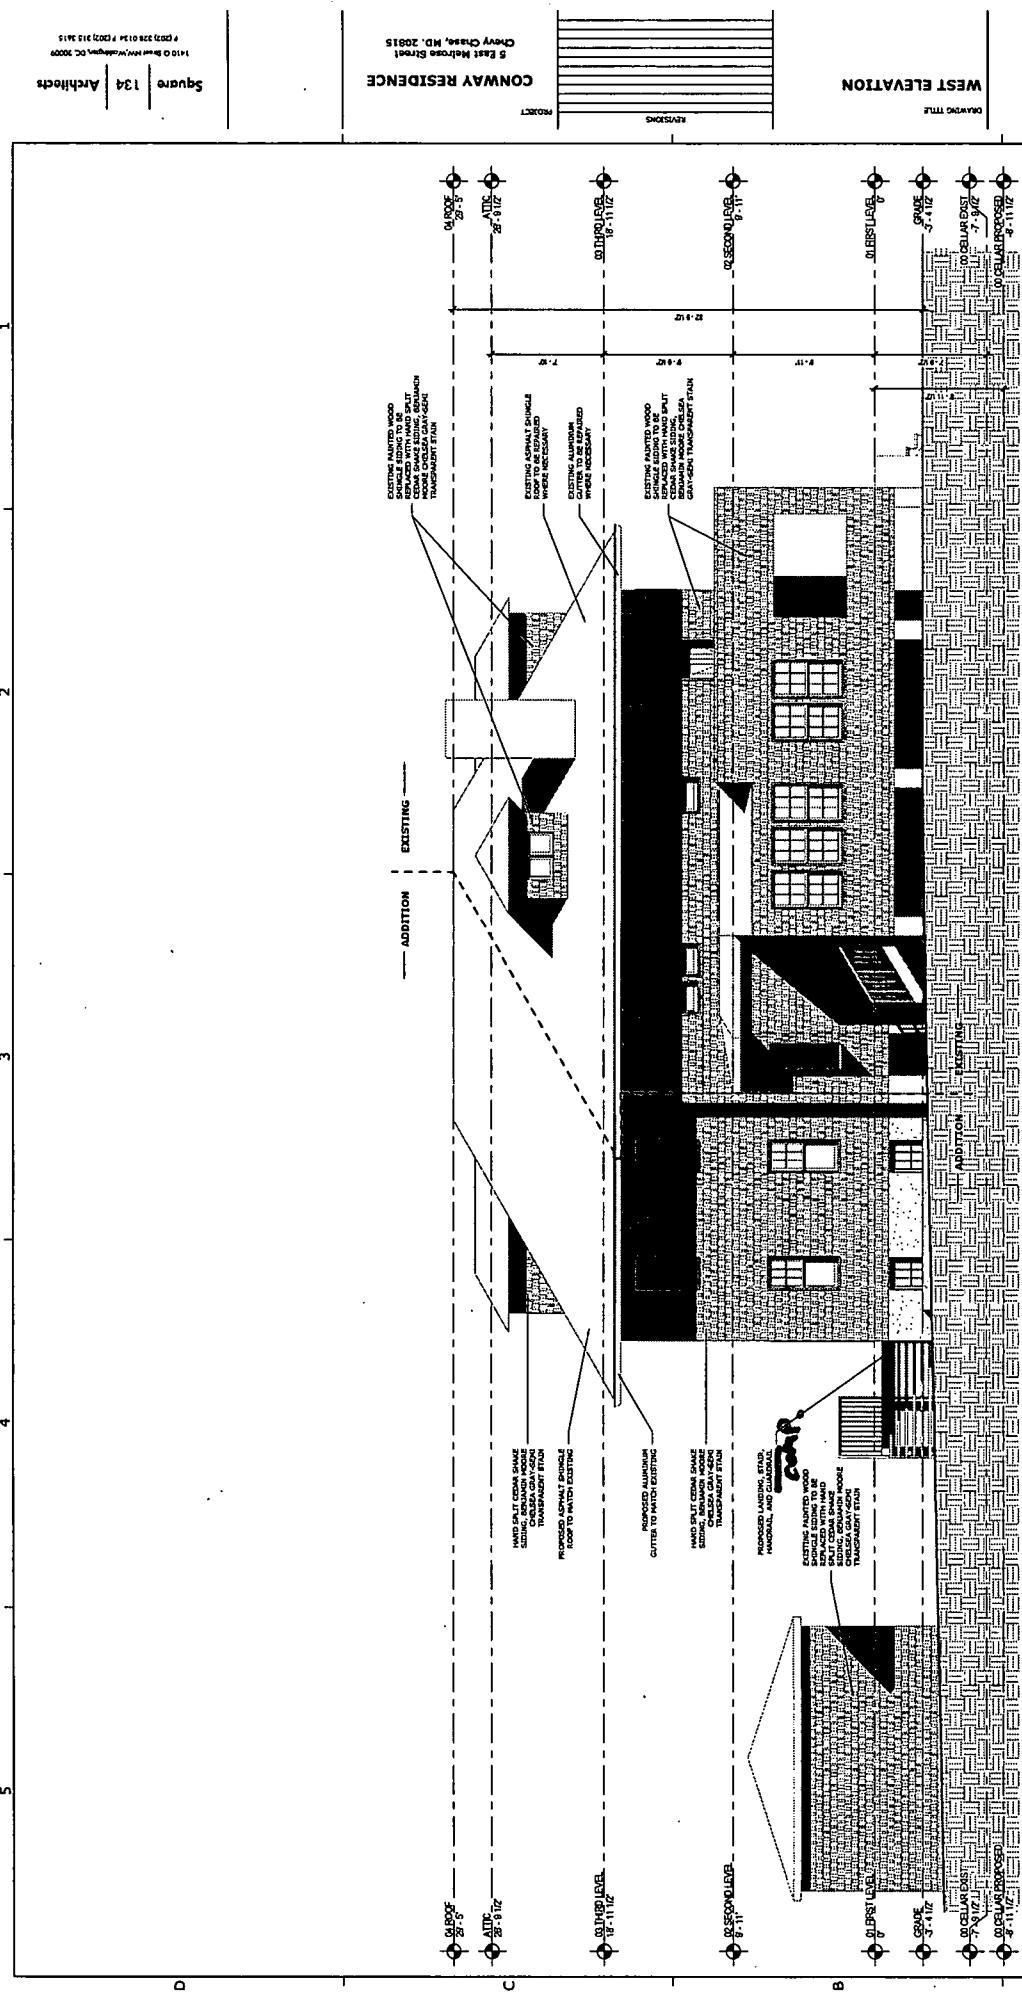

A4.00

PROJECT NO.
13025
DRAWING NO.:
C-101
SCALE:
1/8" = 1'-0"
DATE:
11/12/2013
CROSS REF:

BUILDING SECTION

DRAWING TITLE

REVISONS

CONWAY RESIDENCE
5 East Monroe Rd, 20015
Chevy Chase, MD 20815
1100 Sherman Way, Bethesda, MD 20804
4000 Wisconsin Ave, Washington, DC 20007

Square 134 Architects

1

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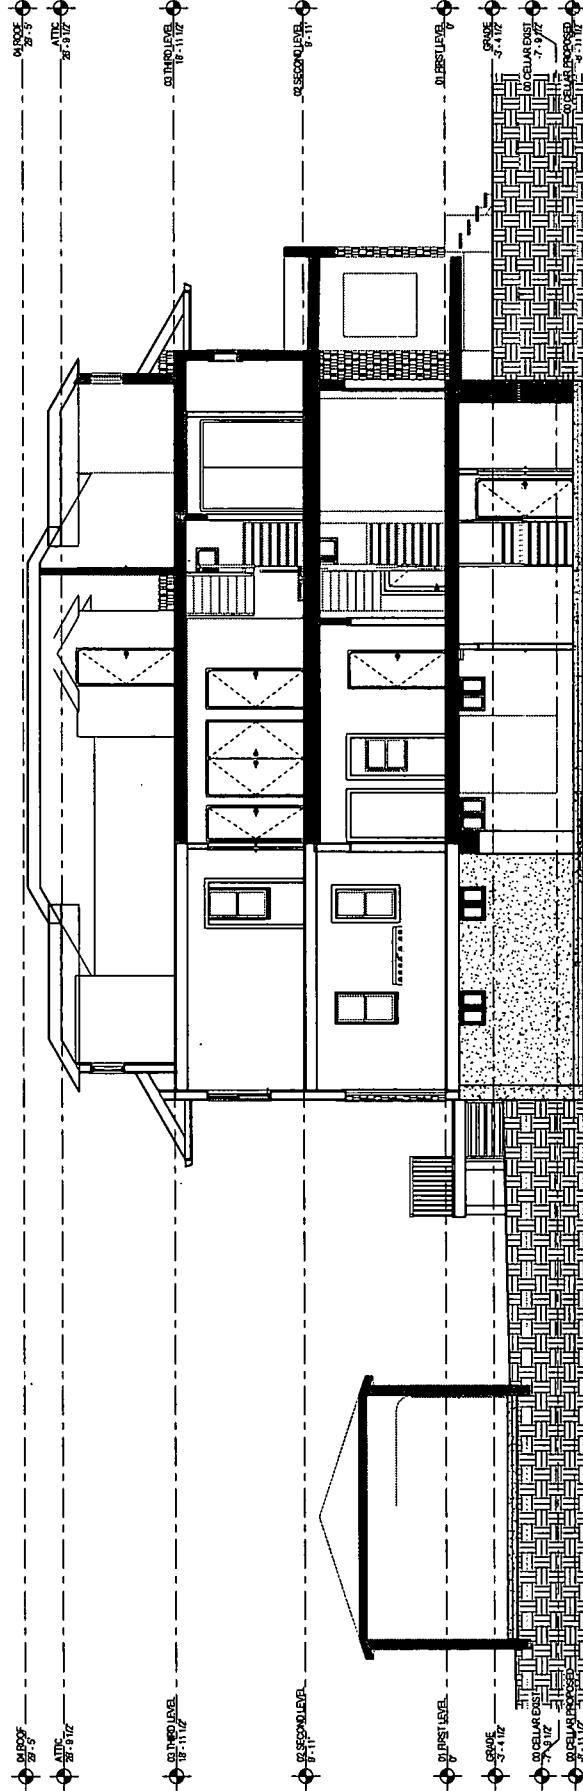
5

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SECTION 1
1/8" = 1'-0"


22

A4.01

23



PROJECT NO. 13025
DRAWING NO. 13025
DATE: 11/12/2013
SCALE: 1/4" = 1'-0"
DRAFTS: 13025
CONTRACTOR: C&C CONSTRUCTION CO., INC.
ADDRESS: 5 East Main Street, Cherry Hill, NJ 08002
PHONE: (800) 344-4444

BUILDING SECTIONS

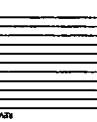

CONWAY RESIDENCE
SECTION 2

BUILDING SECTION 2

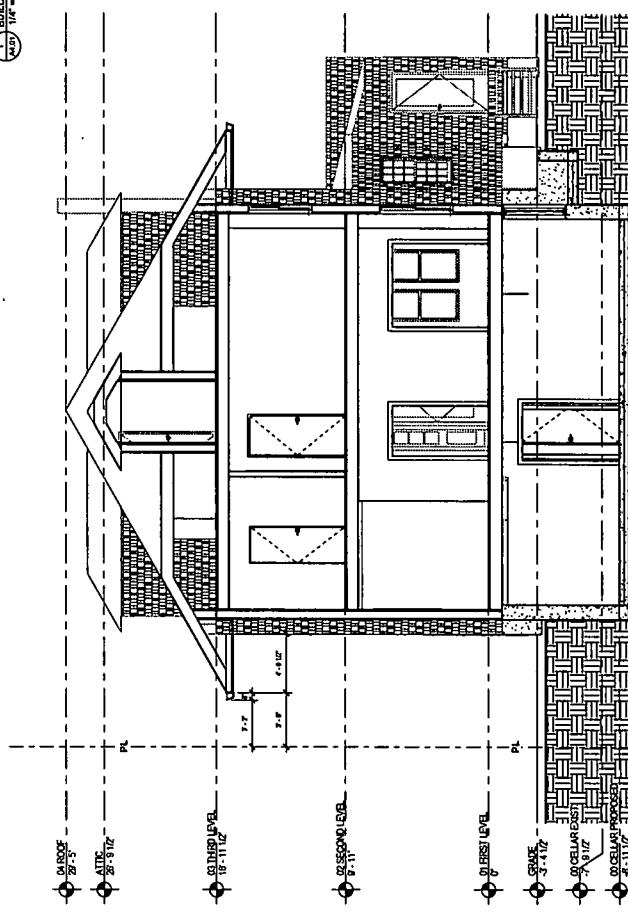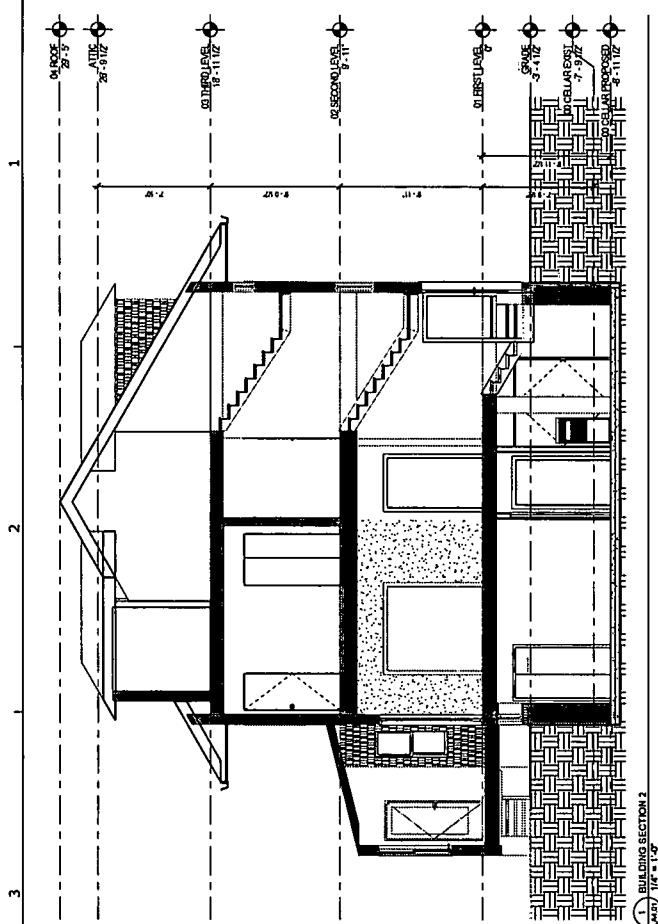

BUILDING SECTION 3
1/4" = 1'-0"

D

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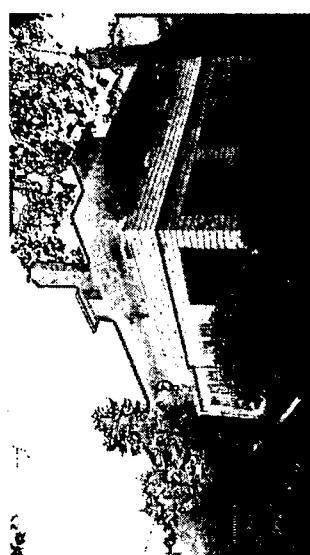
A9.00

PROJECT NO.
130/25
DRAWING NO.:
SCALE:
DATE: 11/27/2013
DRAFTED BY:

SITE PHOTOS

CONWAY RESIDENCE
5 East Monroe Street
Conway, Kansas, 67042
1110 Division Street, Wichita, Kansas, 67203
REVISIONS
WORKS

Square 134 Architects



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24

A9.01

DRWING NO. 13025

DATE: 11/11/2013

DRAWN BY:

SCALE:


PROJECT NO.

13025



CUSTOM ST:

DRWING TITLE:


PROPOSED
SIDE DOOR
PRECEDENTS AND
CONWAY RESIDENCE

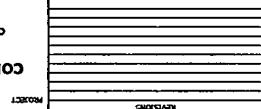

CONWAY RESIDENCE
PROJECT NO.
13025
DRAWING TITLE
SQUARES
134
Architects
G. Gurn Miller Associates, Inc., 2000
1100 South Main, Salt Lake City, UT 84115
P: (800) 325-1222 F: (800) 325-1223

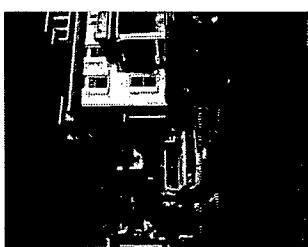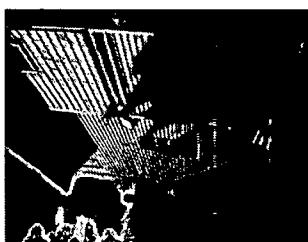


SIDE YARD/DRIVeway DOOR PRECEDENTS LOCATED IN THE VILLAGE OF CHEVY CHASE

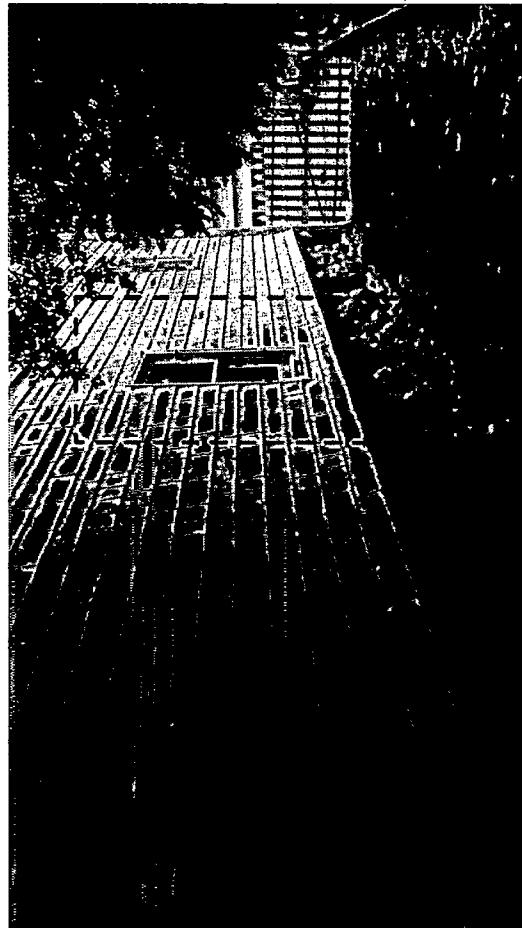

PROPOSED LOCATION OF NEW
SIDE/YARD/DRIVeway DOOR. VIEW
TO COINCIDE WITH EXISTING WINDOW

25

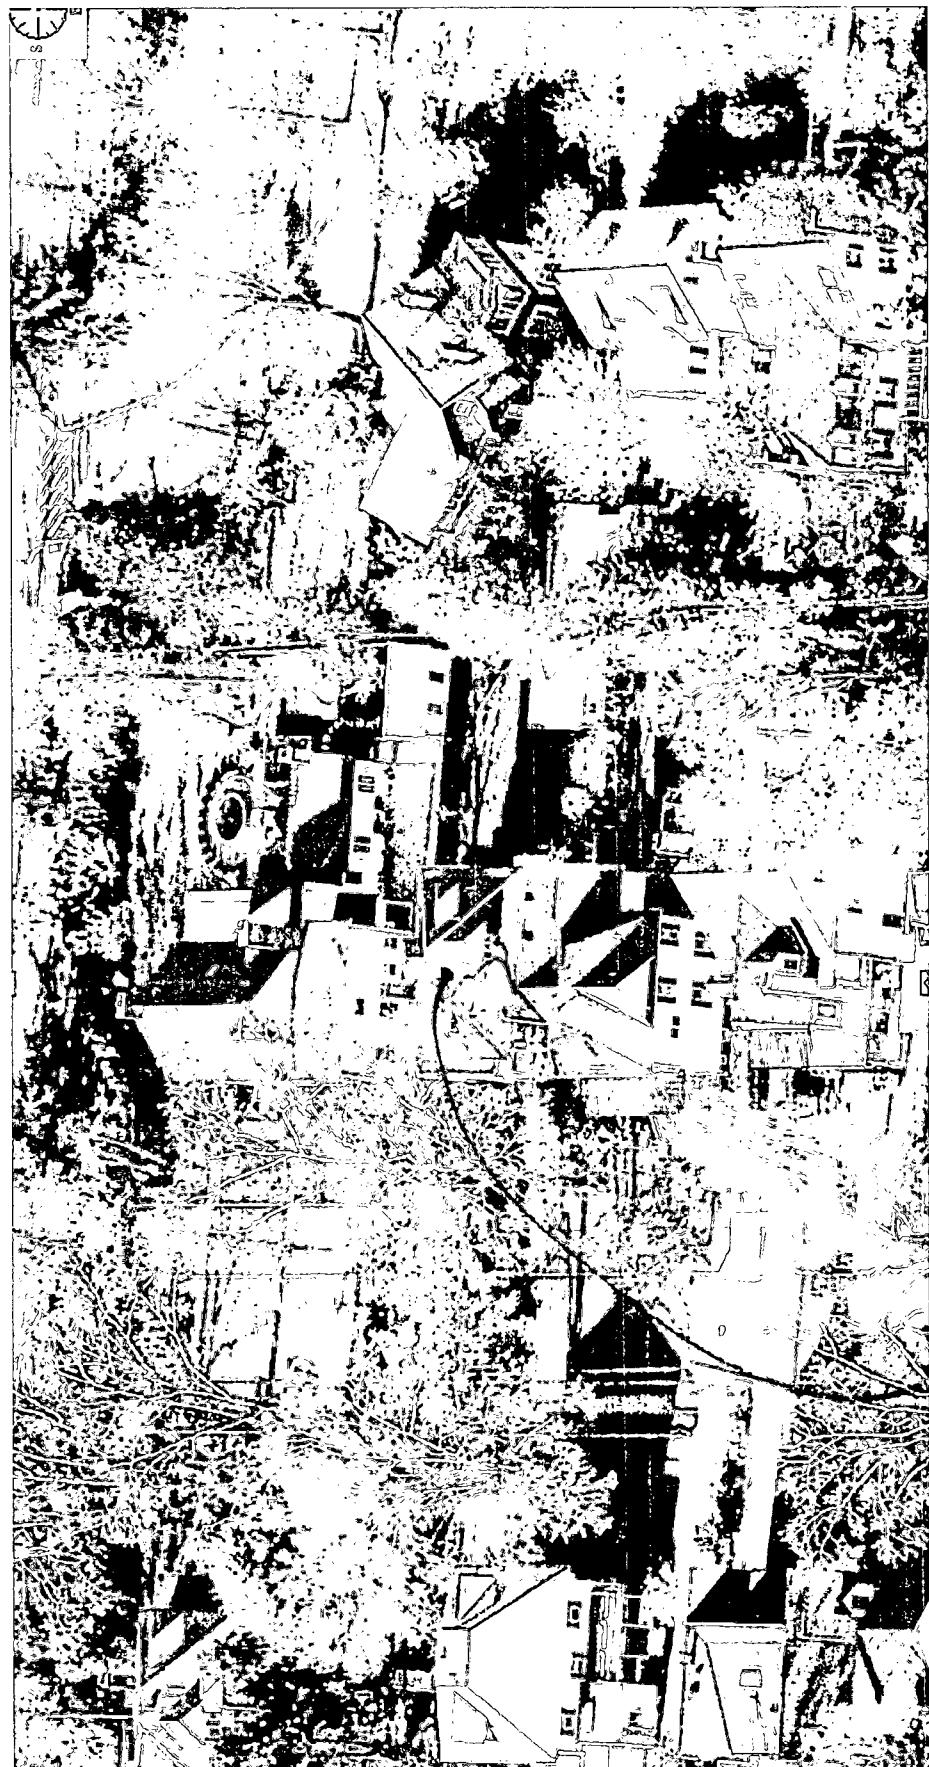


S.E. MELROSE

26

5 E. MELROSE



(23)

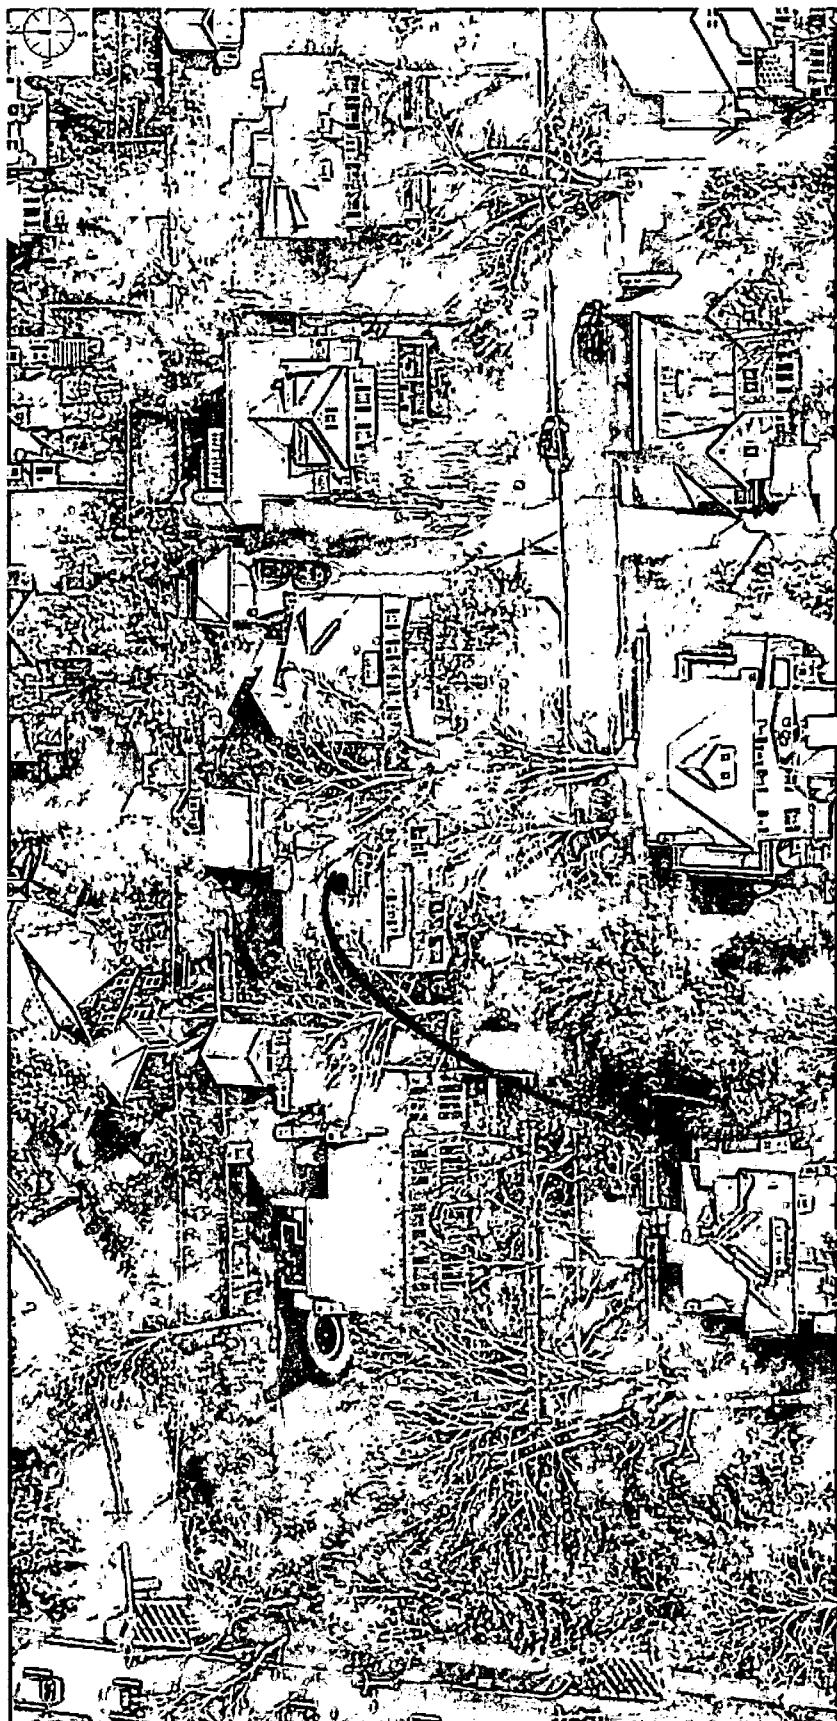

5 E. MELROSE

Silver, Joshua

From: CCV Permitting <ccvpermitting@montgomerycountymd.gov>
Sent: Wednesday, November 20, 2013 4:03 PM
To: Patrick@Lock7Development.com
Cc: Silver, Joshua
Subject: status of 5 East Melrose

Mr. Conway:

I wanted to update you that I met this afternoon with the Village Manager to review your variance request for an encroachment into the east side yard setback. She confirmed my earlier assessment that the request is very much in keeping with previously granted Board decisions. We do not anticipate any major concerns in the hearing of the case scheduled for December 9. Please contact me if you need anything else.

Ellen Sands
Permitting and Code Enforcement Coordinator
Chevy Chase Village
Tele. 301-654-7300
FAX 301-907-9721

ccvpermitting@montgomerycountymd.gov
www.chevychasevillagemd.gov

ALTERATION, REPAIR, AND ADDITION TO AN EXISTING SINGLE FAMILY RESIDENCE



CONWAY RESIDENCE

5 EAST MELROSE STREET
CHEVY CHASE, MD. 20815

NEED ② SECTIONS:
 ① 12" Wall | Roof "HPC APPROVED"
 ② 6" " / " APPLICANT REQUEST

PURPOSE: to show what applicant
would lose in width and height

Was: 12" inset → continuous roof
Now: 6" inset → 6" roof inset

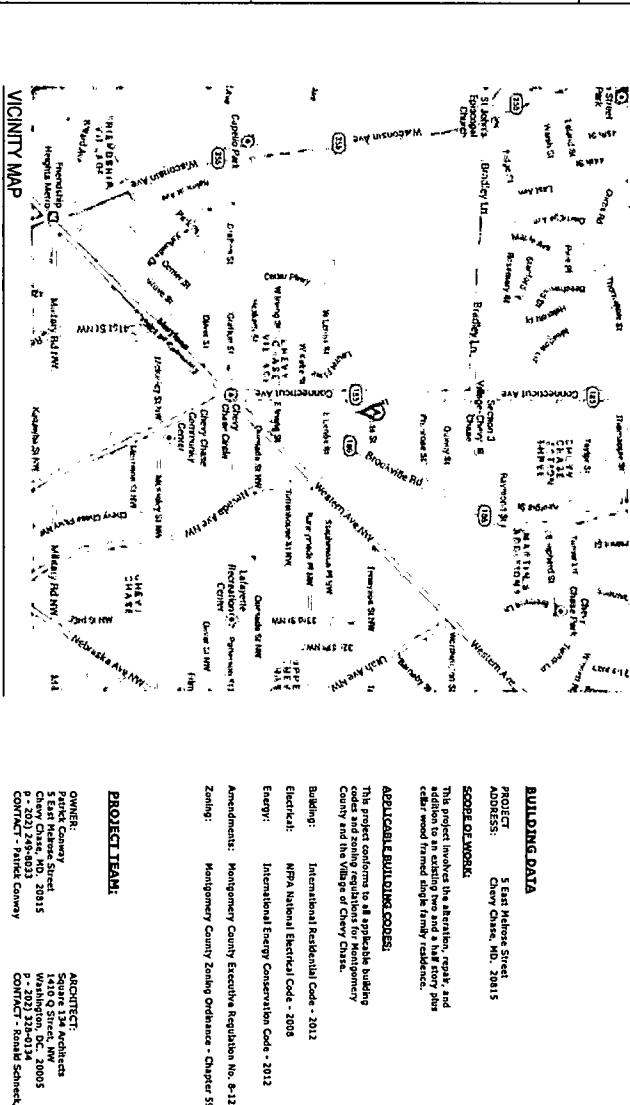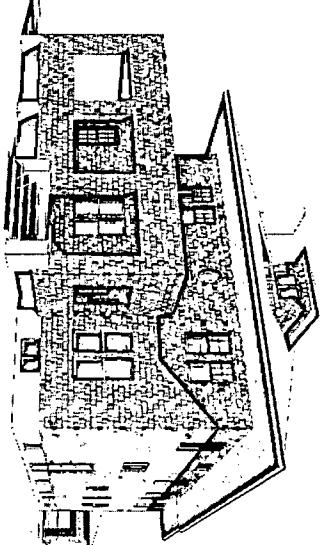

PROJECT TEAM:

OWNER: Park City
5 East Melrose Street
Chevy Chase, MD. 20815
P: 202-242-0134
C: 407-249-8823
CONTRACTOR - Park City

ARCHITECT: SMC Architects
Suite 134, Architects
1410 G Street, NW
Washington, DC. 20005
P: 202-226-0134
C: 407-249-8823
CONTRACTOR - Park City

STRUCTURAL ENGINEER: FMC & Associates, LLC
515 M St. SE, Suite 105
Washington, DC. 20003
P: 202-852-0111
C: 407-249-8823
CONTRACTOR - Park City

MEP ENGINEER: W.W.K. Construction, Inc.
13104 Wilson Oaks Drive
Silver Spring, MD. 20906
P: 301-961-0000
C: 301-961-0000

DRAWING TITLE: CONWAY RESIDENCE
COVER SHEET

PROJECT NO.: 13025
OWNER PT:

KIND: 3/8" x 1/2" -
DATE: 12/04/2013
DRAWN BY:
DESIGNED BY:

A0.00

12/18

5 4

3

2


1

1

D

Square | 134 | Architects
1410 G Street NW Washington, DC 20009
P (202) 338 0134 F (202) 315 3615

1. Property shown as boundary shown on Survey
 2. All dimensions and areas are approximate.
 3. A survey map or copy may be requested.
 4. The dimensions and areas shown are based on the recorded Survey.
 5. The dimensions and areas shown are based on the recorded Survey.

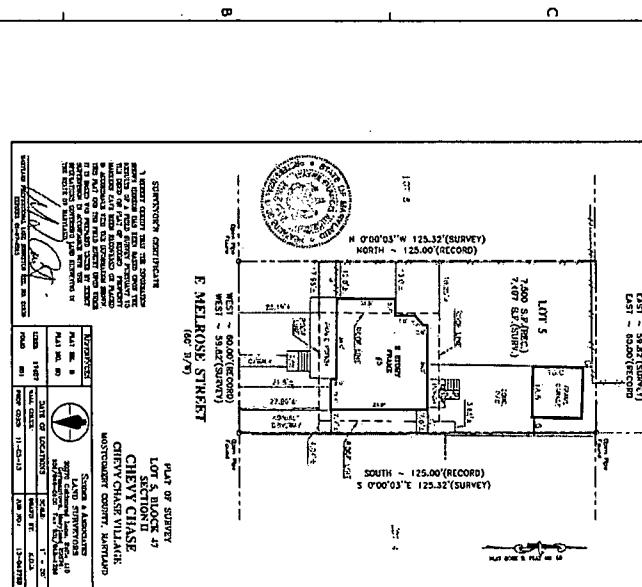GENERAL STATE

A

B


C

A

B

C


- 1. SITE PLAN - PROPOSED**
 10' = 1'-0"
- 2. SITE PLAN - EXISTING**
 10' = 1'-0"

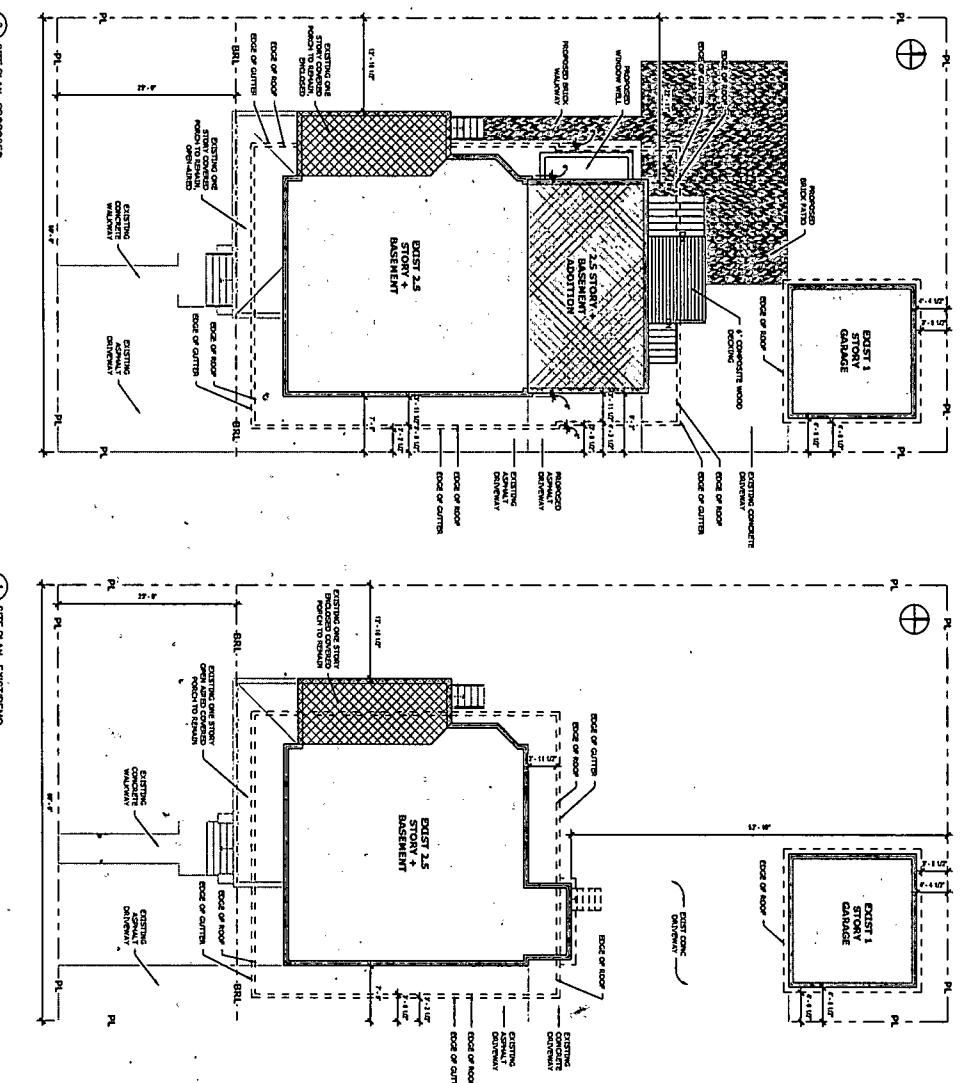



| | |
|--------------|------------|
| PRODUCT NO. | A3025 |
| Quat. #: | |
| SCALE: | |
| As Indicated | |
| DATE: | 11/04/2013 |
| DRAW. NO.: | |

A0.06**DRAWING TITLE**
SITE PLAN**REVISIONS**

CONWAY RESIDENCE
5 East Melrose Street
Chevy Chase, MD, 20815

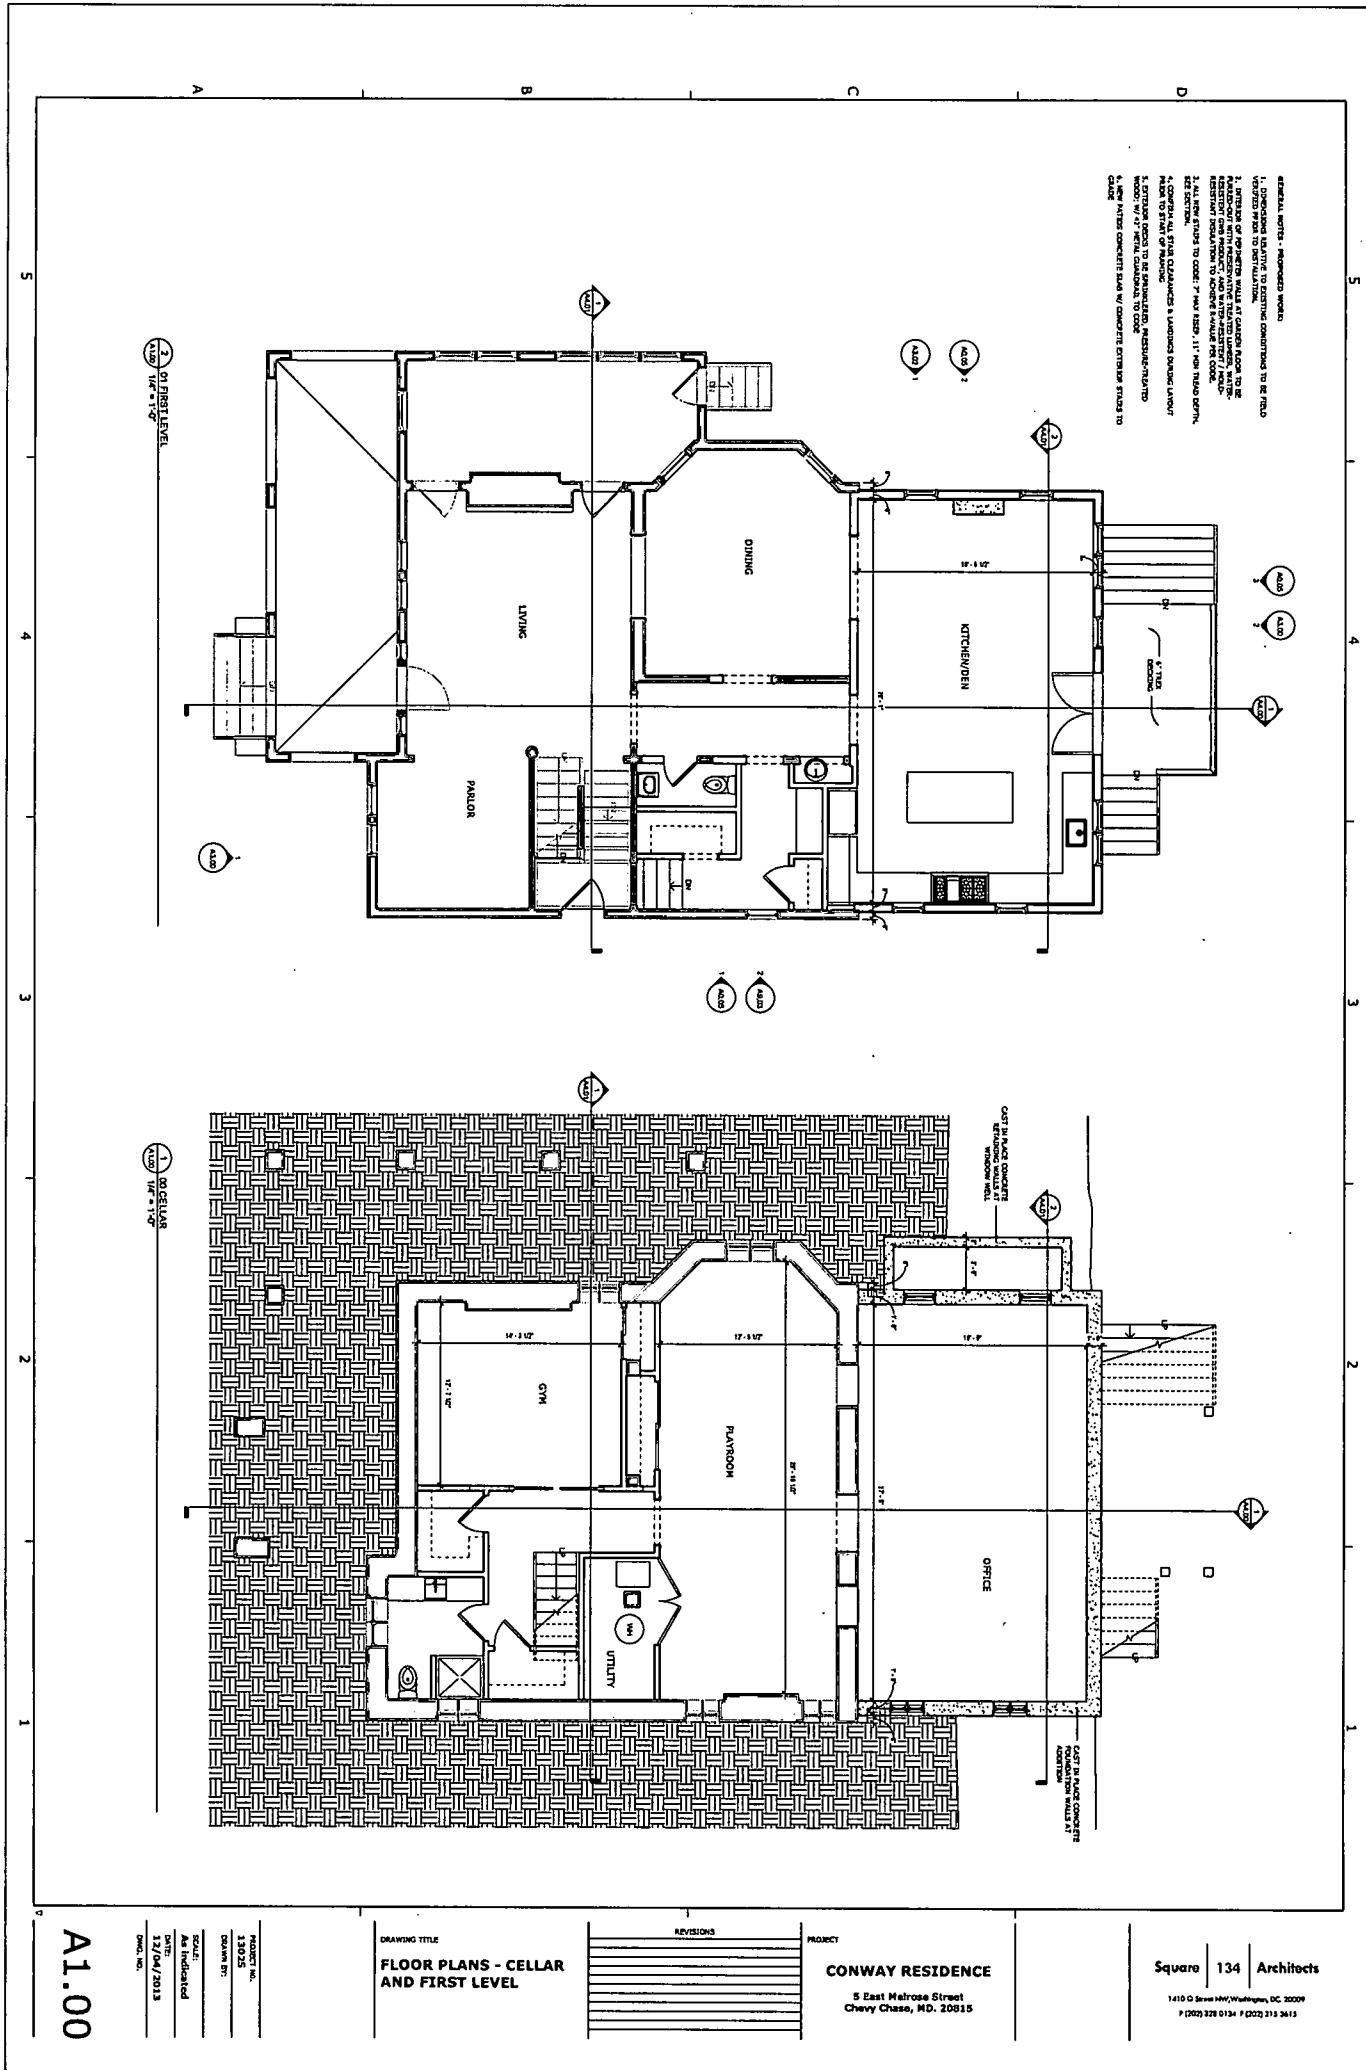

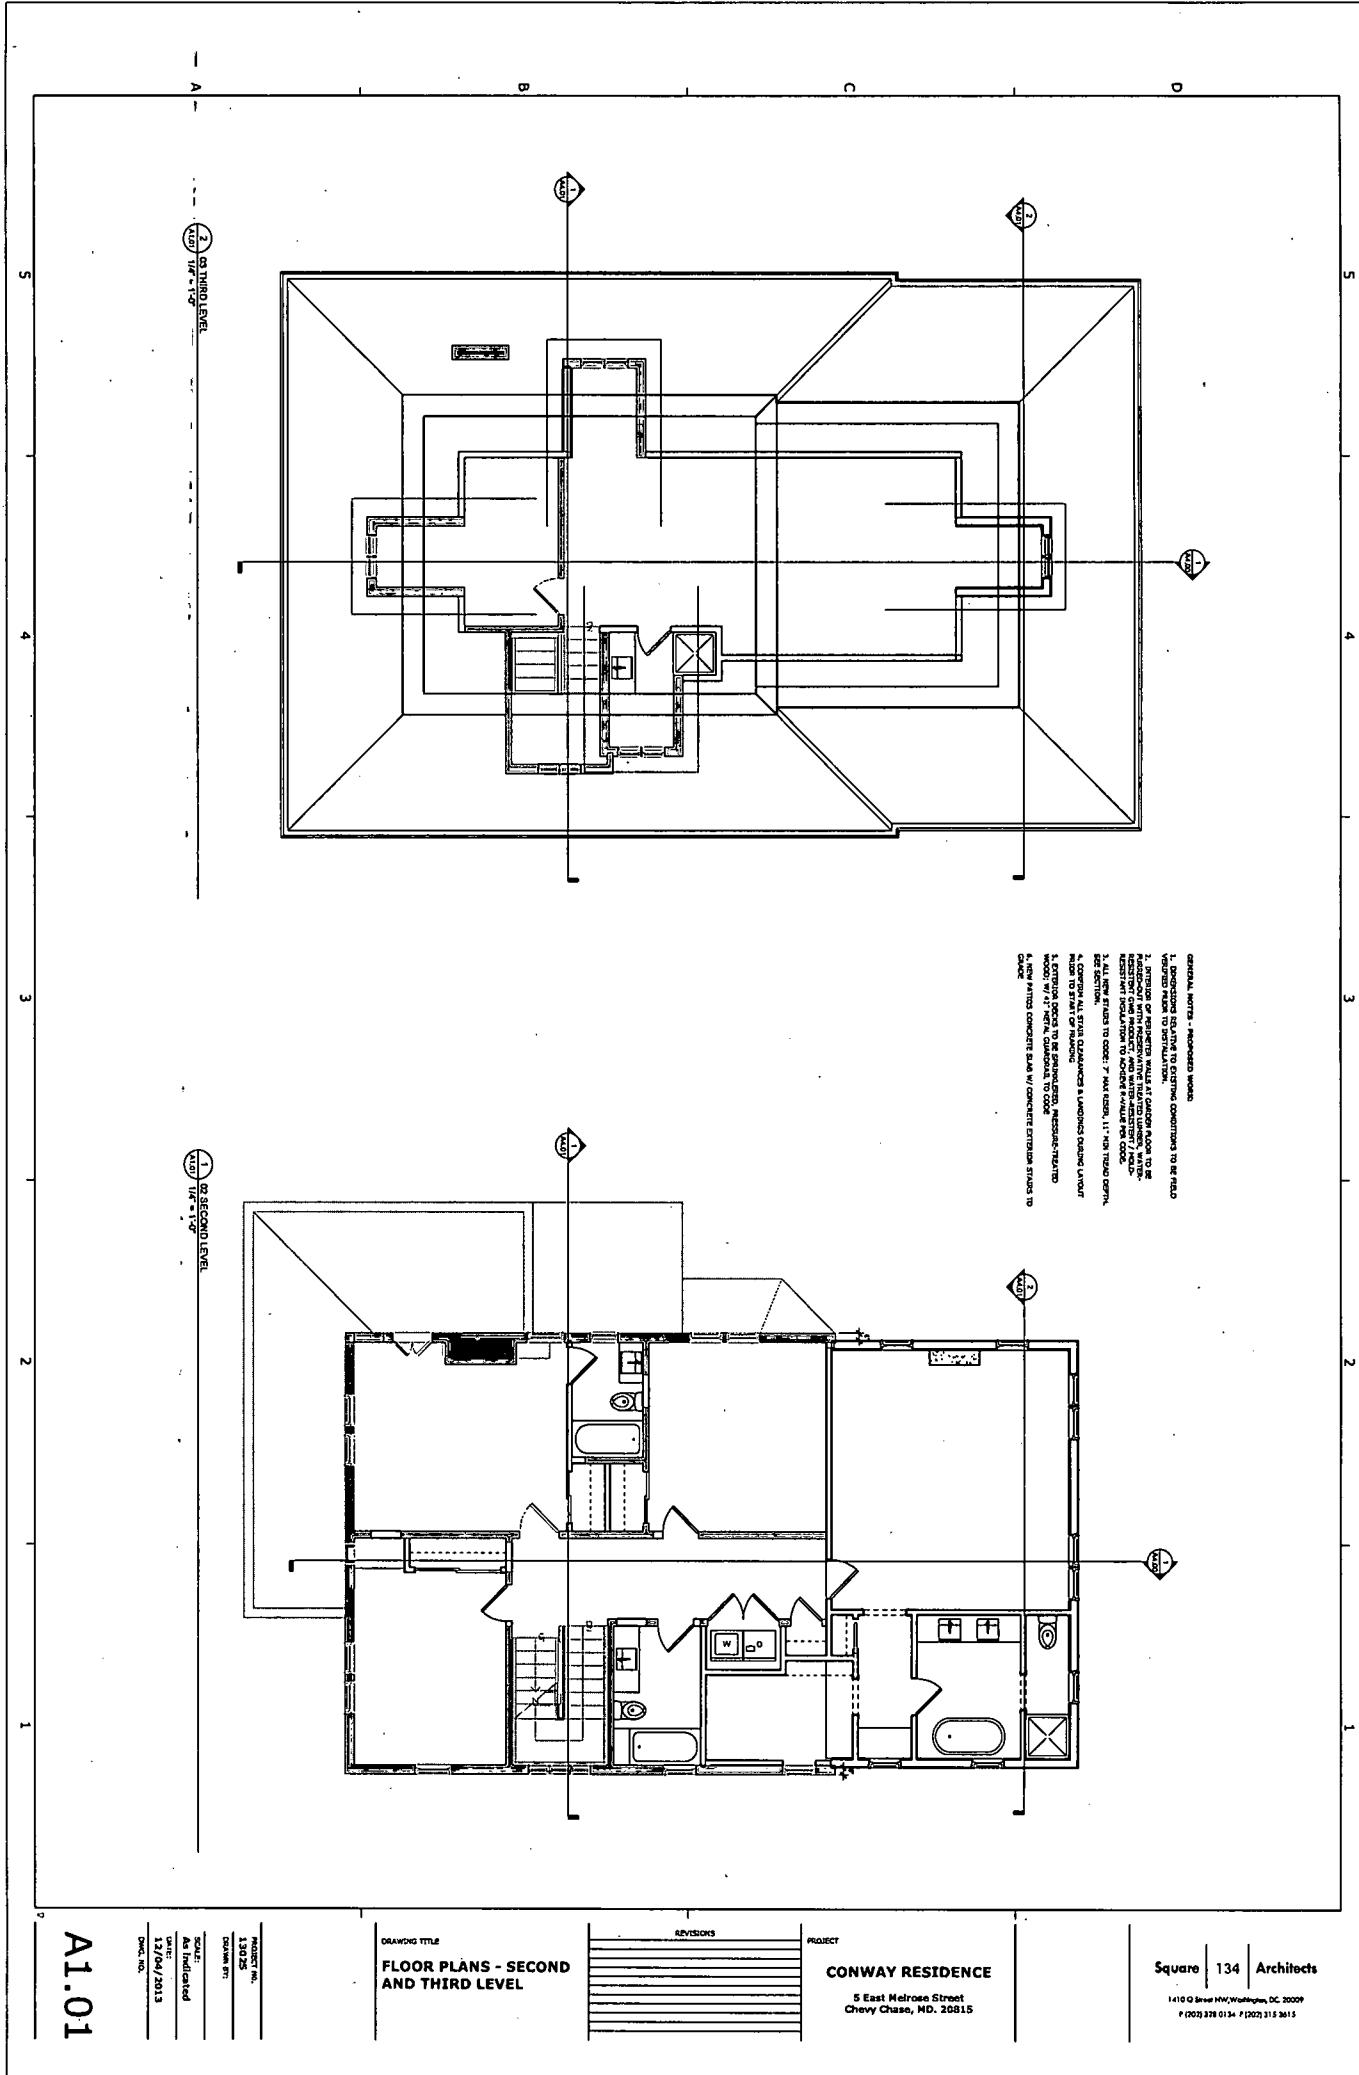


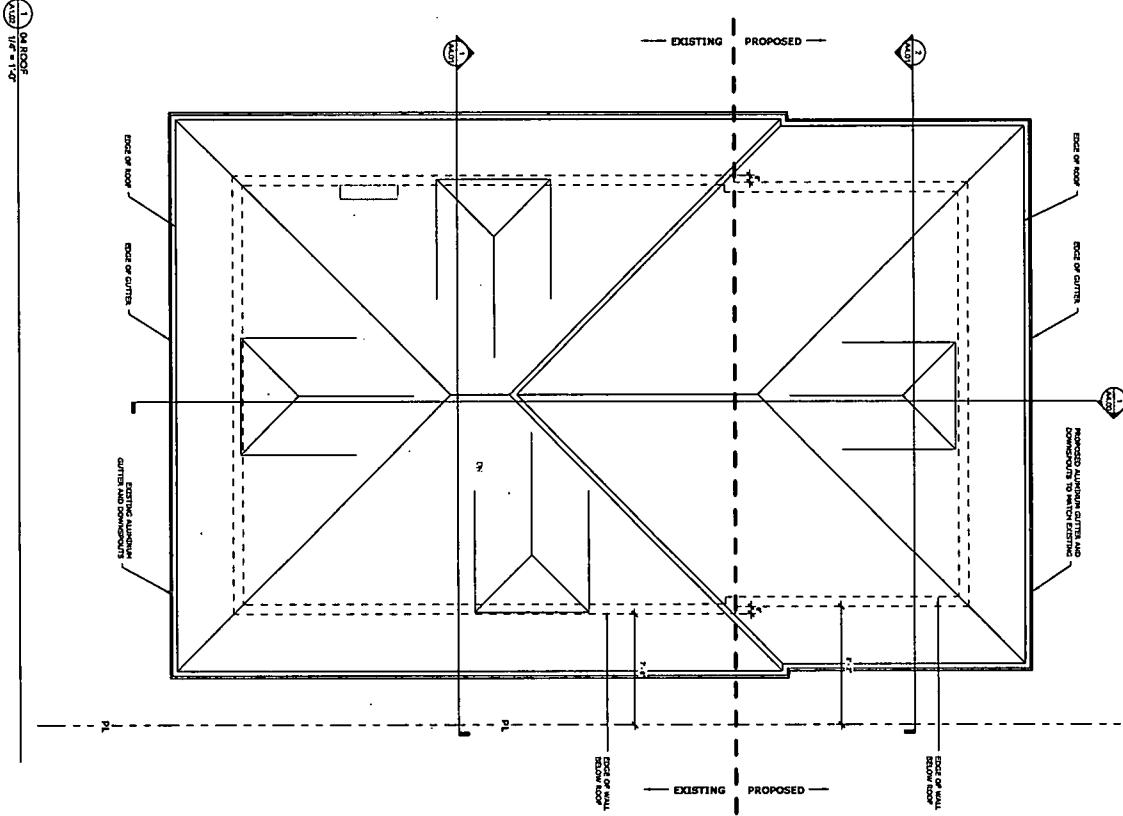

A1.02


| | |
|-------------|--------------|
| PROJECT NO. | 130325 |
| SCALE | 1/8" = 1'-0" |
| DATE | 12/04/2013 |
| DRW. NO. | |

DRAWING TITLE
FLOOR PLANS - ROOF

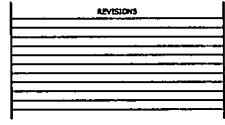

PROJECT
CONWAY RESIDENCE
8 East Melrose Street
Chevy Chase, MD. 20815

Square | 134 | Architects
1410 O Street NW, Washington, DC 20009
P (202) 328 0134 F (202) 313 3615

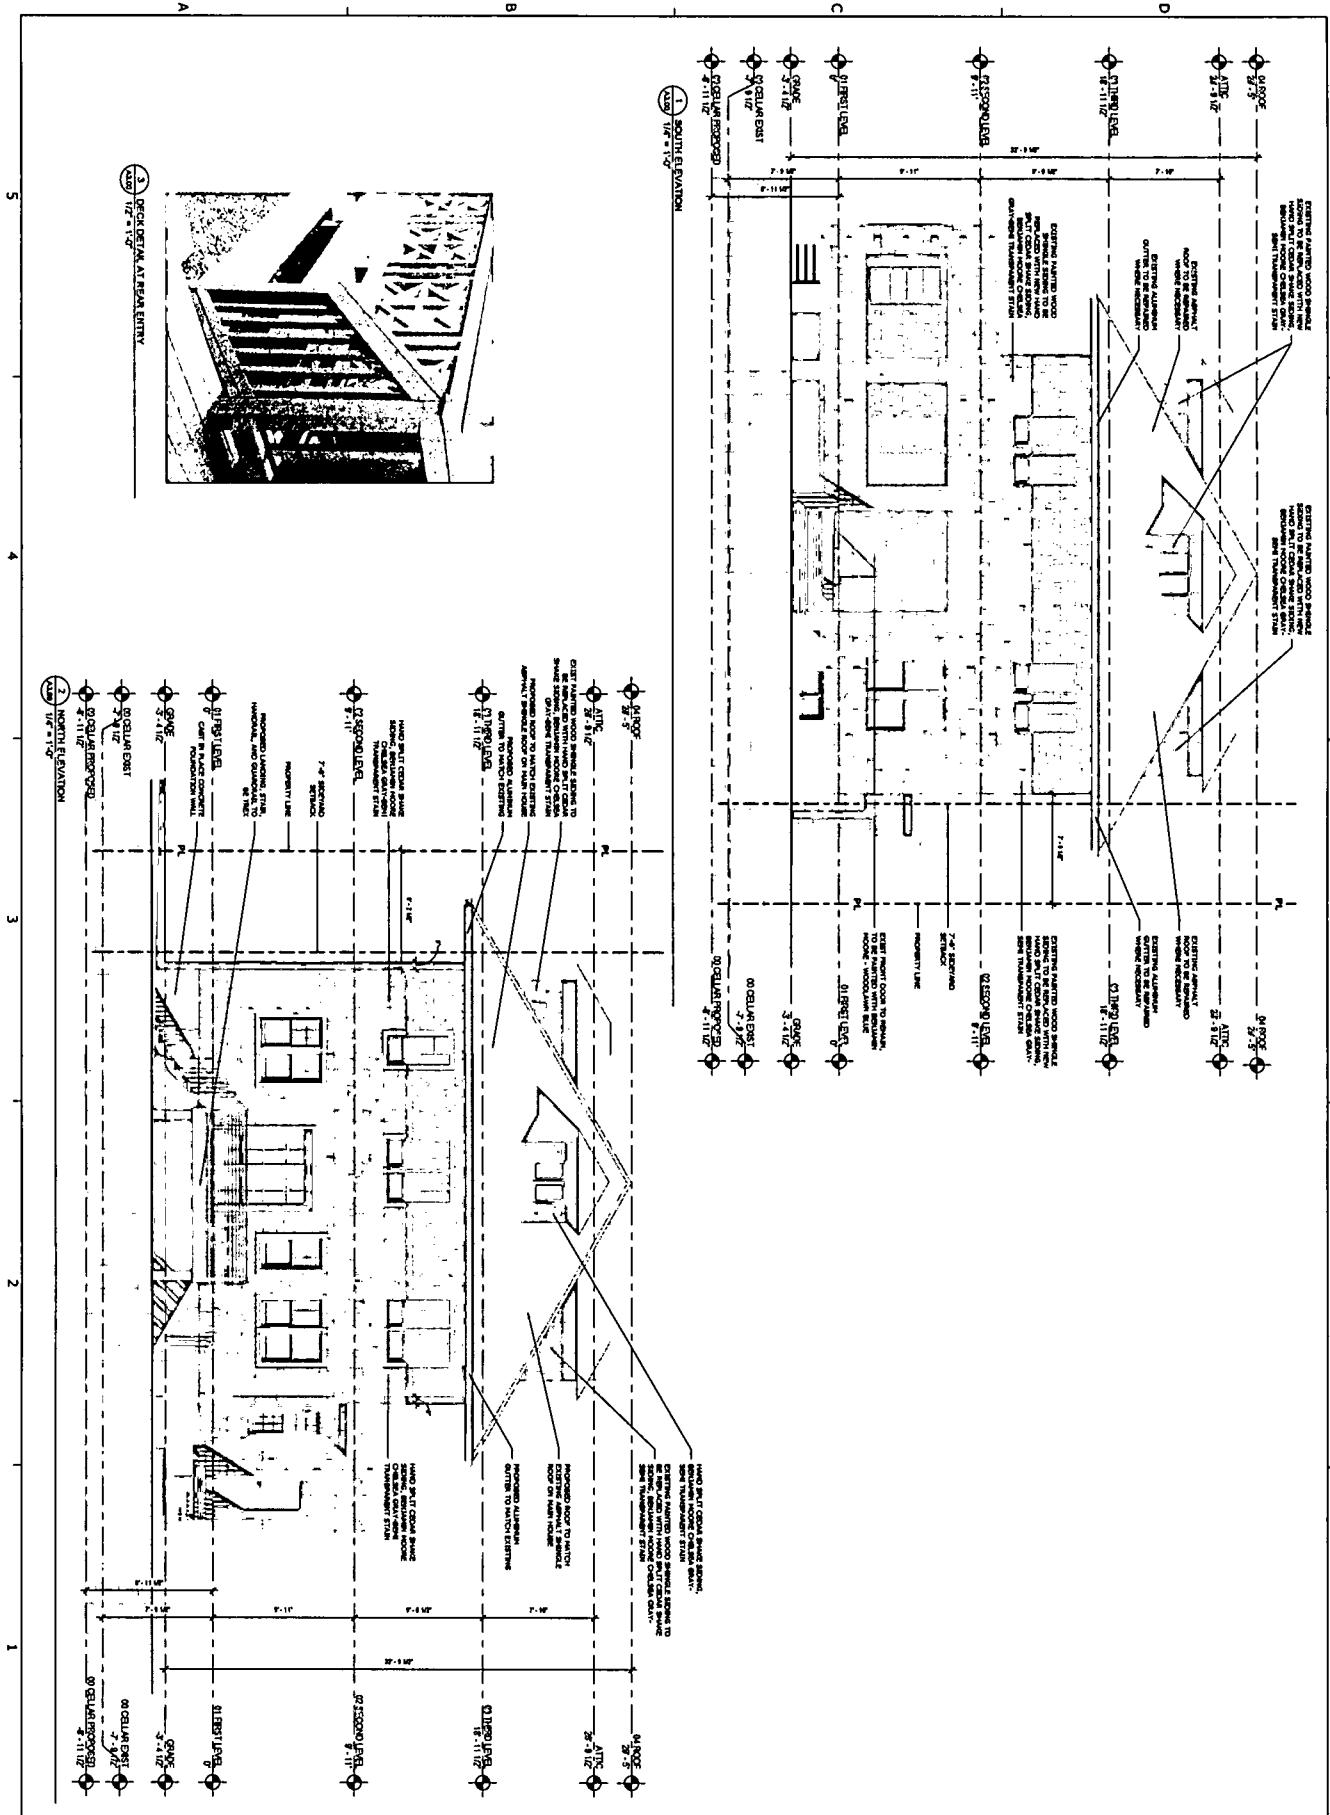


A3.00

| | |
|-------------|--------------|
| DATE | 12/04/2013 |
| PROJECT NO. | 134 |
| DRAWN BY | As Indicated |
| REVISIONS | |


DRAWING TITLE
NORTH AND SOUTH
ELEVATIONS

PROJECT
CONWAY RESIDENCE
5 East Neilrose Street
Chevy Chase, MD. 20815

Square | 134 | Architects
1419 O Street NW, Washington, DC 20009
P (202) 238-0134 F (202) 313-3615

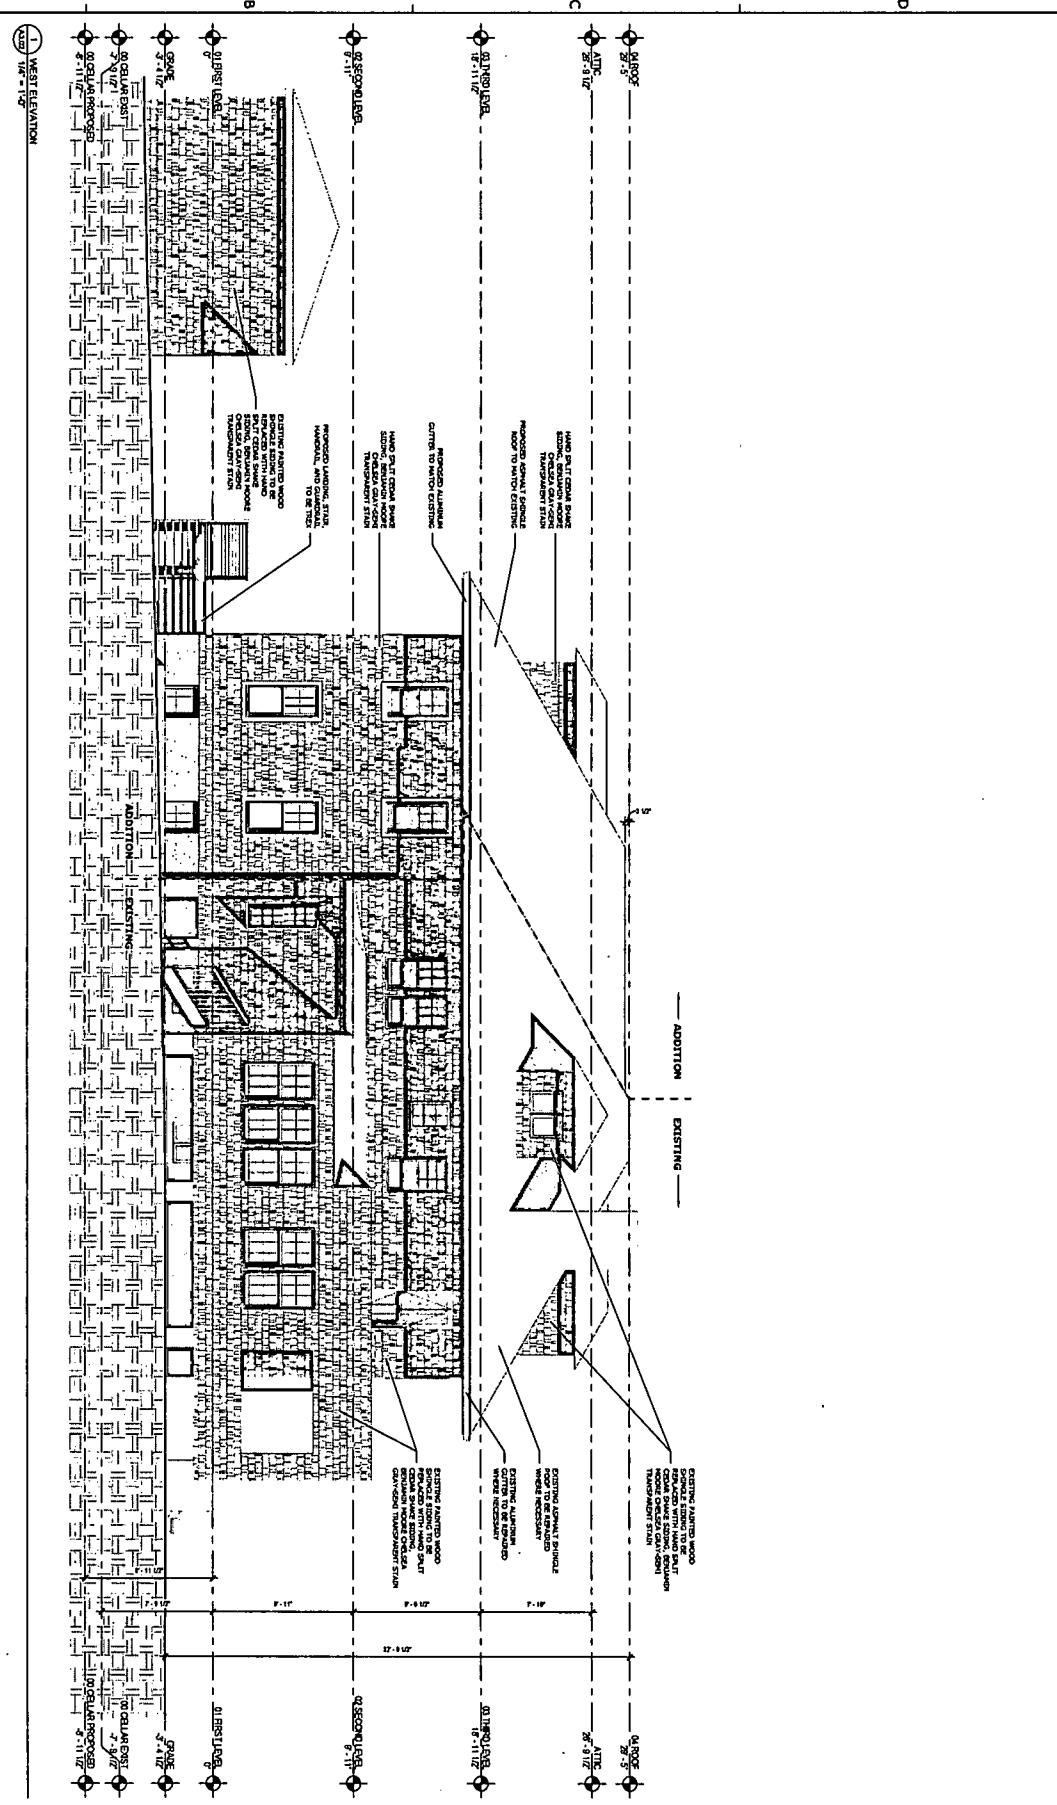5
4
3
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15
4
3
2
1**A3.02**

5
4
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2
1

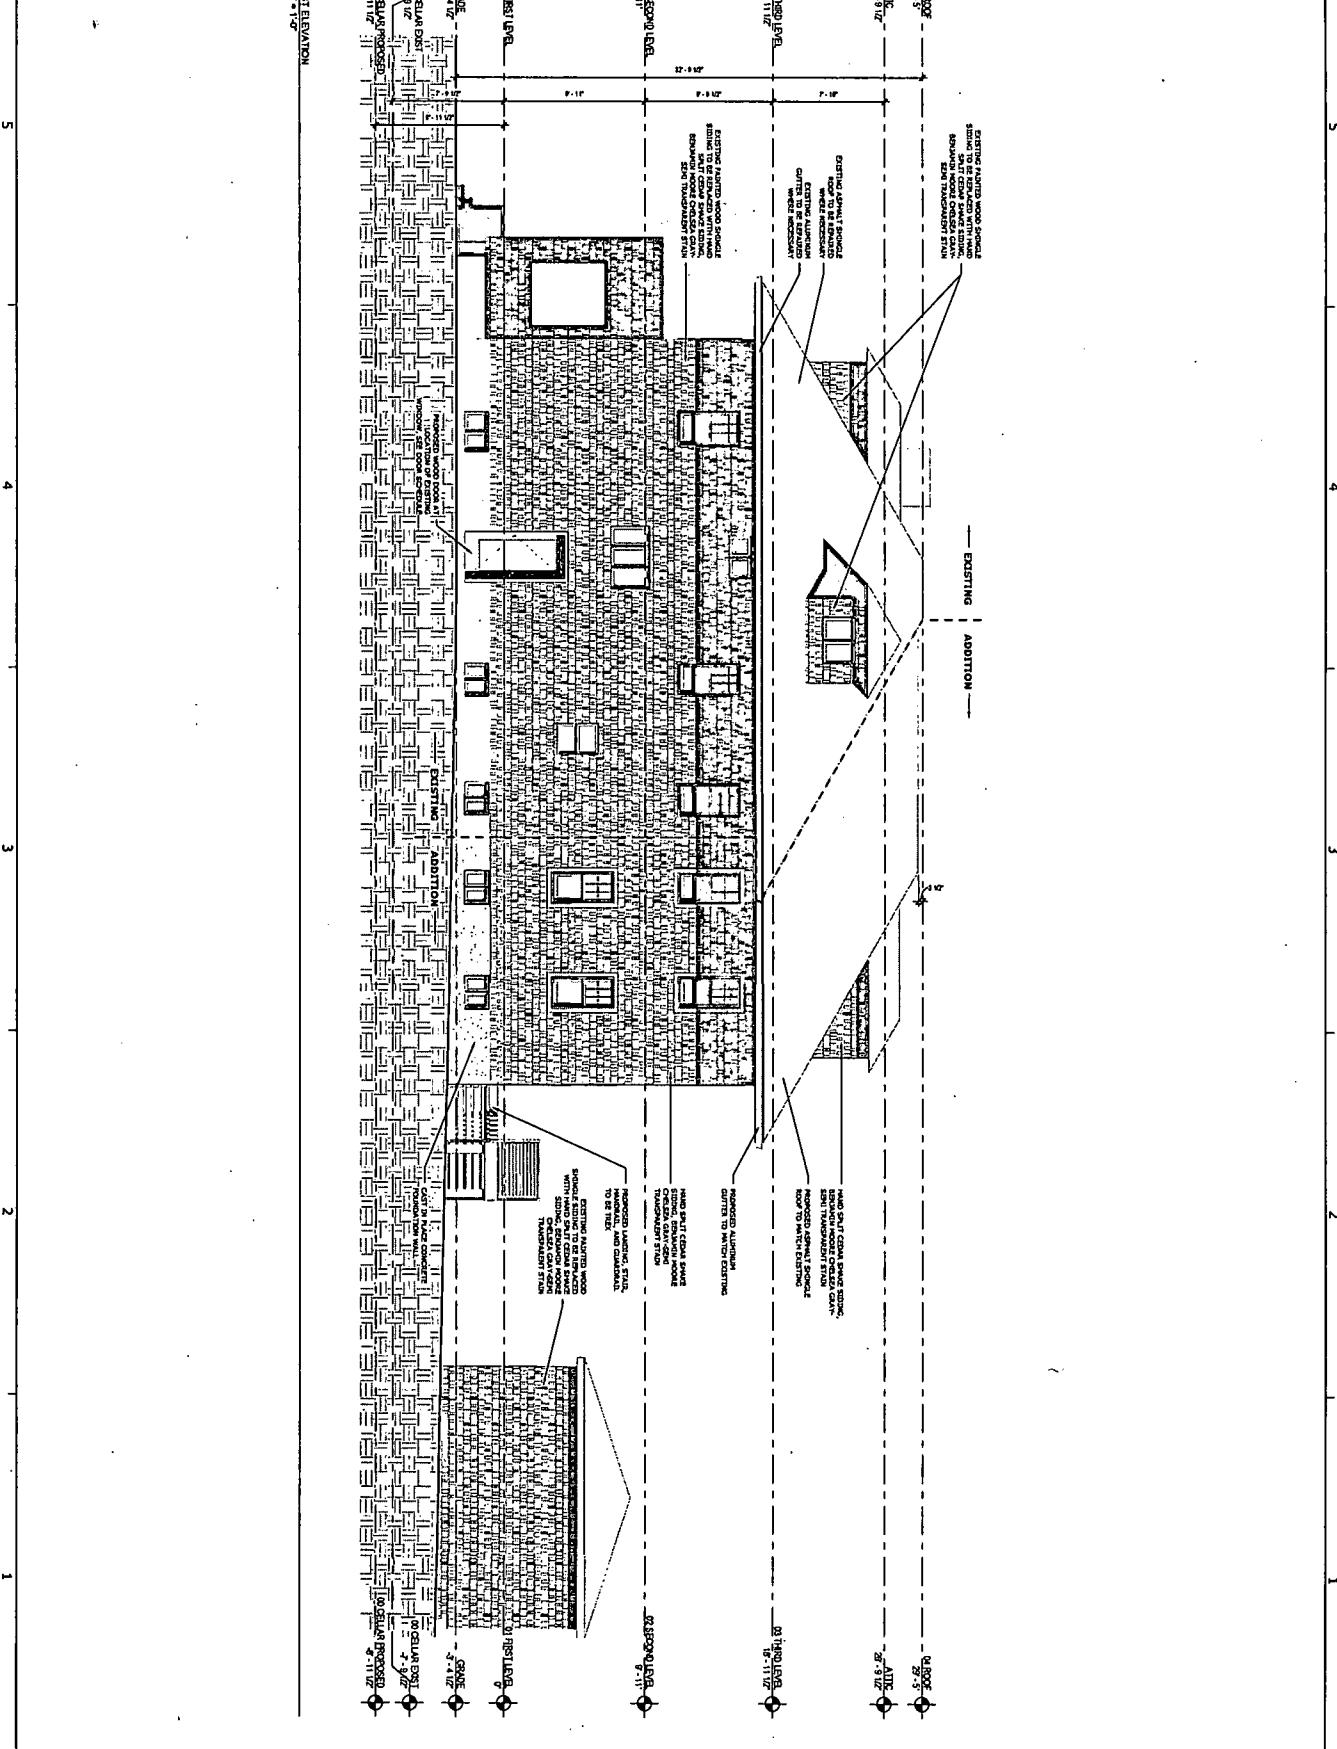

A3.01

| | |
|---------------|---|
| PROJECT | CONWAY RESIDENCE |
| LOCATION | 5 East Melrose Street Chevy Chase, MD, 20815 |
| DRAWING TITLE | EAST ELEVATION |
| DATE | 3/17/13 - 1-40' |
| REVISONS | |
| DOC. NO. | 12/04/2013 |

Square 134 Architects
1410 O Street NW/Washington, DC 20009
(202) 328-0134 F (202) 315-3615

Manarolla, Kevin

From: Bourke, Tom(Winchester Homes, Inc.)(Tom) <tom.bourke@whihomes.com>
Sent: Wednesday, December 04, 2013 1:58 PM
To: Manarolla, Kevin; Whipple, Scott; Silver, Joshua
Cc: Bourke, Tom(Winchester Homes, Inc.)(Tom); CCV Permitting Coordinator (Ellen Sands); ChCh Village file (CCV@montgomerycountymd.gov); Feldman, Gail; HBSacks@comcast.net; Mark Nadel; Myra Kovey; P. Wellington; Stephens, Betsy
Subject: CCV LAP comments for HPC - December 4, 2013 - 24 W Kirke; 5 East Melrose

The following are the comments of the Chevy Chase village Local Advisory Panel on items before the HPC on 12/4/13:

24 West Kirke

Contributing Resource

Hardscape alterations – driveway, lead walk, concrete stoop replacement with flagstone, patio etc

Staff recommended Expedited Approval, and the LAP concurs with Staff recommendation.

5 East Melrose

Contributing Resource

Construction of rear addition and other alterations

Staff recommends approval with conditions – CC Village side yard variance will be needed on east side eaves and gutters.

The LAP supports Staff recommendation and appreciates Staff recognition of Village Board review requirements.

Submitted for the LAP by Tom Bourke, Chair

From: Manarolla, Kevin [<mailto:Kevin.Manarolla@montgomeryplanning.org>]

Sent: Wednesday, November 27, 2013 2:42 PM

To: Betsy Stephens; Bourke, Tom(Winchester Homes, Inc.)(Tom); ChCh Village; Gail Feldman; HBSacks; Mark Nadel; Myra Kovey; P. Wellington

Subject: HPC staff reports for December 4, 2013

Chevy Chase:

Here are the staff reports for the HPC meeting scheduled on December 4, 2013.

Kevin Manarolla, Senior Administrative Assistant | Historic Preservation Section

Functional Planning and Policy Division | Montgomery County Planning Department | M-NCPPC

Office: 8787 Georgia Avenue STE 204 | Silver Spring | Mail: 8787 Georgia Avenue | Silver Spring MD 20910

301-563-3400 phone | 301-563-3412 fax | [Email Me Here](#) | [Our Web Site](#) | M-NCPPC

Silver, Joshua

From: Patrick Conway <patrick@lock7development.com>
Sent: Thursday, December 19, 2013 6:32 PM
To: Silver, Joshua
Cc: 'Kevin Donohoe'; 'Lindsay Conway'
Subject: RE: Melrose
Attachments: 13025_Conway-Residence_Building-Section-Diagrams_2013-12-19.pdf

Importance: High

Josh,

Please see the attached diagram of both 6" and 12" insets. The existing 3rd floor ceiling is right at code in height: 7'6". At your original suggestion in this process, we opted not to inset the sides of the building 4" and instead do 12" in a compromise of sorts to be able to extend the existing roofline and therefore maintain the 3rd floor ceiling height of 7'6". The board voted against that. So we went back to you with 6" insets which would lower the roofline and ceiling 3.5" (OPTION 1 in diagram). A 7'2.5" ceiling height is no longer code but at least it's still usable space. Option 2 in the lower diagram with 12" insets has been included at your request. Option 2 lowers the roofline/ceiling 7", lowering the ceiling to 6'11". This space is much less usable especially when I have family members who are over 6'7" in height.

As you know CCV signed off on the 6" insets, which was a very big hurdle to get through. We only designed the 12" insets because we thought we would be able to maintain the existing roofline. I know of many other historic and CCV homes that do not inset 12". I have altered my plans numerous times to everyone of your requests and I'm asking that you to accept the 6" insets.

I need your signature before you leave for almost 2 weeks as I'd like to submit for permits on Monday morning.

Can you sign off on this?

Thank you
Patrick

-----Original Message-----

From: Silver, Joshua [mailto:joshua.silver@montgomeryplanning.org]
Sent: Thursday, December 19, 2013 10:33 AM
To: Patrick@Lock7Development.com
Subject: RE: Melrose

I did. Please call me at your convenience to discuss the HPC's consideration of your revision to the addition's roof plan. We can discuss the shingles at that time also. My direct dial is: 301.563.3403.

Thanks,
Josh

-----Original Message-----

From: Patrick Conway [<mailto:patrick@lock7development.com>]
Sent: Thursday, December 19, 2013 10:30 AM
To: Silver, Joshua
Cc: 'Kevin Donohoe'; 'Lindsay Conway'; Patrick@Lock7Development.com
Subject: RE: Melrose

Hi Josh,

Did you receive the shingles I dropped off at your office?

Thanks
Patrick

-----Original Message-----

From: Patrick Conway [<mailto:patrick@lock7development.com>]
Sent: Tuesday, December 17, 2013 4:34 PM
To: 'Silver, Joshua'
Cc: Patrick@Lock7Development.com; 'Kevin Donohoe'; 'Lindsay Conway'
Subject: RE: Melrose

Josh

Will I need to bring you the shingles before you issue approval or can I bring them to you when we are closer to switching the shingles out? I'm asking because I'd like to get started with permits asap but obviously need your signatures first. Does this makes sense?

Thank you
Patrick

-----Original Message-----

From: Silver, Joshua [<mailto:joshua.silver@montgomeryplanning.org>]
Sent: Monday, December 16, 2013 12:43 PM
To: Patrick@lock7development.com
Subject: FW: Melrose

Please see below about next steps. In addition to the staff item I will present to the HPC on Wednesday for the roof, you still need to satisfy the other condition of approval added by the HPC for the siding. You need to submit to me a siding sample of the existing (on the historic house now) and the siding you will be using to comply with the HPC's condition of approval .

Thanks,
Josh

-----Original Message-----

From: Silver, Joshua
Sent: Tuesday, December 03, 2013 2:51 PM
To: 'Patrick Conway'
Cc: Kevin Donohoe (KDonohoe@square134.com)
Subject: RE: Melrose

Thanks for letting me know. See you tomorrow evening. Again, you will likely hear trim and siding added as conditions of approval. I'm optimistic your case will be expedited at the beginning of the hearing and you will be free to go home.

As for the next steps, you will work with me on getting the replacement siding detail right, obtaining your variance, then filing three sets of your building permit plans with me for my final review and stamping. After this occurs you will then proceed with two copies of the HPC stamped plans to the Department of Permitting Services in Rockville to begin the building permit process. Again, you must file the plans with me first before proceeding to the building permit stage. The plans must be the final version and include all pertinent details, including those the HPC does not review such as plumbing and electrical. The reason for this is DPS requires the HPC stamp each page of the final building permit plans.

Josh

-----Original Message-----

From: Patrick Conway [mailto:patrick@lock7development.com]

Sent: Tuesday, December 03, 2013 2:43 PM

To: Silver, Joshua

Subject: Melrose

Josh - we are on board to replace shingle in-kind. Sorry for the late response.

Patrick

Sent from my iPhone

<Anderson HAWP Reduced.pdf>
<HAWP Description Anderson 2013.pdf>

<IMG_4419.jpeg>
<IMG_4420.jpeg>
<photo.jpeg>

A4.00

1

2





3

4

5

2 BUILDING SECTION A-4.00

 2 BUILDING SECTION A-4.00

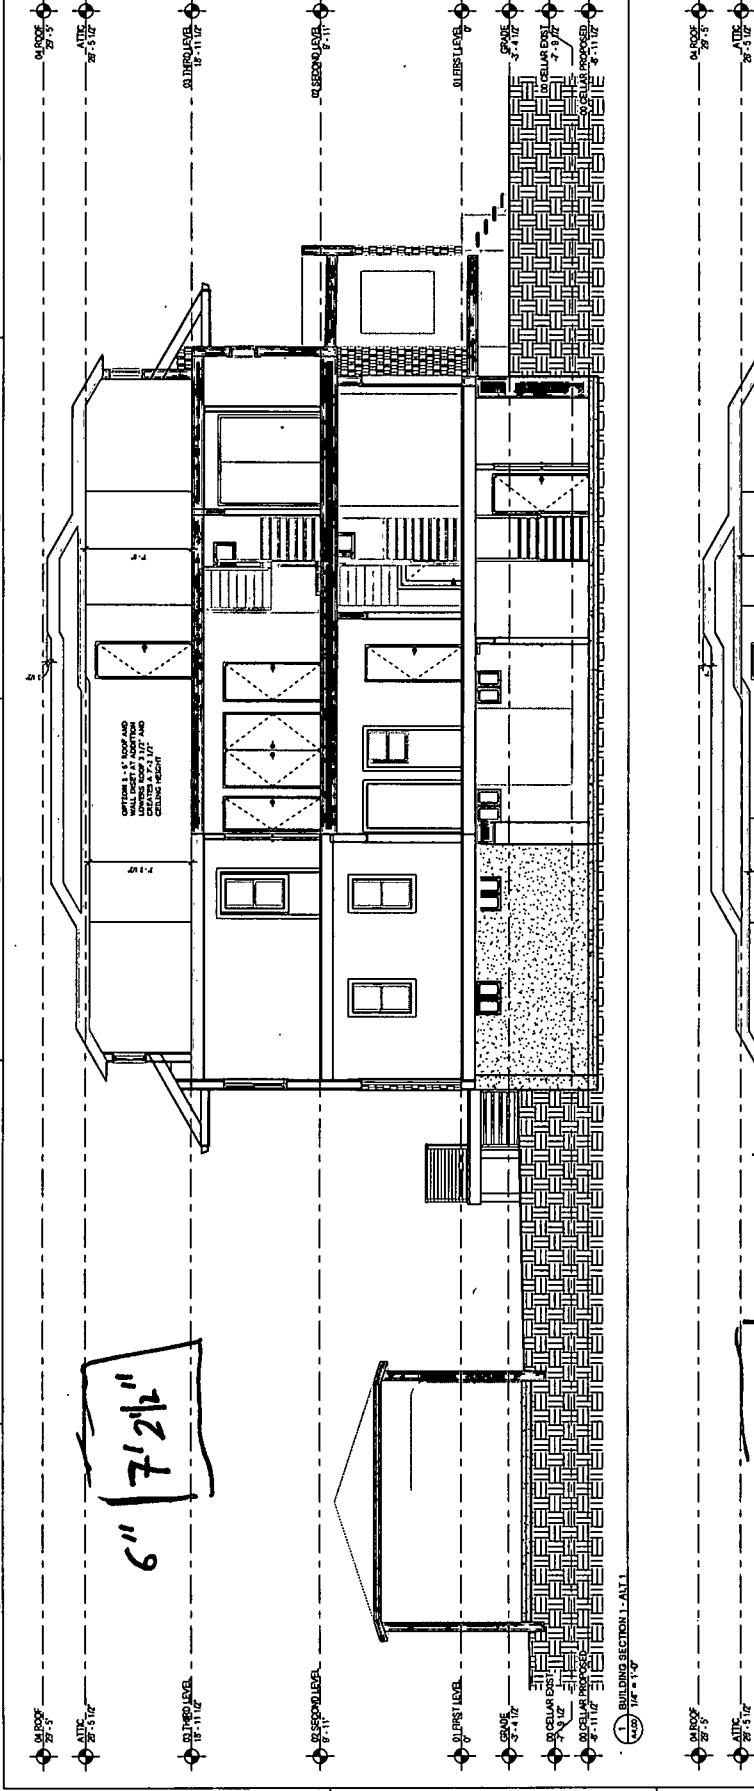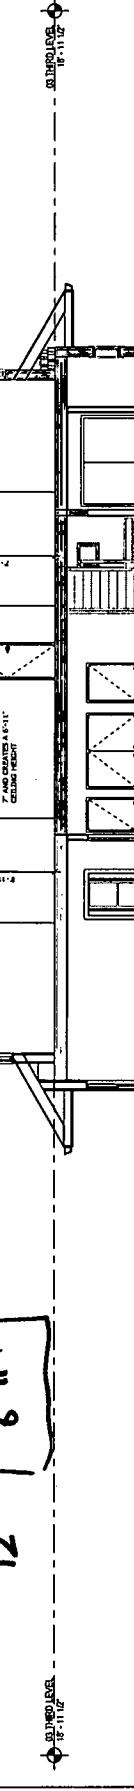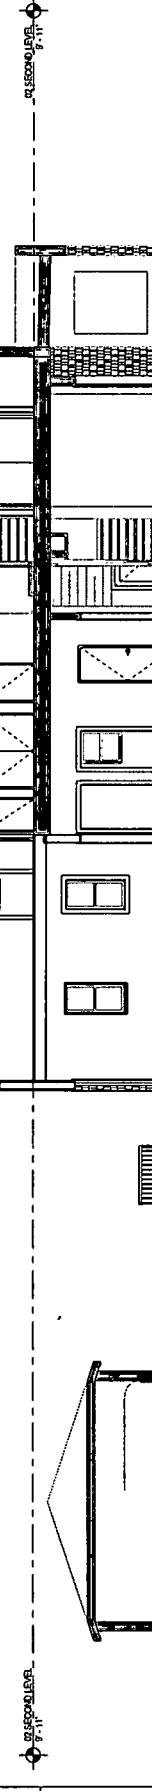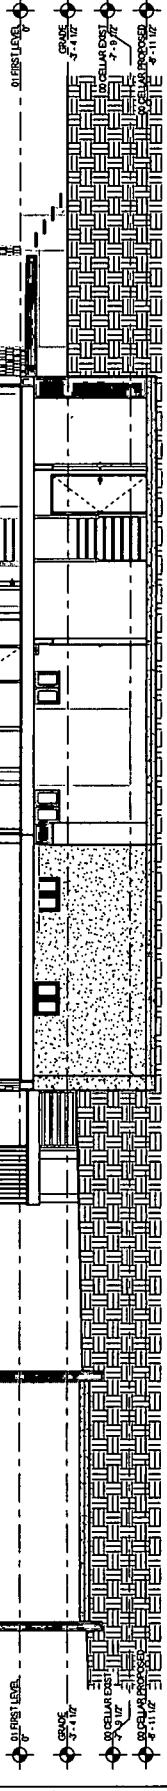

CONWAY RESIDENCE
 5 Ester Street, Chevy Chase, MD, 20815
 Project No. 13035, Drawing No. 1-4.00
 Date 11/4/2013
 Drawn by:

Square 134 Architects
 1101 Connecticut Avenue, Washington, DC 20008

CHEVY CHASE SURVEY FORM, 1995

SURVEY AREA # 3ADDRESS 5 E. MELROSEContact Sheet # 320

ARCHITECTURAL STYLE

CATEGORY: 1 2 ✓ NC OOP

- | | |
|------------------------|---------------------|
| 1. Gothic Revival | 7. Colonial Revival |
| 2. Renaissance Revival | 8. Four Square |
| 3. Tudor Revival | 9. Craftsman |
| 4. Classical Revival | 10. Bungalow |
| 5. Mission | 11. Art Deco |
| 6. Dutch Colonial | 12. Other _____ |

NUMBER OF STORIES

1 1.5 2 2.5 ✓ 3 or more
(indicate #)

NUMBER OF BAYS

1 2 3 ✓ 4 5 6 or more
(indicate #)

PRINCIPAL WALL MATERIALS - 1st story

- | | | | |
|---------------------|----------|-------------------|----------------|
| 1. Wood - clapboard | 3. Brick | 5. Concrete | 7. Stucco |
| 2. Wood - shingle | 4. Stone | 6. Aluminum/Vinyl | 8. Other _____ |

2nd story

- | | | | |
|---------------------|----------|-------------------|----------------|
| 1. Wood - clapboard | 3. Brick | 5. Concrete | 7. Stucco |
| 2. Wood - shingle | 4. Stone | 6. Aluminum/Vinyl | 8. Other _____ |

PRINCIPAL WINDOW TYPE - 1st Story

- | | | | | | | |
|---------------------|--------|--------|--------|--------|-------------|----------------|
| a. 1/1 | b. 8/8 | c. 6/1 | d. 6/6 | e. 9/1 | f. Casement | g. Other _____ |
| + 1 8/8 in addition | | | | | | |


2nd Story

- | | | | | | | |
|--------|--------|--------|--------|--------|-------------|----------------|
| a. 1/1 | b. 8/8 | c. 6/1 | d. 6/6 | e. 9/1 | f. Casement | g. Other _____ |
|--------|--------|--------|--------|--------|-------------|----------------|


ROOF SHAPE

Gabled:

Hipped:

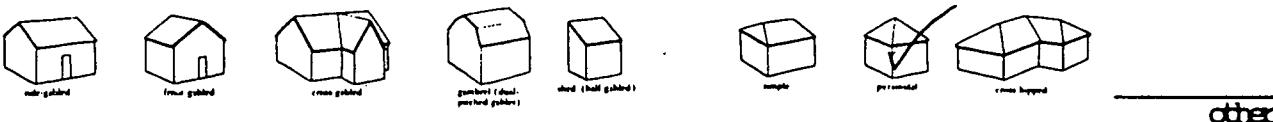

ROOF MATERIALS

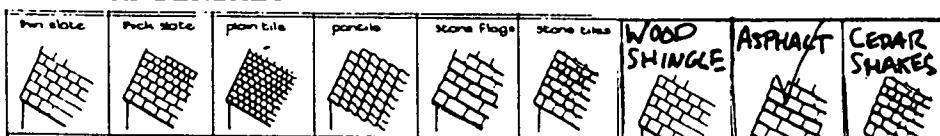

other

DATE/ERA OF CONSTRUCTION BY 1912pre-1916 ✓ 1916-27 1927-45 post-45 unknown 1912 RESIDENT: JOHN L. RIGGENWAY
GEOLOGICAL SURVEY
ALMANY BRICE, COOKnotes on back ✓

Shingle Craftsman garage

Note: Four Sq. ✓
Four

00455452