

HISTORIC PRESERVATION COMMISSION

Marc Elrich
County Executive

Robert Sutton
Chairman

Date: March 18, 2024

MEMORANDUM

TO: Rabbiah Sabbakhan

Department of Permitting Services

FROM: Chris Berger

Historic Preservation Section

Maryland-National Capital Park & Planning Commission

SUBJECT: Historic Area Work Permit # 1058872 - deck demolition, building addition, and deck construction

The Montgomery County Historic Preservation Commission (HPC) has reviewed the attached application for a Historic Area Work Permit (HAWP). This application was **approved** at the March 6, 2024, HPC meeting with six conditions:

- 1. The applicant shall provide specifications for the door.
- 2. The windows shall be either wood or wood with aluminum cladding, and the grilles shall be either full divided lite or simulated divided lite with permanent exterior and interior grilles.
- 3. The applicant shall label the infill material below the windows on the rear elevation.
- 4. The applicant shall revise the existing south elevation to accurately show the existing deck stairs.
- 5. The applicant shall add the dimensions of the addition to the proposed floor plan.
- 6. The MDO paneling shall be painted.

The HPC staff has reviewed and stamped the attached construction drawings.

THE BUILDING PERMIT FOR THIS PROJECT SHALL BE ISSUED CONDITIONAL UPON ADHERENCE TO THE ABOVE APPROVED HAWP CONDITIONS AND MAY REQUIRE APPROVAL BY DPS OR ANOTHER LOCAL OFFICE BEFORE WORK CAN BEGIN.

Applicant: Scott Plunkett and Jasleen Kaur Address: 7328 Piney Branch Road, Takoma Park

This HAWP approval is subject to the general condition that the applicant will obtain all other applicable Montgomery County or local government agency permits. After the issuance of these permits, the applicant must contact this Historic Preservation Office if any changes to the approved plan are made. Once work is complete the applicant will contact Chris Berger at 301-495-4571 or chris.berger@montgomeryplanning.org to schedule a follow-up site visit.





APPLICATION FOR HISTORIC AREA WORK PERMIT HISTORIC PRESERVATION COMMISSION 301.563.3400

DATE ASSIGNED____

FOR STAFF ONLY:

HAWP#_

APPLICANT:

Name: _	Scott Plunkett and Jasleen Kaur	E-mail: scottplunkett.ltd@gmail.com
Address:	7328 Piney Branch Road	City: Takoma Park, MD zip: 20912
Daytime	Phone: 202-415-3961	Tax Account No.: 01058197
AGENT/	CONTACT (if applicable):	
Name: <u>E</u>	REVIEWED	E-mail: eric@saularchitects.com
Address:	By Chris Berger at 3:42 pm, I	Mar 18, 2024 Takoma Park, MD Zip: 20912
Daytime	P 714 553 1750 APPROVED	Contractor Registration No.: n/a
LOCATIO	Montgomery County	of Historic Property
Is the Pr	op Historic Preservation Commission	ict? _XYes/District Name_Takoma Park No/Individual Site Name
Is there a		nvironmental Easement on the Property? If YES, include a n the Easement Holder supporting this application.
Are othe	r F	pprovals /Reviews Required as part of this Application? If YES, include information on these reviews as
•	nental information.	ii 123, include information on these reviews as
Building	Number: <u>7328</u> Str	eet: Piney Branch Road
Town/Ci	ty: Takoma Park, MD Nea	arest Cross Street: Takoma Avenue
Lot: <u>15</u>	Block: 11 Sub	odivision: 0025 Parcel: 0000
		list on Page 4 to verify that all supporting items sapplication. Incomplete Applications will not
	pted for review. Check all that appl	
	ew Construction 🔟 Deck/Po	
	ddition	Tree removal/planting pe/Landscape x Window/Door
=	emolition	Other:
_		ake the foregoing application, that the application is correc
		omply with plans reviewed and approved by all necessary
	es and hereby, acknowledge and acce	ot this to be a condition for the issuance of this permit.
	Cric (Daul	2/13/24

HAWP APPLICATION: MAILING ADDRESSES FOR NOTIFING

[Owner, Owner's Agent, Adjacent and Confronting Property Owners]

\sim	•		1 1
()wne	r's t	nailing	address

7328 Piney Branch Road Takoma Park, MD 20912

Owner's Agent's mailing address

8114 Carroll Avenue Takoma Park, MD 20912

Adjacent and confronting Property Owners mailing addresses

7330 Piney Branch Road Takoma Park, MD 20912 7324 Piney Branch Road Takoma Park, MD 20912

7329Piney Branch Road Takoma Park, MD 20912 7319 Baltimore Ave Takoma Park, MD 20912

REVIEWED timore Ave

By Chris Berger at 3:42 pm, Mar 18, 2024

7325 Baltimore Ave Takoma Park, MD 20912

APPROVED

Montgomery County

Historic Preservation Commission

Rame h. M.

Description of Property: Please describe the building and surrounding environment. Include information on significant structures, landscape features, or other significant features of the property:

Existing property is a historic craftsman style bungalow located in the Takoma Park historic district. The property slopes steeply towards the rear where there is a walk-out basement condition.

Description of Work Proposed: Please give an overview of the work to be undertaken:

Proposed is a small addition on the rear of the house to fill in the existing inset covered porch in order to expand the existing kitchen. The existing deck will be replaced and expanded. Also proposed are new windows and a new door leading onto the deck from the kitchen.

REVIEWED

By Chris Berger at 3:42 pm, Mar 18, 2024


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Montgomery County

Historic Preservation Commission

Rameta Man

Work Item 1: Rear Addition						
Description of Current Condition:	Proposed Work:					
Inset covered porch	New addition to expand kitchen					
Work Item 2: New Deck Description of Current Condition:	Proposed Work:					
Existing pressure treated deck	New 10' x 15' pressure treated deck					

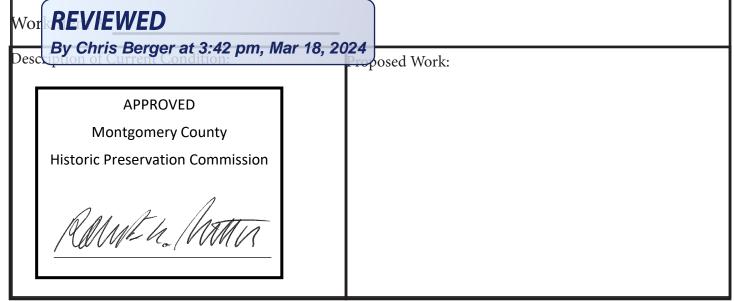

HISTORIC AREA WORK PERMIT CHECKLIST OF APPLICATION REQUIREMENTS

	Required Attachments						
Proposed Work	I. Written Description	2. Site Plan	3. Plans/ Elevations	4. Material Specifications	5. Photographs	6. Tree Survey	7. Property Owner Addresses
New Construction	*	*	*	*	*	*	*
Additions/ Alterations	*	*	*	*	*	*	*
Demolition	*	*	*		*		*
Deck/Porch	*	*	*	*	*	*	*
Fence/Wall	*	*	*	*	*	*	*
Driveway/ Parking Area	*	*		*	*	*	*
Grading/Exc avation/Land scaing	*	*		*	*	*	*
Tree Removal	*	*		*	*	*	*
Siding/ Roof Changes	*	*	*	*	*		*
Window/ Door Changes	*	*	*	*	*		*
Masonry Repair/ Repoint	*	*	*	*	*		*
Signs	*	*	*	*	*		*

REVIEWED


By Chris Berger at 3:42 pm, Mar 18, 2024

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Montgomery County

Historic Preservation Commission

Ramen home

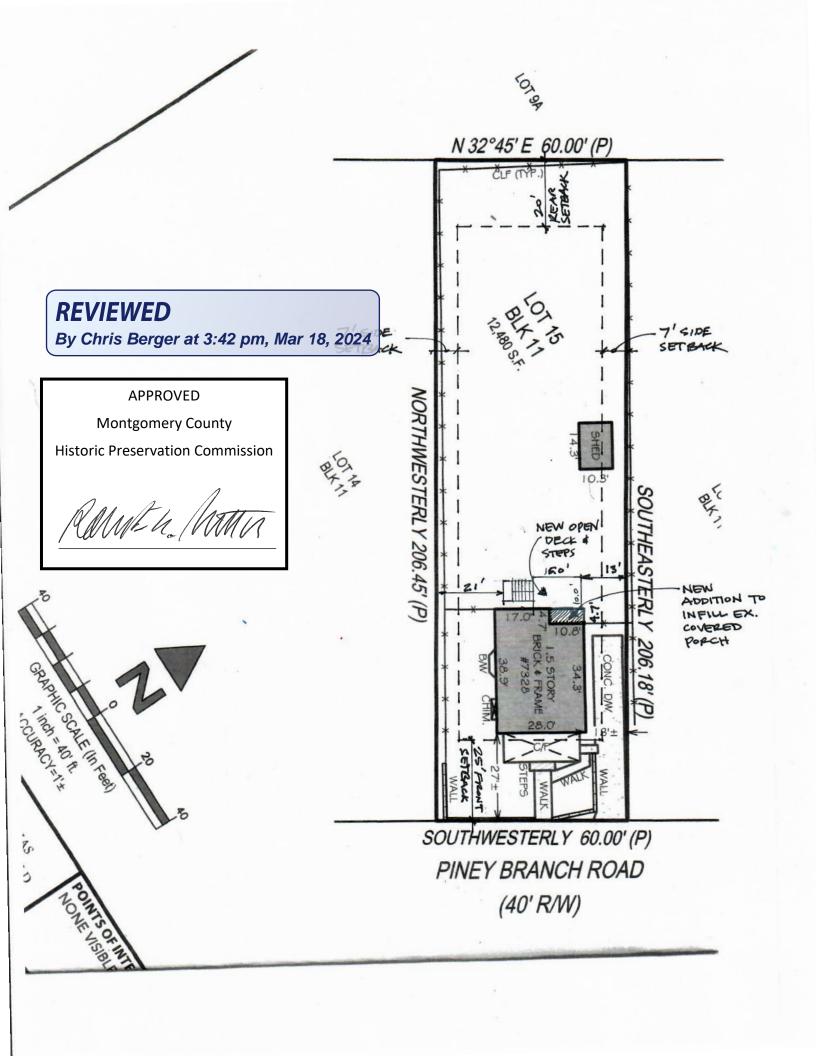

MUNICIPAL STAMPS

APPROVED Montgomery County **Historic Preservation Commission**

PLUNKETT/KAUR RESIDENCE ADDITION AND RENOVATION


7328 PINEY BRANCH ROAD | TAKOMA PARK, MD 20912

▲RCHITE

REVISIONS

CODE ANALYSIS GRAPHIC SYMBOLS SITE PLAN: 1" = 20'-0" SHEET INDEX PROJECT TEAM RESIDENCE **OWNERS:** ARCHITECTURAL SMALL REAR ADDITION TO FILL-IN THE EXISTING SCOTT PLUNKET AND JASLEEN KAUR 7328 PINEY BRANCH ROAD SHEET NUMBER COVERED PORCH WITH HABITABLE SPACE TO EXPAND THE CS COVER SHEET EXISTING KITCHEN AND A NEW REAR DECK AND STEPS. TAKOMA PARK, MD 20912 **DETAIL CALLOUT** EXISTING/DEMO FLOOR PLANS PROPOSED FLOOR PLANS AND WINDOW/DOOR SCHEDULES LOT: BLOCK: SUBDIVISION: (202) 415-3961 SHEET NUMBER ARCHITECT:
ERIC C. SAUL, RA
SAUL ARCHITECTS
8114 CARROLL AVENUE CODE: ZONE: CONSTRUCTION TYPE: NO. OF STORIES: A2 EXTERIOR ELEVATIONS IRC 2018 R-60 **ELEVATION CALLOUT** SHEET NUMBER BUILDING SECTION AND DETAILS N 32°45' E 60.00' (P) 2 PLUS BASEMENT FRAMING PLANS AND STRUCTURAL NOTES DETAIL NUMBER **DESIGN CRITERIA:** TAKOMA PARK, MD 20912 GROUND SNOW LOAD ELECTRICAL PLAN SHEET NUMBER 115 MPH (301) 270-0395 SEISMIC DESIGN CATEGORY WEATHERING INTERIOR ELEVATION FROST DEPTH LINE MODERATE TO HEAVY WINTER DESIGN TEMP. ICE SHIELD UNDERLAYMENT REQ'D PLUN SPOT ELEVATION AIR FREEZING INDEX MEAN ANNUAL TEMP. WINDOW IDENTIFIER ALLOWED HEIGHT: 2 1/2 STORIES; 30'-0" MEAN HEIGHT 7' SIDE PROPOSED HEIGHT: UNCHANGED SETBACK SETBACKS: DOOR IDENTIFIER SETBACK 25'-0" 7'-0" 20'-0" FRONT YARD SIDE YARD REAR YARD FLOOR HEIGHT IDENTIFIER LOT AREA CALCULATIONS: 12,480.0 SQ. FT. (100.0%) 4,368.0 SQ. FT. (35.0%) 1,236.5 SQ. FT. (9.9%) **KEYNOTE** MAX. LOT COVERAGE EXISTING COVERAGE PROPOSED COVERAGE 1,236.5 SQ. FT. (9.9%) INCREASED COVERAGE 0.0 SQ. FT. (0.0%) REVISION INDICATOR ADDITIONAL LOT COVERAGE 0.0 SQ. FT. FLOOR LIVING AREA CALCULATIONS: NEW OPEN EXISTING FLOOR AREA 1,038.4 SQ. FT. 1,038.4 SQ. FT. / DECK & FIRST FLOOR STEPS PROFESSIONAL CERTIFICATION SECOND FLOOR 568.0 SQ. FT. I, ERIC SAUL, HEREBY CERTIFY TOTAL EXISTING 2,644.8 SQ. FT. THAT THESE DOCUMENTS WERE PREPARED OR APPROVED BY ME AND THAT I AM A DULY LICENSEI PROPOSED FLOOR AREA ADDITION TO 1,038.4 SQ. FT. ARCHITECT UNDER THE LAWS OF BASEMENT INFILL EX. THE STATE OF MARYLAND. 1,089.2 SQ. FT. FIRST FLOOR LICENSE NO. 14248, EXPIRATION 568.0 SQ. FT. COVERED SECOND FLOOR DATE JUNE 30, 2025 2,695.6 SQ. FT. PORCH TOTAL PROPOSED 50.8 SQ. FT. (10.1%) % INCREASE PROJECT NUMBER: 24002 150 SQ. FT. DECK ADDITION PRINTING LOG 58 SQ. FT. TOTAL ADDITION DATE PURPOSE 03.06.24 PERMIT SET REMODELED FLOOR AREA 0 SQ. FT. 161.2 SQ. FT. **BASEMENT** FIRST FLOOR SECOND FLOOR 0 SQ. FT. 161 SQ. FT. TOTAL RENOVATION SOUTHWESTERLY 60.00' (P) **COVER SHEET** AND SITE PLAN PINEY BRANCH ROAD (40' R/W)

APPROVED Montgomery County **Historic Preservation Commission** MUNICIPAL STAMPS

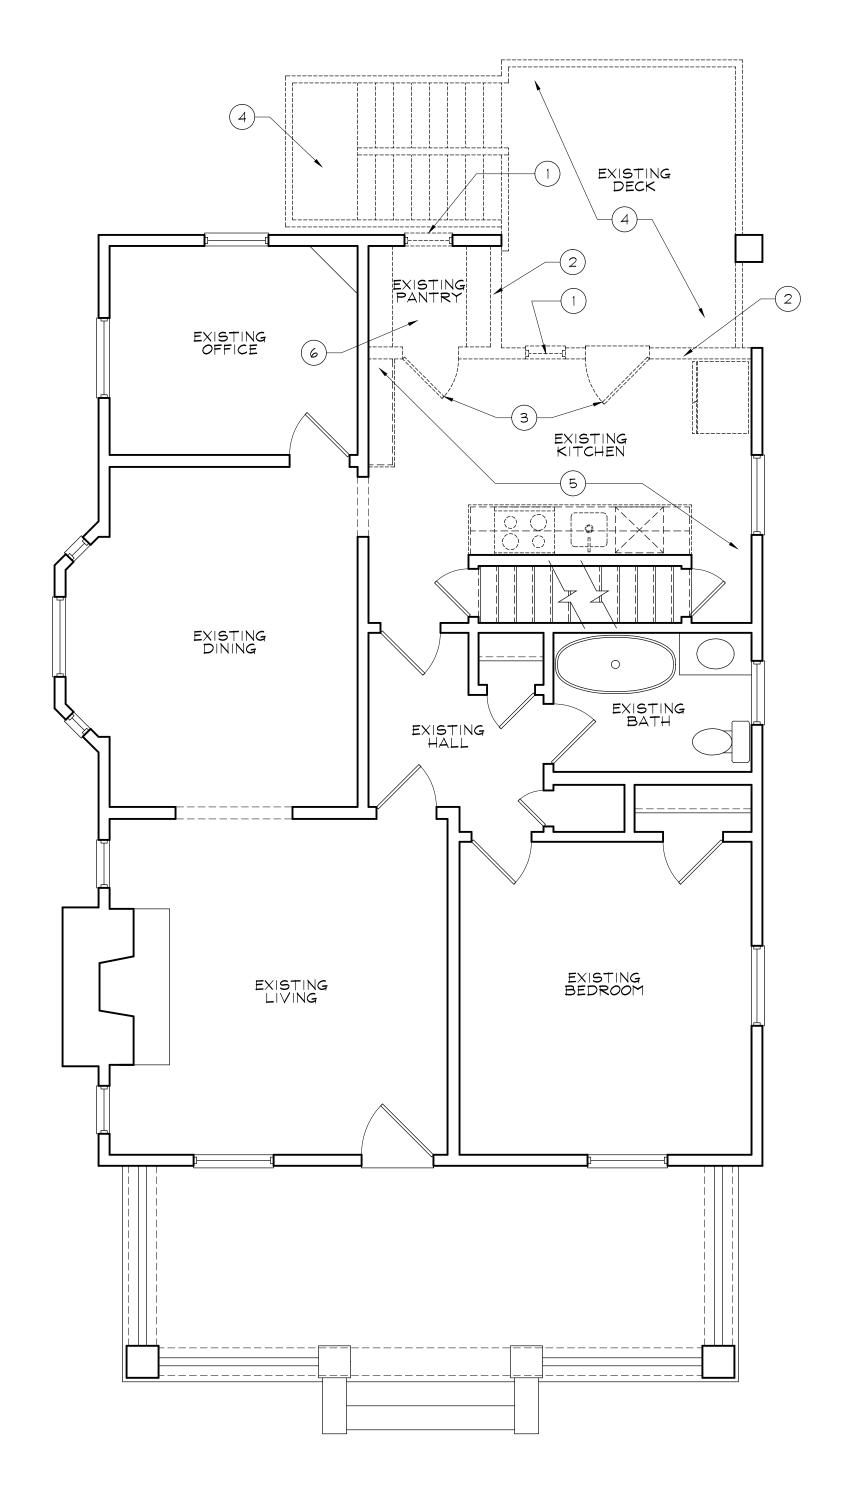

EXISTING/DEMO FIRST FLOOR PLAN A1 1/4" = 1'-0"

DEMOLITION KEYNOTES:

- (1) EXISTING WINDOW TO BE REMOVED
- (2) NON-BEARING EXTERIOR WALL TO BE REMOVED
- (3) EXISTING DOOR TO BE REMOVED
- (4) DEMO EXISTING EXTERIOR DECK AND STEPS
- 5 COMPLETE DEMO OF EXISTING KITCHEN: REMOVE ALL CABINETS, PLUMBING FIXTURES, HARDWARE, FINISHES AND FLOORING. CAP ALL PLUMBING AND EXPOSE ALL MECHANICAL AND ELECTRICAL.
- 6 EXISTING PANTRY TO BE DEMOLISHED

▲RCHITECTS

REVISIONS

GENERAL DEMO NOTES

- 1. DEMOLITION DRAWINGS ARE SCHEMATIC AND ARE INCLUDED TO DESCRIBE THE DEMOLITION WORK IN A GENERAL MANNER.
- 2. EXISTING CONSTRUCTION SHALL REMAIN UNLESS NOTED OTHERWISE AND SHALL BE PROTECTED FROM DAMAGE DUE TO DEMOLITION, CONSTRUCTION, THEFT, VANDALISM, MOISTURE, WEATHER, ETC. ALL DISTURBED EXISTING ITEMS SHALL BE RESTORED TO ORIGINAL CONDITION.
- 3. SEAL OFF UNDISTURBED AREAS OF THE BUILDING FROM DEMOLITION AREAS TO PREVENT THE INFILTRATION OF DUST AND DEBRIS. SECURE BUILDING TO PREVENT UNWANTED ENTRY THROUGH OPENINGS CREATED DURING CONSTRUCTION.
- 4. EXISTING CONCEALED ELEMENTS WERE NOT NECESSARILY VERIFIED PRIOR TO DEMOLITION. ALL DISCOVERIES OF UNIDENTIFIED OR INCORRECTLY LOCATED EXISTING ELEMENTS SHALL BE REPORTED TO THE ARCHITECT BEFORE REMOVAL FOR FINAL DISPOSAL,
- 5. ALL ITEMS DESIGNATED FOR RE-USE TO BE VERIFIED BY OWNER. PROTECT ANY STORED ITEMS TO BE RE-USED FROM DAMAGE DUE TO DEMOLITION, CONSTRUCTION, THEFT, VANDALISM, MOISTURE, WEATHER, ETC.
- 6. ALL DEBRIS BECOMES THE PROPERTY OF THE

DNTRACTOR AND SHALL	DATE JUNE 30, 2025		
REMISES AT THE CONTR SPOSED OF ACCORDING	PROJE	CT NUMBER: 2	
OVERNING AUTHORITIES.		F	PRINTING LOG
		DATE	PURPOSE
OOR PLAN	LEGEND	03.06.24	PERMIT SET
EXISTING	WALL TO REMAIN		
NEW INT.	2X4 STUD WALL, U.N.O.		
	2X4 STUD FURRED WALL INSULATION		
* * * * * *	ERIOR 2X6 STUD WALL; . Insulation		
NEW 8" C	ONC. MASONRY WALL	EXIS	TING/DEM

NEW BRICK MASONRY WALL OR PIER

EXISTING ITEM TO BE REMOVED

CEILING HEIGHT INDICATOR

EXISTING WALL TO BE REMOVED

(8'-0"

FLOOR PLANS

PROFESSIONAL CERTIFICATION: I, ERIC SAUL, HEREBY CERTIFY

THAT THESE DOCUMENTS WERE

PREPARED OR APPROVED BY ME,

AND THAT I AM A DULY LICENSED

ARCHITECT UNDER THE LAWS OF

THE STATE OF MARYLAND. LICENSE NO. 14248, EXPIRATION



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Montgomery County

Historic Preservation Commission

MUNICIPAL STAMPS

	WINDOW SCHEDULE								
	SYMB	MANUFACTURER	TYPE	MATERIAL	APPROX. UNIT SIZE	HEAD	DOW DET.	AILS SILL	REMARKS
ſ	1	TBD	DOUBLE HUNG	WOOD	32" X 48"				QUANTITY = 3

. HARDWARE AND FINISH TO BE SELECTED BY OWNER

2. ALL WINDOWS TO HAVE 7/8" SIMULATED DIVIDED LITES AS SHOWN IN THE ELEVATION DRAWINGS


3. DOUBLE GLAZING, LOW E GLASS WITH ARGON

4. ARCHITECT TO REVIEW FINAL WINDOW ORDER BEFORE PURCHASING

DO	OR SCHE	DULE							
DOOR NO.	ROOM NAME	DOOR SIZE	DOOR TYPE	HDWR SET	THRESH	DC HEAD	OR DETA	ILS SILL	REMARKS
FIRS	T FLOOR		<u>'</u>	1					
1A	KITCHEN	3'-0" x 6'-8"	SWING	1	ALUM.	-	-	-	EXTERIOR DOOR TO BE SELECTED BY OWNER

HARDWARE SETS: (ALL HARDWARE FINISHES TO BE SELECTED BY OWNER)

1. (3) 3.5" HINGES; ENTRY LOCK AND DEADBOLT

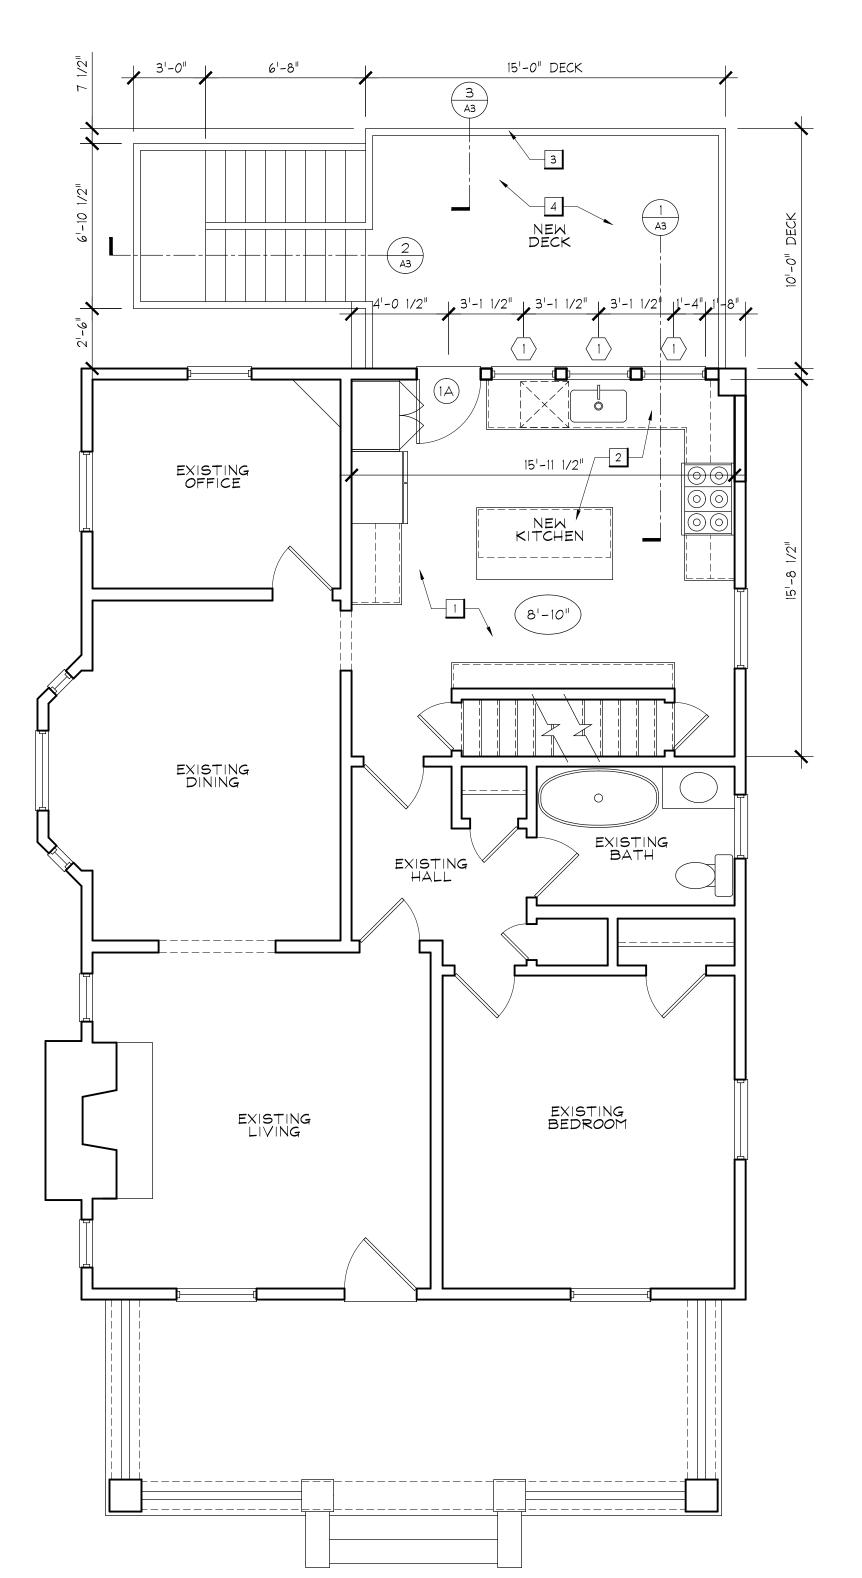

1. ALL JO

FLOOR PLAN KEYNOTES:

- NEW HARDWOOD FLOORING TO MATCH DIRECTION OF EXISTING ADD BLOCKING UNDER FLOOR AS NEEDED
- 2 NEW KITCHEN CABINETS PER SEPARATE KITCHEN DESIGN DRAWINGS
- 3 NEW 36" HIGH DECK GUARDRAIL
- 4 PT DECKING BOARDS

GENERAL NOTES:

- ALL DIMENSIONS ARE TO FACE OF STUD, CONCRETE OR MASONRY ON NEW WALLS, AND TO FACE OF FINISH OF EXISTING WALLS.
- 2. ANGLED WALLS ARE 45° TO ADJACENT WALLS, U.N.O.
- 3. DOORS TO BE LOCATED 4" FROM WALL ON HINGE SIDE OR CENTER OF THE SPACE, U.N.O.

AIR LEAKAGE:

PER IRC: 402.4.2

BUILDING THERMAL ENVELOPE. THE BUILDING THERMAL ENVELOPE SHALL BE DURABLY SEALED TO LIMIT INFILTRATION. THE SEALING METHODS BETWEEN DISSIMILAR MATERIALS SHALL ALLOW FOR DIFFERENTIAL EXPANSION AND CONTRACTION. THE FOLLOWING SHALL BE CAULKED, GASKETED, WEATHERSTRIPPED, OR OTHERWISE SEALED WITH AN AIR BARRIER MATERIAL, SUITABLE FILM OR SOLID MATERIAL:

1. ALL JOINTS, SEAMS AND PENETRATIONS
2. SITE-BUILT WINDOWS, DOORS AND SKYLIGHTS
3. OPENINGS BETWEEN WINDOW AND DOOR ASSEMBLIES AND THEIR RESPECTIVE JAMBS AND FRAMING

- 4. UTILITY PENETRATIONS
 5. DROPPED CEILINGS OR CHASES ADJACENT TO THE THERMAL ENVELOPE
- 6. KNEE WALLS
 7. WALLS AND CEILINGS SEPARATING A GARAGE FROM CONDITIONED SPACES
 8. BEHIND TUBS AND SHOWERS ON EXTERIOR WALLS
- 9. COMMON WALLS BETWEEN DWELLING UNITS
 10. ATTIC ACCESS OPENINGS
 11. RIM JOIST JUNCTION

12. OTHER SOURCES OF INFILTRATION

M1601.4 INSTALLATION.

DUCT INSTALLATION SHALL COMPLY WITH SECTIONS
M1601.4.1 THROUGH M1601.4.7

MICOLAI JOINTE AND SEAMS

M1601.4.1 JOINTS AND SEAMS JOINTS OF DUCT SYSTEMS SHALL BE MADE SUBSTANTIALLY AIRTIGHT BY MEANS OF TAPES, MASTICS, LIQUID SELANTS, GASKETING OR OTHER APPROVED CLOSURE SYSTEMS. CLOSURE SYTEMS USED WITH RIGID FIBROUS GLASS DUCTS SHALL COMPLY WITH UL181A AND SHALL BE MARKED 181A-P FOR PRESSURE SENSITIVE TAPE, 181A-M FOR MASTIC OR 181 A-H FOR HEAT-SENSITIVE TAPE. CLOSURE SYSTEMS USED WITH FLEXIBLE AIR DUCTS AND FLEXIBLE AIR CONECTORS SHALL COMPLY WITH UL 181B AND SHALL BE MARKED 181B-FX FOR PRESSURE-SENSITIVE TAPE OR 181B-M FOR MASTIC. DUCT CONNECTIONS TO FLANGES OF AIR DISTRIBUTION SYSTEM EQUIPMENT OR SHEET METAL FITTINGS SHALL BE MECHANICALLY FASTENED, MECHANICAL FASTENERS FOR USE WITH FLEXIBLE NONMETALLIC AIR DUCTS SHALL COMPLY WITH UL 181B AND SHALL BE MARKED 181B-C. CRIMP JOINTS FOR ROUND METAL DUCTS SHALL HAE A CONTACT LAP OF AT LEAST 1 1/2 INCHES (38MM) AND SHALL BE MECHANICALLY FASTENED BY MEANS OF AT LEAST THREE SHEET-METAL SCREWS OR RIVETS EQUALLY SPACED AROUND THE JOINT. CLOSURE SYSTEMS USED TO SEAL METAL DUCTWORK SHALL BE INSTALLED IN ACCORDANCE WITH THE MANUFACTURER'S INSTALLATION INSTRUCTIONS.

EXCEPTIONS:

1. SPRAY POLYURETHANE FOAM SHALL BE PERMITTED TO BE APPLIED WITHOUT ADDITIONAL JOINT SEALS.

2. WHERE A DUCT CONNECTION IS MADE THAT IS PARTIALLY INACCESSIBLE, THREE SCREWS OR RIVETS SHALL BE EQUALLY SPACED ON THE EXPOSED PORTION OF THE JOINT SO AS TO PREVENT A HINGE FFECT.

3. CONTIUOUSLY WELDED AND LOCKING TYPE LONGITUDINAL JOINTS AND SEAMS IN DUCTS OPERATING AT STATIS PRESSURES LESS THAN 2 INCHES OF WATER COLUMN (500 PA) PRESSURE CLASSIFICATION SHALL NOT REQUIRE ADDITIONAL CLOSURE SYSTEMS.

FLOOR PLAN LEGEND

EXISTING WALL TO REMAIN

NEW INT. 2X4 STUD WALL, U.N.O.

NEW EXT. 2X4 STUD FURRED WALL
R-13 MIN. INSULATION

NEW EXTERIOR 2X6 STUD WALL;
R-20 MIN. INSULATION

R-2

NEW 8" CONC. MASONRY WALL

NEW BRICK MASONRY WALL OR PIER

EXISTING WALL TO BE REMOVED

-O" CEILING

CEILING HEIGHT INDICATOR

EXISTING ITEM TO BE REMOVED



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REVISIONS

PROFESSIONAL CERTIFICATION:
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ARCHITECT UNDER THE LAWS OF
THE STATE OF MARYLAND.
LICENSE NO. 14248, EXPIRATION
DATE JUNE 30, 2025

PROJECT NUMBER: 24002						
	PRINTING LOG					
DATE PURPOSE						
03.06.24	PERMIT SET					

PROPOSED FIRST AND SECOND FLOOR PLANS

A1.1

PROPOSED FIRST FLOOR PLAN

A1.1 / 1/4" = 1'-0"


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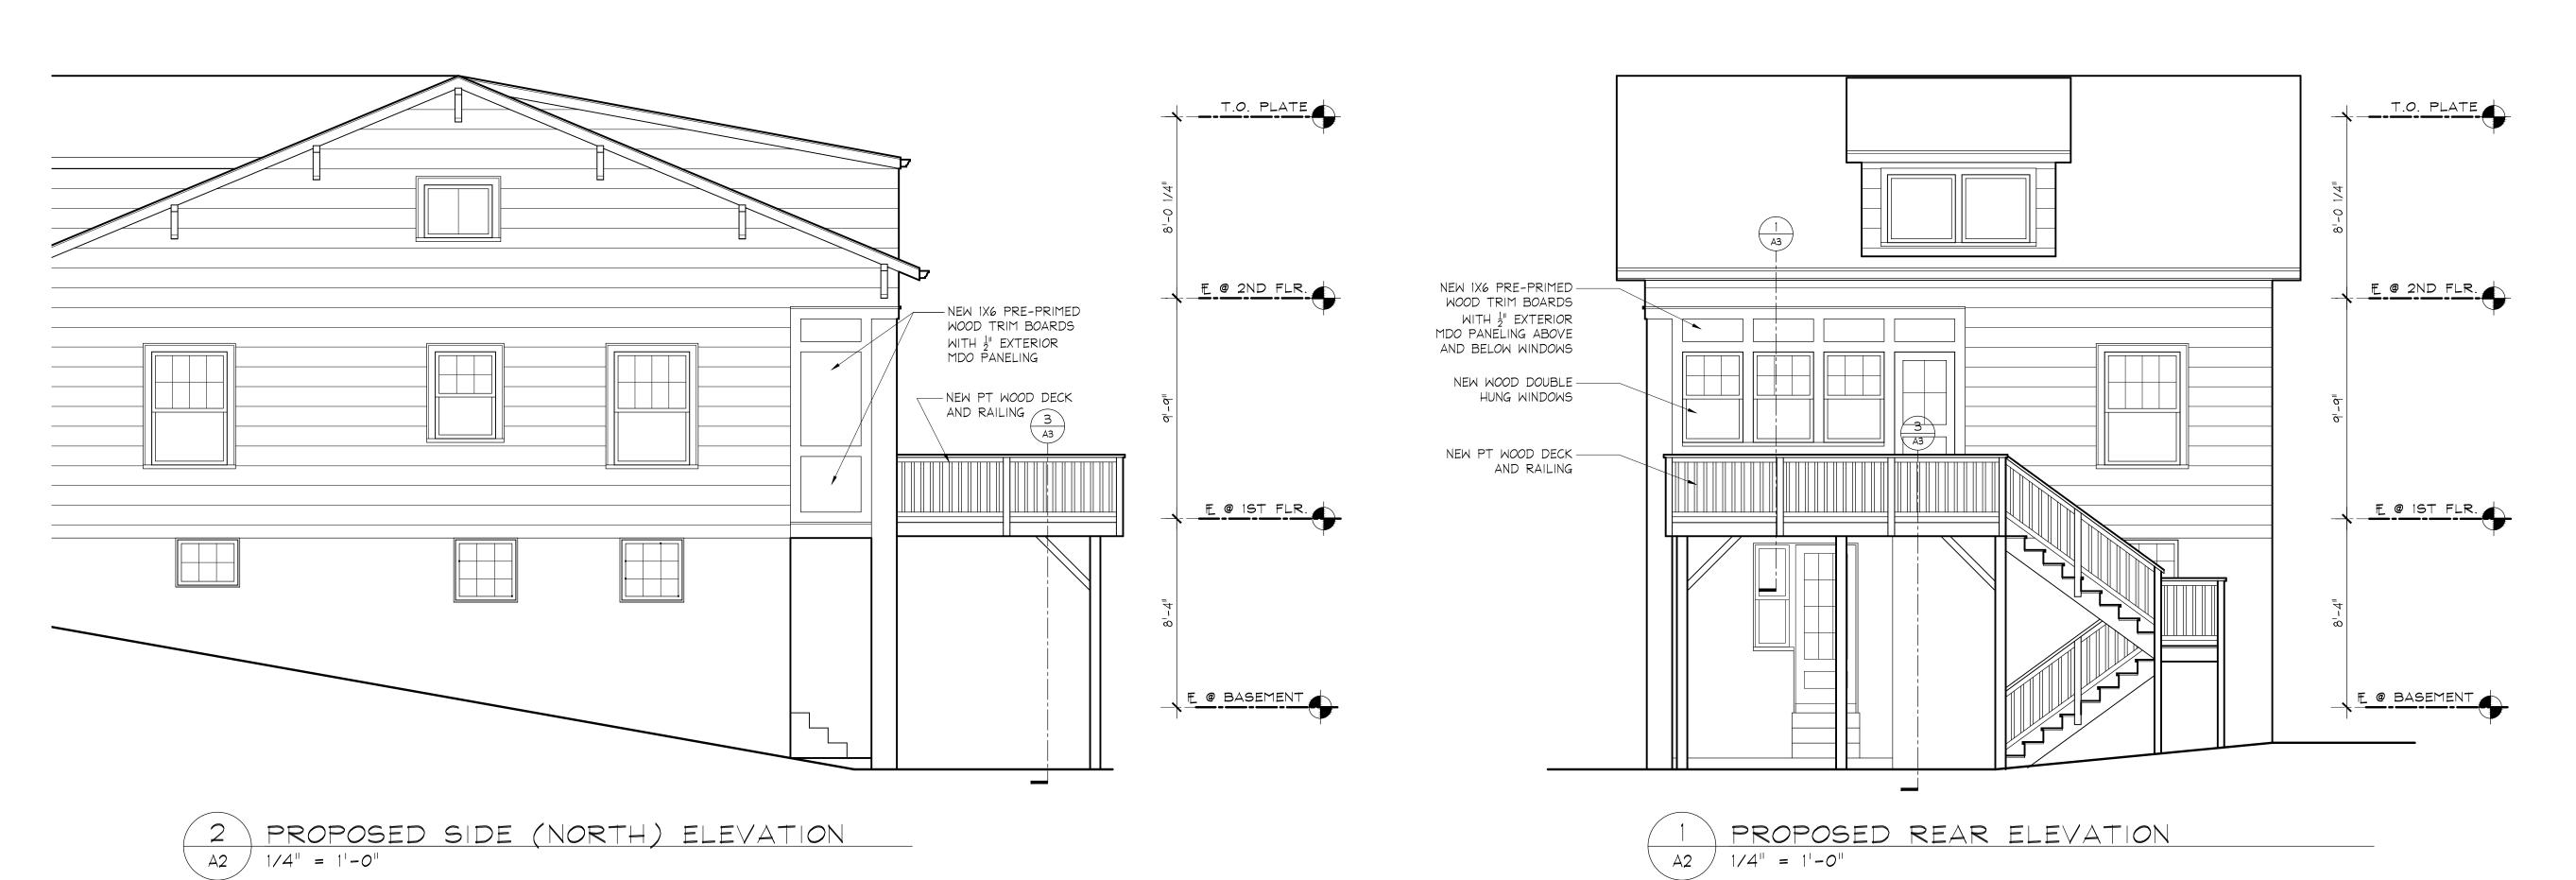
Montgomery County

Historic Preservation Commission

Addula Addula





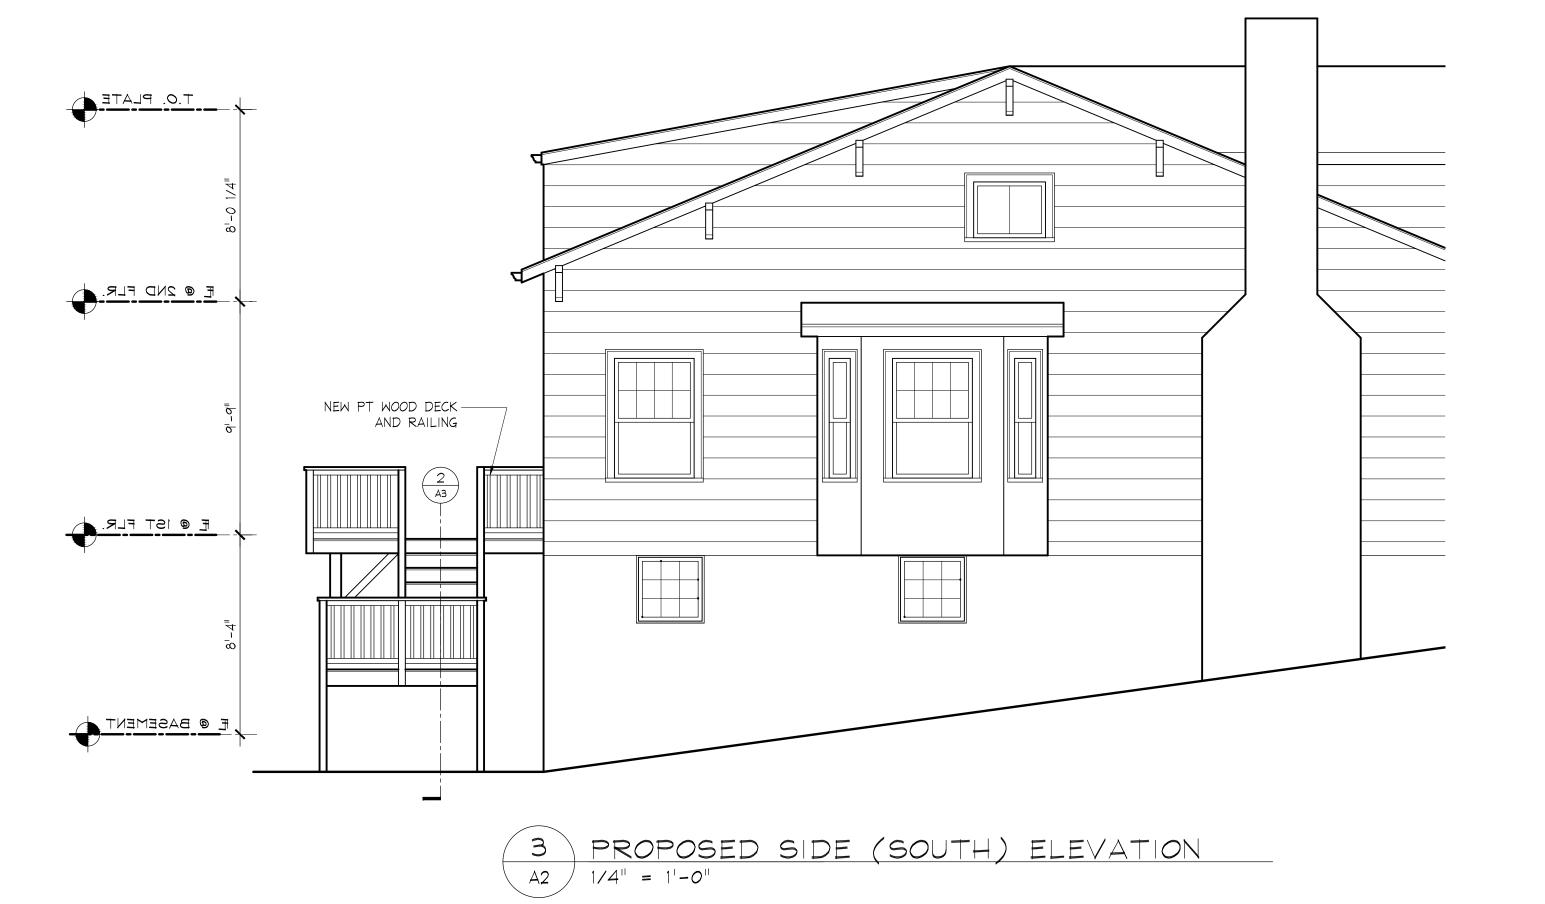

SAUL RCHITECTS

8114 CARROLL AVENUE | TAKOMA PARK, MD 20912
P: 301,270,0395
info@saularchitects.com
www.saularchitects.com

REVISIONS

PLUNKETT/KAUR RESIDENCE ADDITION AND RENOVATION 7328 PINEY BRANCH ROAD | TAKOMA PARK, MD 20912

OF MADE

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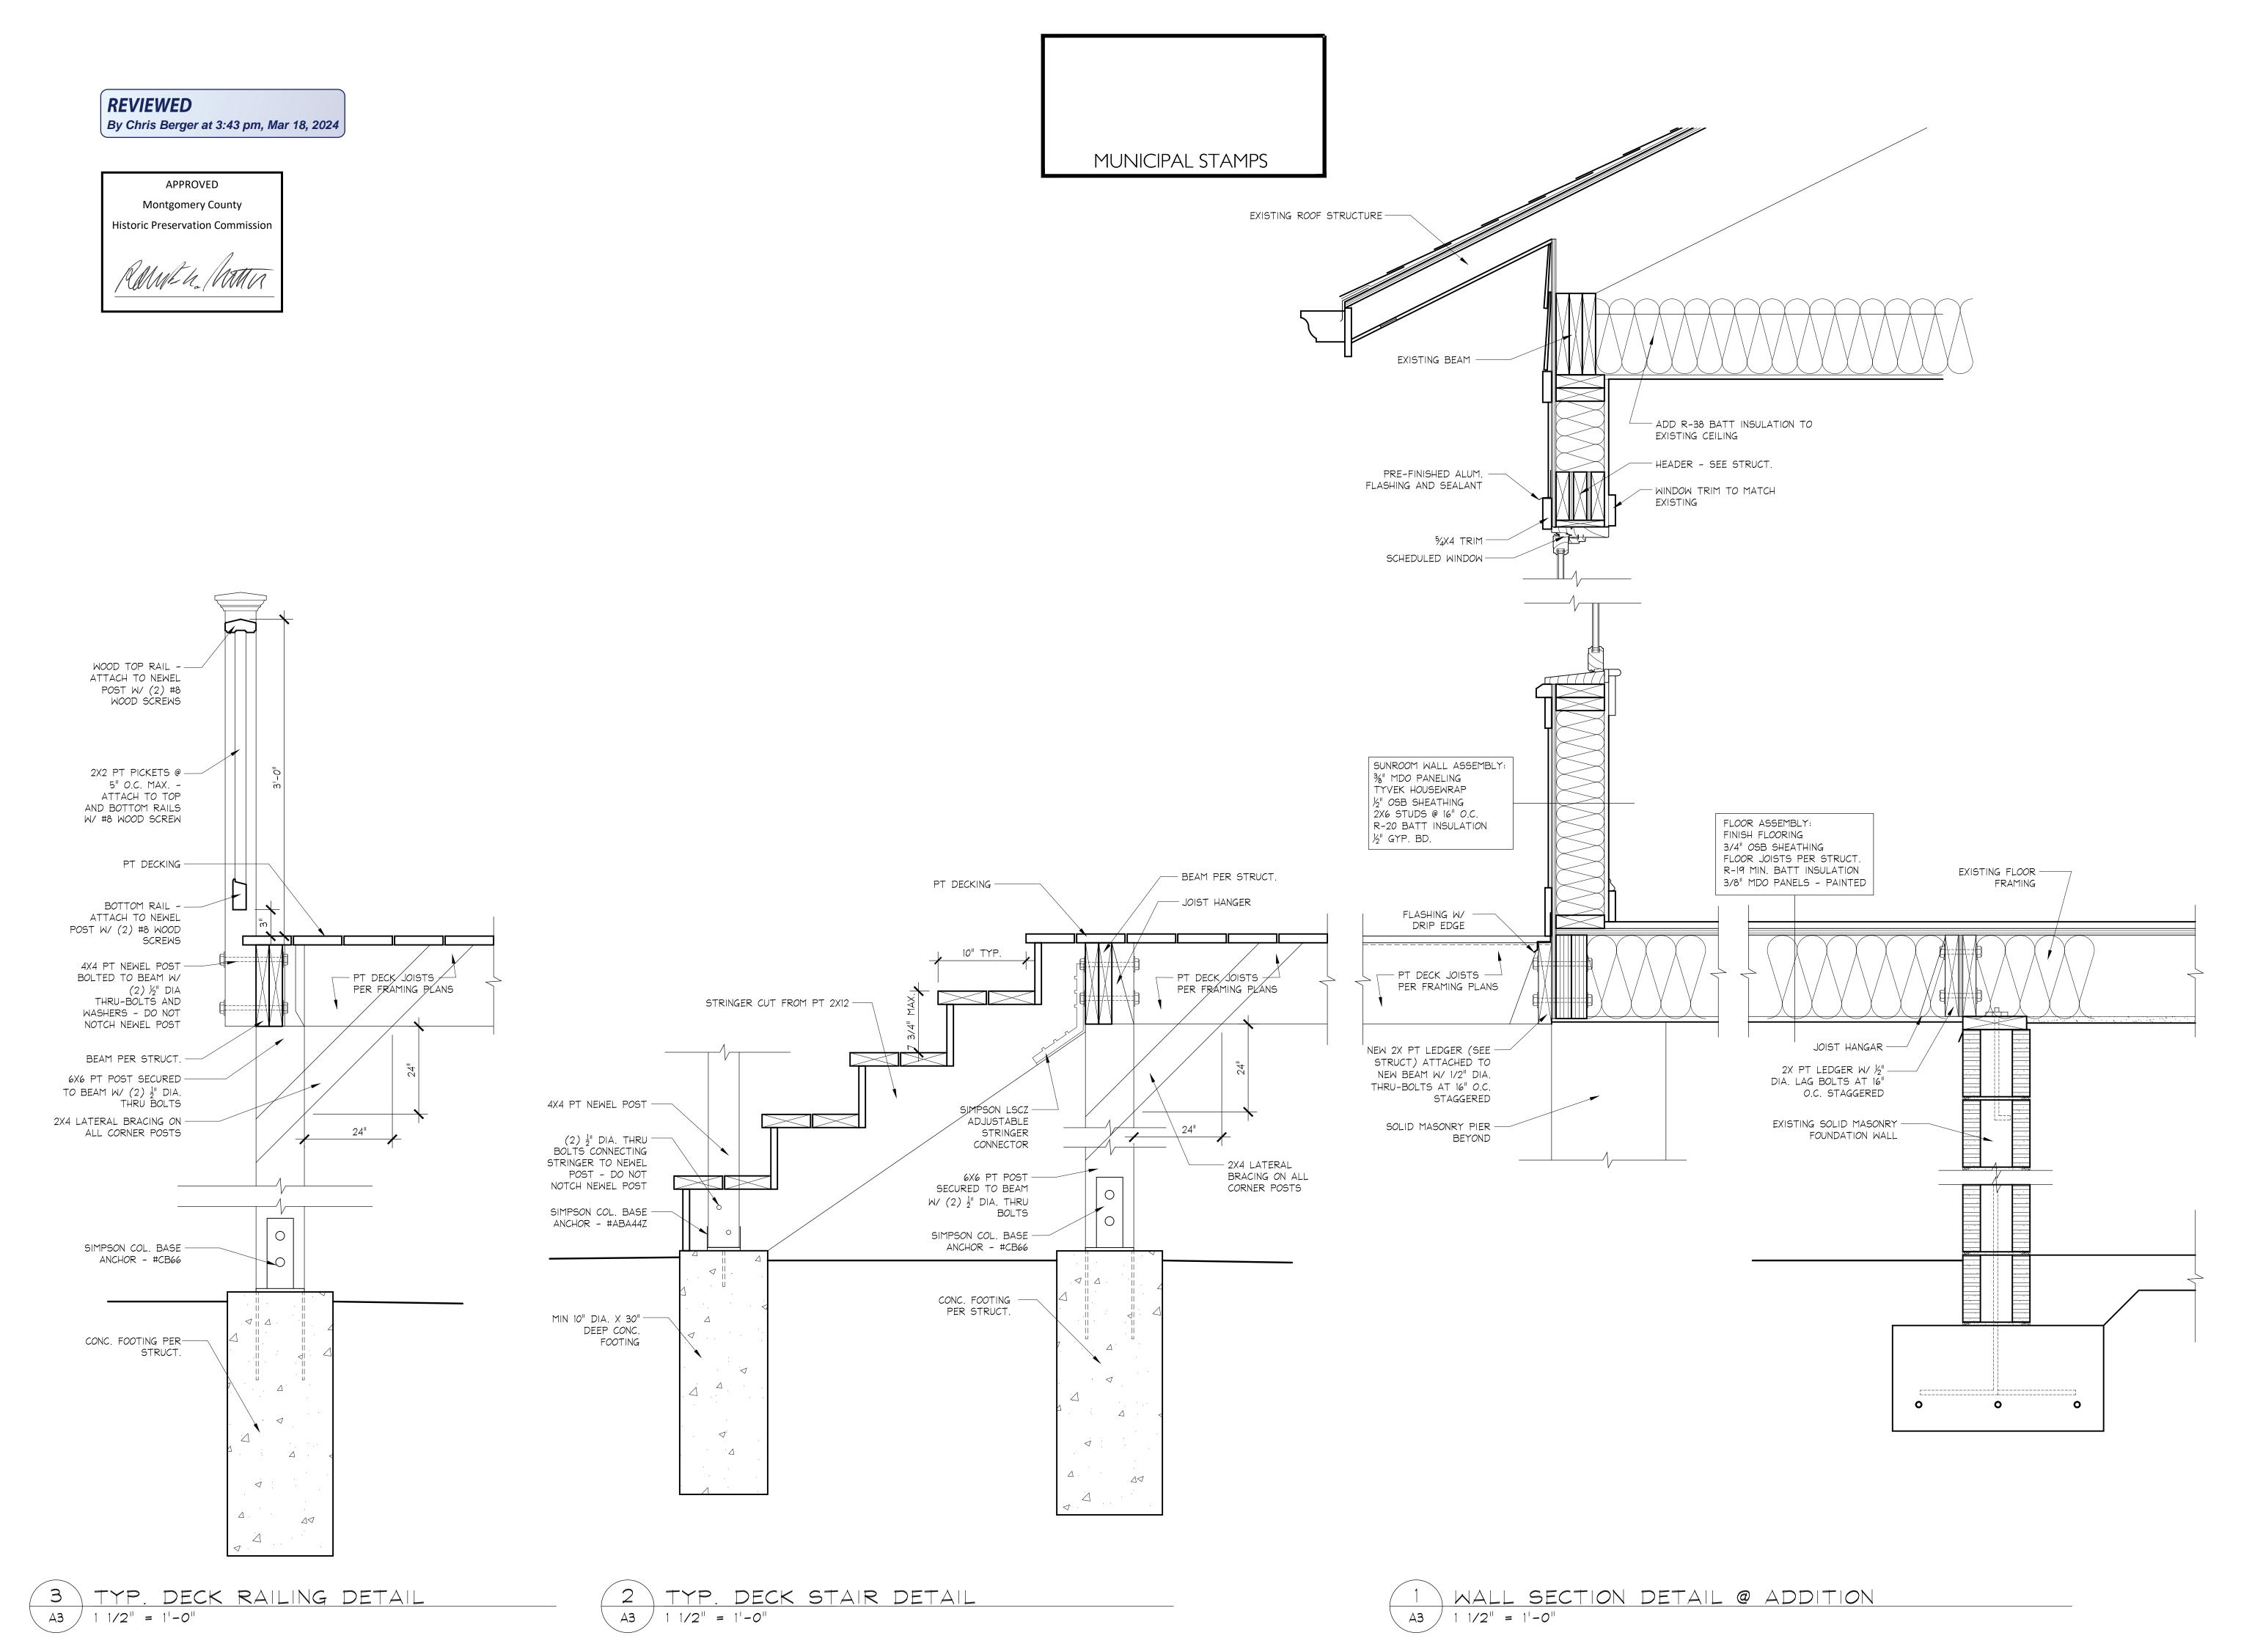
PRINTING LOG

DATE PURPOSE

03.06.24 PERMIT SET

EXTERIOR ELEVATIONS

A2



JL RCHITECTS

RROLL AVENUE | TAKOMA PARK, MD 20912

P: 301.270.0395

info@saularchitects.com

REVISIONS

ETT/KAUR RESIDENCE

PLUN

OF MAQUILLIAN OF

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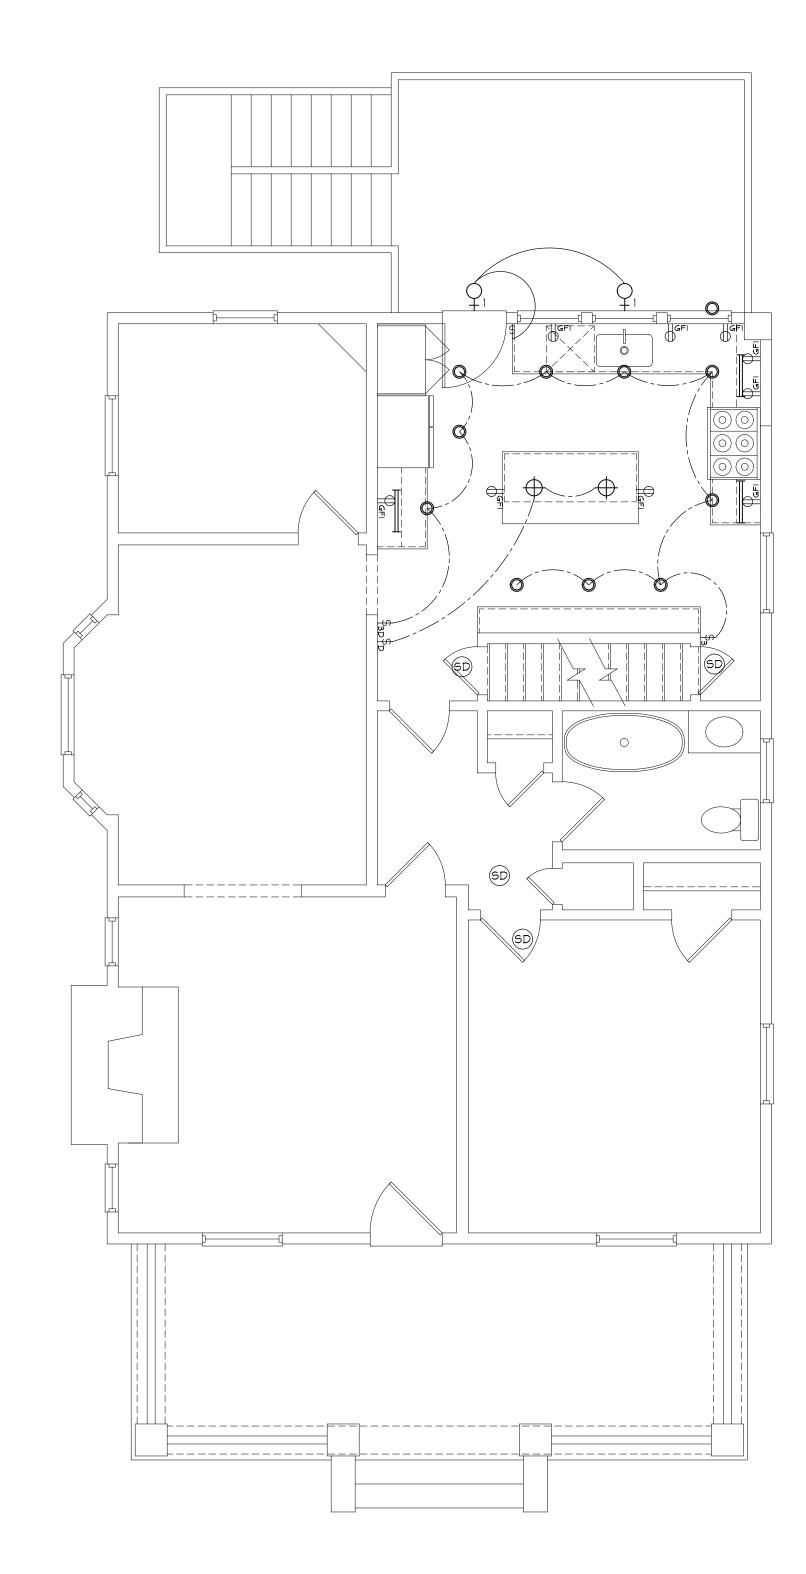
BLDG. SECTIONS AND DETAILS

A3



APPROVED Montgomery County Historic Preservation Commission





1 FIRST FLOOR ELECTRICAL PLAN
E1 1/4" = 1'-0"

ELECTRICAL SYMBOLS

THREE-WAY SWITCH

JAMB SWITCH

SWITCH WITH DIMMER

AIR SWITCH FOR DISPOSAL

DUPLEX RECEPTACLE

DUPLEX RECEPTACLE W/ USB PORTS

QUADRUPLEX RECEPTACLE

SWITCHED OUTLET

GROUND FAULT PROTECTED RECEPTACLE

WATERPROOF RECEPTACLE

220V RECEPTACLE

FLOOR MOUNTED DUPLEX RECEPTACLE

CEILING MOUNTED WIRELESS ACCESS POINT JACK

CABLE TELEVISION JACK W/ DUAL CAT6 DATA WIRING

TELEPHONE JACK/INTERNET/DATA

SMOKE DETECTOR

SURFACE MOUNTED CEILING FIXTURE (OSCI)

RECESSED CEILING FIXTURE

RECESSED CEILING FIXTURE - RATED FOR WET LOCATION

RECESSED WALL WASH FIXTURE

WALL MOUNTED FIXTURE

EXTERIOR WALL MOUNTED FIXTURE

WALL SCONCE

FLOODLIGHT

BATHROOM EXHAUST FAN

CEILING FAN (OSCI)

UNDER CABINET/OVER DOOR LED STRIP LIGHT

GENERAL ELECTRICAL NOTES:

ELECTRICAL LAYOUT TO MEET REQUIREMENTS OF THE CURRENT NATIONAL ELECTRICAL CODE.

SMOKE DETECTORS ARE TO BE HARDWIRED TOGETHER SO THAT ACTIVATION OF ONE DETECTOR ACTIVATES ALL. PROVIDE BATTERY BACK-UPS.

3. INSTALL CARBON MINOXIDE DETECTOR ON EACH FLOOR

4. WIRE ENTIRE HOUSE FOR INTERNET SERVICE

SAUL REVISIONS

▲RCHITECTS



PROFESSIONAL CERTIFICATION: I, ERIC SAUL, HEREBY CERTIFY THAT THESE DOCUMENTS WERE PREPARED OR APPROVED BY ME, AND THAT I AM A DULY LICENSED ARCHITECT UNDER THE LAWS OF THE STATE OF MARYLAND. LICENSE NO. 14248, EXPIRATION DATE 6/30/2025

PROJE	CT NUMBER: 2400
ı	PRINTING LOG
DATE	PURPOSE
03.06.24	PERMIT SET

ELECTRICAL PLANS

MUNICIPAL STAMPS

1'-0" BEAM


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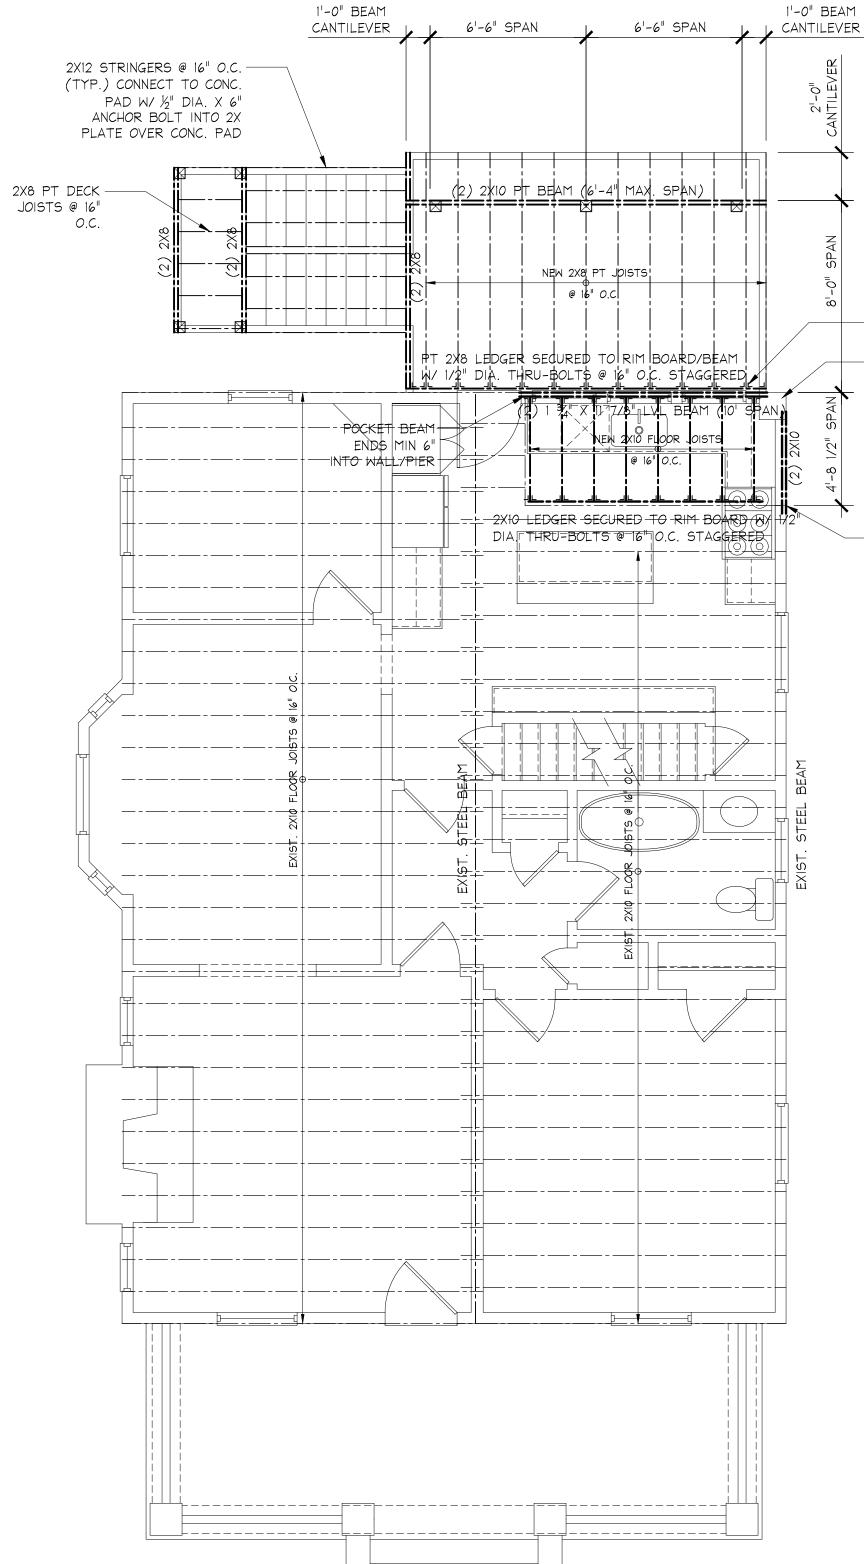
MASONRY


WALL/PIER (TYP.)

APPROVED Montgomery County **Historic Preservation Commission**



SECOND FLOOR FRAMING PLAN

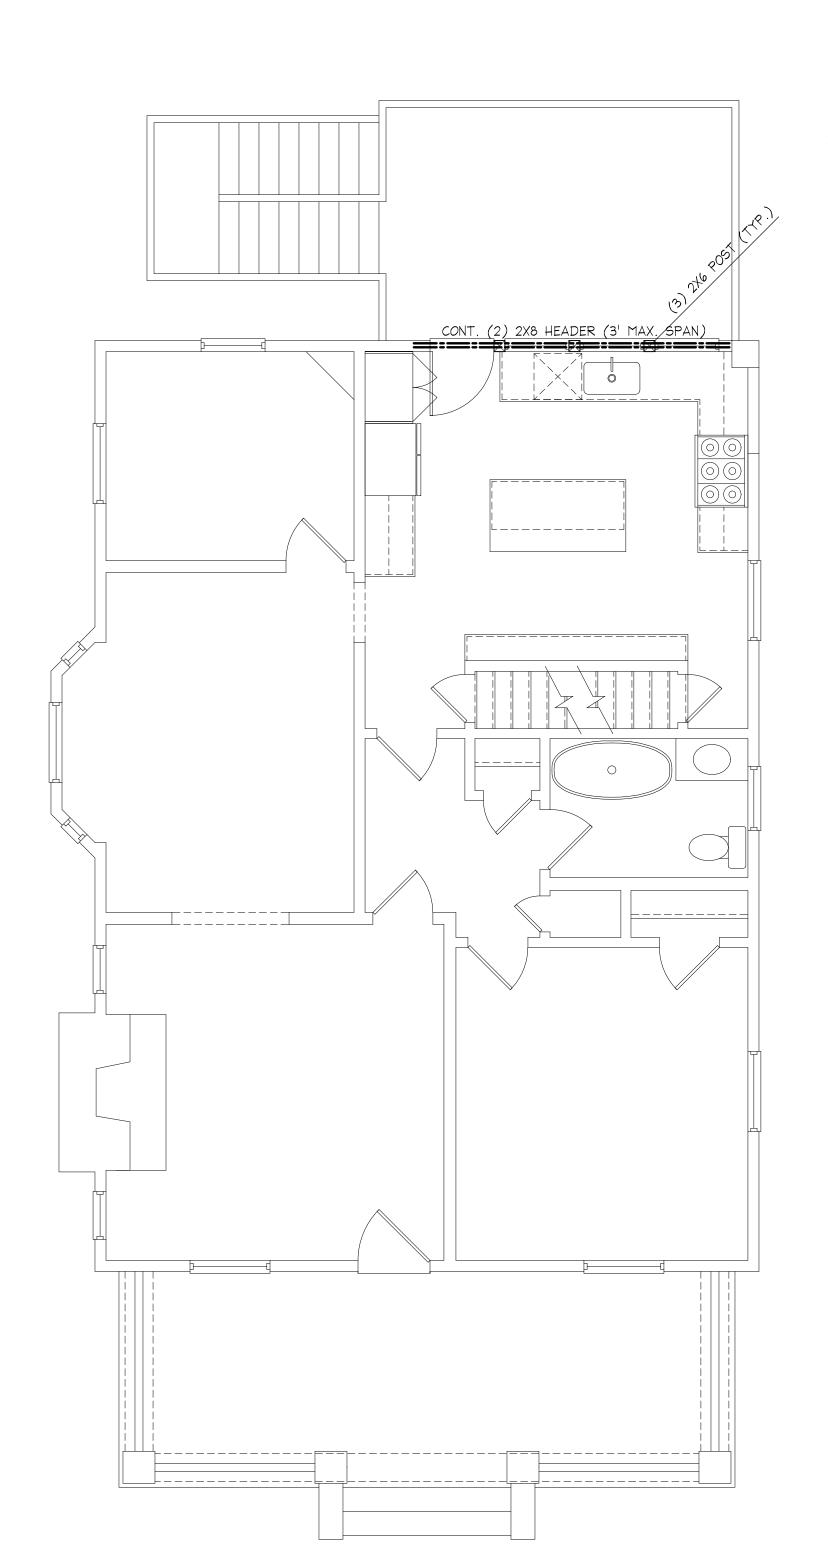

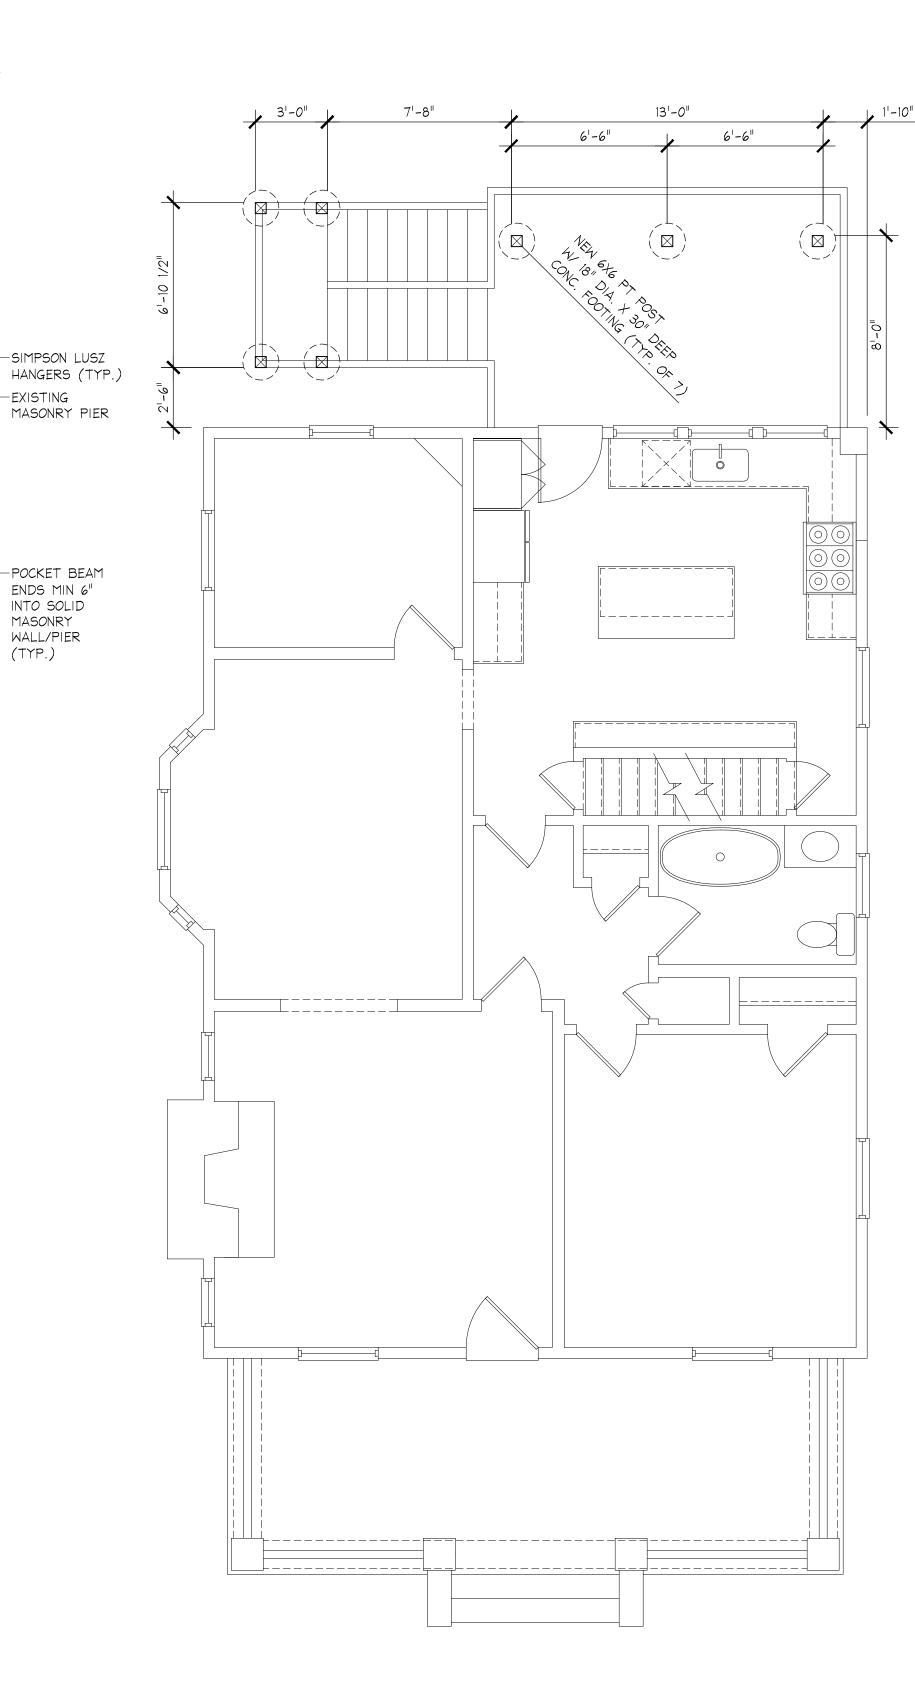

FIRST FLOOR FRAMING PLAN

FOUNDATION PLAN

STRUCTURAL NOTES:

- 1. USE MONTGOMERY COUNTY, MD. BUILDING CODE
- 2. LOADS- LIVE -FLOOR RESIDENTIAL 40PSF; ROOF -30 PSF - SNOW; WIND 115 MPH EXPOSURE B IMPORTANCE 1
- 3. FOUNDATIONS ARE DESIGNED FOR 2000 PSF SOIL. FOOTING BOTTOMS SHALL BE AT LEAST 30" BELOW GRADE AND A MINIMUM OF 12" INTO EXISTING NATURAL SOIL. EXISTING FOUNDATIONS ARE ADEQUATE FOR NEW LOADS
- 4. CONCRETE 3000 PSI @ 28 DAYS MINIMUM. REINFORCING STEEL ASTM A615 GRADE 60. USE ACI STANDARDS, CONC. FOUNDATION WALL REINFORCEMENT: #4 BARS @ 24" O.C. HORIZ. AND VERTICAL - EMBED 8" INTO FOOTING.
- 5. FRAMING LUMBER SHALL BE STRUCTURAL GRADE, DOUGLAS FIR #2 OR STRONGER. Fb = 1200 PSI MINIMUM, USE HURRICANE CLIPS FOR ALL ROOF RAFTERS. USE MANUFACTURERS STANDARDS FOR MANUFACTURED LUMBER. LVL'S Fb=2650PSI, e=1.9M
- 6. BRACED WALL PANELS (BWP): 1/2" PLYWOOD PANELS 48" WIDE BY FULL STORY HEIGHT OR AS DIMENSIONED. 8d NAILS @ 6" O.C. ON EDGES AND 12" O.C. ON INTERMEDIATE STUDS, WIND LOADS ARE ACCOMMODATED BY CONTINUOUS SHEATHING METHOD AND SECTION R301.1.1.
- 7. CONC. BLOCK REINFORCEMENT: USE 9 GAGE TRUSS-TYPE HORIZONTAL REINFORCEMENT EVERY OTHER COURSE (DUR-O-WALL OR EQUAL). VERTICAL REINFORCEMENT: #5 BARS @ 32" O.C. - NEEDED ONLY WHERE DIRT IS RETAINED ABOVE 36" HIGH. ALL CONC. BLOCK CELLS TO BE GROUT SOLID.
- 8. STRUCTURAL STEEL SHALL BE ASTM A-36. USE AISC STANDARDS
- 9. CONTRACTOR SHALL VERIFY ALL DIMENSIONS IN THE

ALL NEW EXTERIOR OPENINGS TO HAVE DOUBLE (3) 2X8 HEADERS, U.N.O. POSTS UNDER HEADERS TO BE ONE

KING AND ONE JACK STUD, U.N.O. NEW DOUBLE WINDOWS TO HAVE TWO JACK STUDS BETWEEN.

EXISTING EXTERIOR OPENINGS TO HAVE A MINIMUM (3) 2X6 UP TO 36" WIDE, (3) 2X8 UP TO 48" WIDE AND (3) 2X10 UP TO 60" WIDE.


NOTE: USE CONTINUOUS WALL BRACING METHOD (#3) PER IRC: R602.10.4

CS-WSP = 1/2" WOOD STRUCTURAL PANEL (SEE STRUCTURAL NOTE #6 FOR CONNECTION CRITERIA)

RCHITEC SAUL

REVISIONS

SIDEN

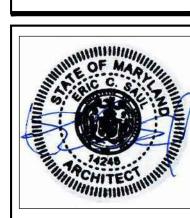

PROFESSIONAL CERTIFICATION: I, ERIC SAUL, HEREBY CERTIFY THAT THESE DOCUMENTS WERE PREPARED OR APPROVED BY ME AND THAT I AM A DULY LICENSED ARCHITECT UNDER TH LAWS OF THE STATE OF MARYLAND. LICENSE NO. 14248, EXPIRATION DATE 6/30/2025

PROJECT NUMBER: 24002 PRINTING LOG 03.06.24 | PERMIT SET

STRUCTURAL PLANS

REVIEWED

By Chris Berger at 3:42 pm, Mar 18, 2024

GRILLE OPTIONS

With Andersen, you'll find grille patterns, widths and configurations to fit a or the taste of any homeowner. If you're replacing windows and doors, w any existing grille. We'll even work with you and your customers to creat

APPROVED

Montgomery County

Historic Preservation Commission





























Double-Hung

Our 2 V4-inch-wide grille can make a casement window look like a double-hung. Light* Fractional

Equal Light*

Custom Patterns

Contact your Andersen supplier for your custom needs.

To see all of the standard patterns available for a specific window or door, refer to the detailed sections in this book for each product or contact your Andersen supplier.

GRILLE CONFIGURATIONS

Full Divided Light

For an authentic look, full divided light grilles are permanently applied to the interior and exterior of the window with a spacer between the glass.





Simulated Divided Light

Simulated divided light off permanent grilles on the exterior and interior with no spacer between the glass. We also offer permane exterior grilles with rem interior grilles in natura wood or prefinished wh





Convenient Cleaning Options

Removable interior grilles come off for easy cleaning. Andersen® Finelight® grilles are installed between the glass panes and feature a contoured 1° or 34" profile.







Removable Interior Grille

Finelight* Grilles-Between-the-Glass

Grille Widths (actual size shown)

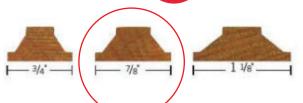

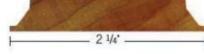

*Specify number of same-size rectangles across or down. 11







































