

#### HISTORIC PRESERVATION COMMISSION

Marc Elrich
County Executive

Robert K. Sutton
Chairman

Date: August 15, 2024

# **MEMORANDUM**

TO:

Rabbiah Sabbakhan, Director

Department of Permitting Services

FROM:

Laura DiPasquale

**Historic Preservation Section** 

Maryland-National Capital Park & Planning Commission

SUBJECT:

Historic Area Work Permit # 1067618 - Construction of accessory structure

The Montgomery County Historic Preservation Commission (HPC) has reviewed the attached application for a Historic Area Work Permit (HAWP). This application was <u>approved</u> at the August 14, 2024 HPC meeting.

The HPC staff has reviewed and stamped the attached construction drawings.

THE BUILDING PERMIT FOR THIS PROJECT SHALL BE ISSUED CONDITIONAL UPON ADHERENCE TO THE ABOVE APPROVED HAWP CONDITIONS AND MAY REQUIRE APPROVAL BY DPS OR ANOTHER LOCAL OFFICE BEFORE WORK CAN BEGIN.

Applicant:

Janice Johnson

Address:

23717 Woodfield Rd, Gaithersburg

This HAWP approval is subject to the general condition that the applicant will obtain all other applicable Montgomery County or local government agency permits. After the issuance of these permits, the applicant must contact this Historic Preservation Office if any changes to the approved plan are made. Once work is complete the applicant will contact Laura DiPasquale at 301-495-2167 or laura.dipasquale@montgomeryplanning.org to schedule a follow-up site visit.





# **APPLICATION FOR** HISTORIC AREA WORK PERMIT HISTORIC PRESERVATION COMMISSION 301.563.3400

HAWP#\_ DATE ASSIGNED\_\_\_\_

FOR STAFF ONLY:

# **APPLICANT:**

Name:	E-mail:
Address:	City: Zip:
Daytime Phone:	Tax Account No.:
AGENT/CONTACT (if applicable):	
Name:	E-mail:
Address:	City: Zip:
Daytime Phone:	Contractor Registration No.:
LOCATION OF BUILDING/PREMISE: MIHP # of	Historic Property
map of the easement, and documentation from Are other Planning and/or Hearing Examiner Ap (Conditional Use, Variance, Record Plat, etc.?) If supplemental information.	No/Individual Site Name vironmental Easement on the Property? If YES, include a the Easement Holder supporting this application.  provals / Reviews Required as part of this Application? YES, include information on these reviews as  t:
	est Cross Street:
TYPE OF WORK PROPOSED: See the checklist for proposed work are submitted with this a be accepted for review. Check all that apply:  New Construction Deck/Porce Addition Fence	ivision: Parcel: st on Page 4 to verify that all supporting items application. Incomplete Applications will not Shed/Garage/Accessory Structure
and accurate and that the construction will con	te the foregoing application, that the application is correct inply with plans reviewed and approved by all necessary this to be a condition for the issuance of this permit.

# HAWP APPLICATION: MAILING ADDRESSES FOR NOTIFING [Owner, Owner's Agent, Adjacent and Confronting Property Owners] Owner's mailing address Owner's Agent's mailing address Adjacent and confronting Property Owners mailing addresses


Description of Property: Please describe the building and surrounding environment. Inclandscape features, or other significant features of the property:	clude information on significant structures,
Description of Work Proposed: Please give an overview of the work to be undertaken:	
REVIEWED  By Laura DiPasquale at 11:53 am, Aug 15, 2024	APPROVED  Montgomery County  Historic Preservation Commission


Work Item 1:	
Description of Current Condition:	Proposed Work:
<b>REVIEWED</b> By Laura DiPasquale at 11:53 am, Aug 15, 202	APPROVED  Montgomery County  Historic Preservation Commission  AMALA AMA
Work Item 2:	
Work Item 3:	
Description of Current Condition:	Proposed Work:

SITE PLAN 23717 Woodfield Road Gaithersburg, MD 20882

Parcel ID: 12-0093330

Lot area: 0.5 Acres Paper Size: 11"x17"

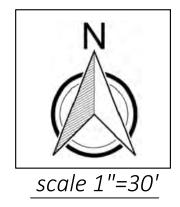

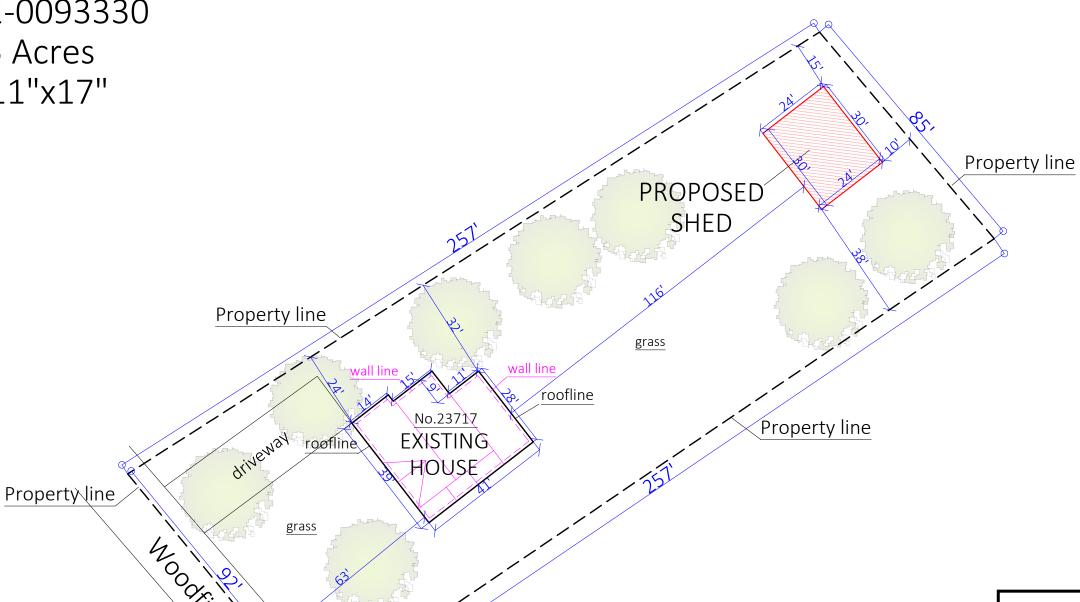


# REVIEWED

By Laura DiPasquale at 11:53 am, Aug 15, 2024

APPROVED

**Montgomery County** 

**Historic Preservation Commission** 

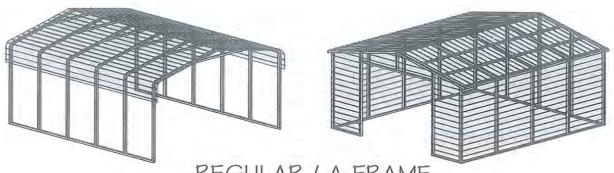

# REGULAR / A-FRAME 24'-0" WIDE

# CARPORT STYLE BUILDINGS

#### **DESIGN NOTES**

- 1. ALL CONSTRUCTION SHALL BE PROVIDED IN ACCORDANCE WITH IBC 2018, OSHA, AISC 360, AISI 100, ASCE 7-16, AWS D1.3 CODES AND ALL APPLICABLE LOCAL REQUIREMENTS.
- 2. ALL MATERIALS IDENTIFIED BY MANUFACTURER NAME MAY BE 1. SUBSTITUTED WITH MATERIAL EQUAL OR EXCEEDING ORIGINAL. 2
- 3. ALL SHOP CONNECTIONS SHALL BE WELDED CONNECTIONS.
- 4. ALL STRUCTURAL FIELD CONNECTIONS SHALL BE #12-14 X 3/4" SDS (ESR-2196 OR EQ) WITHOUT WASHERS.
- 5. STEEL SHEATHING SHALL BE 29GA, CORRUGATED GALV, OR PAINTED STEEL - MAIN RIB HT. 3/4" (FY=80KSI) OR EQ. CONNECTIONS SHALL BE #12-14 X 3/4" SDS (ESR-2196 OR EQ) WITH NEOPRENE WASHERS.
- 6. ALL STRUCTURAL LIGHT GAUGE TUBING AND CHANNELS SHALL BE GRADE 50 STEEL (FY = 50 KSI, FU = 65 KSI).
- 7. STRUCTURAL TUBE 2 1/2" X 2 1/2" 14GA, IS EQUIVALENT TO TS 2 1/4" X 2 1/4" - 12GA AND EITHER ONE MAY BE USED IN LIEU OF THE
- 8. GYPSUM BOARD OR DRYWALL FINISH OR ANY BRITTLE BASE MATERIAL IS NOT CONSIDERED OR ACCOUNTED FOR ON THE DESIGN CRITERIA.
- 9. ALL DESIGN CRITERIA MUST BE INCREASED TO THE NEXT HIGHER INCREMENT BASED ON THE TABLES ON PAGE 4. NO INTERPOLATION IS ALLOWED.

CUSTOMER INFORMATION

## DESIGN CRITERIA

PREVAILING CODE: USE GROUP: RISK CATEGORY:

MBPS (IBC 2018) U (CARPORTS, BARNS)

- DEAD LOAD (D) ROOF LIVE/SNOW LOAD (Lr)
  - Lr = 20 61 PSF (AS PER SNOW LOAD SEE TABLE 4)
- SNOW LOAD (S) GROUND SNOW LOAD Pg = 20 - 90 PSF IMPORTANCE FACTOR Is = 0.8 THERMAL FACTOR Ct = 1.2EXPOSURE FACTOR Ce = 1.0 ROOF SLOPE FACTOR Cs = 1.0
- WIND LOAD (W) BASIC WIND SPEED VIIIT = 105 - 180 MPH EXPOSURE
- SEISMIC LOAD (E) DESIGN CATEGORY IMPORTANCE FACTOR 1e = 1.00

#### LOAD COMBINATIONS: D+(LrORS)

- 2. D + (0.6W OR ±0.7E)
- 3. D + 0.75 (0.6W OR ±0.7E) + 0.75 (Lr OR S)
- 0.6D + (0.6W OR ±0.7E)

# DRAWING INDEX

COVER SHEET

SCHEDULES & MEMBER -SECTIONS FRAME SECTIONS & DETAILS -3-A, 3-B SPACING SCHEDULES -& ENCLOSURE NOTES PURLIN & GIRT SCHEDULES SHEATHING OPTIONS SIDE WALL FRAMING & OPENINGS 7-A. 7-B END WALL FRAMING & OPENINGS 8-A. 8-B CORNER BRACING DETAILS OPTIONAL LEAN-TO ADDITION FOUNDATION OPTIONS ----- 11-A TO 11-D

> APPROVED Montgomery County Historic Preservation Commission

# **REVIEWED**

BUILDING INFORMATION

By Laura DiPasquale at 11:53 am, Aug 15, 2024

CERTIFICATION VALIDITY NOTICE



457 N. Broadway, Joshua, TX 76058 1-866-730-9865

ENGINEERED BY:



#### A&A ENGINEERING CIVIL · STRUCTURAL

6036 Renaissance Place, Toledo, OH 43623 Tel. 419-292-1983 • Fax. 419-292-0955 www.aa-engineers.com

#### DRAWING INFORMATION

PROJECT: 24'-0" WIDE BUILDINGS

LOCATION: STATE OF MARYLAND

PROJECT NO.: 033-22-0243 SHEET TITLE:

# COVER SHEET

1/11 SHEET NO .:

DRAWN BY: A.W.

DATE: 2/9/22

CHECKED BY: OAA

DATE: 2/9/22

#### LEGAL INFORMATION

- ANY DUPUCATION OF THIS DRAWING IN WHOLE OR PART IS STRICTLY FORBIDDEN, ANYONE DOING SO WILL BE PROSECUTED UNDER THE FULL EXTENT OF THE LAW. DRAWINGS VALID UP TO DATE OF EXPIRATION.



STAMP EXPIRY: 07-23-2024 DATE SIGNED: 07-30-2022

OWNER: ADDRESS: GROUND SNOW:

BASIC WIND SPEED:

ROOF LIVE LOAD:

**DESIGN LOADS** 

WIDTH: LENGTH:

HEIGHT:

☐ REGULAR TI FULL **ENCLOSURE** TYPE:

FRAME TYPE:

☐ PARTIAL ☐ OPEN

A-FRAME

#### TABLE 21: MEMBER PROPERTIES

NO.	LABEL	PROPERTY	DETAIL NO
1	COLUMN POST	2.5" X 2.5" X 14GA TUBE	1
2	ROOF BEAM	2.5" X 2.5" X 14GA TUBE	t t
3	BASE RAIL	2.5" X 2.5" X 14GA TUBE	1
4	PEAK BRACE	2.5" X 2.5" 14GA CHANNEL	4
5	KNEE BRACES	2.5" X 1.5" 14GA CHANNEL	4
6	CONNECTOR SLEEVE	2.25" X 2.25" X 12GA TUBE	2
7	BASE ANGLE	2" X 2" X 3" LG. 3/16" ANGLE	10
8	PURLIN	4.25" X 1,5" X 14GA / 18GA HAT CHANNEL	5
9	GIRT	4.25" X 1.5" X 14GA / 18GA HAT CHANNEL	5
9A	OPT. END WALL GIRT	2.5" X 1.5" 14GA CHANNEL	1
10	SHEATHING	29 GA CORRUGATED SHEET	8
11	END WALL POST	2.5" X 2.5" X 14GA TUBE	1
12	DOOR POST	2.5" X 2.5" X 14GA TUBE	1
13	SINGLE HEADER	2.5" X 2.5" X 14GA TUBE	1
14	DOUBLE HEADER	DBL. 2.5" X 2.5" X 14GA TUBE	1
15	SERVICE DOOR / WINDOW FRAMING	2.5" X 2.5" X 14GA TUBE	1
16	ANGLE BRACKET	2" X 2" X 2" LG. 14GA ANGLE	7
17	STRAIGHT BRACKET	2" X 2" X 4" LG. 14GA PLATE	6
18	PB SUPPORT	2.5" X 2.5" X 14GA TUBE	1
19	DIAGONAL BRACE	2" X 2" X 14 GA TUBE	3
20	GABLE BRACE	2" X 2" X 14 GA TUBE	3
21	DB BRACKET	2.25" X 2.25" X 6" LG. 14GA ANGLE	9
22	TRUSS SPACER	2.5" X 2.5" X 14GA TUBE	1
23	ALL FASTENERS	#12 X 1" SELF-DRILL SCREWS (ESR-2196 OR EQ) W/ NEOPRENE/STEEL WASHER	

#### TABLE 2.2: SHEATHING FASTENER SCHEDULE

LOCATION	CORNER PANELS	SIDE LAPS	EDGE LAPS	ELSEWHERE
SPACING	9" C/C	MIN. 1	4½" C/C	9" C/C


FASTENER TYPE: #12X1" SELF-DRILL SCREWS (ESR-2196 OR EQ) W/

NEOPRENE/STEEL WASHER

"SEE TYP. SHEATHING FASTENER SCHEDULE DIAGRAM ON PAGE 6.



THICKNESS = 14GA

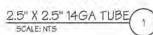



THICKNESS = 12GA

2.25" X 2.25" 12GA TUBE,



THICKNESS = 14GA

2" X 2" 14GA TUBE, SCALE: NTS



THICKNESS = 14GA

2.5" X 1.5" 14GA CHANNEL SCALE: NTS



ENGINEERED BY:

MANUFACTURED BY:




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RAWING INFORMATION

PROJECT: 24'-O" WIDE BUILDINGS



THICKNESS = 14GA / 18GA

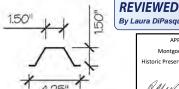SCALE: NTS

4.25" X 1.5" X 14GA / 18GA HAT CHANNEL



LOCATION: STATE OF MARYLAND AMMEL/MMI

PROJECT NO.: 033-22-0243 SHEET TITLE:

> SCHEDULES & MEMBER SECTIONS


2/11 SHEET NO .:

DATE: 2/9/22 DRAWN BY: A.W.

CHECKED BY: OAA DATE: 2/9/22

#### LEGAL INFORMATION


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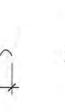


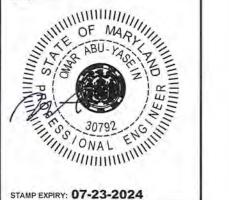STAMP EXPIRY: 07-23-2024 DATE SIGNED: 07-30-2022

THICKNESS = 14GA


ANGLE BRACKET SCALE: NTS



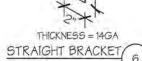


THICKNESS = 14GA

DB BRACKET SCALE: NTS

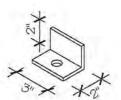


THICKNESS = 3/16"


BASE ANGLE SCALE: NTS

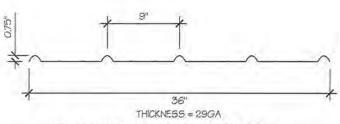



29 GA CORRUGATED SHEATHING


SCALE: NTS

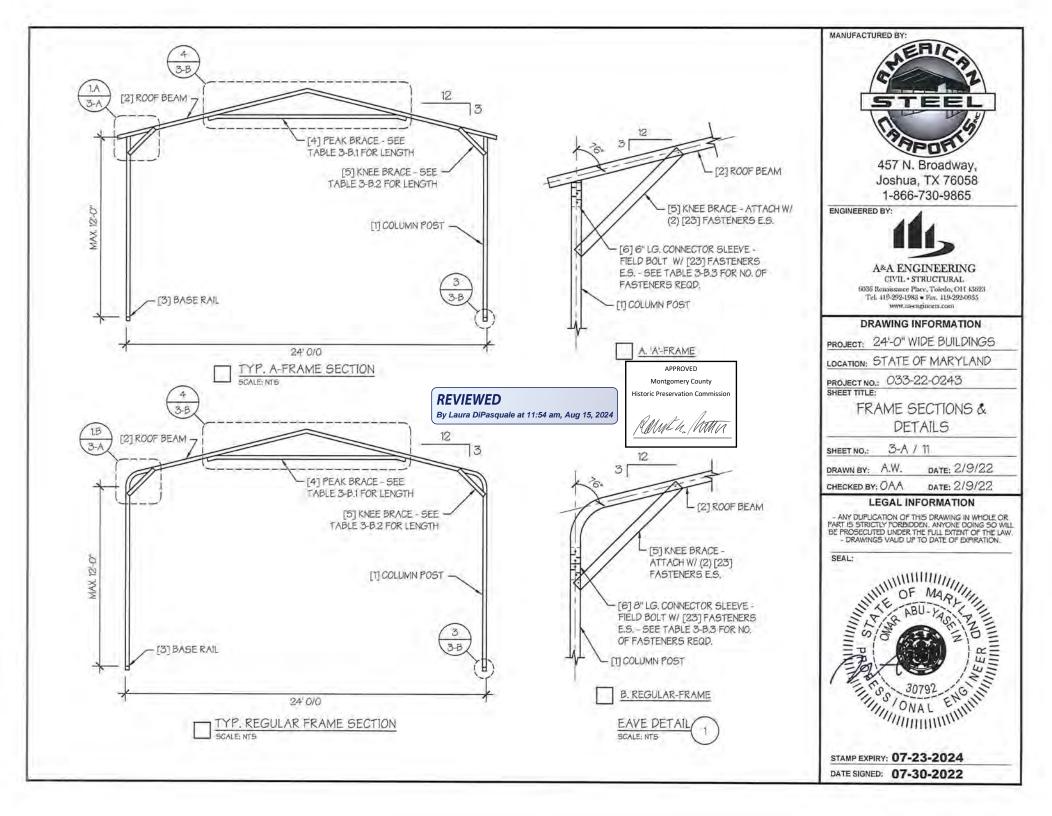

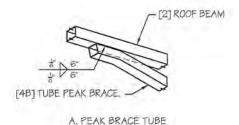

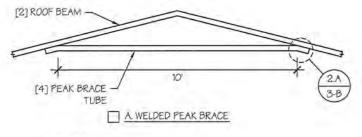

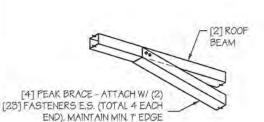

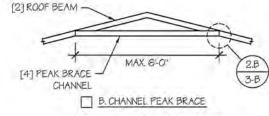

PEAK BRACE DETAILS SCALE: NTS

B. PEAK BRACE CHANNEL

DISTANCE AND SPACING

By Laura DiPasquale at 11:54 am, Aug 15, 2024

REVIEWED

APPROVED Montgomery County Historic Preservation Commission

PEAK BRACE CONNECTION DETAILS SCALE: NTS

> [6] 6" LG. CONNECTOR SLEEVE. FIELD BOLT W/ [23] FASTENERS - SEE TABLE 3-B.3 FOR NO. OF FASTENERS REQD.

[3] BASE RAIL

117 COLUMN POST

BASE DETAIL SCALE: NTS

TABLE 3-B.1: PEAK BRACE SCHEDULE

GROUND SNOW / ROOF	WIND SPEED					
LIVE LOAD (PSF)	□105 TO 130	□140 TO 180				
□ 30 / 20	6'	10'				
□ 35 / 25 TO 90 / 61	10'	10'				

TABLE 3-B.2: KNEE BRACE SCHEDULE

EAVE HEIGHT	KNEE BRACE LENGTH
DUPTO8'	24"
□ 9' TO 12'	36"

TABLE 3-B.3 FASTENER SCHEDULE

WIND SPEED (MPH)	NO. OF FASTENERS
□ 105 TO 125	4
□ 130 TO 155	6
□160 TO 180	8

NOTE: COLUMN POST MAY BE ADJUSTED ±1" FOR LEVELING. MANUFACTURER IS NOT RESPONSIBLE FOR LEVELING OF GROUND AND/OR CONCRETE SURFACE PROVIDED BY OTHERS.



457 N. Broadway. Joshua, TX 76058 1-866-730-9865

ENGINEERED BY:



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6036 Renaissance Place, Toledo, O11 43623 Tel. 419-292-1983 • Fax. 419-292-0955 www.aa-engineers.com

#### DRAWING INFORMATION

PROJECT: 24'-O" WIDE BUILDINGS

LOCATION: STATE OF MARYLAND

PROJECT NO.: 033-22-0243

SHEET TITLE:

FRAME DETAILS

3-B / 11 SHEET NO .:

DATE: 2/9/22 DRAWN BY: A.W.

CHECKED BY: OAA DATE: 2/9/22

#### LEGAL INFORMATION

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STAMP EXPIRY: 07-23-2024

TABLE 4: FRAME	SPACING CHART	/ SCHEDULE

	ROUND			■ ENCLO	SED BUIL	DINGS					■ OPE	N BUILDII	NG5		
SNOW / ROOF LIVE		WIND SPEED (MPH)						WIND SPEED (MPH)							
LOAI	D (PSF)	□105	□ 115	□130	□140	□155	□165	□180	□105	□ 115	□130	□140	□155	□165	□180
	30/20	60	60	54/60	54	42	42	36	48	48	48	42	36	30	24
,o-,2! 0L,	40/27	48/60	48/60	42/60	42/54	42	42	36	42	42	42	42	36	30	24
<u>2</u> □5	50/34	40/48	40/48	40/48	40/48	40/42	40/42	36	30	30	30	30	30	30	24
2 0	60 / 41	36	36	36	36	36	36	36	30	30	30	30	30	30	24
ō □7	70/47	30	30	30	30	30	30	30	24	24	24	24	24	24	REV
o □7	30/54	24	24	24	24	24	24	24	24	24	18	18	18	18	By Lau
	90 / 61		1885	-144	2004	200	10000	4000			***		***		
	30/20	60	60	54/60	54	48	42/48	42	54	54	48/54	42/54	36/48	36	30
5 04	40/27	48/60	48/60	42/60	42/54	42/48	42/48	42	42	42	42	42	36/42	36	30
0.60L	50/34	40/48	40/48	40/48	40/48	40/48	40/48	40/42	36	36	36	36	36	36	30
2 0	60 / 41	36	36	36	36	36	36	36	30	30	30	30	30	30	30
ō 07	70/47	30	30	30	30	30	30	30	24	24	24	24	24	24	24
φ D7	30/54	24	24	24	24	24	24	24	24	24	24	24	24	24	24
	90 / 61		+++		944	465			1000	359	1.884	888	6.6		le.ee
	30 / 20	60	60	54/60	54	48	42/48	42	60	54/60	48/60	42/54	36/48	36/42	36
<b>3</b> D4	40/27	48/60	48/60	42/60	42/54	42/48	42/48	42	48	48	42/48	42/48	36/48	36/42	36
0 05	50/34	40/48	40/48	40/48	40/48	40/48	40/48	40/42	40/42	40/42	40/42	40/42	36/42	36	36
0 0	60/41	36	36	36	36	36	36	36	36	36	36	36	36	36	30
0-901 AU	70/47	30	30	30	30	30	30	30	30	30	30	30	30	30	30
5 □8	30/54	24	24	24	24	24	24	24	24	24	24	24	24	24	24
	90 / 61		1000			222	1000	-							201

FRAME SPACINGS ARE IN UNITS OF INCHES (IN).

WHERE TWO VALUES ARE SHOWN, THE HIGHER VALUE CAN ONLY BE USED FOR VERTICAL SHEATHING.

SNOW LOADS AND ROOF LIVE LOADS ARE IN POUNDS PER SQUARE FOOT (PSF). WIND SPEED IS 3 SEC. GUST IN MILES PER HOUR (MPH).


4. FOR VALUES THAT LIE BETWEEN TWO CELLS, THE HIGHER (MORE STRINGENT) VALUE HAS TO BE USED. INTERPOLATION BETWEEN CELLS IS NOT ALLOWED.

#### ENCLOSURE CLASSIFICATION:

- ENCLOSED BUILDING = ALL 4 WALLS FULLY ENCLOSED WITH DOORS/WINDOWS = USE ENCLOSED BUILDING SPACING CHART.
- OPEN BUILDING = ALL 4 WALLS FULLY OPEN = USE OPEN BUILDING SPACING CHART.
- SFT PARTIALLY ENCLOSED = BOTH END-WALLS FULLY OPEN, WITH BOTH SIDE-WALLS ONLY 3FT ENCLOSED = USE OPEN BUILDING SPACING CHART.
- PARTIALLY ENCLOSED = BOTH END-WALLS FULLY OPEN, WITH BOTH SIDE-WALLS ENCLOSED MORE THAN 3FT = START WITH OPEN BUILDING SPACING CHART AND THEN REDUCE SPACING BY 6".
- 3 SIDED ENCLOSED = ALL WALLS ARE ENCLOSED EXCEPT FOR 1 END-WALL = START WITH ENCLOSED BUILDING SPACING + THE OPEN END FRAME MUST HAVE EITHER A GABLED END OR HAVE DOUBLED WELDED LEGS & ROOF.
- 6. FOR ALL SHEATHING ENCLOSURES NOT LISTED ABOVE, REFER TO SHEET 5 FOR SPACING. AND DESIGN REQUIREMENTS.

#### GENERAL NOTES:


- THE MAX. BUILDING LENGTH FOR ENCLOSED BUILDINGS IS 50'-0". THIS CAN BE INCREASED BY ADDING A DOUBLE FRAME AT THE CENTER TO BREAK THE LENGTH OF THE BUILDING.
- 2. BUILDINGS WITH PARTIALLY ENCLOSED END WALLS NEED TO HAVE SIDE WALL BRACING TO SUPPORT THE PARTIALLY ENCLOSED END WALL. (SEE FIGURE A ON SHEET 5).
- ALL BUILDINGS WITH AN OPEN END WALL MUST HAVE A 10'-0" TUBE PEAK BRACE.

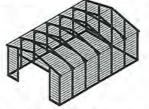



TYP. ENCLOSED BUILDING

TYP. OPEN BUILDING

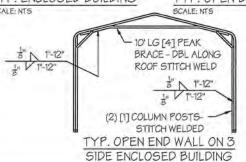

SCALE: NTS

MANUFACTURED BY

457 N. Broadway, Joshua, TX 76058 1-866-730-9865

APPROVED Montgomery County Historic Preservation Commission

DiPasquale at 11:54 am. Aug 15, 2024

RAMEL /NATUR

GINEERED BY:

A&A ENGINEERING CIVIL . STRUCTURAL

6036 Remaissance Place, Toledo, OH 43623 Tel. 419-292-1983 • Fax. 419-292-0955 www.aa-engineers.com

#### DRAWING INFORMATION

PROJECT: 24'-0" WIDE BUILDINGS

LOCATION: STATE OF MARYLAND

PROJECT NO.: 033-22-0243

SHEET TITLE:

SPACING SCHEDULES & ENCLOSURE NOTES

4/11 SHEET NO .:

DATE: 2/9/22 DRAWN BY: A.W.

CHECKED BY: OAA DATE: 2/9/22

#### LEGAL INFORMATION

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- DRAWINGS VALID UP TO DATE OF EXPIRATION.



STAMP EXPIRY: 07-23-2024

#### TABLE 5.1: PURLIN SPACING SCHEDULE

	GROUND SNOW /	0	14GA	. НАТ	CHA	NNEL	PURI	IN
	ROOF LIVE		γ	VIND S	PEED	(MPH	1)	
	LOAD (PSF)	105	115	130	140	155	165	180
75	□ 30 / 20	54	48	42	36	30	24	24
ž	□ 40 / 27	42	42	42	36	30	24	24
××.	□ 50 / 34	40	40	40	36	30	24	24
E 5P 5-0	0 60 / 41	36	36	36	36	30	24	24
FRAME SPACING: ■ 5'-0"	070/47	32	32	32	32	30	24	24
₽ ¥	080/54	30	30	30	30	30	24	24
T.	D 90 / 61	24	24	24	24	24	24	24
/K	D 30 / 20	54	48	42	42	36	30	30
FRAME SPACING: ■ 4'-6"	D 40 / 27	42	42	42	42	36	30	30
<u>۽</u> ج	□ 50 / 34	40	40	40	40	36	30	30
E 5P	D 60 / 41	36	36	36	36	36	30	30
유 _	0 70 / 47	32	32	32	32	32	30	30
ξ-	D 80 / 54	32	32	32	32	32	30	30
正	0 90 / 61	30	30	30	30	30	30	30
	D 30 / 20	54	48	42	42	36	36	30
2	D 40/27	42	42	42	42	36	36	30
AC.	D 50 / 34	40	40	40	40	36	36	30
FRAME SPACING: ■ 4'-0"	D 60/41	36	36	36	36	36	36	30
≜ 4	070/47	32	32	32	32	32	32	30
₹ V	□ 80 / 54	32	32	32	32	32	32	30
IL	0 90 / 61	30	30	30	30	30	30	30
	□30/20	54	48	42	42	36	36	30
ջ	D 40/27	42	42	42	42	36	36	30
AC -	□50/34	40	40	40	40	36	36	30
FRAME SPACING: ■ 5'-6"	D 60/41	36	36	36	36	36	36	30
푸음	070/47	32	32	32	32	32	32	30
\$	□ 80 / 54	32	32	32	32	32	32	30
Œ	D 90 / 61	30	30	30	30	30	30	30
25	□ 30 / 20	54	48	42	42	36	36	30
<u> </u>	D 40/27	42	42	42	42	36	36	30
E SPACINC OR LOWER	□ 50 / 34	40	40	40	40	36	36	30
E SP OR L	D 60/41	36	36	36	36	36	36	30
	□ 70 / 47	32	32	32	32	32	32	30
FRAM 3-0"	□ 80 / 54	32	32	32	32	32	32	30
E -	□ 90 / 61	30	30	30	30	30	30	30

#### TABLE 5.2: GIRT SPACING SCHEDULE

FRAME	TO:	W	IND S	PEEC	(MP	H)	
SPACING	105	115	130	140	155	165	180
D5'-0"	60	48	36	30	24	24	18
D4'-6"	60	60	48	42	36	30	24
<b>4'-0"</b>	60	60	54	54	42	36	30
□3'-6"	60	60	54	54	48	42	42
□2'-0' TO 3'-0"	60	60	54	54	48	42	42


#### NOTES:

- GIRT SPACING UNITS ARE IN INCHES.
- THIS SCHEDULE IS TO BE USED FOR BOTH
- FRAME SPACING NEEDS TO BE DETERMINED FROM TABLE 4.

#### **REVIEWED**

By Laura DiPasquale at 11:54 am, Aug 15, 2024

# APPROVED Montgomery County Historic Preservation Commission

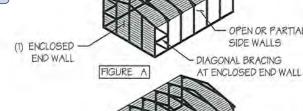



(1) ENCLOSED SIDE WALL

PARTIAL

END WALLS

PARTIAL END WALL DIAGONAL BRACING AT PARTIAL END WALL

OPEN OR PARTIAL

SIDE WALLS

# FIGURE C

PARTIAL END WALL

PARTIALLY ENCLOSED SIDE WALLS FIGURE D

DIAGONAL BRACING AT PARTIAL END WALL

#### IRREGULAR BUILDING NOTES:

PURLIN SPACING UNITS ARE IN INCHES.

NOTES:

- FIGURES A, B, C & D ON THE RIGHT INDICATE EXAMPLES OF IRREGULAR BUILDINGS.
- FOR IRREGULAR BUILDINGS, FRAME SPACING MUST BE REDUCED BY 6" FROM OPEN BUILDING SPACING TABLE. SEE SHEET 4 FOR OPEN BUILDING TABLE.
- SITE SPECIFICS MAY ALLOW FOR ALTERNATIVE SPACING.

FRAME SPACING NEEDS TO BE DETERMINED FROM TABLE 4.

IRREGULAR BUILDING & BUILDINGS W/ MORE THAN 2 SIDE OPENINGS MUST HAVE A 10' TUBE PEAK BRACE ON ALL FRAMES.





457 N. Broadway, Joshua, TX 76058 1-866-730-9865

ENGINEERED BY:



A&A ENGINEERING

CIVIL + STRUCTURAL 6036 Renaissance Place, Toledo, OH 43623 Tel. 419-292-1983 • Fax, 419-292-0955 www.aa-engineers.com

#### DRAWING INFORMATION

PROJECT: 24'-O" WIDE BUILDINGS

LOCATION: STATE OF MARYLAND

PROJECT NO.: 033-22-0243

SHEET TITLE:

PURLIN & GIRT SPACING SCHEDULES

5/11 SHEET NO .:

DATE: 2/9/22 DRAWN BY: A.W.


CHECKED BY: OAA DATE: 2/9/22


#### LEGAL INFORMATION


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457 N. Broadway, Joshua, TX 76058 1-866-730-9865

ENGINEERED BY:

MANUFACTURED BY:

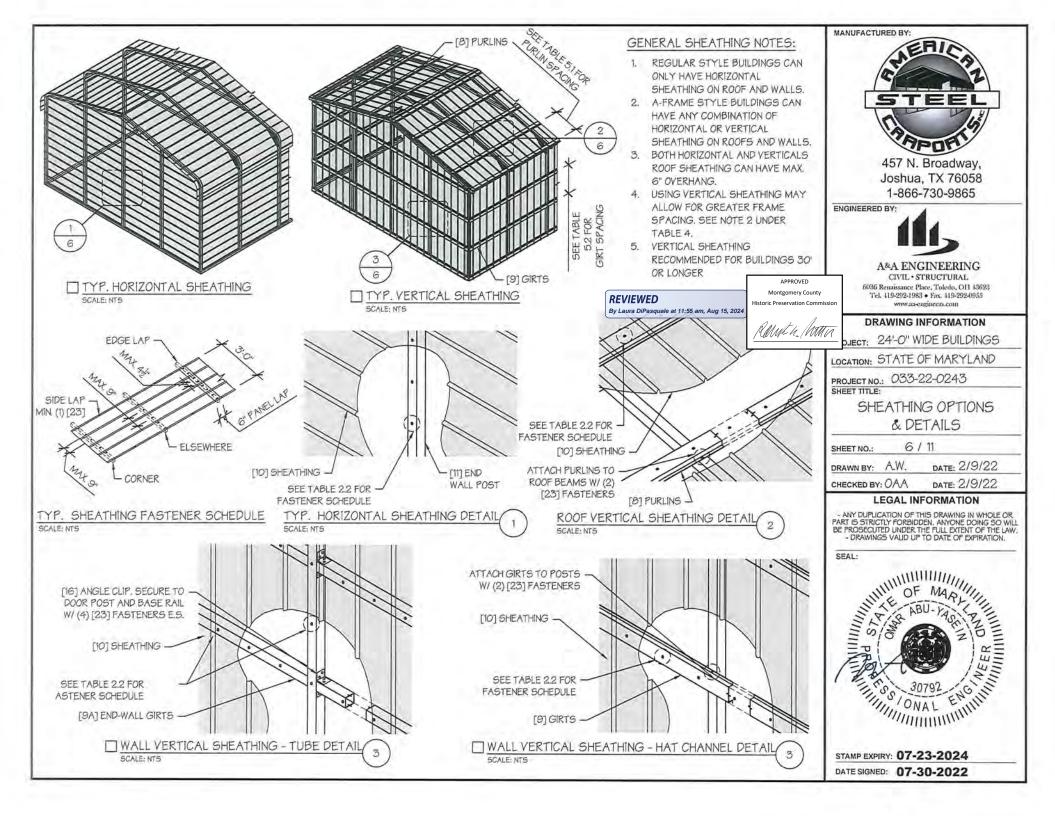By Laura DiPasquale at 11:55 am, Aug 15, 2024
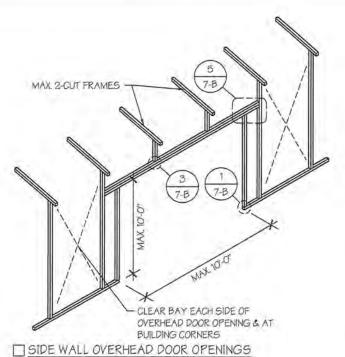
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#### DRAWING INFORMATION

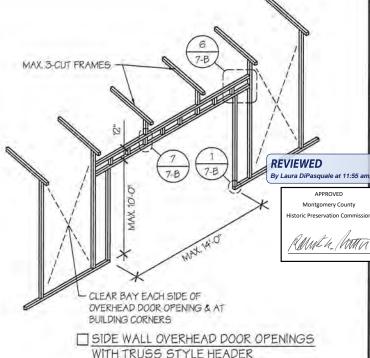PROJECT: 24'-O" WIDE BUILDINGS

LOCATION: STATE OF MARYLAND

PROJECT NO .: 033-22-0243

SHEET TITLE:

SIDE WALL FRAMING & OPENINGS

SHEET NO .: 7-A / 11

A.W. DATE: 2/9/22 DRAWN BY:

CHECKED BY: OAA DATE: 2/9/22

#### LEGAL INFORMATION

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STAMP EXPIRY: 07-23-2024 DATE SIGNED: 07-30-2022

SIDE WALL FRAMING NOTES:


SCALE: NTS


- TRUSS-STYLE HEADERS ARE REQUIRED FOR WHERE THE GROUND SNOW LOAD IS 40 PSF OR GREATER.
- 2. DESIGNS AND DETAILS SHOWN HERE ARE APPLICABLE TO BOTH REGULAR AND A-FRAME STYLE BUILDINGS.
- 3. MAX. HEIGHT OF SIDE WALL OVERHEAD DOOR OPENINGS IS 2 FT LESS THAN THE EAVE HEIGHT.
- 4. OVERHEAD DOOR OPENINGS CANNOT CUT THROUGH MORE THAN 2 FULL FRAMES.
- 5. MIN. I CLEAR BAY MUST BE MAINTAINED BETWEEN ANY 2 OVERHEAD DOOR OPENINGS. A CLEAR BAY IS A SPACE BETWEEN TWO FRAMES THAT HAS NO OVERHEAD DOOR OPENINGS.
- 6. MIN I CLEAR BAY MUST ALSO BE MAINTAINED FROM THE BUILDING CORNERS.
- SERVICE DOORS AND WINDOWS CAN BE PLACED IN CLEAR BAYS OR ANY WHERE ELSE AS NEEDED.


SERVICE DOOR(S) TO BE LOCATED PER CUSTOMER REQUIREMENTS OPENING SIZED TO FIT WINDOW

SCALE: NTS


SIDE WALL SERVICE DOOR / WINDOW OPENINGS SCALE: NTS

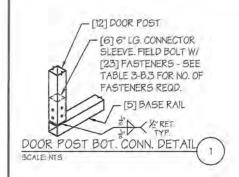


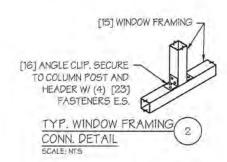

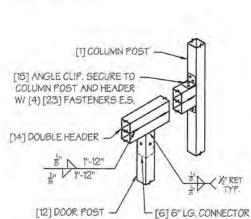


COLUMN POST ABOVE DBL DOOR HEADER CONN. DETAIL SCALE: NTS

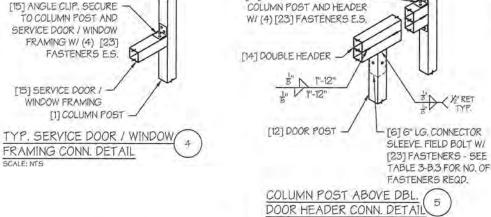


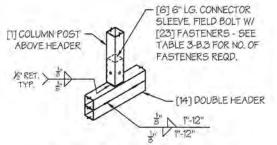

COLUMN POST ABOVE DBL. DOOR HEADER CONN. DETAI SCALE: NTS

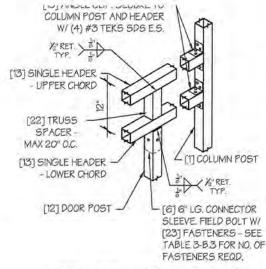

COLUMN POST ABOVE TRUSS DOOR HEADER CONN. DETAIL SCALE: NTS.

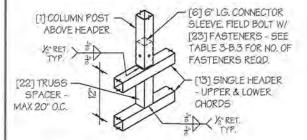

SCALE: NTS

COLUMN POST ABOVE TRUSS DOOR HEADER CONN. DETAIL SCALE: NTS

# **REVIEWED**

By Laura DiPasquale at 11:55 am, Aug 15, 2024

**APPROVED** Montgomery County Historic Preservation Commission

COME 4. MAIN



457 N. Broadway Joshua, TX 76058 1-866-730-9865

ENGINEERED BY:



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#### DRAWING INFORMATION

PROJECT: 24'-O" WIDE BUILDINGS

LOCATION: STATE OF MARYLAND

PROJECT NO.: 033-22-0243

SHEET TITLE:

SIDE WALL FRAMING DETAILS

7-B / 11 SHEET NO.:

DRAWN BY: A.W. DATE: 2/9/22


CHECKED BY: OAA DATE: 2/9/22

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STAMP EXPIRY: 07-23-2024 DATE SIGNED: 07-30-2022



# END WALL FRAMING NOTES:

- MIN. 12" CLEARANCE MUST BE MAINTAINED BETWEEN ANY TWO OPENINGS (OVERHEAD DOOR OR SERVICE DOOR) AND FROM CORNERS.
- SERVICE DOORS AND WINDOWS CAN BE PLACED AS NEEDED.
- 4. DIAGONAL BRACES NEED TO BE ADDED FOR PARTIAL END WALL ENCLOSURES. SEE SHEET 9 FOR DIAGONAL BRACE CONNECTION DETAILS.

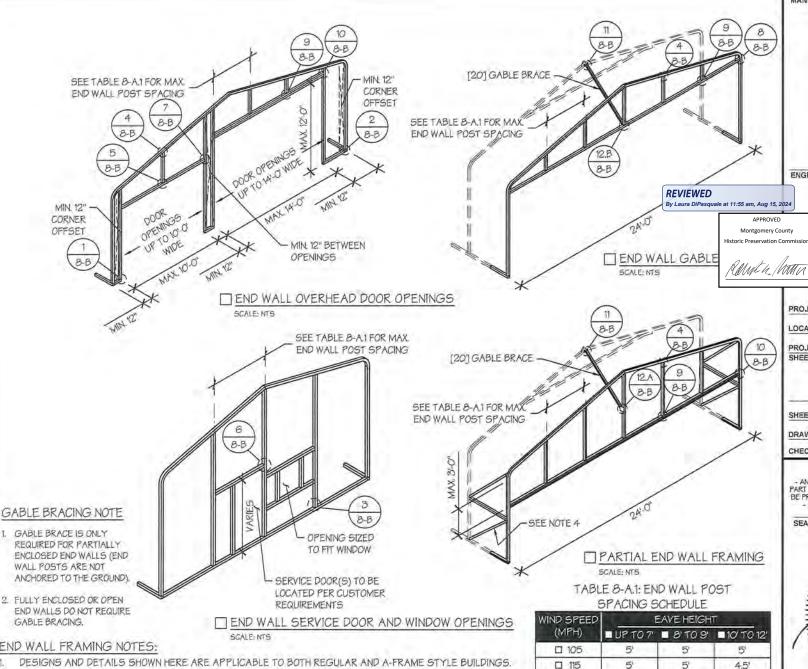WIND SPEED	EAVE HEIGHT		Γ
(MPH)	UP TO 7	■ 8'T0 9'	■10' TO 12
□ 105	5'	5	5'
□ 115	5'	5'	4.5'
□ 13 <i>0</i>	4.5'	4,5'	4
□ 140	4.5'	4,5'	3'
□ 155	4'	4'	2.5
□ 165-180	3.5	3'	2'



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#### DRAWING INFORMATION

PROJECT: 24'-0" WIDE BUILDINGS

LOCATION: STATE OF MARYLAND

PROJECT NO.: 033-22-0243

SHEET TITLE:

END WALL FRAMING

8-A / 11 SHEET NO .:

DRAWN BY: A.W. DATE: 2/9/22


CHECKED BY: OAA DATE: 2/9/22

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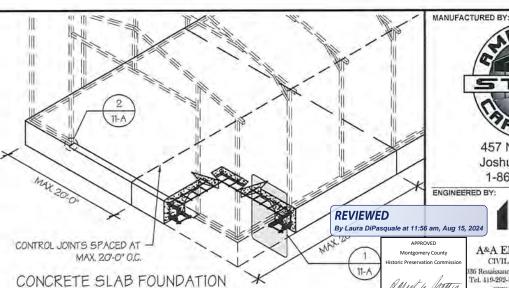


STAMP EXPIRY: 07-23-2024



#### CONCRETE SLAB FOUNDATION NOTES:

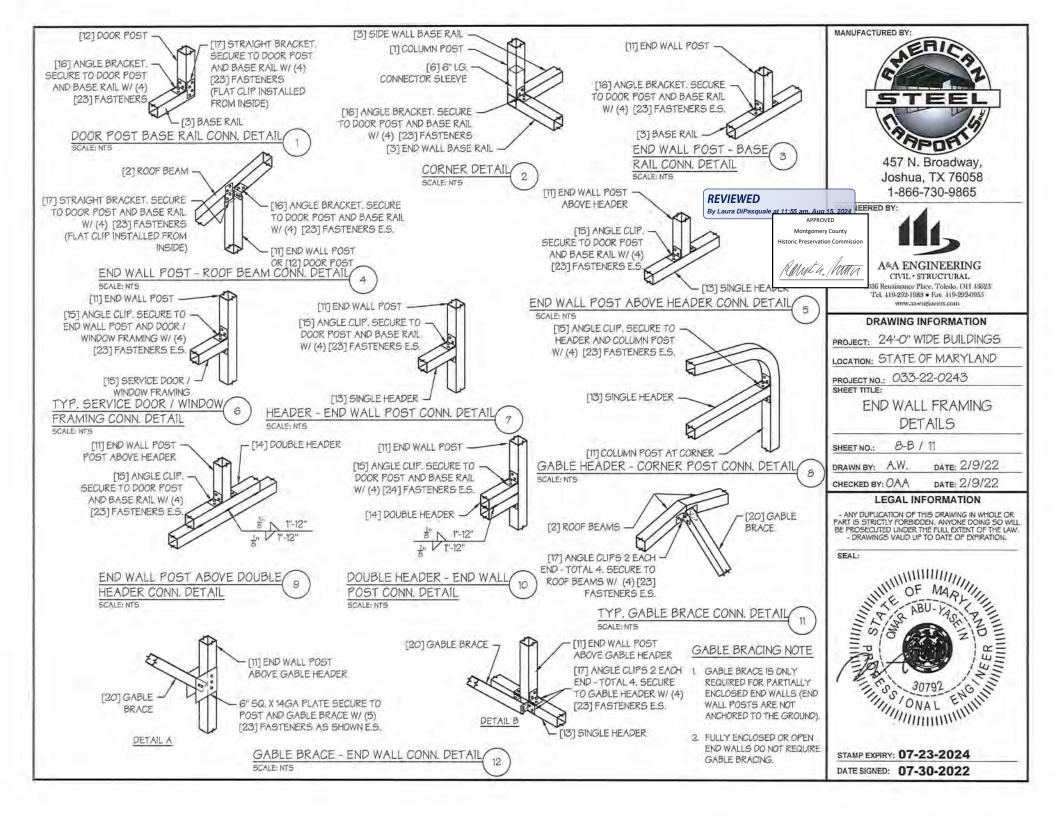- 1. DESIGNS SHOWN ON THIS SHEET ARE FOR CONCRETE SLAB FOUNDATION. ANY OF THE FOUNDATIONS SHOWN ON SHEETS 11-A THRU C CAN BE USED.
- 2. CONCRETE ANCHORS SHALL BE LOCATED NEXT TO EVERY POST AND ON EITHER SIDE OF OPENINGS, TWO ANCHORS SHALL BE INSTALLED AT CORNERS OF ENCLOSED BUILDINGS WITH END WALLS - ONE ON EACH BASE RAIL. IN LOCATIONS REQUIRING TWO ANCHORS DUE TO WIND, ONE ANCHOR IS TO BE ON EACH SIDE OF THE COLUMN POST.
- 3. ANCHORS IN CLOSE PROXIMITY TO EACH OTHER MUST HAVE A MIN. 4" SPACING.
- 4. MIN. NUMBER OF CONCRETE ANCHORS PER POST SHALL BE AS SHOWN IN TABLE 11-A.2.
- 5. THE SIZE OF THE SLAB SHALL BE THE SIZE (WIDTH AND LENGTH) OF THE BUILDING PLUS 5% FOR 14GA MATERIAL AND 52 FOR 12GA MATERIAL.
- 6. DEPTH OF SLAB TURN DOWN FOOTING SHALL BE GREATER THAN FROST DEPTH SPECIFIED PER LOCAL CODE.
- 7. CONTROL JOINTS SHALL BE PLACED SO AS TO LIMIT MAX. SLAB SPANS TO 20' IN EACH DIRECTION.
- ASSUMED SOIL BEARING CAPACITY IS TO BE A MIN. OF 1500 PSF.
- CONCRETE STRENGTH TO BE A MIN OF 2500 PSI @ 28 DAYS.



By Laura DiPasquale at 11:56 am, Aug 15, 2024 APPROVED

CAMEL /MAIN

BASE RAIL

END WALL POST

- DOOR POST

14GA SECTION A-A

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#### DRAWING INFORMATION

PROJECT: 24'-O" WIDE BUILDINGS

LOCATION: STATE OF MARYLAND

PROJECT NO .: 033-22-0243

SHEET TITLE:

FOUNDATION OPTION 1: CONCRETE SLAB

11-A / 11 SHEET NO .:

DRAWN BY: A.W. DATE: 2/9/22

CHECKED BY: OAA DATE: 2/9/22

#### LEGAL INFORMATION

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- DRAWINGS VALID UP TO DATE OF EXPIRATION.




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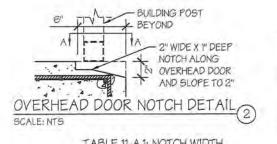
#### TABLE 11-A.2: CONCRETE SLAB ANCHOR SCHEDULE

WIND SPEED (MPH)	ANCHOR SIZE/NUMBER
□105 TO 135	(1) 1/2"Ø X 7"
□136 TO 180	(2) 1/2"Ø X 7"
□105 TO 135	(1) 1/2"Ø X 7"
□136 TO 180	(2) 1/2"Ø X 7"
	(MPH)  □105 T0 135  □136 T0 180  □105 T0 135

SCALE: NTS

- ANCHORS ARE TO BE CONCRETE WEDGE OR EXPANSION ANCHORS.
- MIN. EMBEDMENT DEPTH TO BE 27.
- ANCHORS TO BE SPACED NO MORE THAN 6" FROM POSTS.



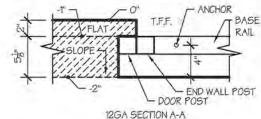

HORIZONTAL/OPEN		VERTICAL	
□14GA	□12GA	□14GA	□ 12GA
2 3/4"	27/8"	13/4"	17/8

NOTE: DEPTH IS TO BE 11/2"

