

HISTORIC PRESERVATION COMMISSION

Marc Elrich
County Executive
Chair

Date: 4/10/2025

MEMORANDUM

TO: Rabbiah Sabbakhan

Department of Permitting Services

FROM: Laura DiPasquale

Historic Preservation Section

Maryland-National Capital Park & Planning Commission

SUBJECT: Historic Area Work Permit #1109655 – New landing and ADA ramp

The Montgomery County Historic Preservation Commission (HPC) has reviewed the attached application for a Historic Area Work Permit (HAWP). This application was **approved** at the April 9, 2025 HPC meeting.

The HPC staff has reviewed and stamped the attached submission materials.

THE BUILDING PERMIT FOR THIS PROJECT SHALL BE ISSUED CONDITIONAL UPON ADHERENCE TO THE ABOVE APPROVED HAWP CONDITIONS AND MAY REQUIRE APPROVAL BY DPS OR ANOTHER LOCAL OFFICE BEFORE WORK CAN BEGIN.

Applicant: Emily Holness; Alan Kinney, Agent. Address: 7210 Spruce Avenue, Takoma Park

This HAWP approval is subject to the general condition that the applicant will obtain all other applicable Montgomery County or local government agency permits. After the issuance of these permits, the applicant must contact this Historic Preservation Office if any changes to the approved plan are made. Once work is complete, the applicant will contact Laura DiPasquale at 301-495-2167 or laura.dipasquale@montgomeryplanning.org to schedule a follow-up site visit.



Description of Property: Please describe the building and surror landscape features, or other significant features of the property:	unding environment. Include information on significant structures,
Description of Work Proposed: Please give an overview of the	work to be undertaken:
	APPROVED
	Montgomery County
REVIEWED By Laura DiPasquale at 8:59 am, Apr 10, 2025	Historic Preservation Commission
(3, 2, 2, 2, 2, 2, 2, 2, 2, 2, 2, 2, 2, 2,	
	Karen Bulit

Work Item 1:	_
Description of Current Condition:	Proposed Work:
Work Item 2:	Proposed Work:
REVIEWED By Laura DiPasquale at 8:59 am, Apr 10, 2025	APPROVED Montgomery County Historic Preservation Commission
Work Item 3:	Karen Brulit



Holness Residence 7210 Spruce Avenue Takoma Park, MD. 20912

-Plans conform with IRC 2021 -All wood in contact with soil or masonry foundations will meet the ASTM standard A 153 and A653, class 185. -All framing lumber to be SPF#2 unless indicated otherwise. -Design criteria used are as follows: -Roof load -30lbs/sf. -Roof and floor dead load-10lbs/sf. -Seismic design category B. -Termite damage subjectivity-moderate to heavy. -Winter design temperature-15 degrees F, -9 degrees C. -Subjectivity to damage from weather-heavy. -Subjectivity to decay -moderate. -Floor live load in non-sleeping areas-40lbs/sf. -Floor live load in sleeping areas- 30lbs/sf. -Wind speed-90mph (3 sec. gust method) 90 mph 40 m/s. -Frost line depth-24". -Flood hazard-Yes. -Subfloors- 3/4" APA subfloor/underlayment rated, tongue and groove, glued and nailed to joists.
-Roof sheathing 12/" OSB with spacers. -Roofing-2151b per square asphalt shingles over 151b. felt.

STRUCTURAL NOTES SOIL BEARING AND WATER CONDITION: ASSUMED SOIL BEARING CAPACITY OF 1500 PSF (MIN.) WITH A LATERAL PRESSURE OF 60 PSF. LIVE LOADS: ROOF...... FLOOR..... STAIRWAY..... FLOOR 40 PSF 15 MIND LOAD BACKFILL: SHALL NOT BE PLACED AGAINST WALLS UNTIL SLABS ON GRADE FOUNDATIONS: BOTTOMS OF THE ALL EXTERIOR FOOTINGS SHALL BE A MINIMUM OF 2'-6" BELOW FINISH GRADE. ALL FOOTINGS SHALL BE AS SHOWN ON FOOTING PLANS AND PROJECT 12" INTO UNDISTURBED EX'G. NATURAL GROUND HAVING ALLOMABLE BEARING CAPACITY AS PER SOIL CONSULTANT'S RECOMMENDATIONS, DEPTHS AND SIZES OF ALL FOOTINGS SHALL BE VERIFIED IN THE FIELD. DEPTHS SHALL BE SUBJECT TO CHANGE IF SOIL CONDITIONS ARE OTHER THAN ASSUMED. CONCRETE: ALL CONCRETE CONSTRUCTION SHALL CONFORM TO THE LATEST A.C.I. CODE 3 18. 28-DAY CONCRETE STRENGTH SHALL BE AS FOLLOWS: F'C= 2,500 PSI FOR FOOTINGS, INTERIOR SLABS ON GRADE AND FILL IN CONCRETE BLOCKS. F'C= 3,000 PSI FOR EXTERIOR SLABS ON GRADE. F'C= 4,000 PSI FOR PRECAST CONCRETE UNITS. ALL ROOFING MATERIALS TO HAVE ICE DAMMING PROTECTION. WOOD SPECIES AND GRADE: HEM-FIR (SURFACED DRY OR SURFACED GREEN USED AT 19% MAX. No. 2 OR BETTER WITH THE FOLLOWING DESIGN VALUES: Fb = 1,150 PSI (SINGLE MEMBER) 75 PSI Fc = 825 PSI E = 1,400,000 PSI LAMINATED VENEER LUMBER: MICRO-LAM LUMBER OR BETTER WITH THE FOLLOWING DESIGN PROPERTIES: Fv = 285 PSI Fc = 2,700 PSI E = 2,000,000 PSI VERTICAL LOAD TRANSFER: ALL STRUCTURAL POSTS MUST BE VERTICALLY ALIGNED AND BLOCKED TO PROVIDE CONTINUOUS BEARING TO FOUNDATION.

SCOPE OF WORK:

1-DEMO EXISTING LANDING SECTION AND STAIRS. 2-CONSTRUCT NEW LANDING SECTION AND HANDICAP RAMP.

INDEX

COVER SHEET
FLOOR PLANS
ELEV, FRAMING, SECT. AND DETAILS
A001

Holness Residence
1210 Spruce Avenue
akoma Park, MD. 20912

Date


 Date:
 3/19/25


 Drawn By:
 A&LK LOML

 Scale:
 1/4"=1'-0"

Sheet Number:

OO 1
Cover Page

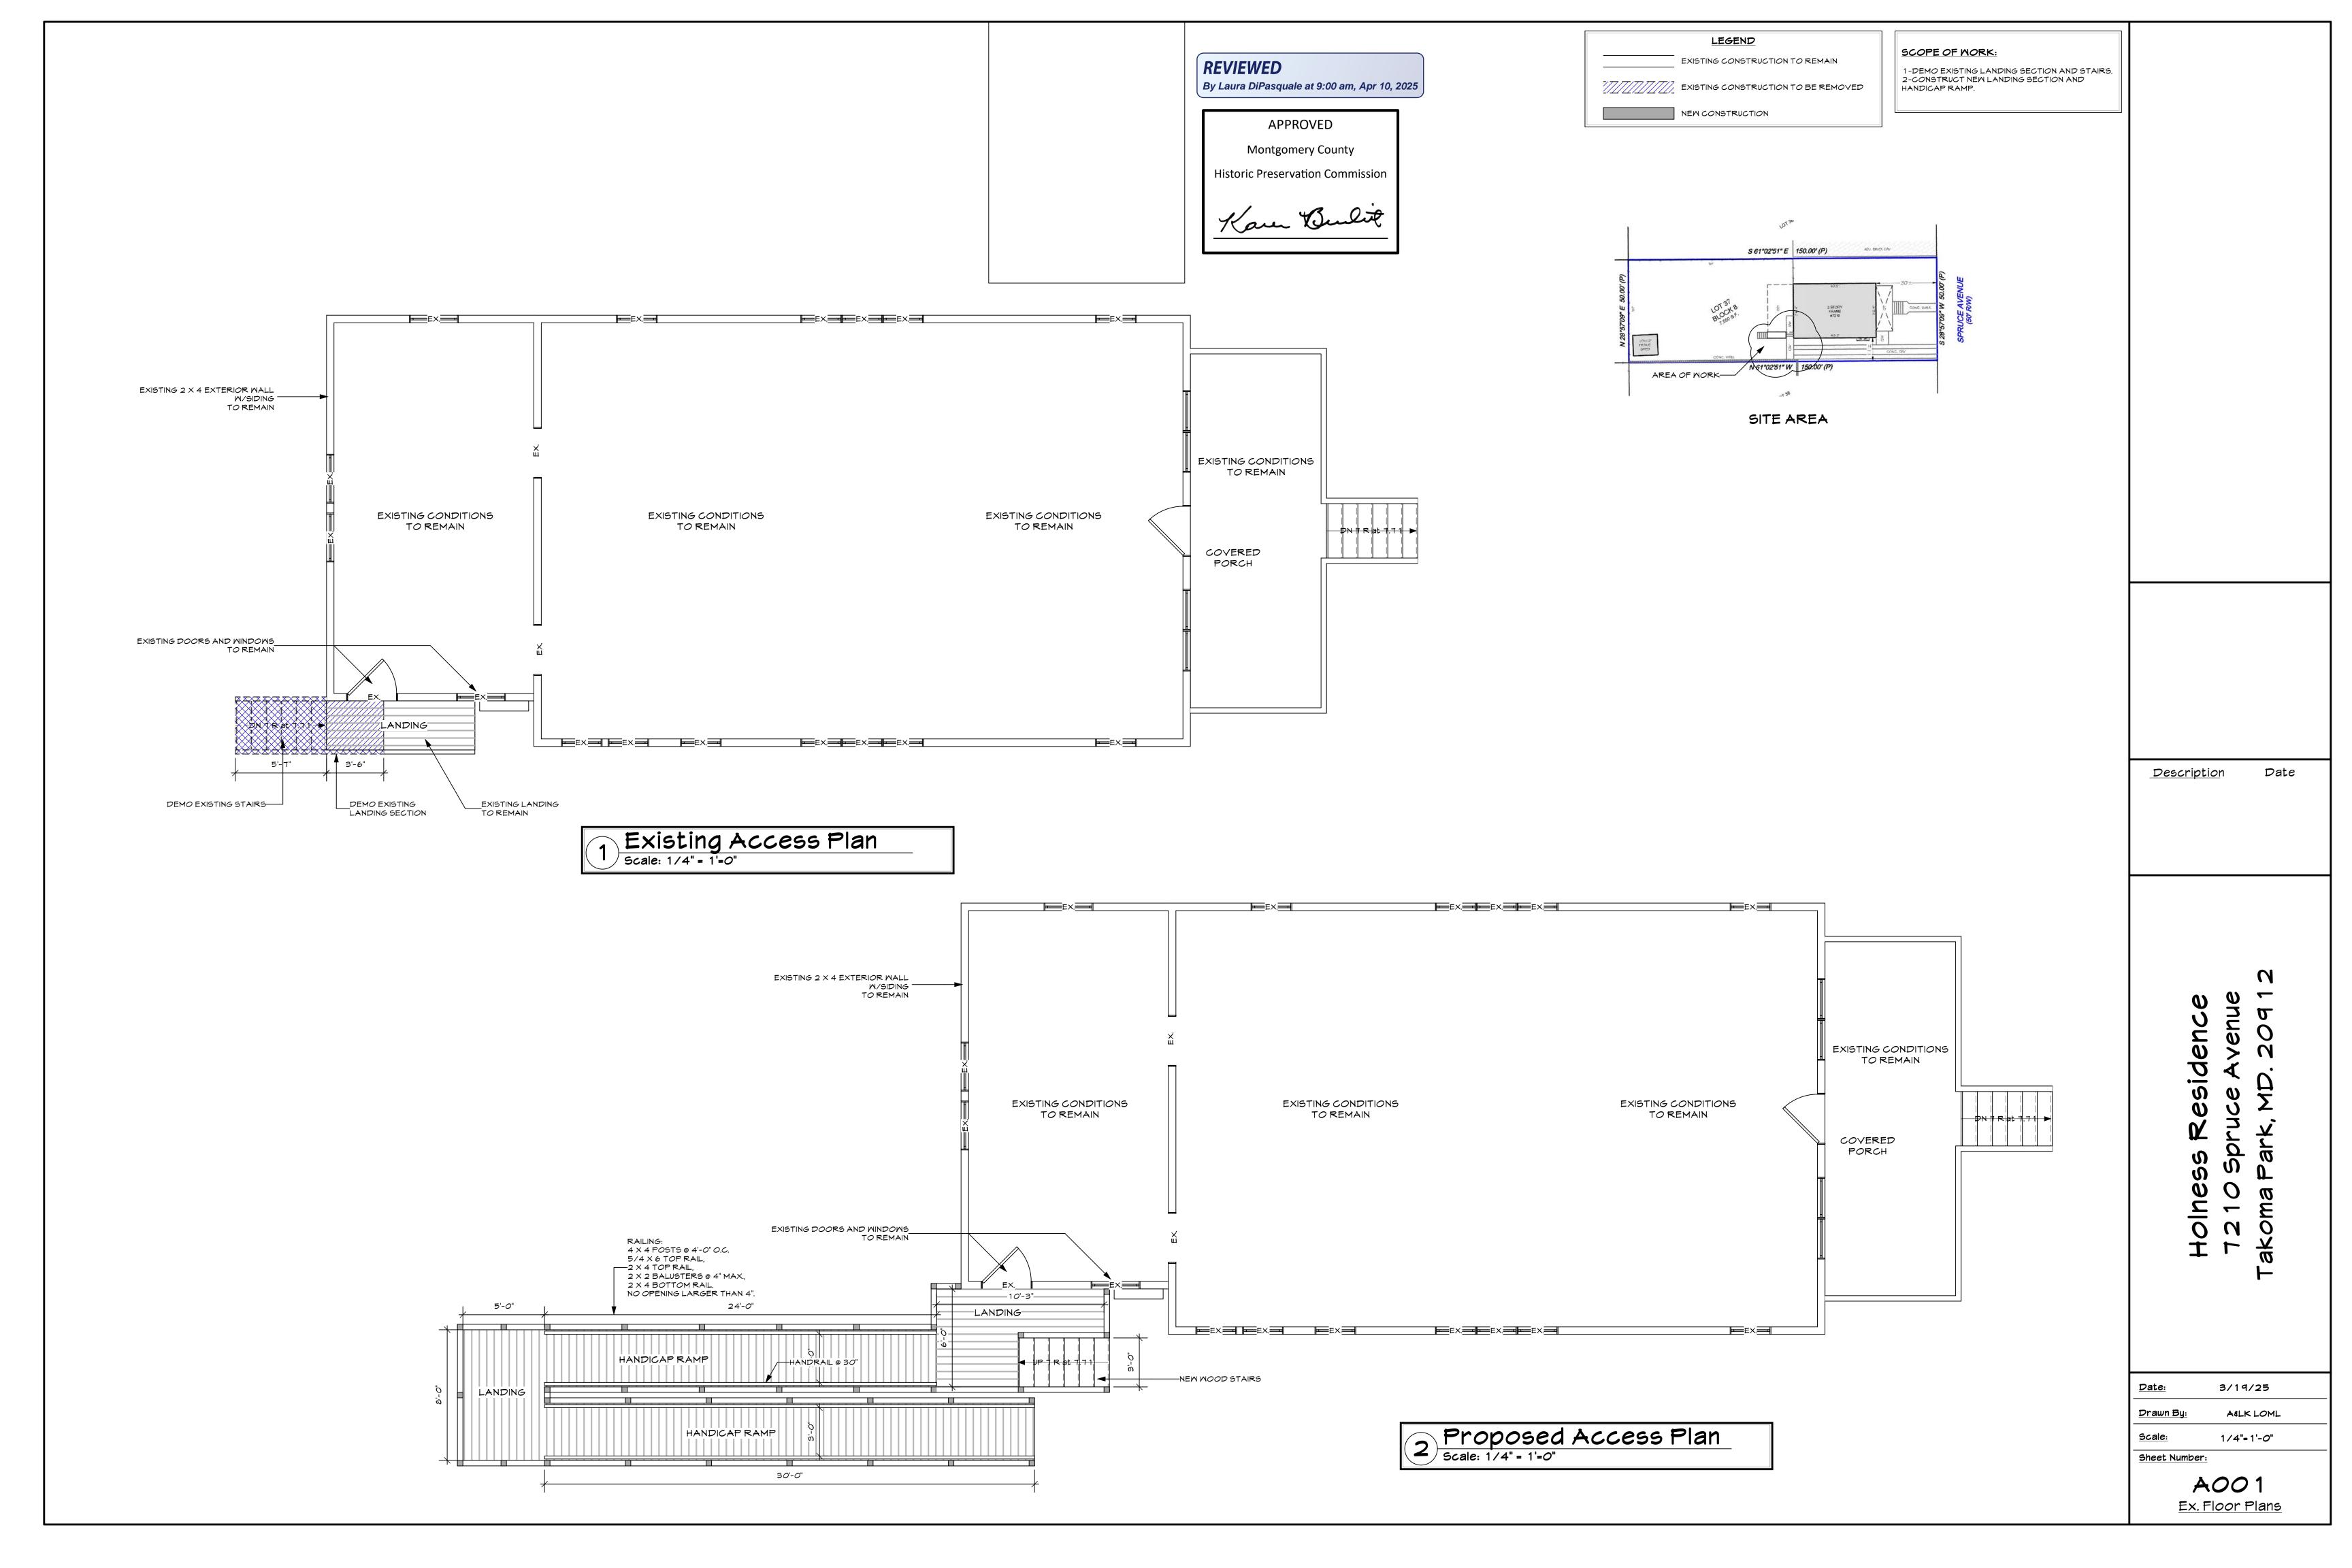

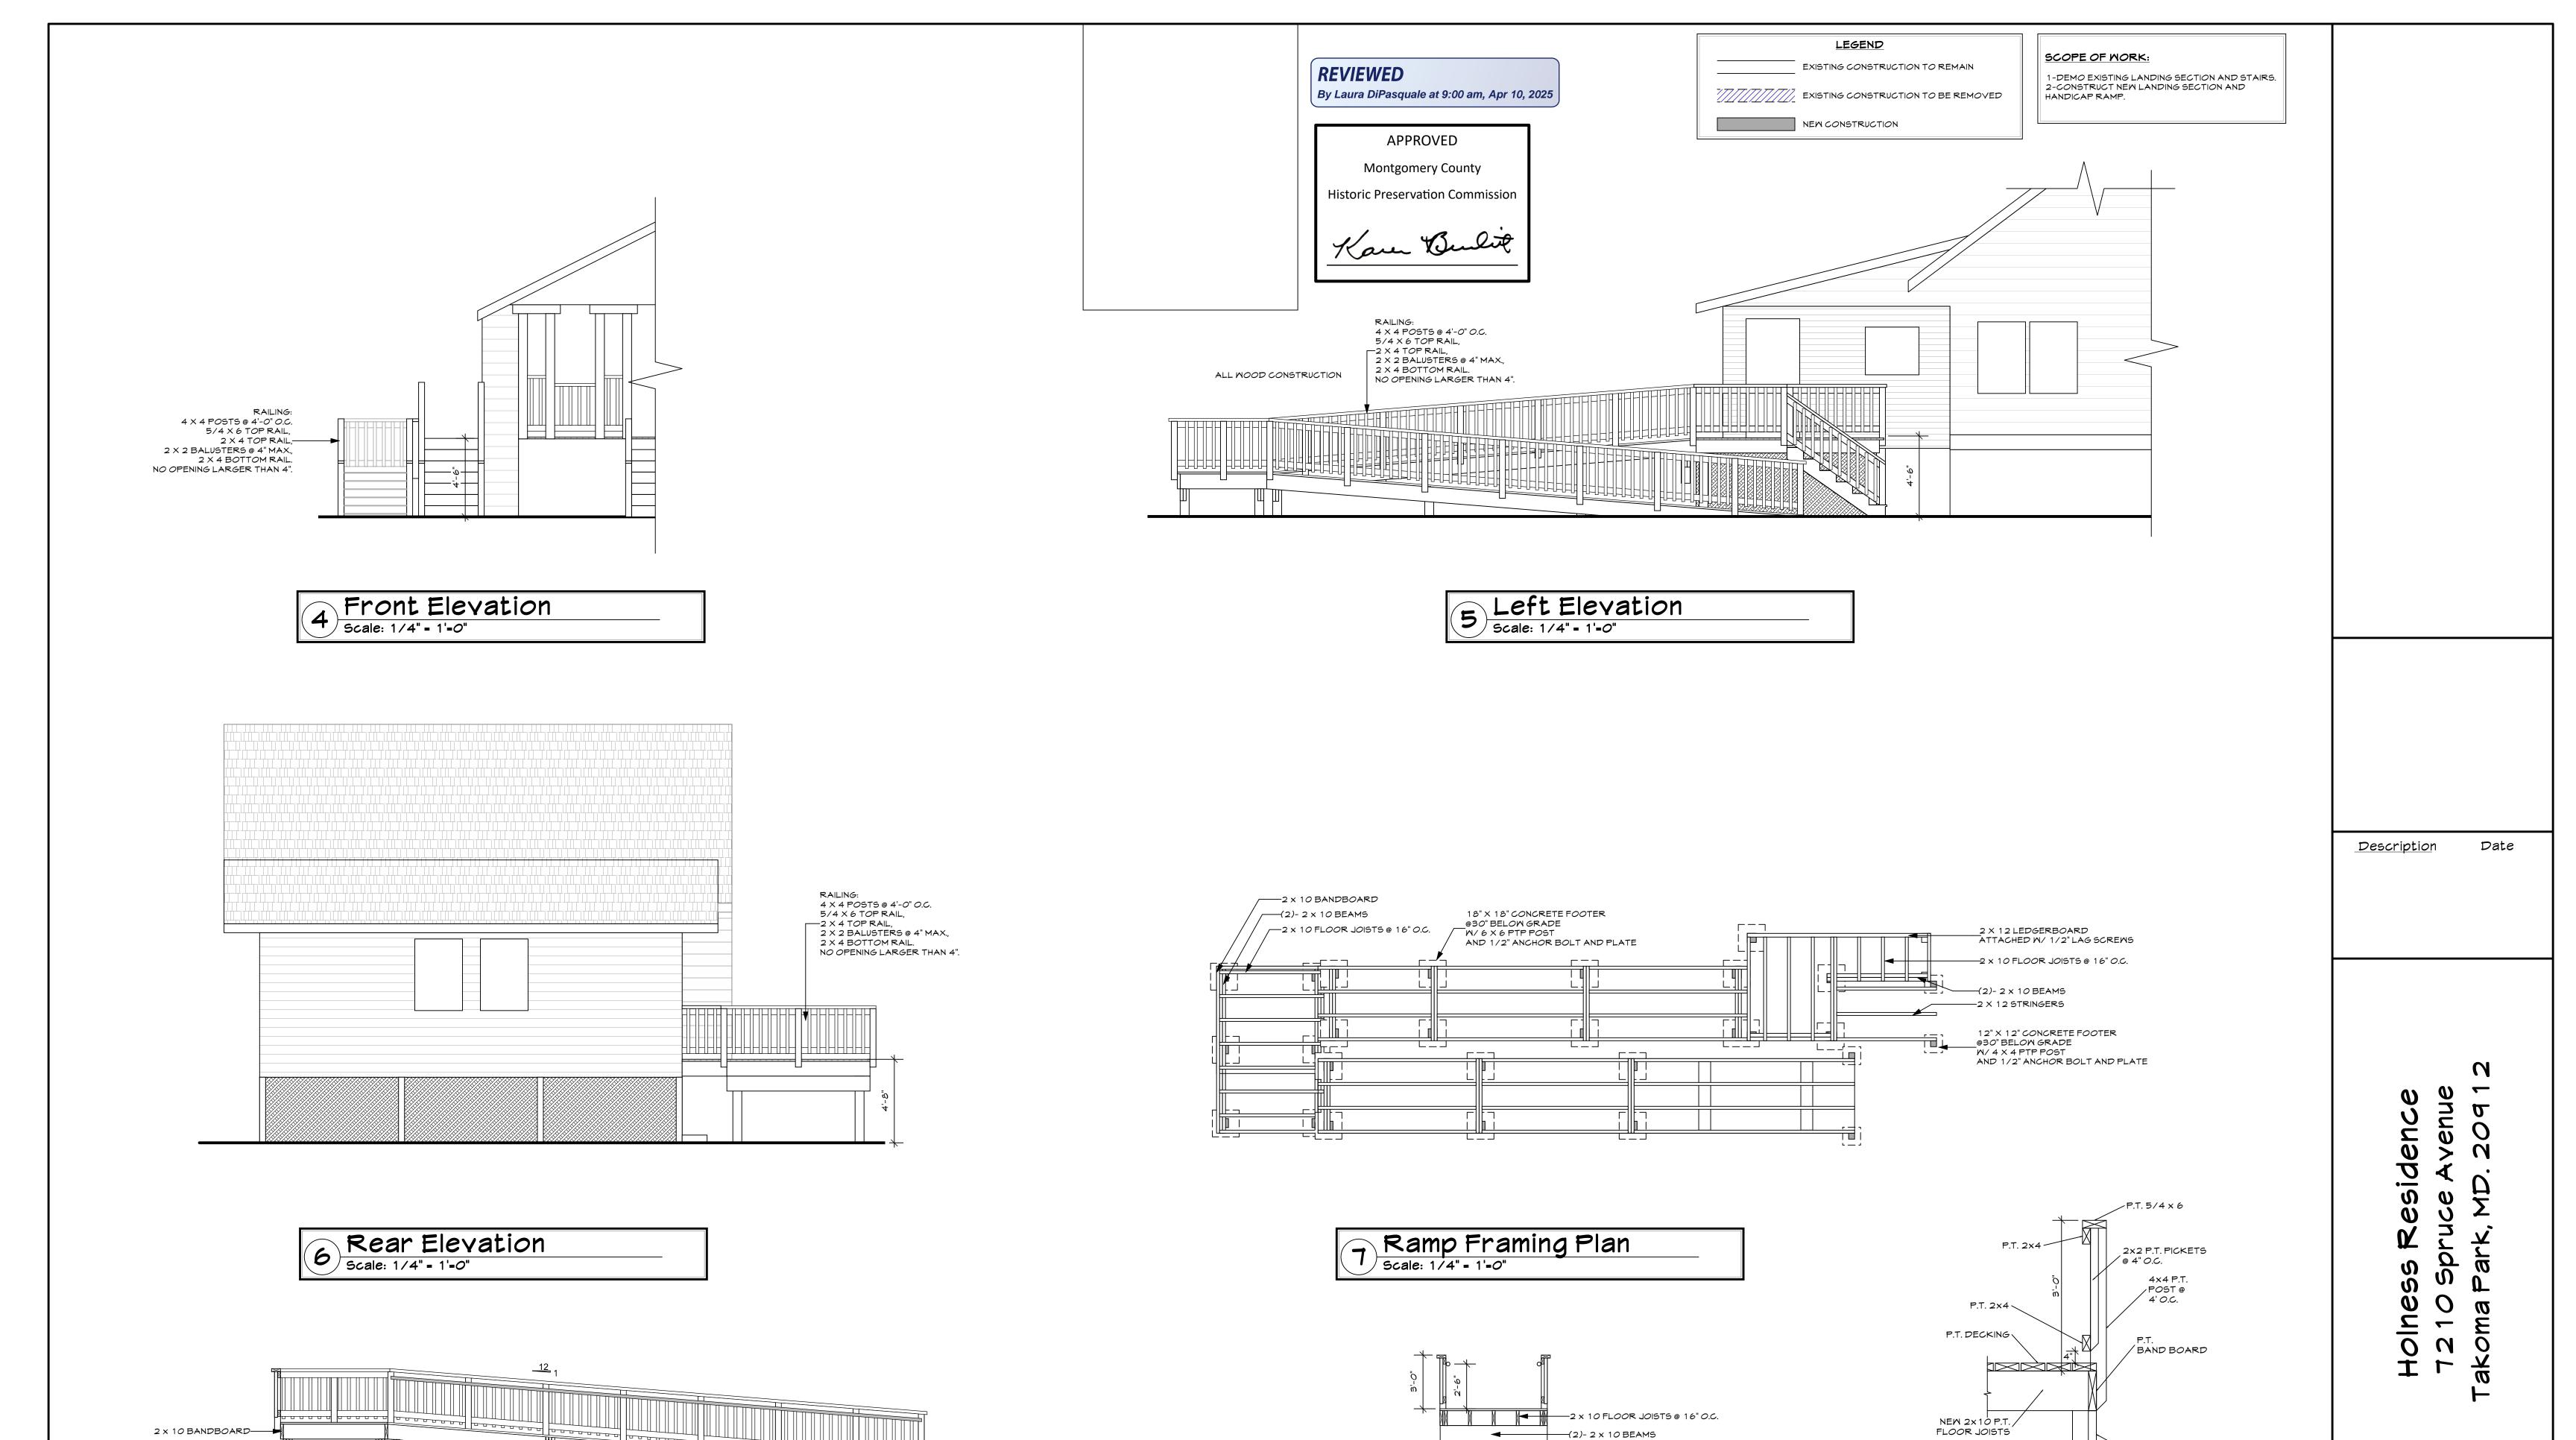

18" X 18" CONCRETE FOOTER

@30" BELOW GRADE

W/ 6 X 6 PTP POST

9 Landing Section Scale: 1/4" - 1'-0"

AND 1/2" ANCHOR BOLT AND PLATE

(2)- 2 x 10 BEAMS-

6 X 6 PTP POST<u>S</u>____

8 Ramp Section
Scale: 1/4" - 1'-0"

18" X 18" CONCRETE FOOTER __@30" BELOW GRADE

AND 1/2" ANCHOR BOLT AND PLATE

12" X 12" CONCRETE FOOTER __@30" BELOW GRADE

W/4 X 4 PTP POST AND 1/2" ANCHOR BOLT AND PLATE

Date: 3/19/25 <u>Drawn By:</u> A&LK LOML <u>Scale:</u> 1/4"= 1'-*0*" Sheet Number: A002 Prop Basement Plan

2-2×1*0*P.T BEAM

6×6 / P.T. POST

Deck Rail Detail
Scale: N.T.S.









