

#### HISTORIC PRESERVATION COMMISSION

Marc Elrich
County Executive

Karen Burditt
Chair

October 9, 2025

#### **MEMORANDUM**

TO: Rabbiah Sabbakhan

Department of Permitting Services

FROM: Laura DiPasquale

**Historic Preservation Section** 

Maryland-National Capital Park & Planning Commission

SUBJECT: Historic Area Work Permit #1133162 Complete renovation of house, demolition of non-historic

addition, and construction of new two-story addition and deck

The Montgomery County Historic Preservation Commission (HPC) has reviewed the attached applications for a Historic Area Work Permit (HAWP). This application was **approved** at the October 8, 2025 HPC meeting.

The HPC staff has reviewed and stamped the attached submission materials.

THE BUILDING PERMIT FOR THIS PROJECT SHALL BE ISSUED CONDITIONAL UPON ADHERENCE TO THE ABOVE APPROVED HAWP CONDITIONS AND MAY REQUIRE APPROVAL BY DPS OR ANOTHER LOCAL OFFICE BEFORE WORK CAN BEGIN.

Applicant: Josean Acevedo Soto; Thomas J. Taltavull, Architect

Address: 9220 Damascus Hills Lane, Damascus

This HAWP approval is subject to the general condition that the applicant will obtain all other applicable Montgomery County or local government agency permits. After the issuance of these permits, the applicant must contact this Historic Preservation Office if any changes to the approved plan are made. Once work is complete, the applicant will contact Laura DiPasquale at 301-495-2167 or <a href="mailto:laura.dipasquale@montgomeryplanning.org">laura.dipasquale@montgomeryplanning.org</a> to schedule a follow-up site visit.



| Description of Property: Please describe the building and surrounding environment. Include information on significant structures, landscape features, or other significant features of the property: |                                  |  |  |
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| Description of Work Proposed: Please give an overview of the wo  | ork to be undertaken:            |  |  |
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|  | APPROVED                         |  |  |
|  | Montgomery County                |  |  |
| REVIEWED   | Historic Preservation Commission |  |  |
| By Laura DIPasquale at 1:31 pm, Oct 09, 2025   |                                  |  |  |
|  | Kare Bulit                       |  |  |

| Work Item 1:   |  |
|--|--|
| Description of Current Condition:  | Proposed Work:   |
| Work Item 2:   |  |
| Description of Current Condition:  | Proposed Work:   |
| Work Item 3:   |  |
| Description of Current Condition:  REVIEWED  By Laura DIPasquale at 1:31 p | APPROVED  Montgomery County  Historic Preservation Commission  Montgomery County  Historic Preservation Commission |

## Work Item 4: Remove mid 20th Century Addition

Description of Current Condition:

Mid 20th Century addition is in poor condition, consisting of concrete footing and CMU foundation walls. Framing is poorly constructed and currently unsafe. Casement windows and metal doors are not compatible with existing house. Wood siding and metal roofing are in poor condtion.

Proposed Work:

Remove poorly constructed and non contributing addition to existing house.

Work Item 5: Reframe existing two story shed roof wing and construct new two story addition & wood deck.

Description of Current Condition:

Roof and wall framing at rear shed roof wing is in poor condition and unsafe. Second Floor window is non original and in poor condition.

Proposed Work:

Rebuild rear shed addition, re-frame roof to provide proper drainage to rear of house to accommodate new addition. Install two new wood vinyl clad two over two double hung windows at first and second floors of shed roof wing. Construct new two story addition and wood deck at rear of house.

## Work Item 6: Restore existing wood windows and trim

Description of Current Condition:

The existing wood two over two wood double hung windows trim are in fair condition.

Proposed Work:

Restore all existing windows and trim, paint.

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## Work Item 7: Existing exterior door replacement **Description of Current Condition:** Proposed Work: Existing Exterior front and side doors are Replace exterior metal doors, frames and trim with metal and in poor condition. new wood panel doors with true divided four light glass panels, frames and trim. Work Item 8: Install wood replacement windows in original locations Description of Current Condition: Proposed Work: Currently there are wood vinyl clad Install Wood windows and trim to match original casement windows in two locations and two over two double hung windows in three one missing window that was removed at locations. second floor



 $_{
m Work\ Item\ 10:}$ Repair and repaint existing metal roofing on house and porch

Description of Current Condition:

Existing metal roofing on house and porch are in fair condition.

Proposed Work:

Repair where required and repaint existing main house and porch roofing.

Work Item 11: Install new half gutters with round downspouts on existing house, porch and new addition.

Description of Current Condition:

Currently no gutters exist.

Proposed Work:

Install appropriately sized half round aluminum gutters and round downspouts on existing house. porch and new addition.

 $_{
m Work\ Item\ 12:}$ Rebuild and restore existing Covered Porch and Steps.

Description of Current Condition:

The existing porch concrete piers, floor framing, wood columns are in poor condition. Porch roof beams and framing and trim are in fair condition. No original porch finish ceiling or floor decking exists.

Proposed Work:

Remove deteriorated porch concrete piers, floor framing and wood columns and replace with new concrete piers, floor framing, new wood tongue and groove decking and wood columns to match. Repair and restore wood porch beams, framing and trim. Install new wood

beaded ceiling. Paint.

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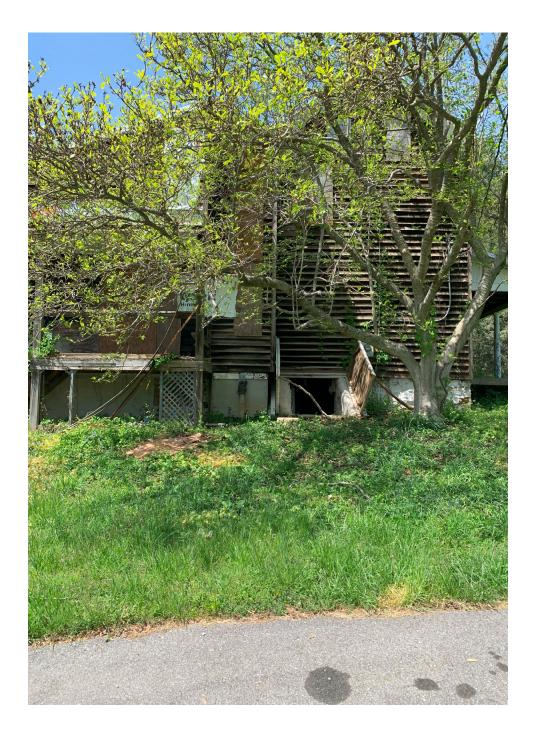
REVIEWED

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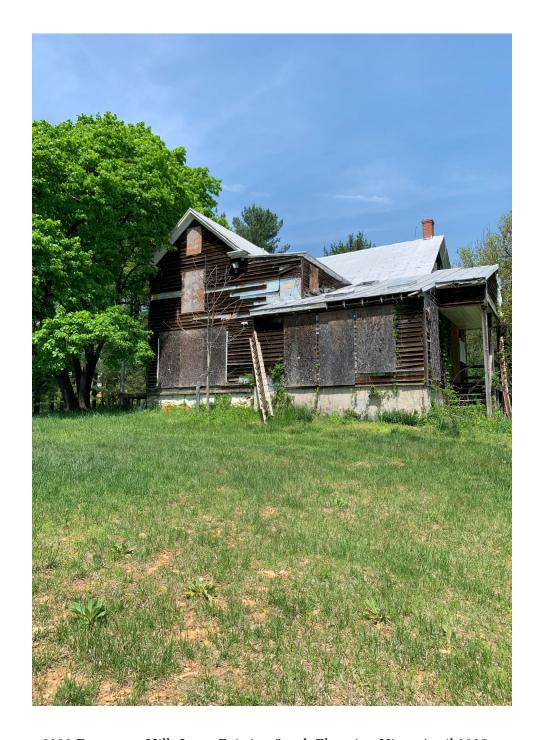
9220 Damascus Hills Lane Existing West Elevation View April 2025




9220 Damascus Hills Lane Existing East Side Elevation View April 2025



9220 Damascus Hills Lane Existing North Elevation View April 2025



9220 Damascus Hills Lane Existing South Elevation View April 2025

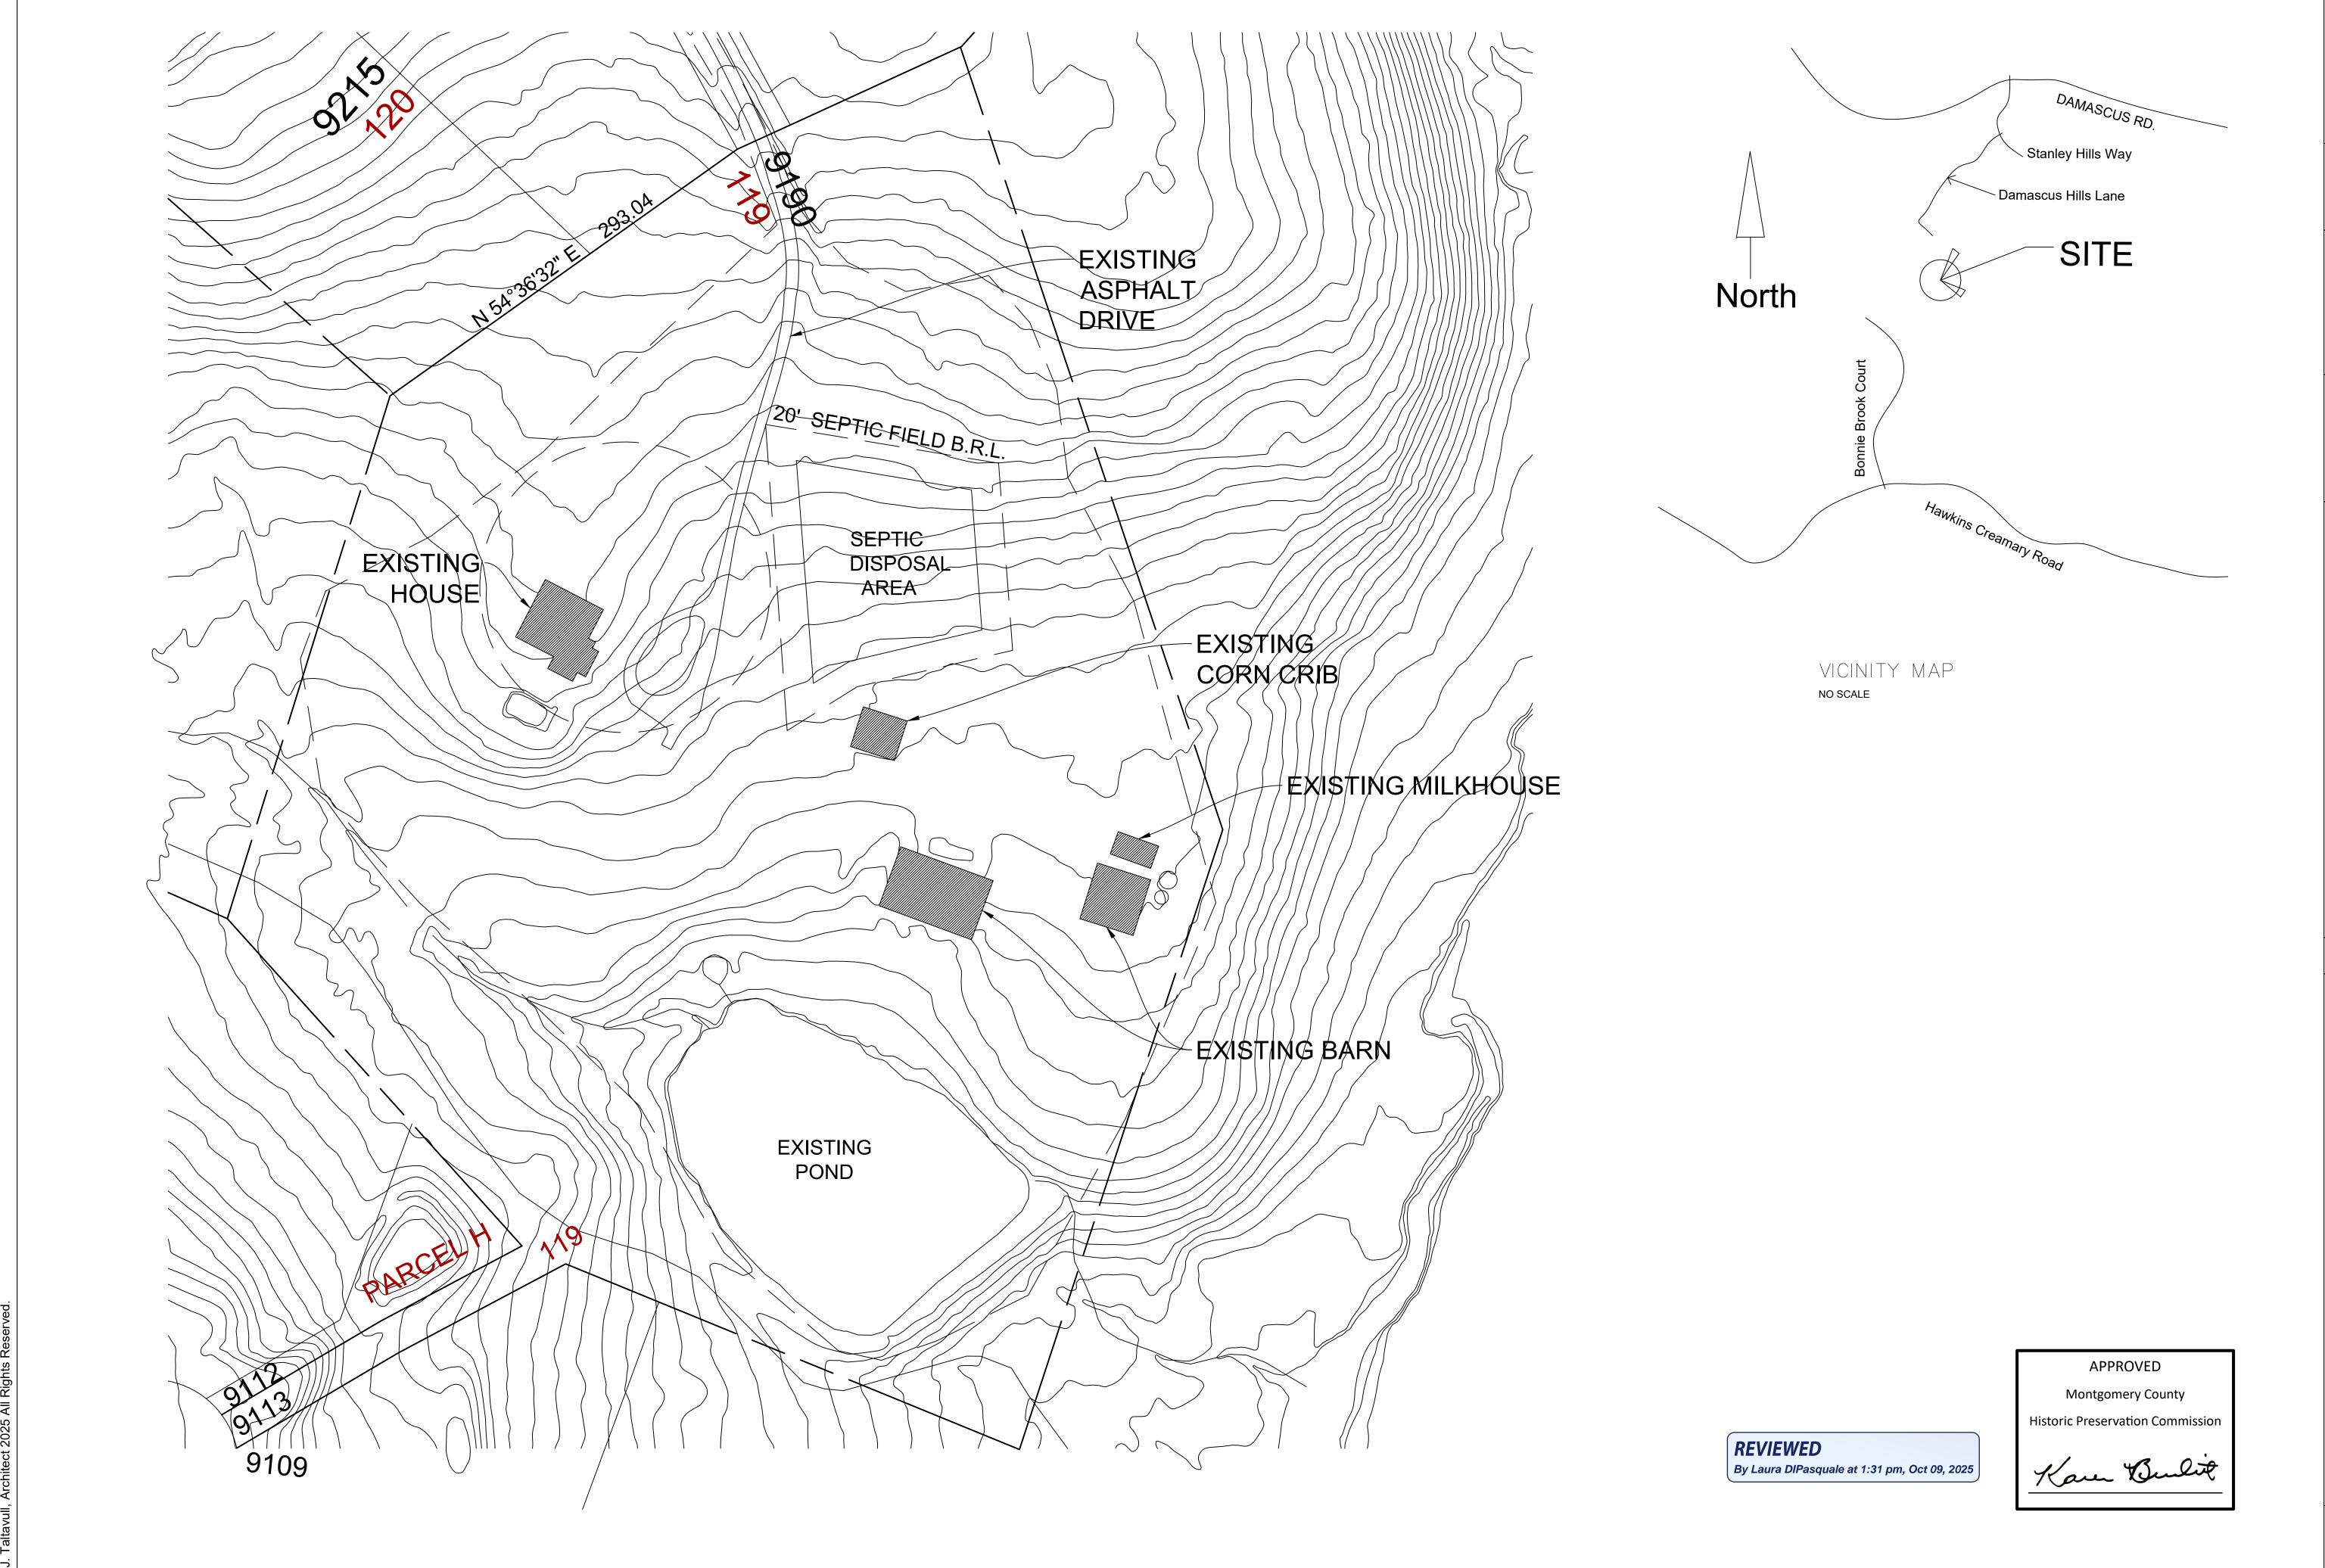

A R C H I T E C T S
P L A N N E R S
H I S T O R I C
PRESERVATION

THOMAS J. TALTAVULL ARCHITECT 20650 PLUM CREEK COURT GAITHERSBURG, MARYLAND 20882

301.840.1847 tom@tjtarchitects.com

Professional Certification:
I hereby certify that these documents were prepared or approved by me, and that I am a duly licensed architect under the laws of the State of Maryland, License No.9083, Expiration Date: 6-13-2026.

Professional Seal

rawing Title
SITE PLAN

Date: Sept. 4, 2025

ons and Addition to:

TO Residence

man Farm


Rehabilitations and Addi ACEVEDO-SOTO Resider Rezin - Bowman Farm

Drawing Number

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P L A N N E R S
H I S T O R I C
PRESERVATION

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Drawing Title

EXISTING PLANS

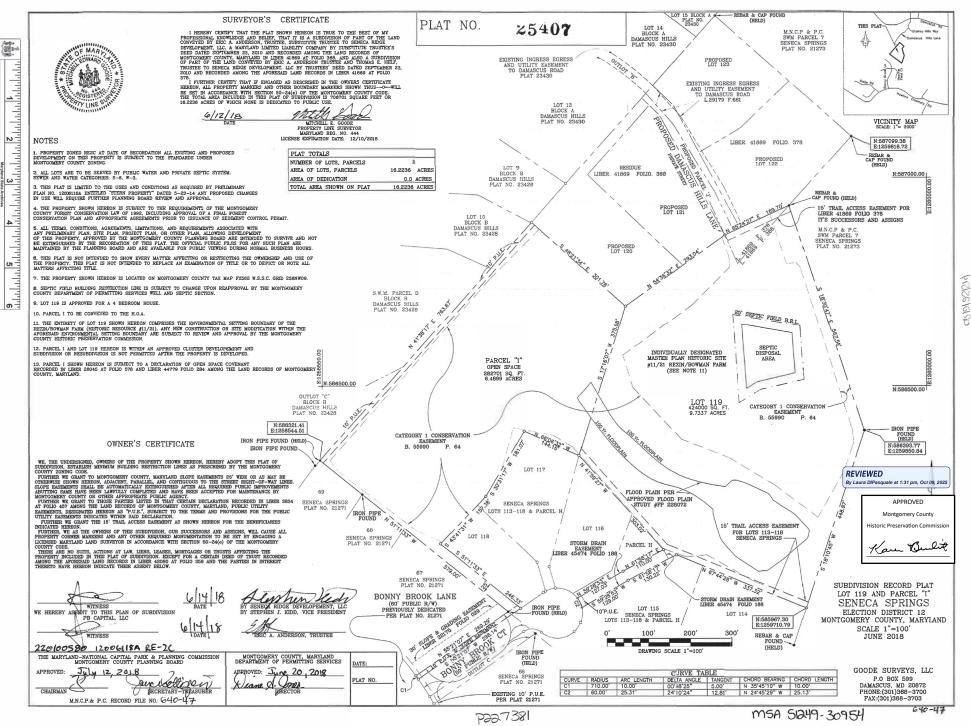Date: Sept. 4, 2025

ions and Addition to: soto Residence wman Farm ascus Hills Lane,

Rehabilitations an ACEVEDO-SOTO R Rezin - Bowman F 9220 Damascus F

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**Historic Preservation Commission** 

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By Laura DIPasquale at 1:30 pm, Oct 09, 2025

Drawing Number

A100

ARCHITECTS PLANNERS

PRESERVATION THOMAS J. TALTAVULL ARCHITECT 20650 PLUM CREEK COURT GAITHERSBURG, MARYLAND 20882

HISTORIC

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**PLANS** TING wing Title

Date: Sept. 4, 2025

Rehabilitations and Addition to:
ACEVEDO-SOTO Residence
Rezin - Bowman Farm
9220 Damascus Hills Lane,
Damascus, Maryland 20872

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**Historic Preservation Commission** 

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**Drawing Number** 

A101

EXISTING FIRST FLOOR PLAN

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THOMAS J. TALTAVULL ARCHITECT 20650 PLUM CREEK COURT GAITHERSBURG, MARYLAND 20882

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**PLANS** 

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Date: Sept. 4, 2025

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Montgomery County


Historic Preservation Commission


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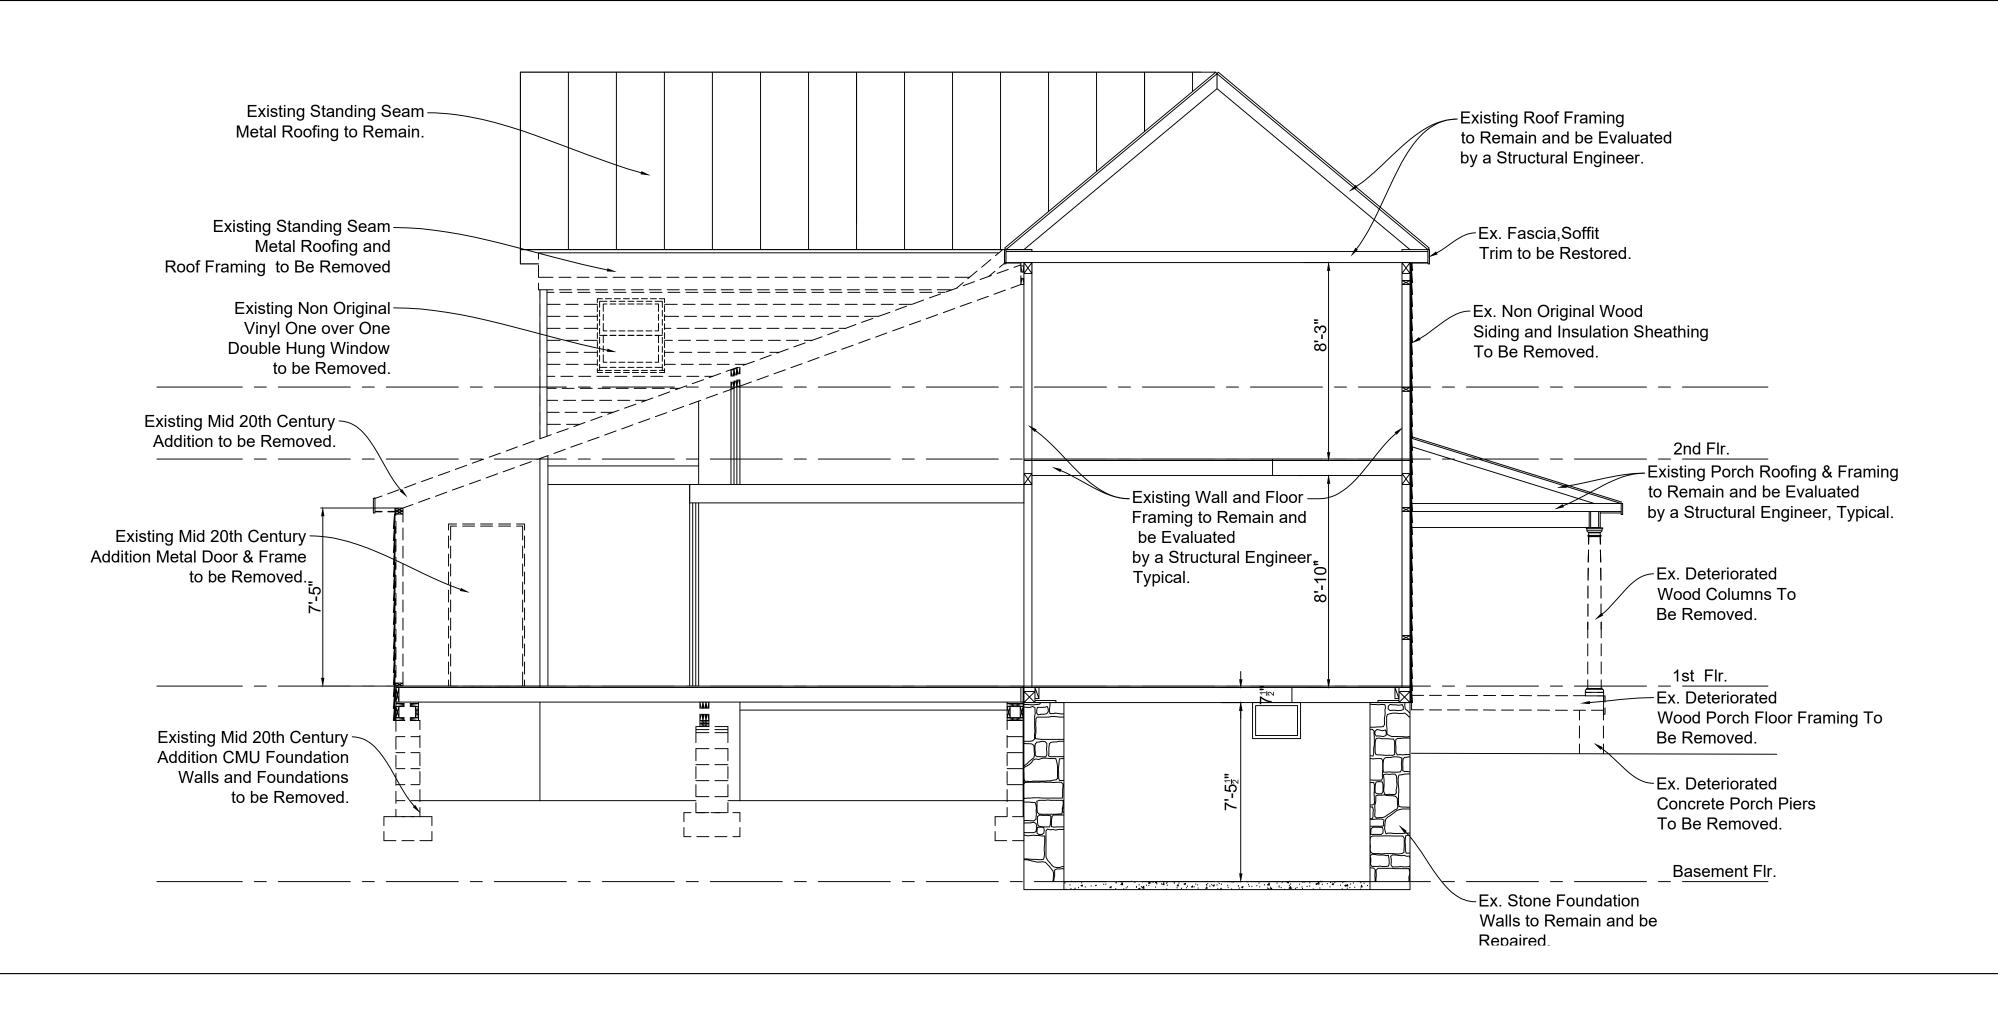
By Laura DIPasquale at 1:30 pm, Oct 09, 2025

**Drawing Number** 

A102




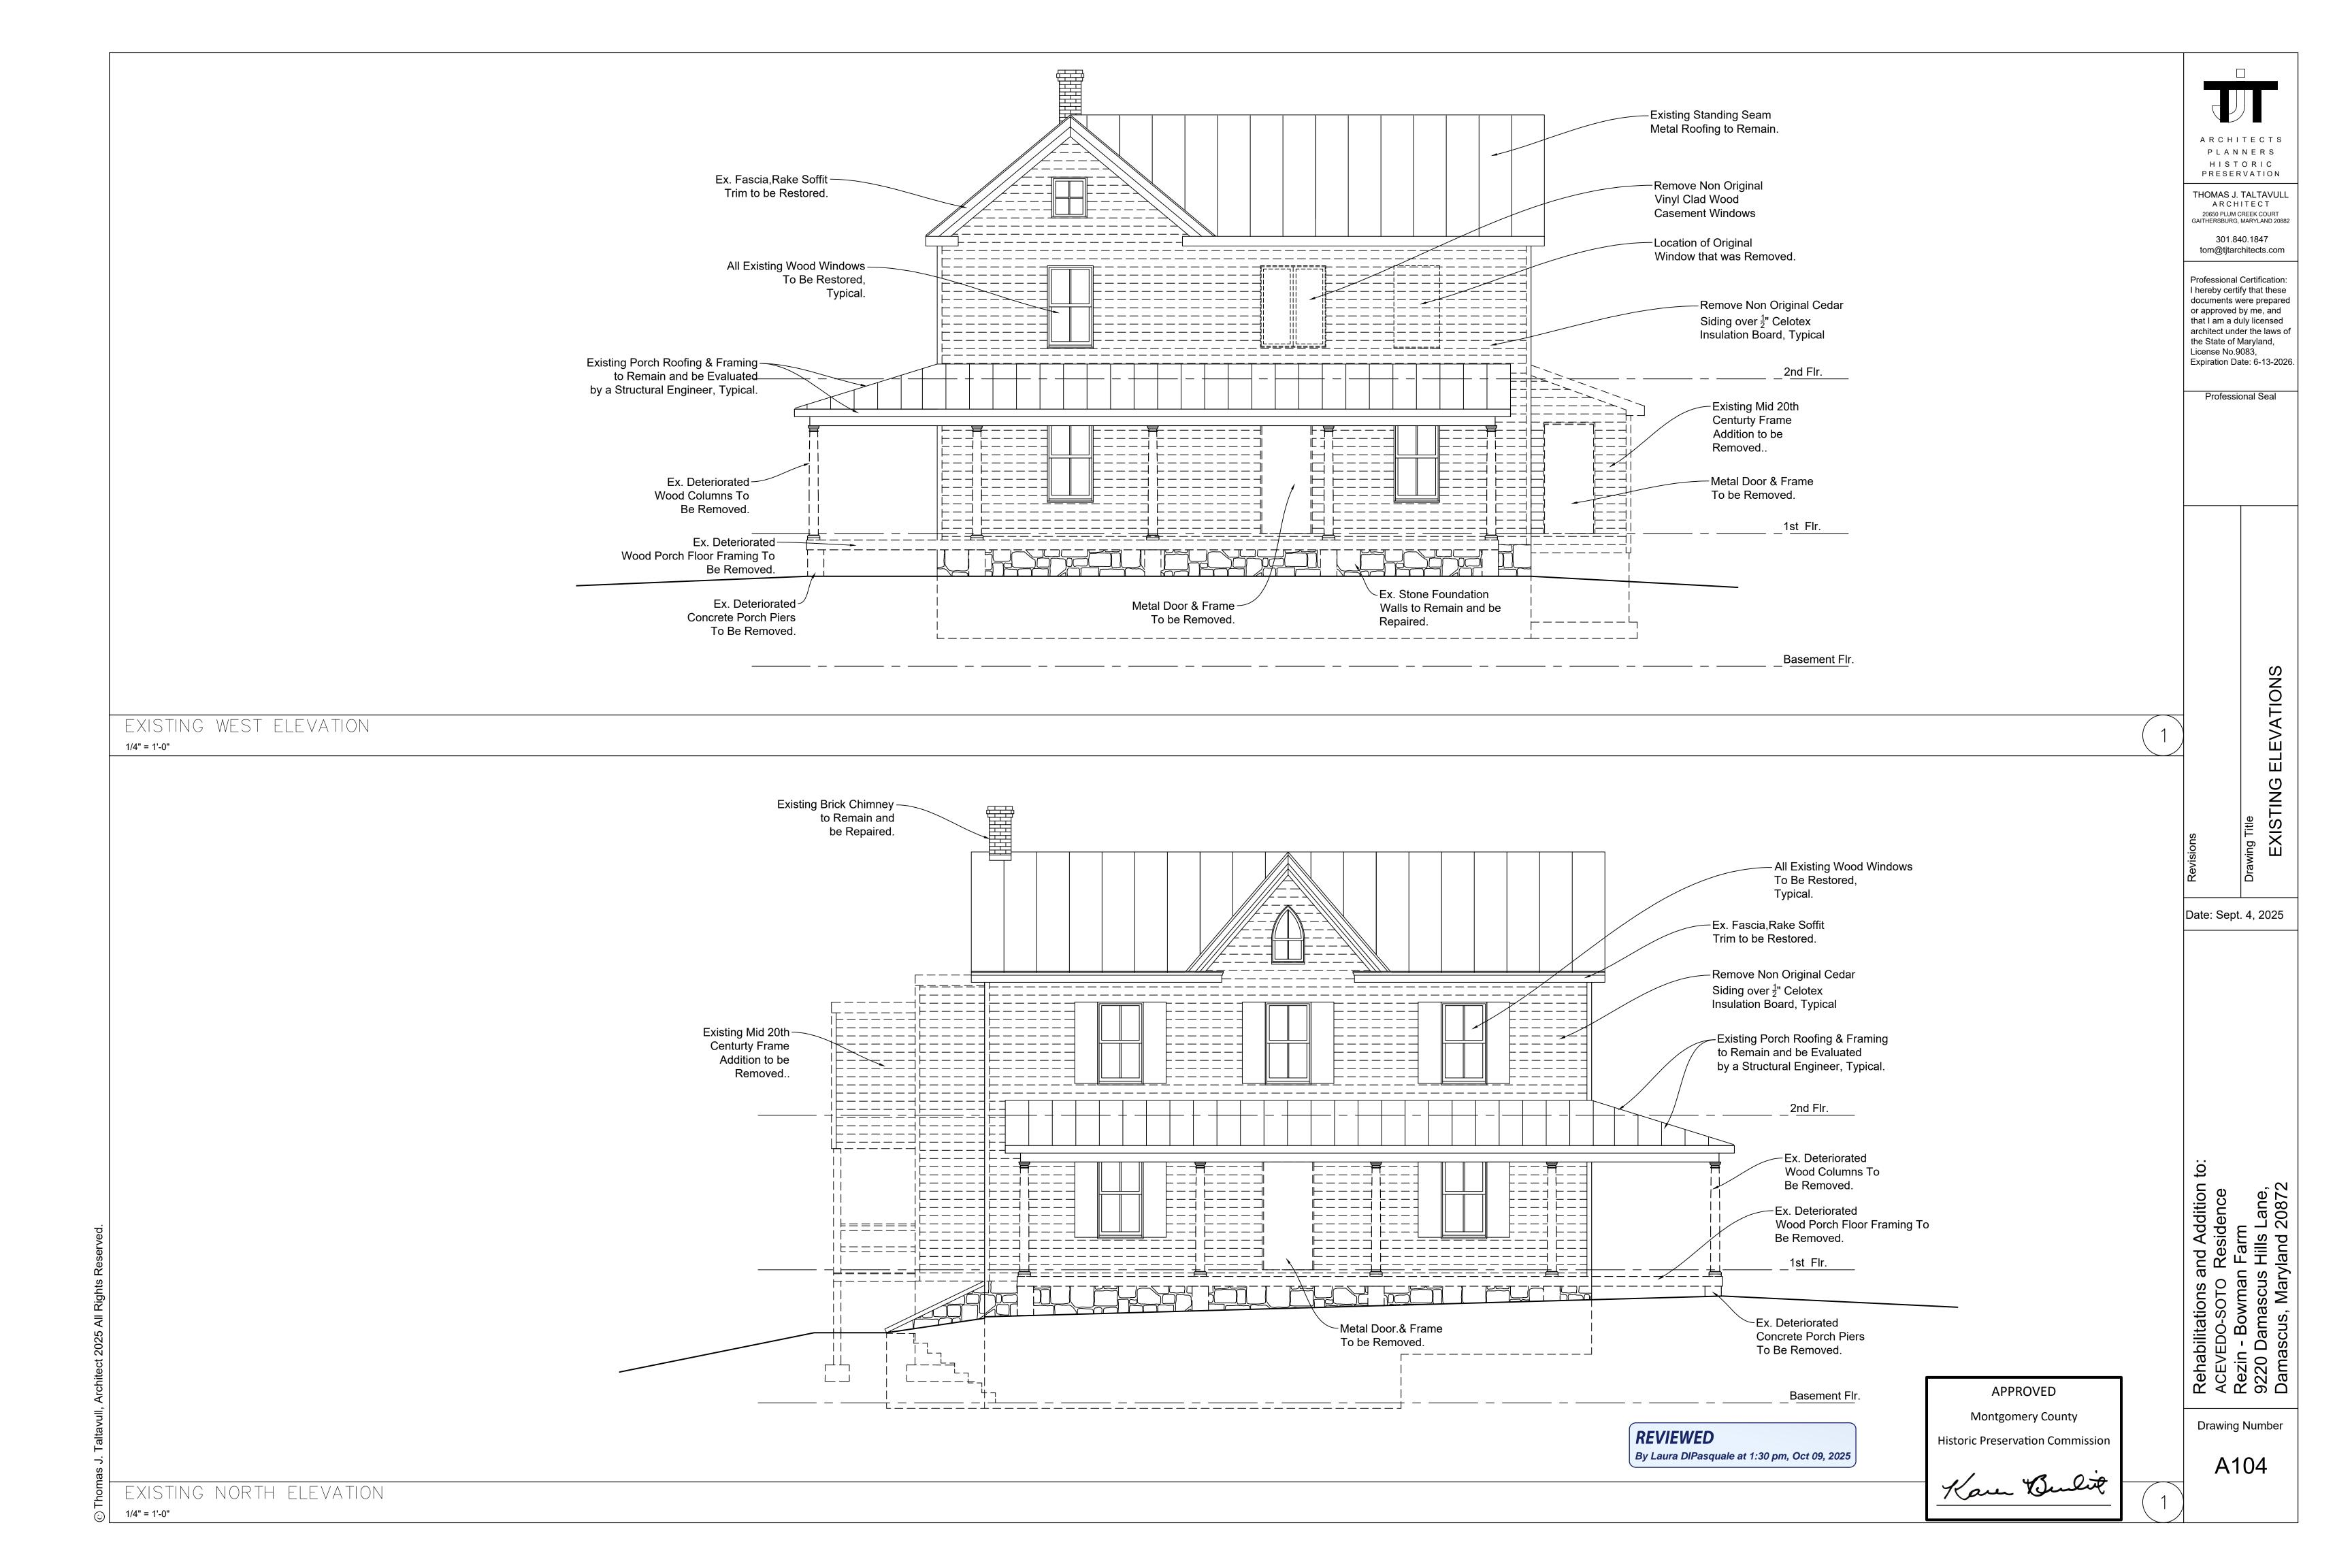

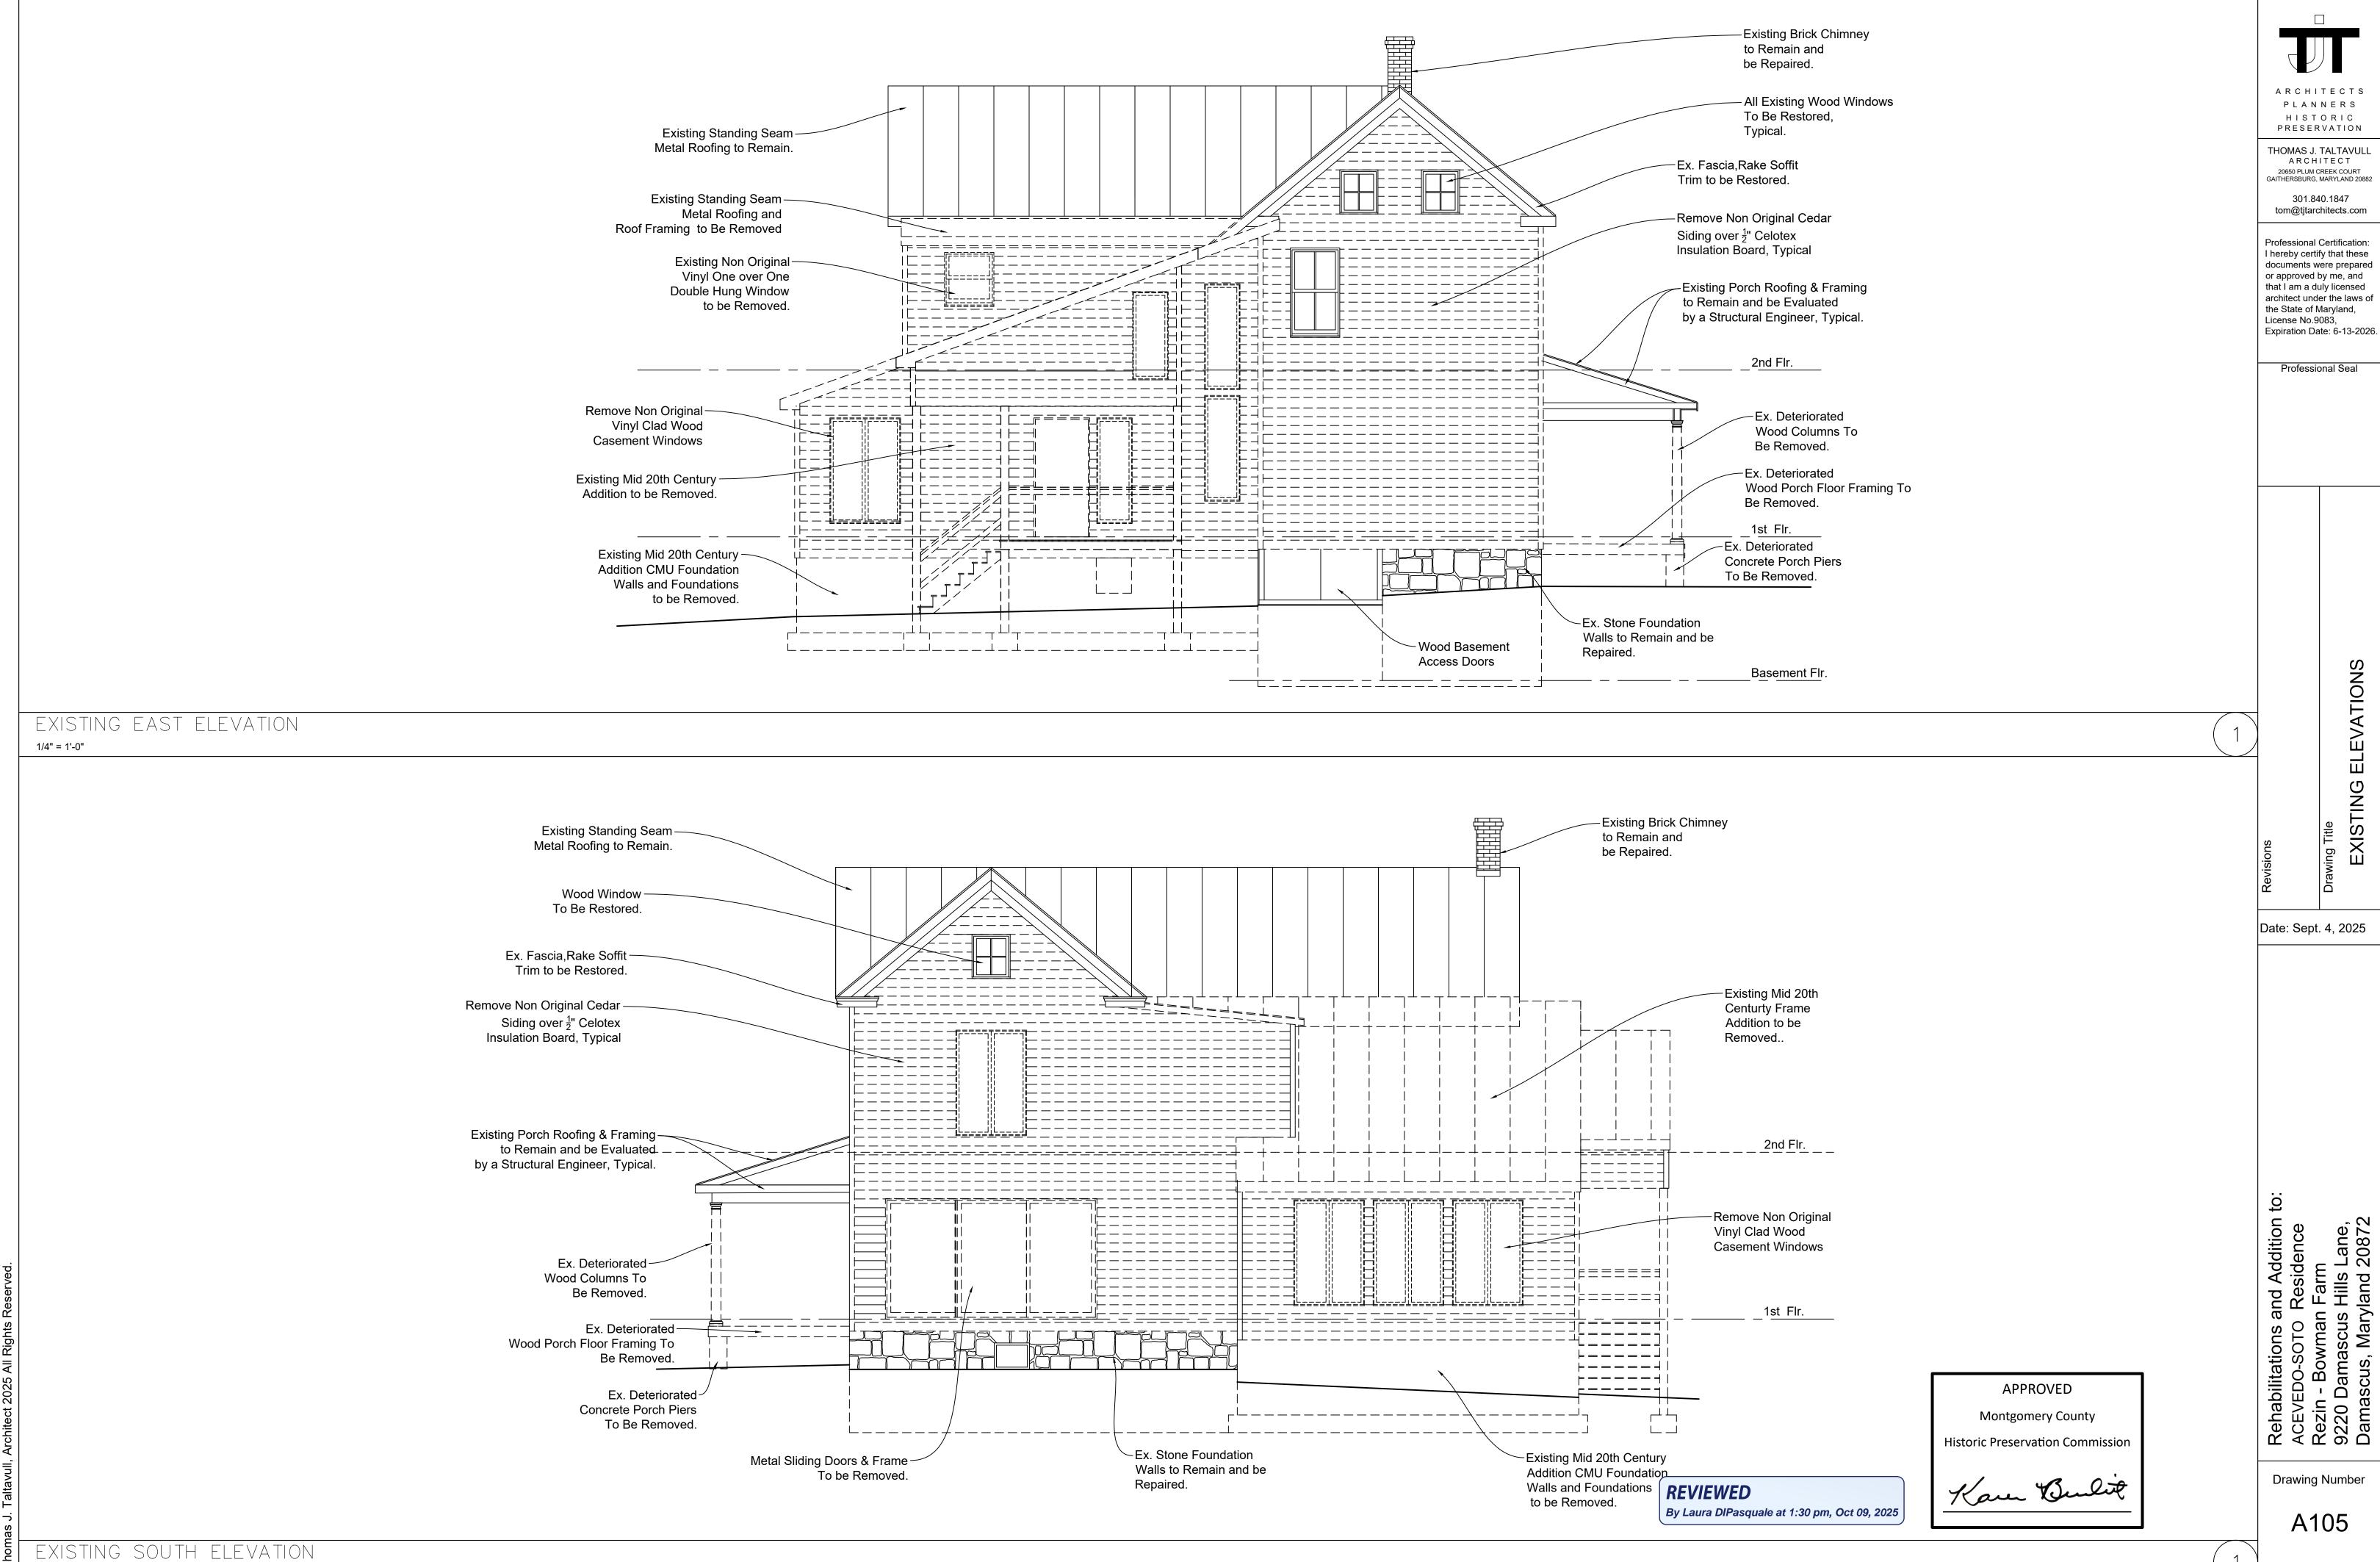

EXISTING BUILDING SECTION

1/4" = 1'-0"

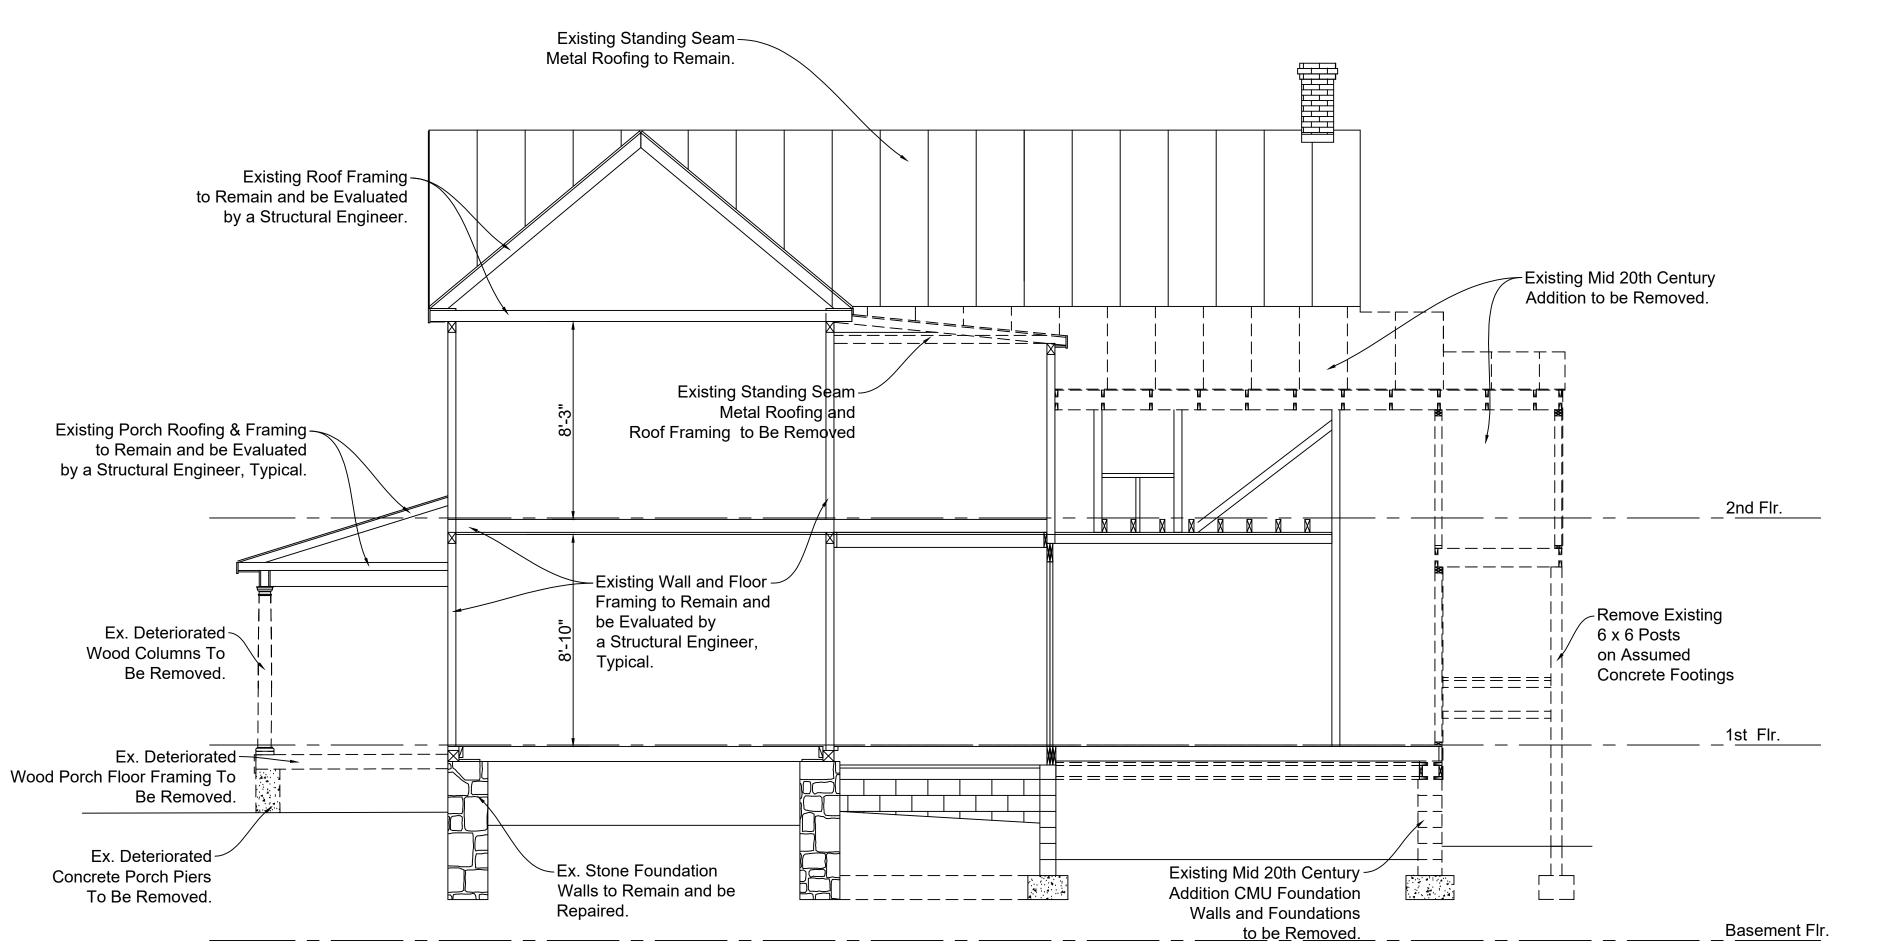

By Laura DIPasquale at 1:30 pm, Oct 09, 2025

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**Drawing Number** 

ARCHITECTS

PLANNERS

HISTORIC PRESERVATION

THOMAS J. TALTAVULL

ARCHITECT

20650 PLUM CREEK COURT GAITHERSBURG, MARYLAND 20882

301.840.1847

tom@tjtarchitects.com

**Professional Certification:** 

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architect under the laws of

Expiration Date: 6-13-2026

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SECTIONS

BUILDING

EXIST

Date: Sept. 4, 2025

the State of Maryland,

License No.9083,

A106

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FLOOR OSED PRPC

Date: Sept. 4, 2025

**Drawing Number** 

A200

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HISTORIC PRESERVATION

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wing Title
PROPOSED FLOOR PLAN

Date: Sept. 4, 2025

tations and Addition to: 0-SOTO Residence Bowman Farm amascus Hills Lane,

ACEVEDO-SOTO Re Rezin - Bowman F 9220 Damascus H

Drawing Number

A201

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By Laura DIPasquale at 1:30 pm, Oct 09, 2025

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Historic Preservation Commission

Rehabilitations and Addition to:
ACEVEDO-SOTO Residence
Rezin - Bowman Farm
9220 Damascus Hills Lane,
Damascus, Maryland 20872 APPROVED **Montgomery County** 

**Drawing Number** 

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A202

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THOMAS J. TALTAVULL ARCHITECT 20650 PLUM CREEK COURT GAITHERSBURG, MARYLAND 20882

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Expiration Date: 6-13-2026.

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EXISTING PLANS


Date: Sept. 4, 2025

the State of Maryland, License No.9083,

REVIEWED

PROPOSED ADDITION SECOND FLOOR PLAN 1/4" = 1'-0"

By Laura DIPasquale at 1:30 pm, Oct 09, 2025

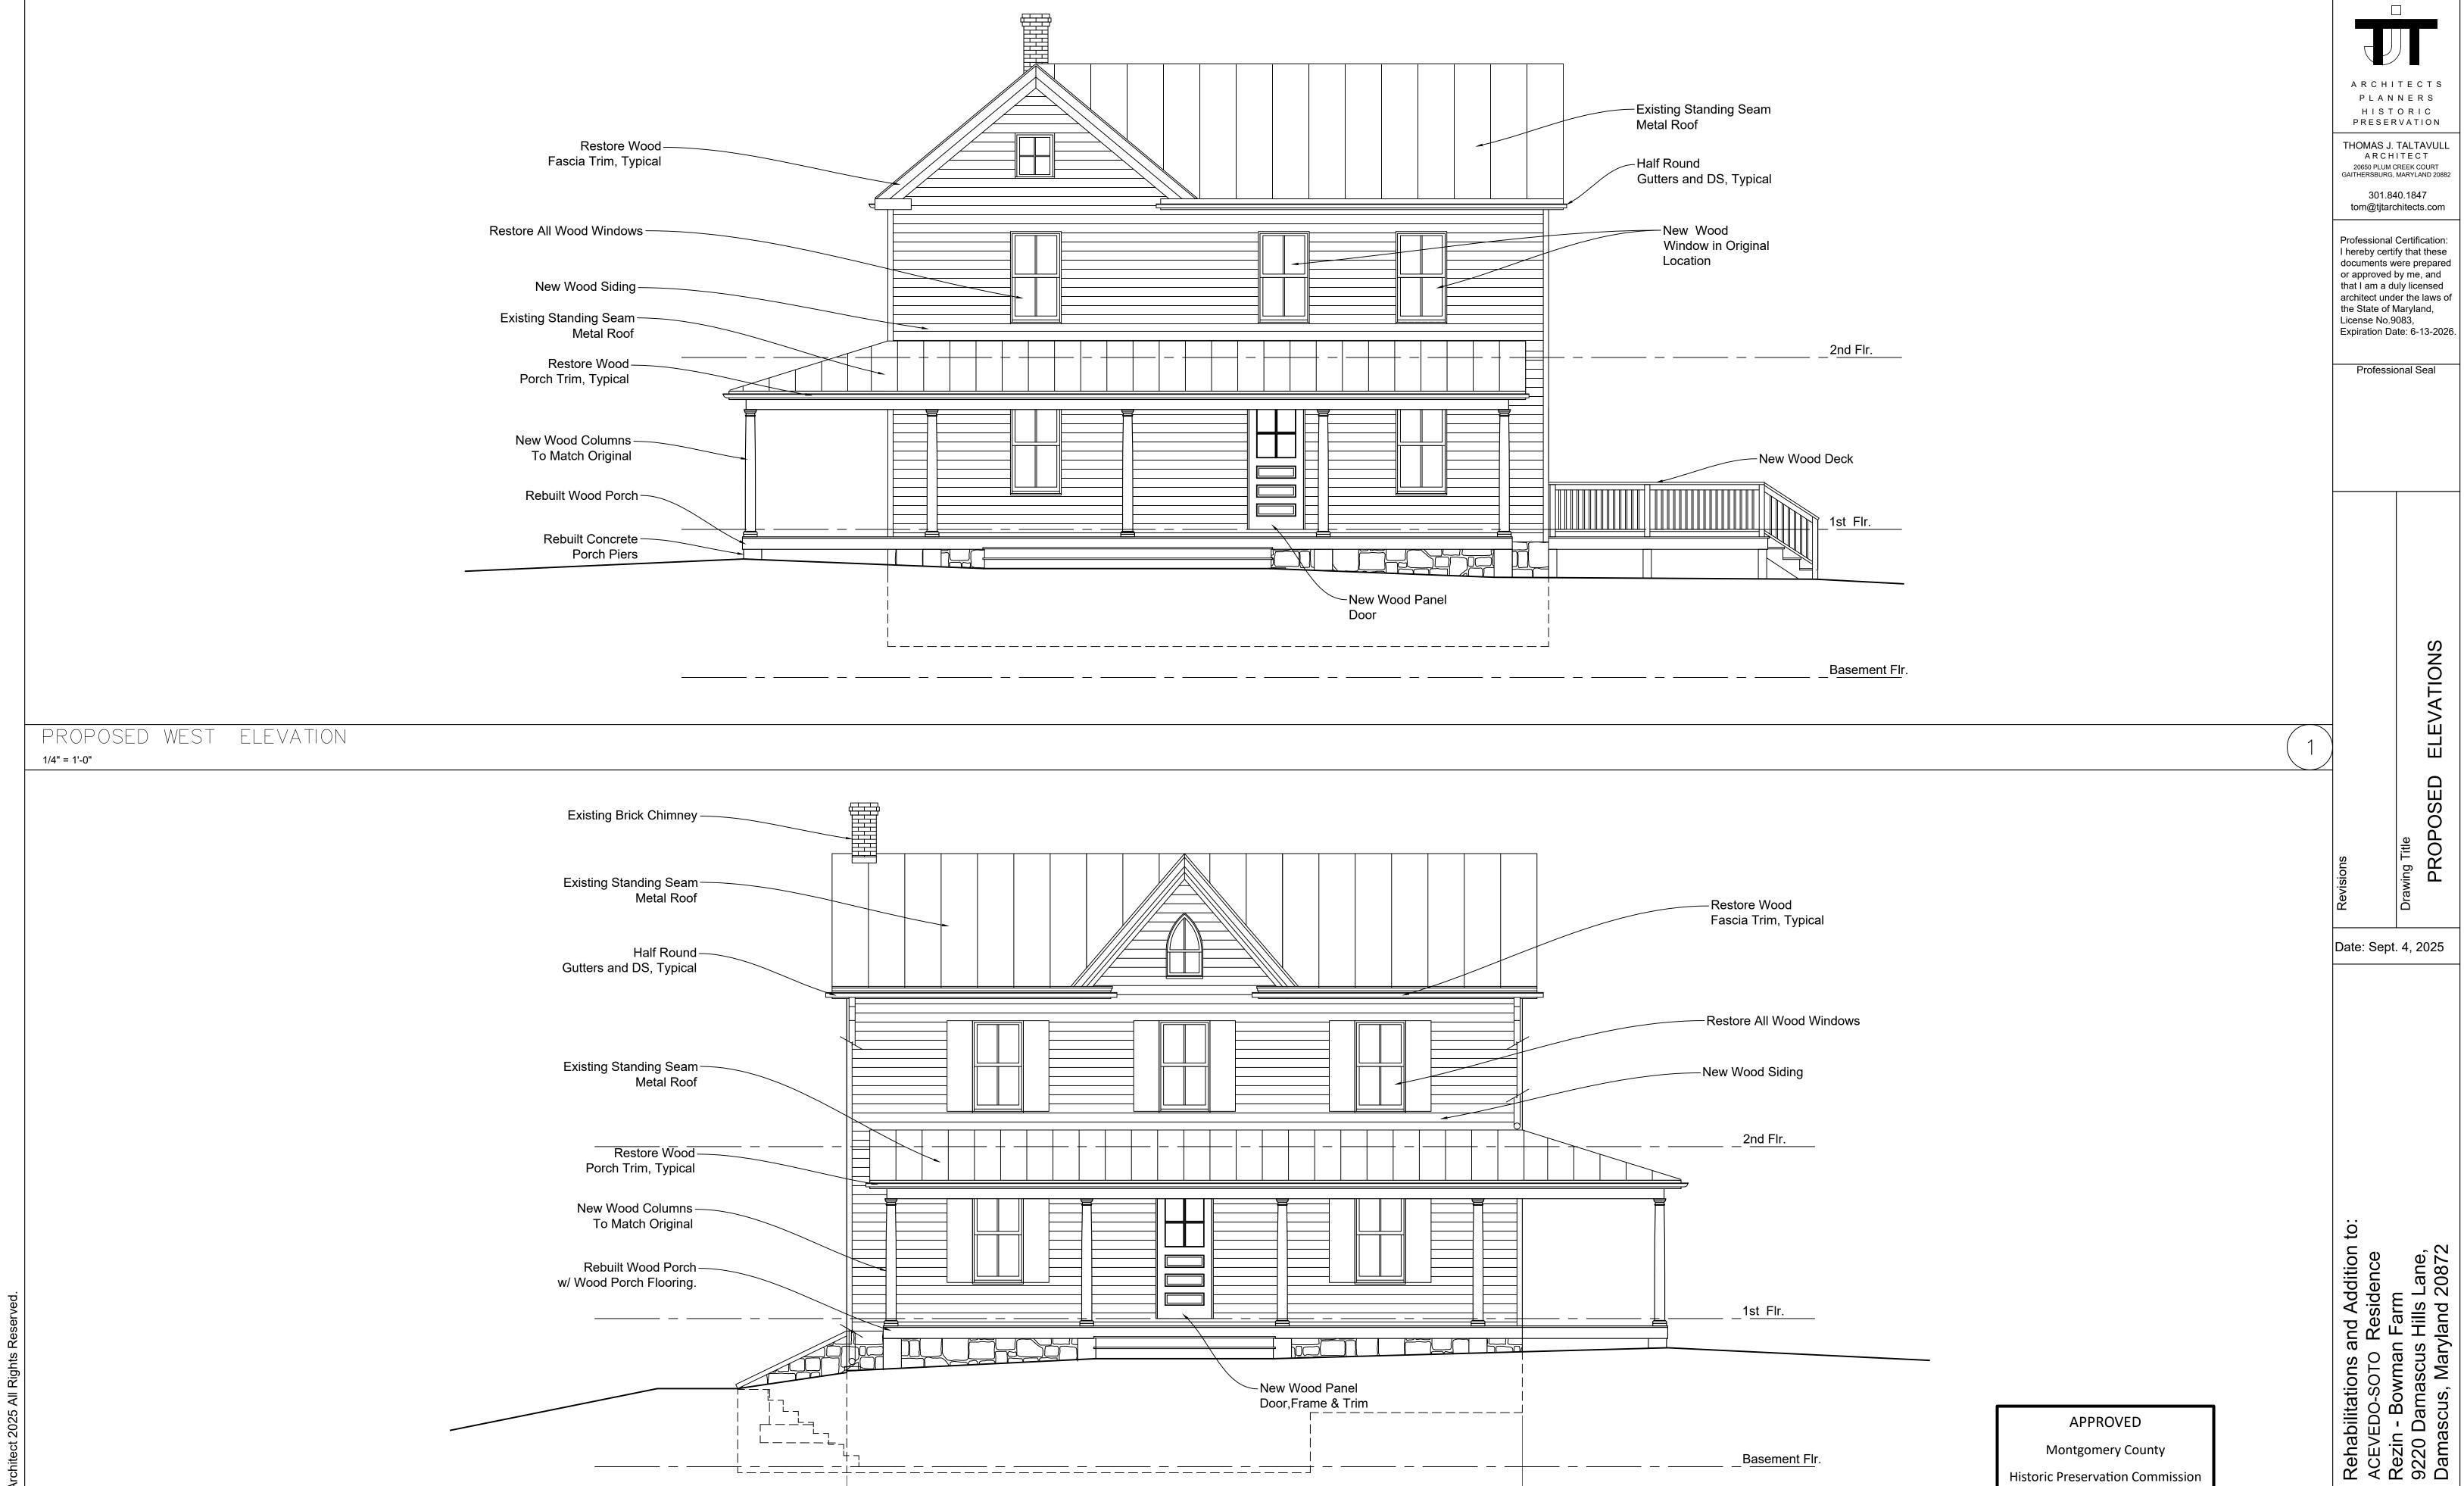


**Existing House** 

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Drawing Number

A203



New Standing Seam — Metal Shed Roofing Tie Into Existing Metal Roofing. Existing Standing Seam-Metal Roof Restore Wood-- Wood Fascia, Rake Trim Fascia Trim, Typical to Match Existing, Typical New Wood Siding -New Wood-−New Wood Vinyl Clad Window in Original Windows on Addition Location -New Fiber Cement Siding New Wood Vinyl Clad ≺ 2nd Flr. Restore Wood-Porch Trim, Typical -New Wood Vinyl Clad Doors -New Wood Vinyl Clad Doors New Wood Columns -To Match Original -New Wood Deck Rebuilt Wood Porch-\_1st\_F<u>lr.</u> Rebuilt Concrete -Porch Piers -Restore Access Panel New Concrete **Existing Stone** Foundation Wall Historic Preservation Commission Foundation to Basement Flr. be Repaired, Typical Kare Bulit REVIEWED **Existing House** New 2 Story Addition

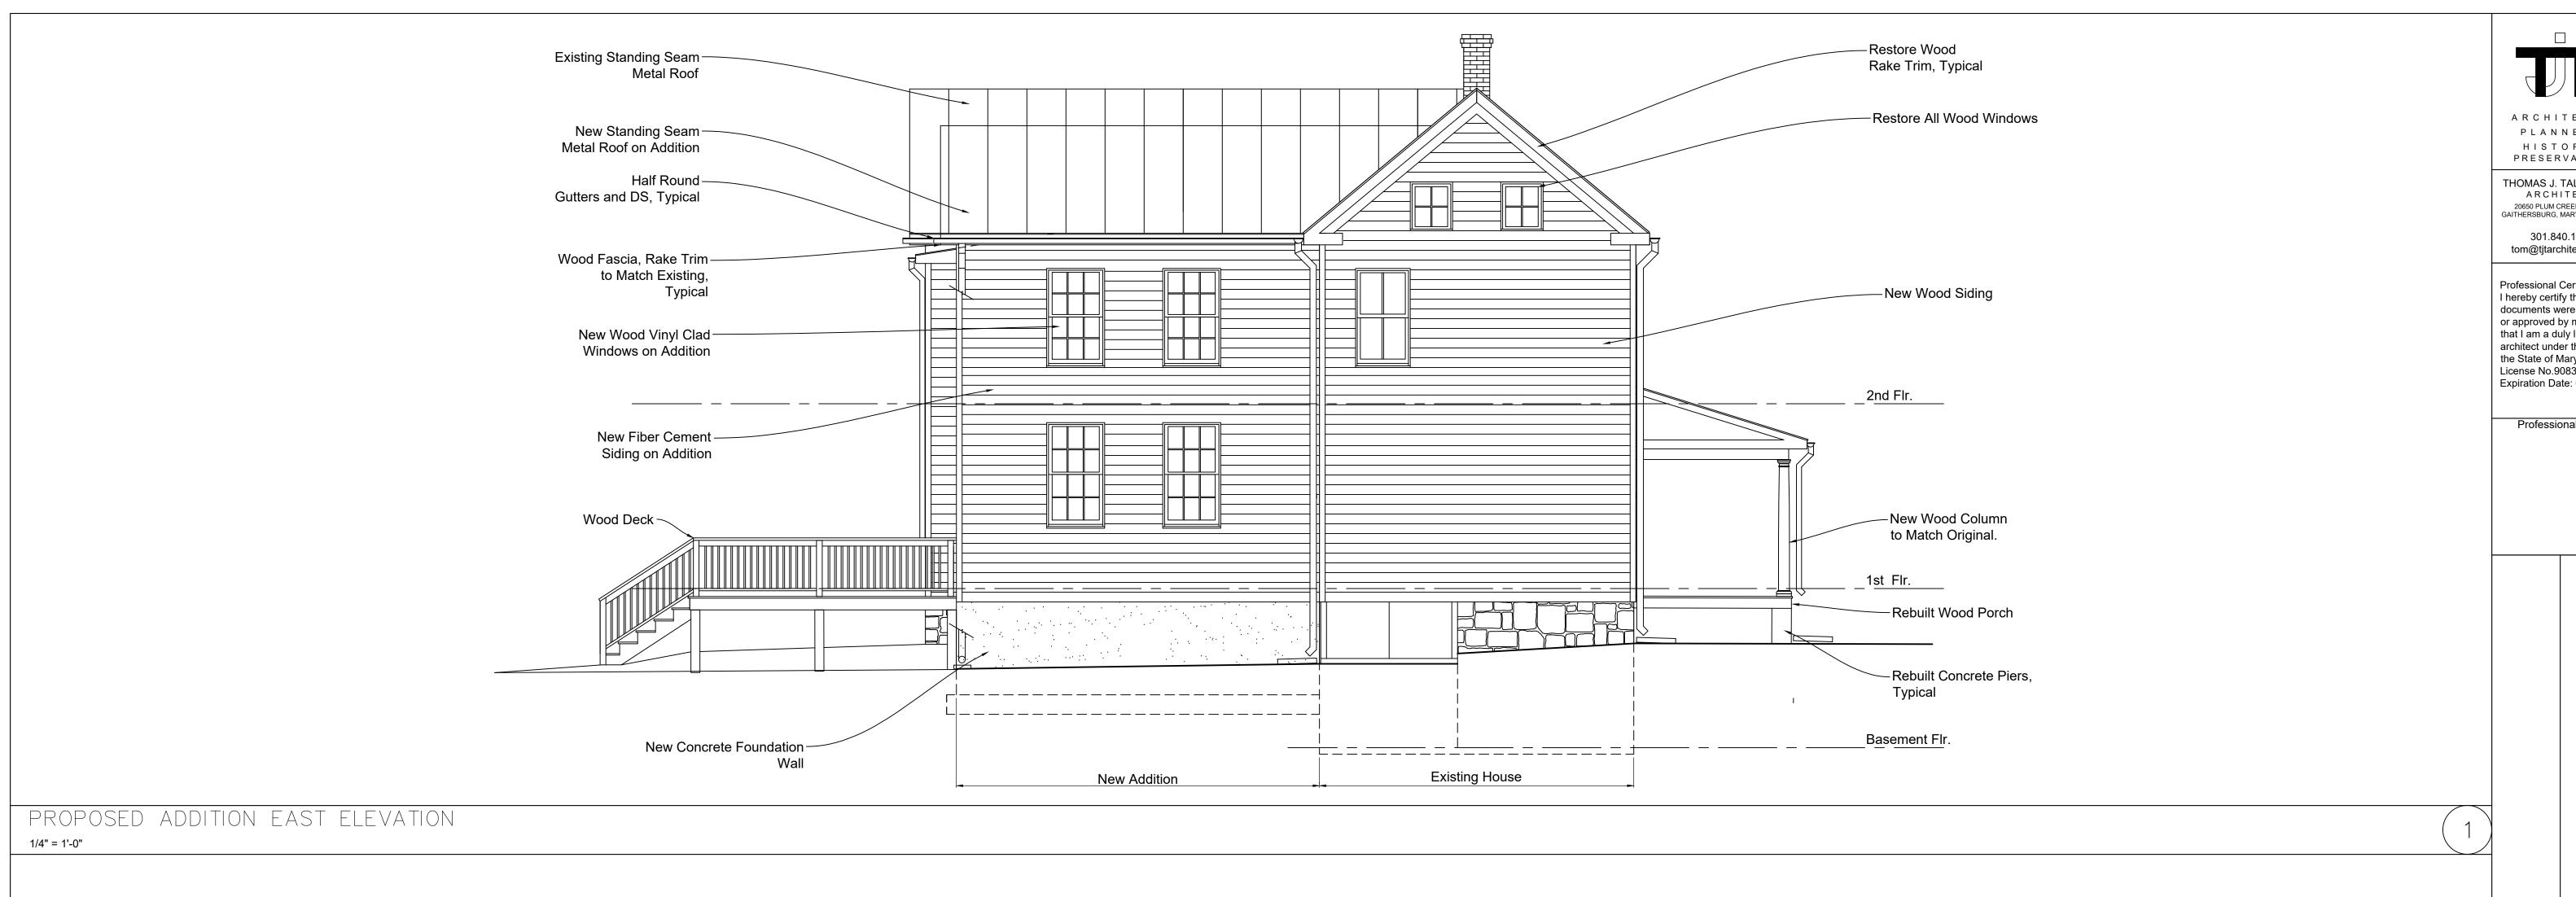ARCHITECTS PLANNERS HISTORIC PRESERVATION THOMAS J. TALTAVULL

ARCHITECT 20650 PLUM CREEK COURT GAITHERSBURG, MARYLAND 20882

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PROF

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9220 Damascus Hills Lane,
Damascus, Maryland 20872

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Drawing Number

A204



Dimensions in parentheses are in millimeters.



#### TILT-WASH DOUBLE-HUNG FULL-FRAME WINDOWS

#### **FEATURES**

#### FRAME


- ♠ Exterior outer frame members are covered with a Perma-Shield® rigid vinyl cladding, minimizing maintenance and providing an attractive appearance.
- For exceptional long-lasting\* performance, sill members are constructed with a wood core and a Fibrex® material exterior. Sill ends are protected and sealed with weather-resistant covers.
- Natural wood stops are available in pine, and prefinished white, dark bronze and black.\*\*
- A factory-applied rigid vinyl anchoring flange on the head, sill and sides of the outer frame helps secure the unit to the structure.
- **3** An extruded rigid vinyl jamb liner and fin provide a protective seal against the outer frame members. Exclusive slide wash assists make it easy to tilt the sash into wash mode position.



Unique block-and-tackle balancers feature sized-to-the-unit, rust-resistant springs that require no adjustment. Glass-reinforced nylon balancer shoes provide smooth, reliable sash operation. Sash can be removed, without tools, for drywall pass-through. Jamb liners are available in white or gray, and must be specified when ordering. Contact your Andersen supplier for details.

Weatherstrip throughout the unit provides a long-lasting, energy-efficient, weather-resistant seal. For the top and bottom rails, an encased foam material is used. The head jamb liner and sill have a rigid vinyl rib that the weatherstrip material.

rib that the weatherstri compresses against. A rail, compressible viny is used. Side jamb line weatherstrip with foam

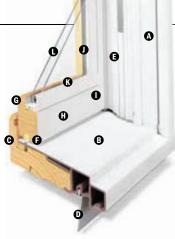

#### SASH

Wash assists make it easy to tilt the sash into wash mode.

- **6** Wood sash members are treated with a water-repellent preservative for long-lasting' protection and performance. Interior surfaces are unfinished pine. Low-maintenance prefinished white interiors are also available.
- A polyester-stabilized coat with a Flexacron® finish is electrostatically applied to penetrate all exterior surfaces for maximum protection and a lustrous finish.
- Sash joints simulate the look of traditional mortise-and-tenon construction inside and out.

#### GLASS

- In addition to stainless steel glass spacers, black or white glass spacers are now available to allow the spacer to blend in with the unit color.
- Silicone bed glazing provides superior weathertightness and durability.
- High-Performance options include:
- Low-E4® glass
- Low-E4 HeatLock® glass
- Low-E4 SmartSun™ glass
- Low-E4 SmartSun HeatLock glass
- Low-E4 Sun glass

Tempered and other glass options are available. Contact your Andersen

supplier

## REVIEWED ble translucent film helps REVIEWED glass from damage during Distressed By Laura DIPasquale at 1:30 pm, Oct 09, 2025

#### Patterned Glass

Patterned glass options are available. See page 12 for more details.

- \*Visit andersenwindows.com/warranty for details.
- \*\*Products with dark bronze and black interiors have matching exteriors.
- "Flexacron" is a registered trademark of PPG Industries, Inc.

Dimensions in parentheses are in millimeters.

Printing limitations prevent exact replication of colors and finishes. See your Andersen supplier for actual color and finish samples.

Naturally occurring variations in grain, color and texture of wood make each window one of a kind. All wood interiors are unfinished unless a finish is specified.

Distressed bronze and oil rubbed bronze are "living" finishes that will change with time and use.

#### **EXTERIOR & INTERIOR OPTIONS**

# White Canvas Sandtone Terratone Dark Forest Black



Bronze

#### **HARDWARE**



Standard Lock & Keeper

Black | Gold Dust | Stone | White

Stone is standard with natural interior units.
White comes with prefinished white interiors.
Other finishes optional.

#### **OPTIONAL HARDWARE** Sold Separately

#### ESTATE™



Antique Brass | Bright Brass Brushed Chrome | Distressed Bronze Distressed Nickel | Oil Rubbed Bronze Polished Chrome | **Satin Nickel** 

Optional Estate lock and keeper reduces the clear opening height by %/6" (14). Check with local building code officials to determine compliance with egress requirements.

#### CONTEMPORARY



Antique Brass | Black | Bright Brass Brushed Chrome | Distressed Bronze **Distressed Nickel** | Gold Dust Oil Rubbed Bronze | Polished Chrome Satin Nickel | Stone | White



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**Montgomery County** 

**Historic Preservation Commission** 



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Antique Brass Black Bright Brass Chrome Bronze Distressed Distressed Nickel

Gold Dust Oil Rubbed Polished Bronze Chrome Nickel



## Stormwatch

400 Series tilt-wash double-hung full-frame windows are available with Stormwatch® Protection. Visit andersenwindows.com/coastal for more details.

#### Performance Grade (PG) Upgrades

A high inside sill stop\* with exterior sill brackets and hidden interior brackets is available to provide additional structural support for tilt-wash windows, allowing standard, non-impact glass units to achieve higher performance grade ratings. Performance Grade (PG) ratings are more comprehensive than Design Pressure (DP) ratings for measuring product performance. For up-todate performance information of individual products, please visit andersenwindows.com. Use of this option will subtract 5/8" (15) from the clear opening height. PG Upgrade not available for 72" (1829) and 76" (1930) heights. Contact your Andersen supplier for availability.

#### **SASH OPTIONS**



#### ACCESSORIES Sold Separately

#### FRAME

#### Extension Jambs



Standard jamb depth is 4 ½" (114). Extension jambs are available in unfinished pine or prefinished white. Some sizes may be veneered.

Factory-applied and non-applied interior extension jambs are available in  $\frac{1}{10}$  (1.5) increments between  $5\frac{1}{4}$  (133) and  $7\frac{1}{8}$  (181). Extension jambs can be factory applied to either three sides (stool and apron application) or four sides (picture frame casing).

#### Pine Stool



A clear pine stool is available and ready for finishing. The tilt-wash stool is available in  $4\%_{16}$ " (116) for use in wall depths up to 5%" (133), and  $6\%_{16}$ " (167) for use in wall depths up to 7%" (181). Works with 2%" (57) and 2%" (64) casing widths.

#### HARDWARE

#### Window Opening Control Device



A recessed window opening control device is available factory applied. It limits the sash travel to less than 4" (102) when the window is first opened. Available in white, stone and black. A field-applied window opening control device kit is also available.

## STORM/INSECT SCREEN COMBINATION UNIT"



A self-storing storm window combined with an insect screen provides greater energy efficiency, while allowing ventilation when needed.

Constructed with an aluminum frame, single-pane upper and lower glass panels, and charcoal powder-coated aluminum screen mesh. Available in white, Sandtone and Terratone to match product exteriors. Canvas, dark bronze, forest green and black are available by special order.

Combination units can improve Sound Transmission Class (STC) and Outdoor Indoor Transmission Class (OITC) ratings. Ideal for projects near airports, busy roadways or other noisy environments. For example, adding a combination unit to a 400 Series till-wash double-hung (3862) unit with Low-E4® glass will improve its STC rating from 26 to 32. Contact your Andersen supplier for additional STC and OITC rating information.

#### **GLASS**

#### Andersen® Art Glass

Available for 400 Series tilt-wash transom and picture units. Andersen art glass panels come in a variety of original patterns. See art glass section starting on page 173 for more information or visit andersenwindows.com/artglass.

#### **INSECT SCREENS**

#### **Insect Screen Frames**



Full and half insect screens are available for most unit sizes. Frame colors match product exteriors. Half insect screen (shown above) allows ventilation without affecting the view through the upper sash. Not available on windows with Stormwatch Protection.

#### TruScene® Insect Screens

Andersen TruScene insect screens let in over 25% more fresh air† and provide 50% greater clarity than conventional Andersen insect screens, all while keeping out unwanted small insects.

#### **Conventional Insect Screens**

Conventional insect screens have charcoal powder-coated aluminum screen mesh.

#### GRILLES

Grilles are available in a variety of configurations and widths. For double-hung grille patterns, see page 85.

#### **EXTERIOR TRIM**

Available with Andersen exterior trim. See exterior trim section starting on page 175.

#### CAUTION:

- Painting and staining may cause damage to rigid vinyl.
- 400 Series windows in Terratone color may be painted any color lighter than Terratone color using quality oil-based or latex paint.
- Do not paint 400 Series windows in white, canvas, Sandtone, dark bronze, forest green or black exterior colors.
- Andersen does not warrant the adhesion or performance of homeowner-applied paint over vinyl or other factory-coated surfaces.
- For vinyl painting instructions and preparation, ntact your Andersen supplier.

not paint weatherstrip.

eosote-based stains should not come in ntact with Andersen products. rasive cleaners or solutions containing

asive cleaners or solutions containing rosive solvents should not be used on dersen products.

#### mation

perable area of the window.

#### **APPROVED**

Montgomery County

Historic Preservation Commission

- \*Infringes on the overall net clear opening. Unit clear operable area may
- $\ref{thm:point}$  and combination units to windows with Low-E4 Sun glass unless See your local code official for egress requirements in your area.

†TruScene insect screens let in over 25% more fresh air than standard Ande Dimensions in parentheses are in millimeters.

Kare Bulit





#### FRENCHWOOD® HINGED INSWING PATIO DOORS

#### **FEATURES**

#### FRAME

⚠ The sill is made with three-piece construction. The subsill is made of Fibrex® material, and the sill step is solid oak. The exterior sill member is made of extruded aluminum with an attractive wear-resistant, heat-baked finish in neutral gray. This combination of materials combines durability and low maintenance with excellent insulating characteristics.

All basic exterior frame members are fiberglass reinforced composite, which maintains an attractive appearance while minimizing maintenance.

• The exterior frame members are attached to a water-repellent preservative-treated wood subframe for long-lasting\* protection and performance. The subframe is grooved to accept extension jambs.

#### **PANEL**

• Panel interior surfaces are unfinished pine veneer. Unfinished maple or oak veneers are available as options. Low-maintenance prefinished white interiors are also available.

Hinged inswing operating panels are left-hand active, right-hand active or two-panel active-passive jamb hinged.



The exterior of the wood door panel is protected with a long-lasting urethane base finish available in white, Sandtone, Terratone and forest green.

• A factory-applied, one-piece compression-type rubber weatherstrip continues in one plane around the panel to provide maximum effectiveness against water and air infiltration. Corners of the weatherstrip are welded to eliminate gaps between the panel and the frame/sill shoulder.

#### Mortise-and-Tenon Joints



Mortise and tenon joints prevent panel sag and maintain smooth operation.

#### GLASS

**G** In addition to stainless steel glass spacers, black or white glass spacers are now available to allow the spacer to blend in with the unit color.

• Panels are silicone bed glazed and finished with an interior wood stop.

• High-Performance options include:

- Low-E4® tempered glass
- Low-E4 HeatLock® tempered glass
- Low-E4 SmartSun<sup>™</sup> tempered glass
- Low-E4 SmartSun HeatLock tempered glass
- Low-E4 Sun tempered glass

Additional glass options are available. Contact your Andersen supplier.

A removable translucent film helps shield the glass from damage during delivery and construction, and simplifies finishing at the job site.

Patterned glass options are available. See page 12 for more details.

#### **EXTERIOR & INTERIOR OPTIONS**

#### **EXTERIOR COLORS**



Terratone Forest


#### INTERIOR OPTIONS



Oak White

Naturally occurring variations in grain, color and texture of wood make each window one of a kind. All wood interiors are unfinished unless a finish is specified. Printing limitations prevent exact replication of colors and finishes. See your Andersen supplier for actual color and finish samples.

#### HARDWARE OPTIONS Sold Separately

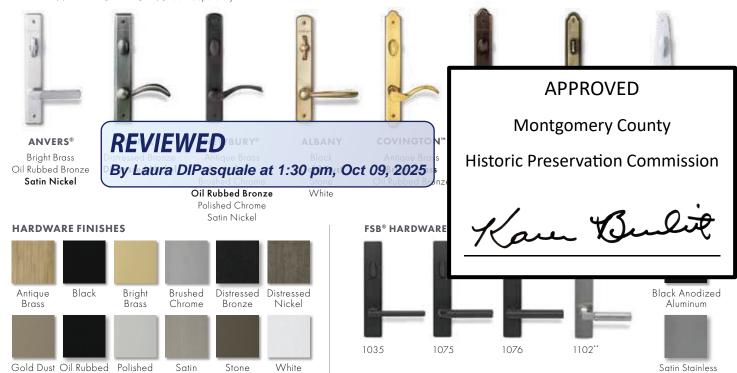

<sup>\*</sup>Visit andersenwindows.com/warranty for details.

Tribeca and Albany hardware are zinc die cast with powder-coated durable finish. Other hardware is solid forged brass.

Distressed bronze and oil rubbed bronze are "living" finishes that will change with time and use.

<sup>\*\*</sup>FSB style 1102 is not available in black anodized aluminum.

<sup>&</sup>quot;FSB" is a registered trademark of Franz Schneider Brakel GmbH & Co. Matching hinges are available for inswing patio doors.

Mix-and-match interior and exterior style and finish options are available; excludes FSB hardware.

Bright brass and satin nickel finishes feature a 10-year limited warranty.



#### Blinds-Between-the-Glass



Blinds-between-the-glass are available for select hinged patio door sizes when ordered with Low-E4® tempered glass, and a pine or prefinished white door interior and any of our four exterior colors. White 1/2" (13) aluminum slat blinds come mounted between two panes of insulated glass in a dust-free environment. Blinds are magnetically controlled and can be tilted, raised and lowered using low-profile controls. Smooth, simple operation allows for customized light and privacy control. Available in 2768, 27611, 3168, 31611, 5068, 50611, 6068, 60611, 9068 and 90611 door sizes.

#### **HARDWARE**

#### Hinges

Adjustable hinges are standard on inswing patio doors and have ball-bearing pivots for smooth, frictionless movement. Feature easy horizontal and vertical adjustment, plus quick-release for easy panel removal. The release feature is ideal for transporting large units up stairs or to other hard-to-reach areas.

Gold dust finish is standard on wood interior doors. For units with prefinished white interior, white is standard. Also available in finishes that coordinate with the hardware.

#### Multi-Point Locking System



An aluminum sill support is designed to lock into a channel under the sill and tie back into the wall. This offers support to the outermost sill section when needed. Available in a neutral gray finish.

#### \*Exterior extension jambs for hinged inswing patio doors must be applied before installing into opening.

security.

#### **ACCESSORIES** Sold Separately

#### FRAME

#### Interior Extension Jambs

Standard jamb depth is 4%/6" (116). Pine, maple and oak veneers, or prefinished white extension jambs are available in 1/16" (1.5) increments between 5 1/16" (129) and 7 1/8" (181). Interior extension jambs on inswing units will restrict the full opening of the door.

#### Exterior Extension Jambs'

Exterior extension jamb system is available for the following wall thicknesses: 5 1/4" (133), 69/16" (167) and 7% (192). In walls over 41/2" (114), the exterior sill extender and exterior extension jamb system allows the unit to be installed flush to the interior, so the hinged doors will open flat against the interior wall. Color matched to the exterior of the finished unit, this system provides a low-maintenance, finished exterior appearance. An extended double-insect screen track is available for jamb-hinged doors that require gliding insect screens. Exterior extension iamb kits are available with or without the double-insect screen track.

#### Threshold



A maple or oak threshold is available for finishing the interior of the sill.

#### Ramped Sill Insert



Ramped sills in maple or oak provide smooth transition from interior to exterior. Ramped sill cannot be used with insect screens. Check with local and federal

#### **HARDWARE**

#### **Exterior Keyed Lock**



A six-pin key cylinder lock is available in styles and finishes that coordinate with the hardware. This lock allows the hinged patio door to be locked and unlocked from the exterior.

#### Handle Extension



Extends interior door handle an additional 1" (25) from the door interior panel to accommodate blinds or shades. Kit includes

one handle extender and spindle. A second extender may be added to increase the length an additional 1" (25) to a 2" (51) total extension. Extenders are available in finishes that coordinate with hardware.

#### Strike Plate Extensions

Bright brass, antique brass, polished chrome, oil rubbed bronze, brushed chrome and satin nickel strike plate extensions are available for the following wall thicknesses:  $5\frac{1}{4}$ " (133),  $6\frac{9}{16}$ " (167),  $7\frac{1}{8}$ " (181) and  $7\frac{9}{16}$ " (192).

#### Construction Lock



This hardware can be used on all Andersen® hinged doors to help secure the structure during the construction phase of the project. It features an undersized escutcheon plate, which makes on-site finishing easier.

#### **INSECT SCREENS**

All insect screens have a long-lasting "fiberglass screen mesh with a charcoal finish, and frames are color matched to the exterior of the door unless otherwise specified.

#### Gliding Insect Screen

Available for all twoand three-panel doors. Features Delrin® material injection-molded bottom rollers with self-contained leveling adjusters.



A double insect screen track is required for two-panel active-passive or passive-active doors. Gliding insect screens are not available for 4' (1219)-wide doors.

#### **Double-Insect Screen Track**



An extended insect screen track is required for two-panel active-passive or passive-active hinged doors that use gliding insect screens.

#### Hinged Insect Screens

Available for single-panel hinged doors, and two-panel active-passive or passiveactive doors.



#### GRILLES

Available in a variety of configurations and widths. See page 155.

#### F X I F D I O I D I N



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GLASS

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Anders
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on page 1/3 for more information or visit andersenwindows.com/artglass.

or black exterior colors.

See page 143 for a complete list of painting, staining and cleaning cautions.

"Delrin" is a registered trademark of E.I. du Pont de Nemours and Company.

Andersen patio doors are not intended for use as entrance doors.

Dimensions in parentheses are in millimeters.

<sup>\*\*</sup>Visit andersenwindows.com/warranty for details.

#### Hardie® Plank

Thickness 5/16 in
Length 12 ft planks

Select Cedarmill® & Smooth

Width 8.25 in

Exposure 7 in

#### Hardie® Panel

Thickness 5/16 in

#### Select Cedarmill® & Smooth

**Size** 4 ft x 10 ft


#### Hardie® Shingle

Thickness 1/4 in Length 48 in

Straight Edge Panel Staggered Edge Panel

Height 15.25 in Height 15.25 in

**Exposure** 7 in **Exposure** 6 in

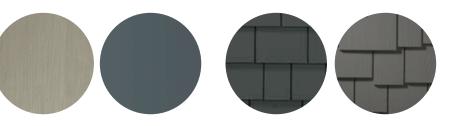

#### Hardie® Soffit

Thickness 1/4 in

#### **Vented Smooth**

**Width** 12 in 16 in 24 in

**Length** 12 ft 12 ft 8 ft

#### **Non-Vented Smooth**

**Width** 12 in 16 in 24 in

**Length** 12 ft 12 ft 8 ft

#### Hardie® Trim

Length 12 ft

4/4 Smooth

Thickness .75 in

**Width** 3.5 in\* 5.5 in 7.25 in 9.25 in\* 11.25 in

#### 5/4 Smooth

Thickness 1 in

**Width** 3.5 in 4.5 in 5.5 in 7.25 in 9.25 in\* 11.25 in

\*This size is only available in Arctic White





#### **Batten Boards**

#### Smooth

Thickness .75 in

Length 12 ft. boards

#### Width

## REVIEWED

By Laura DIPasquale at 1:30 pm, Oct 09, 2025

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**Montgomery County** 

**Historic Preservation Commission** 

Kare Bulit

## Hardie® Plank



| _           |      | •    |       |    |
|-------------|------|------|-------|----|
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|             |      |      |       |    |

| Select Cedarmill® & Smooth |         | Thickness 5/16 in Length 12 ft planks |         |         |          |          |
|----------------------------|---------|---------------------------------------|---------|---------|----------|----------|
| Width                      | 5.25 in | 6.25 in                               | 7.25 in | 8.25 in | 9.25 in* | 12 in*   |
| Exposure                   | 4 in    | 5 in                                  | 6 in    | 7 in    | 8 in     | 10.75 in |
| Prime<br>Pcs/Pallet        | 360     | 308                                   | 252     | 230     | 190      | 152      |
| ColorPlus®<br>Pcs/Pallet   | 324     | 280                                   | 252     | 210     | _        | _        |
| Pcs/Sq.                    | 25.0    | 20.0                                  | 16.7    | 14.3    | 12.5     | 9.3      |



## Select Cedarmill®

| Width                                | 5.25 in | 6.25 in | 7.25 in | 8.25 in |
|--------------------------------------|---------|---------|---------|---------|
| Statement<br>Collection <sup>™</sup> |         |         |         | •       |
| Dream<br>Collection <sup>™</sup>     | •       | •       | •       | •       |
| Prime                                |         | •       | •       | •       |





Beaded Select Cedarmill®

#### **Beaded Select Cedarmill®**

**Beaded Smooth** 

Width

| Width                    | 8.25 in |  |
|--------------------------|---------|--|
| Exposure                 | 7 in    |  |
| ColorPlus®<br>Pcs/Pallet | 210     |  |

By Laura DIPasquale at 1:30 pm, Oct 09, 2025




**Collection**™ **Dream Collection**™ **Prime** 

**APPROVED** 

8.25 in

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By Laura DIPasquale at 1:30 pm, Oct 09, 2025

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#### 1" FIELD-LOK™

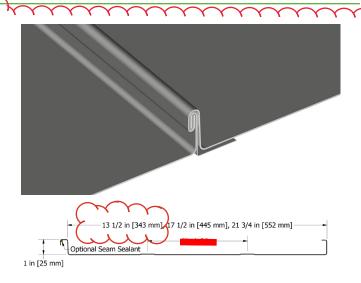SKU: FLL135, FLL175, FLL217, FLL999

#### **MATERIAL**

.032, .040 aluminum

24, 22\* ga. metallic coated steel

24 ga. 55% Al-Zn alloy coated steel with acrylic coating

16, 20 oz. copper\*^

.7 mm zinc\*^

.0197 classic & tin matte stainless steel\*^

^Inquire for available panel widths

#### PANEL SPECS

Coverage: 13½", 1

Custom widths available\* (Plank ribs standard, specify without

ribs or striations)

Minimum Length: 4'-0"

Seam Height: 1"

#### **AVAILABLE**

Tapered, Stretch Curved (Convex)

Factory panel pre-notching available.

Contact ATAS for specifics.

#### **TEXTURE**

Smooth or St d (available in 24 ga. steel & .032 aluminum)

#### MINIMUM SLOPE

2:12 depending on climate conditions

www.atas.com/fll

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By Laura DIPasquale at 1:30 pm, Oct 09, 2025


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Shank Notes: #1 - for fascia, #6 - for ogee or crown moulding, fits contour, #10- for fascia, #11 - for nailing to rafter, #12 - for nailing to sheeting, #25 - for nailing to sheeting, #30 - adjustable pitch for angled end rafters and fascia

## **Round Wood Columns**



## **Indoor and Outdoor Wooden Columns**

We offer columns ranging from the timeless architectural orders, all-tapered, plain or fluted styles. Columns are available in paint grade, finger-jointed wood species (pine, redwood, or cedar) for interior or exterior applications or stain grade woods for interior applications. Our stock wood columns are available in a finger-jointed pine. We can factory prime columns to be painted and apply an asphaltum coating to the interior of the column for added protection for columns to be installed outside.
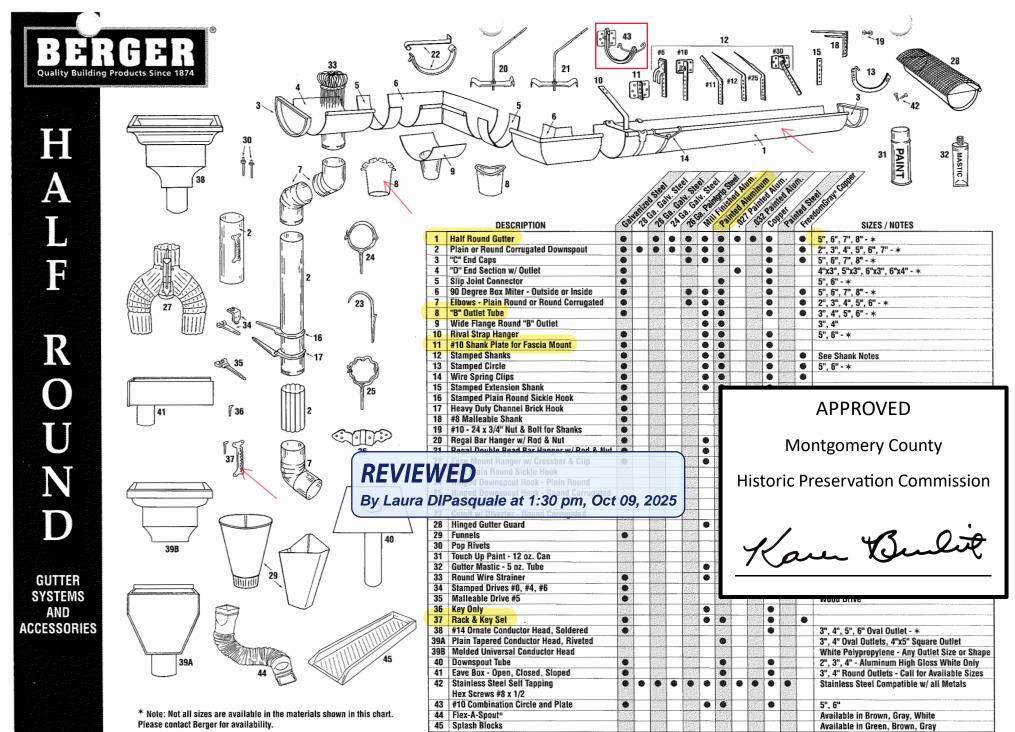
## Search for the product at a nearby retailer

Enter Zip Code

25 Miles

SEARCH





#### Stock Wood Column Sizes

| $\alpha$ | Diameter | Lengths    |
|----------|----------|------------|
|          | 6"       | 8, 10'     |
|          | 8"       | 8, 10, 12' |
|          | 10"      | 8, 10, 12' |
|          | 12"      | 8, 10, 12' |

Larger Sizes and Different Wood Species Available for Special Order.

Please visit the information center for the custom wood quote form.

## What you need to know before ordering a wood column:

The height of the column includes cap and base.

## **REVIEWED**

By Laura DIPasquale at 1:30 pm, Oct 09, 2025

Store columns in a dry, well-ventilated area.

For exterior applications: The interior of the column asphaltum coating to protect against moisture. The up the inside bottom of the column shaft.

Wood columns require ventilation at the top and bottom.

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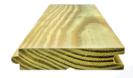
Karen Buli



#### **PORCH FLOORING**

# ELEVATE YOUR OUTDOOR ENTRANCE

Porches add comfort, distinction, and value to any home and act as a natural extension of the family living space. Culpeper porch flooring is a superior choice for enhancing this architectural icon.



1x4 T&G PORCH FLOORING

All profiles available in: 2x4, 2x6, 2x8, 2x10



1x4 T&G PORCH FLOORING



5/4x4 T&G PORCH FLOORING

## **CULPEPER TONGUE AND GROOVE**

Culpeper tongue and groove boards consist of a "tongue" on one side and the interlocking "groove" on the other for easy installation. The tongue and groove style is a popular choice for porches, covered patio ceilings, wallcoverings, and siding.

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By Laura DIPasquale at 1:29 pm, Oct 09, 2025



2x6 SQUARE EDGE

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## **CUSTOM MILLING**

Along with Culpeper porch flooring and Culpeper tongue & groove, we offer a full range of custom milled southern pine products.









