## 30/13-00B 4710 Waverly Avenue (Garrett Park Historic)

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4710 Waverly Ave. front elevation from public right of way




4710 Waverly Ave. from 4709 Waverly Ave.



4710 Waverly Ave. rear elevation from own private yard



4710 Waverly Ave. from 4711 Waverly Ave.

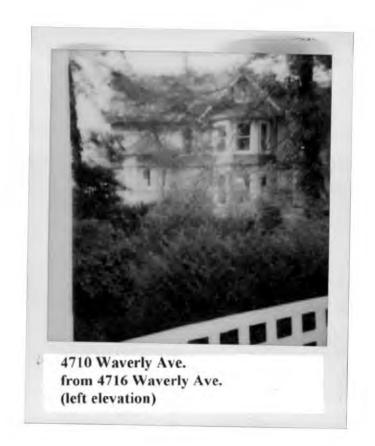



4710 Waverly Ave. from 4716 Waverly Ave. (left elevation)



4710 Waverly Ave. right elevation from public right of way



4710 Waverly Ave. from 4702 Waverly Ave.



4710 Waverly Ave. rear elevation from own private yard



4710 Waverly Ave. right elevation from own private yard

#### August, 1888.

### Scientific American, Architects and Builders Edition.

#### A RESIDENCE FOR \$2,800.

Mr. Hillson, of Bridgeport, Coun., has built lately on plorado Avenue a very attractive residence, of which s give a perspective, with corresponding floor plans. ar engraving was made direct from a photograph of te house specially taken for the SCIENTIFIC AMERI-

IN. The floor plans are excellent. The house conins all the modern imovements. The princid feature of the exterior the bay window, which ms up two stories and ses into a tower.

There is a cellar under hole of house, with fountion of stone and undernning of brick.

The first and second stos are clapboarded, and we a band of cut shines around top of first ory windows.

The roof is covered with e best quality of Bangor ste.

There are ten rooms, four leach floor and two in e attic.

The principal rooms on st floor are separated by ding doors.

The parlor and sitting om have open fireplaces Ith tile hearths and very indsome slate mantels, th beveled plate glass irrors, etc.

Kitchen is neatly wainoted, contains sink and ash trays, all neatly cased ) same as wainscot. Supled with hot and cold ater.

an outside entrance. The dining room has two china closets, which are

fitted up with shelves and drawers in a most complete manner.

The hall is large and has a very handsome staircase, with an elegant 8×8 carved newel, with turned balusters in cherry. The door and window casings are leaded,

There is an entrance to cellar from kitchen, as well as and rail, all put up in a workmanlike manner. This staircase is a very easy one, with a 10" tread and 7" rise. The bed rooms on second floor are large and provided with closets and clothes presses.

The bath room is provided with all the conveniences. The inside trim throughout is of whitewood, finished

> and turned sink angle blocks are provided at angles of casings.

> The ceilings of the principal rooms are neatly corniced and paneled; ornamental center pieces are provided.

The house is piped for gas.


This house cost \$2,800 to build, and is a very commodious structure for that price.

THOSE who cannot enjoy the luxury of an outside sun blind can extemporize a very good substitute by simply lowering the upper half of the window frame and turning the inside roller blind outside. This not only screens the window, but creates a strong draught between the panes and the linen, and thus absolutely makes the glass cold. If there is any wind the blind can be kept steady by drawing in the cord and tassel and shutting the lower half of the window-frame tight down upon it.


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A RESIDENCE FOR \$2,800.

#### **Changes to Plans for**

#### 4710 Waverly Avenue, Garrett Park, MD, 20896-0424
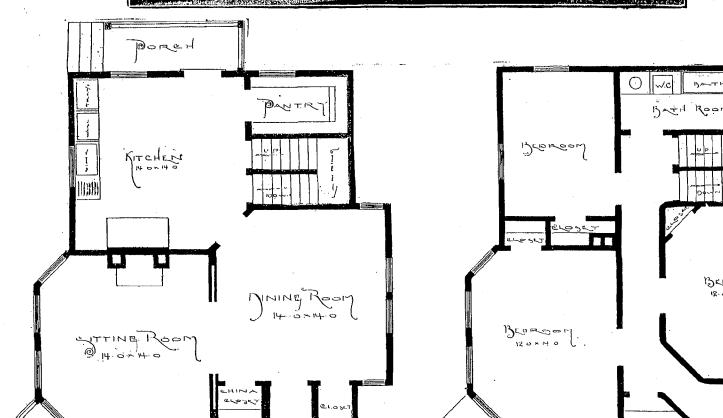
#### Permit Number: 232765

- 1. <u>Drawing 1. Basement Plan</u>: Bulldozer inadvertently removed dirt from portion of area to be left remaining. Structural engineer Jolles & McKenzie visited the site and established a revised structural plan for footings adjoining existing house (drawing dated March 16, 2001). See also Drawing 6 label F.
- 2. <u>Drawings 1 and 2. Basement, First and Second Floor Plans</u>: Removed elevator shaft. Moved staircase to rear of house.
- 3. <u>Drawings 2, 3 and 4. First Floor Plan and Front and Right Elevations</u>: Removed bathroom and corrected omission by architect of entrance hall off porch joining old house to new house.
- 4. <u>Drawing 2. First Floor Plan</u>: Moved bathroom to pantry area (left side of first floor plan).

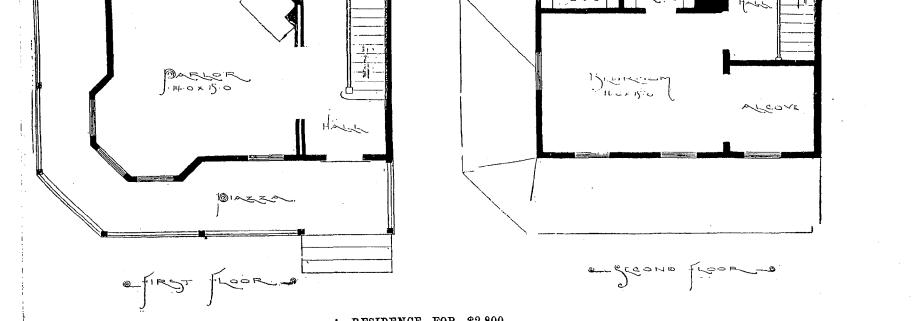5. <u>Drawings 6, 7 and 7a. Structure, Third Floor and Roofing Plans</u>: The architect's roof plan was incorrect. The ridge plate should not have been used with the knee wall, which began to move. The structural engineer from Jolles and McKenzie visited the site and established revised structural plan for a supported roof beam with supports down to the footings in the basement floor (drawing dated January 4, 2002).

#### 4710 Waverly Avenue Garrett Park, MD 20896-0424

December 28, 2001

Ms. Michelle Naru Montgomery County Department of Park and Planning M-NCPPC 8787 Georgia Avenue Silver Spring, MD 20910-3760

un Commit

Reference: Case Number 30/13-00B

Dear Michelle:

1 am following up (belatedly) on our telephone conversation before Thanksgiving.

The purpose of this letter is to obtain permission for a small modification to my architect's drawings for my house at 4710 Waverly Avenue in Garrett Park. His drawing's did not match my approved, preliminary drawings, and I would like to re-instate the floor plan I originally intended.

The background to this project is that my husband and I presented to the Montgomery County Historic Preservation Commission on May 10, 2000, after reviewing our drawings and plans with you. You had prepared presentation material as a Commission Staff Report for HAWP review at the May 10 meeting. The Commission gave their approval to the project that evening. However, they asked that the preliminary drawings I had done be replaced with an architect's drawings.

The feature to be modified (as shown on the architect's drawings) is the short, diagonal passage way that joins the old house with the new addition on the right side. On my preliminary drawings as approved by the Commission on May 10, I had shown a passage between old and new, but the architect left this off his drawings. I did not catch the omission before you stamped them for approval on October 13, 2000.

For more detail, please see Circle 11 of my preliminary drawings in your attachment to the Commission Staff Report for HAWP review (copy attached). During the discussion on May 10, the Commission stated that the wrap-around porch from the front (north) side to the right (west) side should be eliminated and replaced with a side porch not connected to the existing front (north) porch. It was agreed you would work with me to define the new porch on the right side. The Commission did not ask that the interior floor plan be changed, nor did you and I discuss any need to change the interior floor plan. Page Two Ms. Michelle Naru December 17, 2001

Unfortunately, when he redrew the side porch, the architect changed the interior floor plan to remove the connection between old and new, eliminating a flow I consider essential. This is the problem I would now like corrected on the architect's drawings. I am attaching a reduced copy of the architect's version of the floor plan, without the connecting passage.

As I say, the Commission approved my preliminary drawing which included an interior connecting passage way. On the copy of Circle 11 attached, note the new 6'7" wall (highlighted in yellow).


I am requesting permission for the approved architect's drawing to be modified to reinstate the connecting passage, and to allow the double entry doors from the porch to be in this 6'7" wall. This small area will serve as a small entrance hall as well as provide passage between the old and the new parts of the house.


The exterior is not very different from the front elevation except to change the door shown on the architect's drawing to a window, and to add the angled perspective of the double doors in the re-instated 6'7" wall. On the right side elevation, the double doors added to this wall also have an angled perspective. Modified copies of his drawings are attached, as are copies of Circles 13 and 15 as approved by the Commission on May 10, 2000.


If you have any questions, please call me at 301-942-1030. Thank you in advance for your early review.

Sincerely,

Pamela N. Morgan

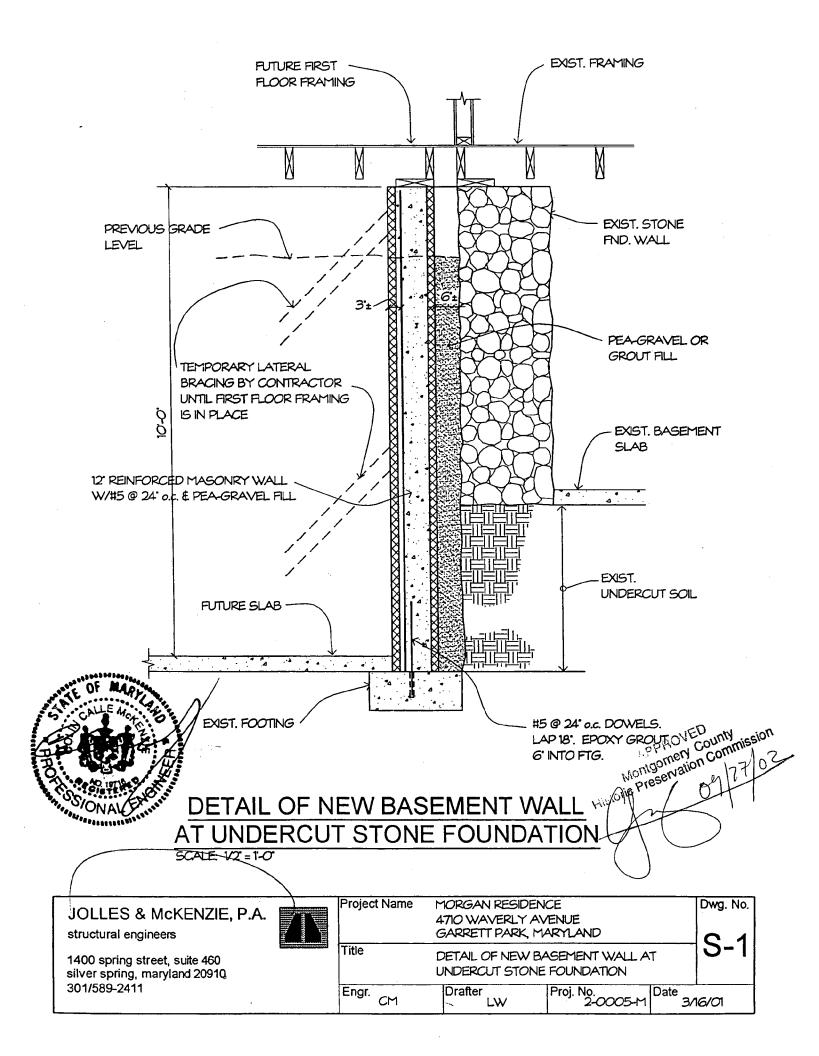

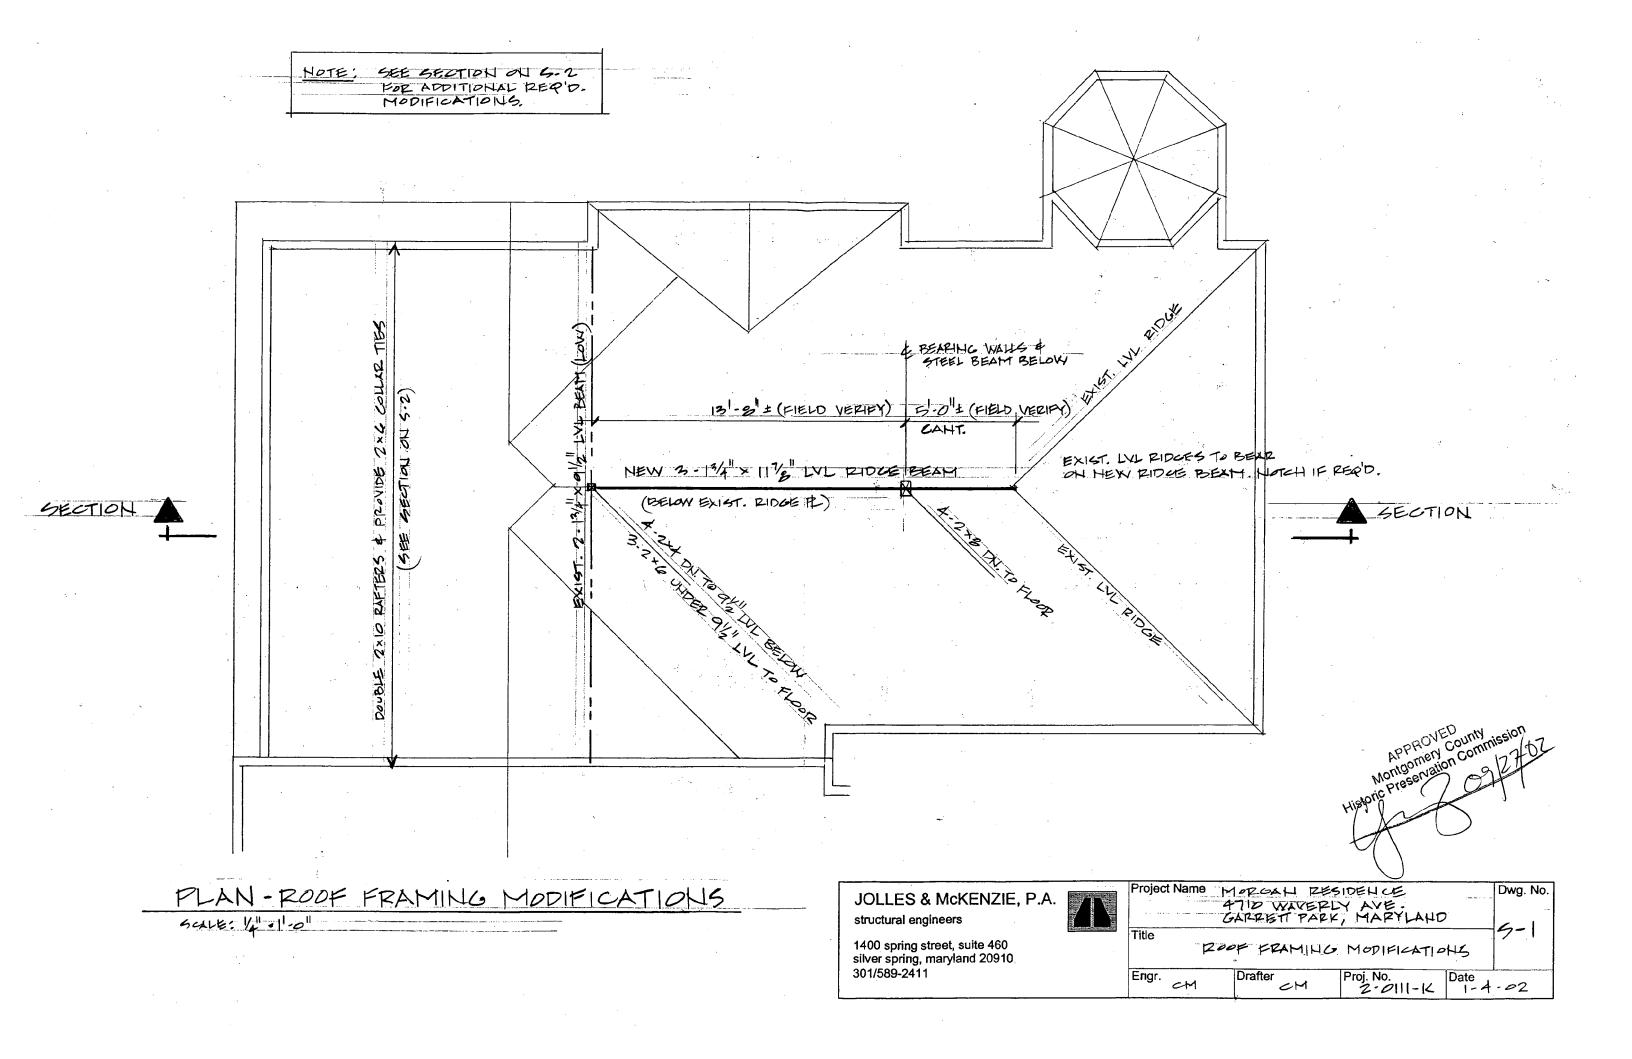


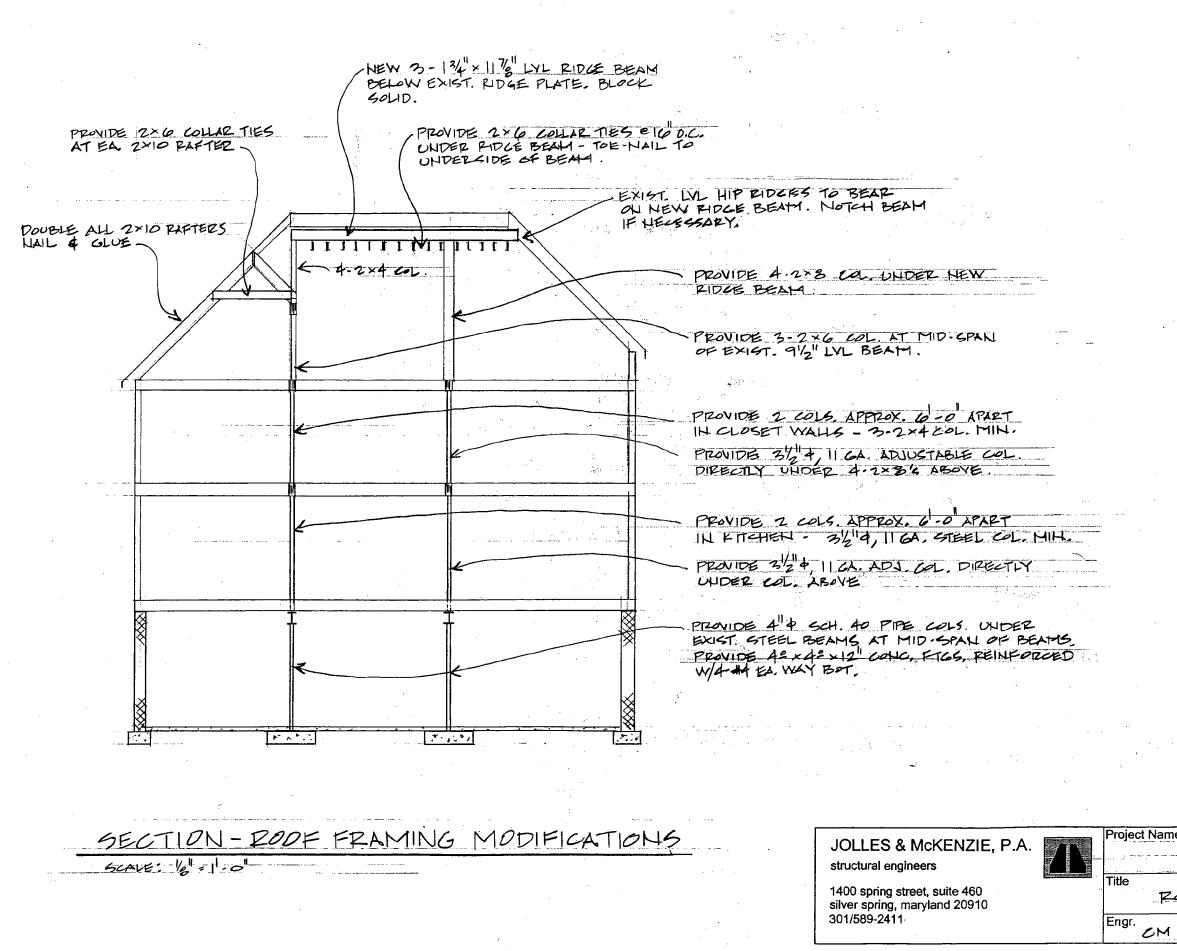

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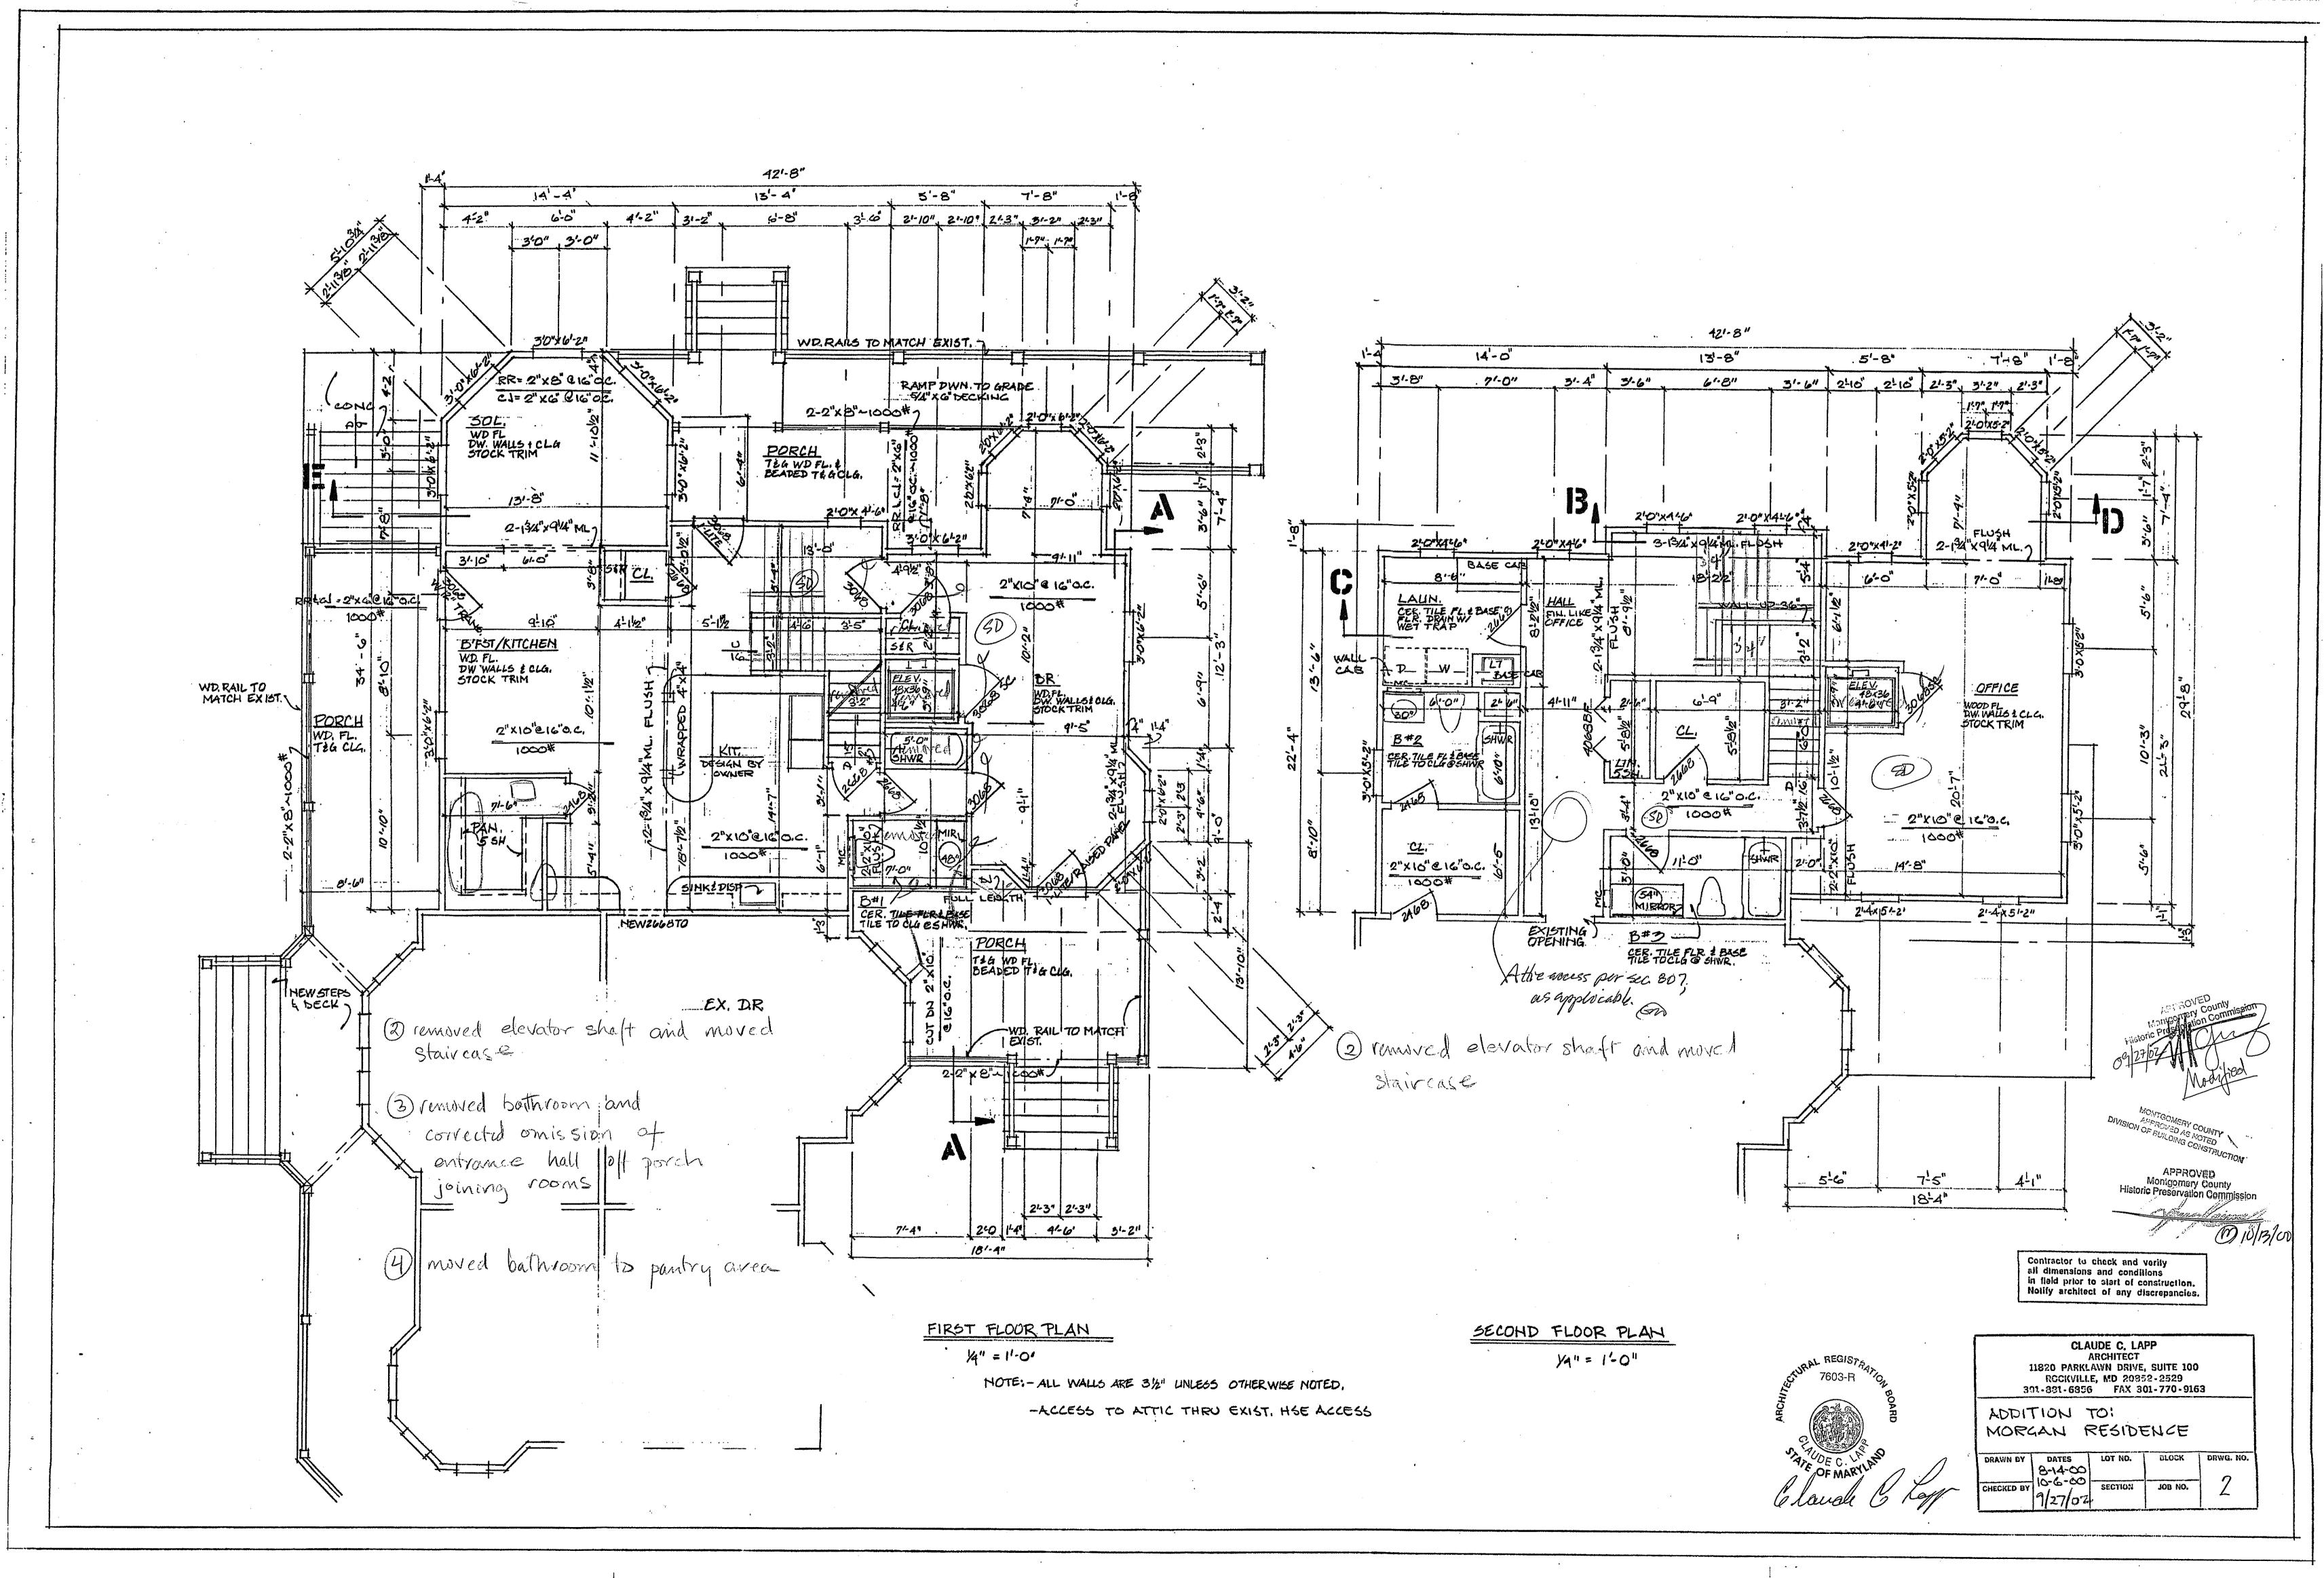



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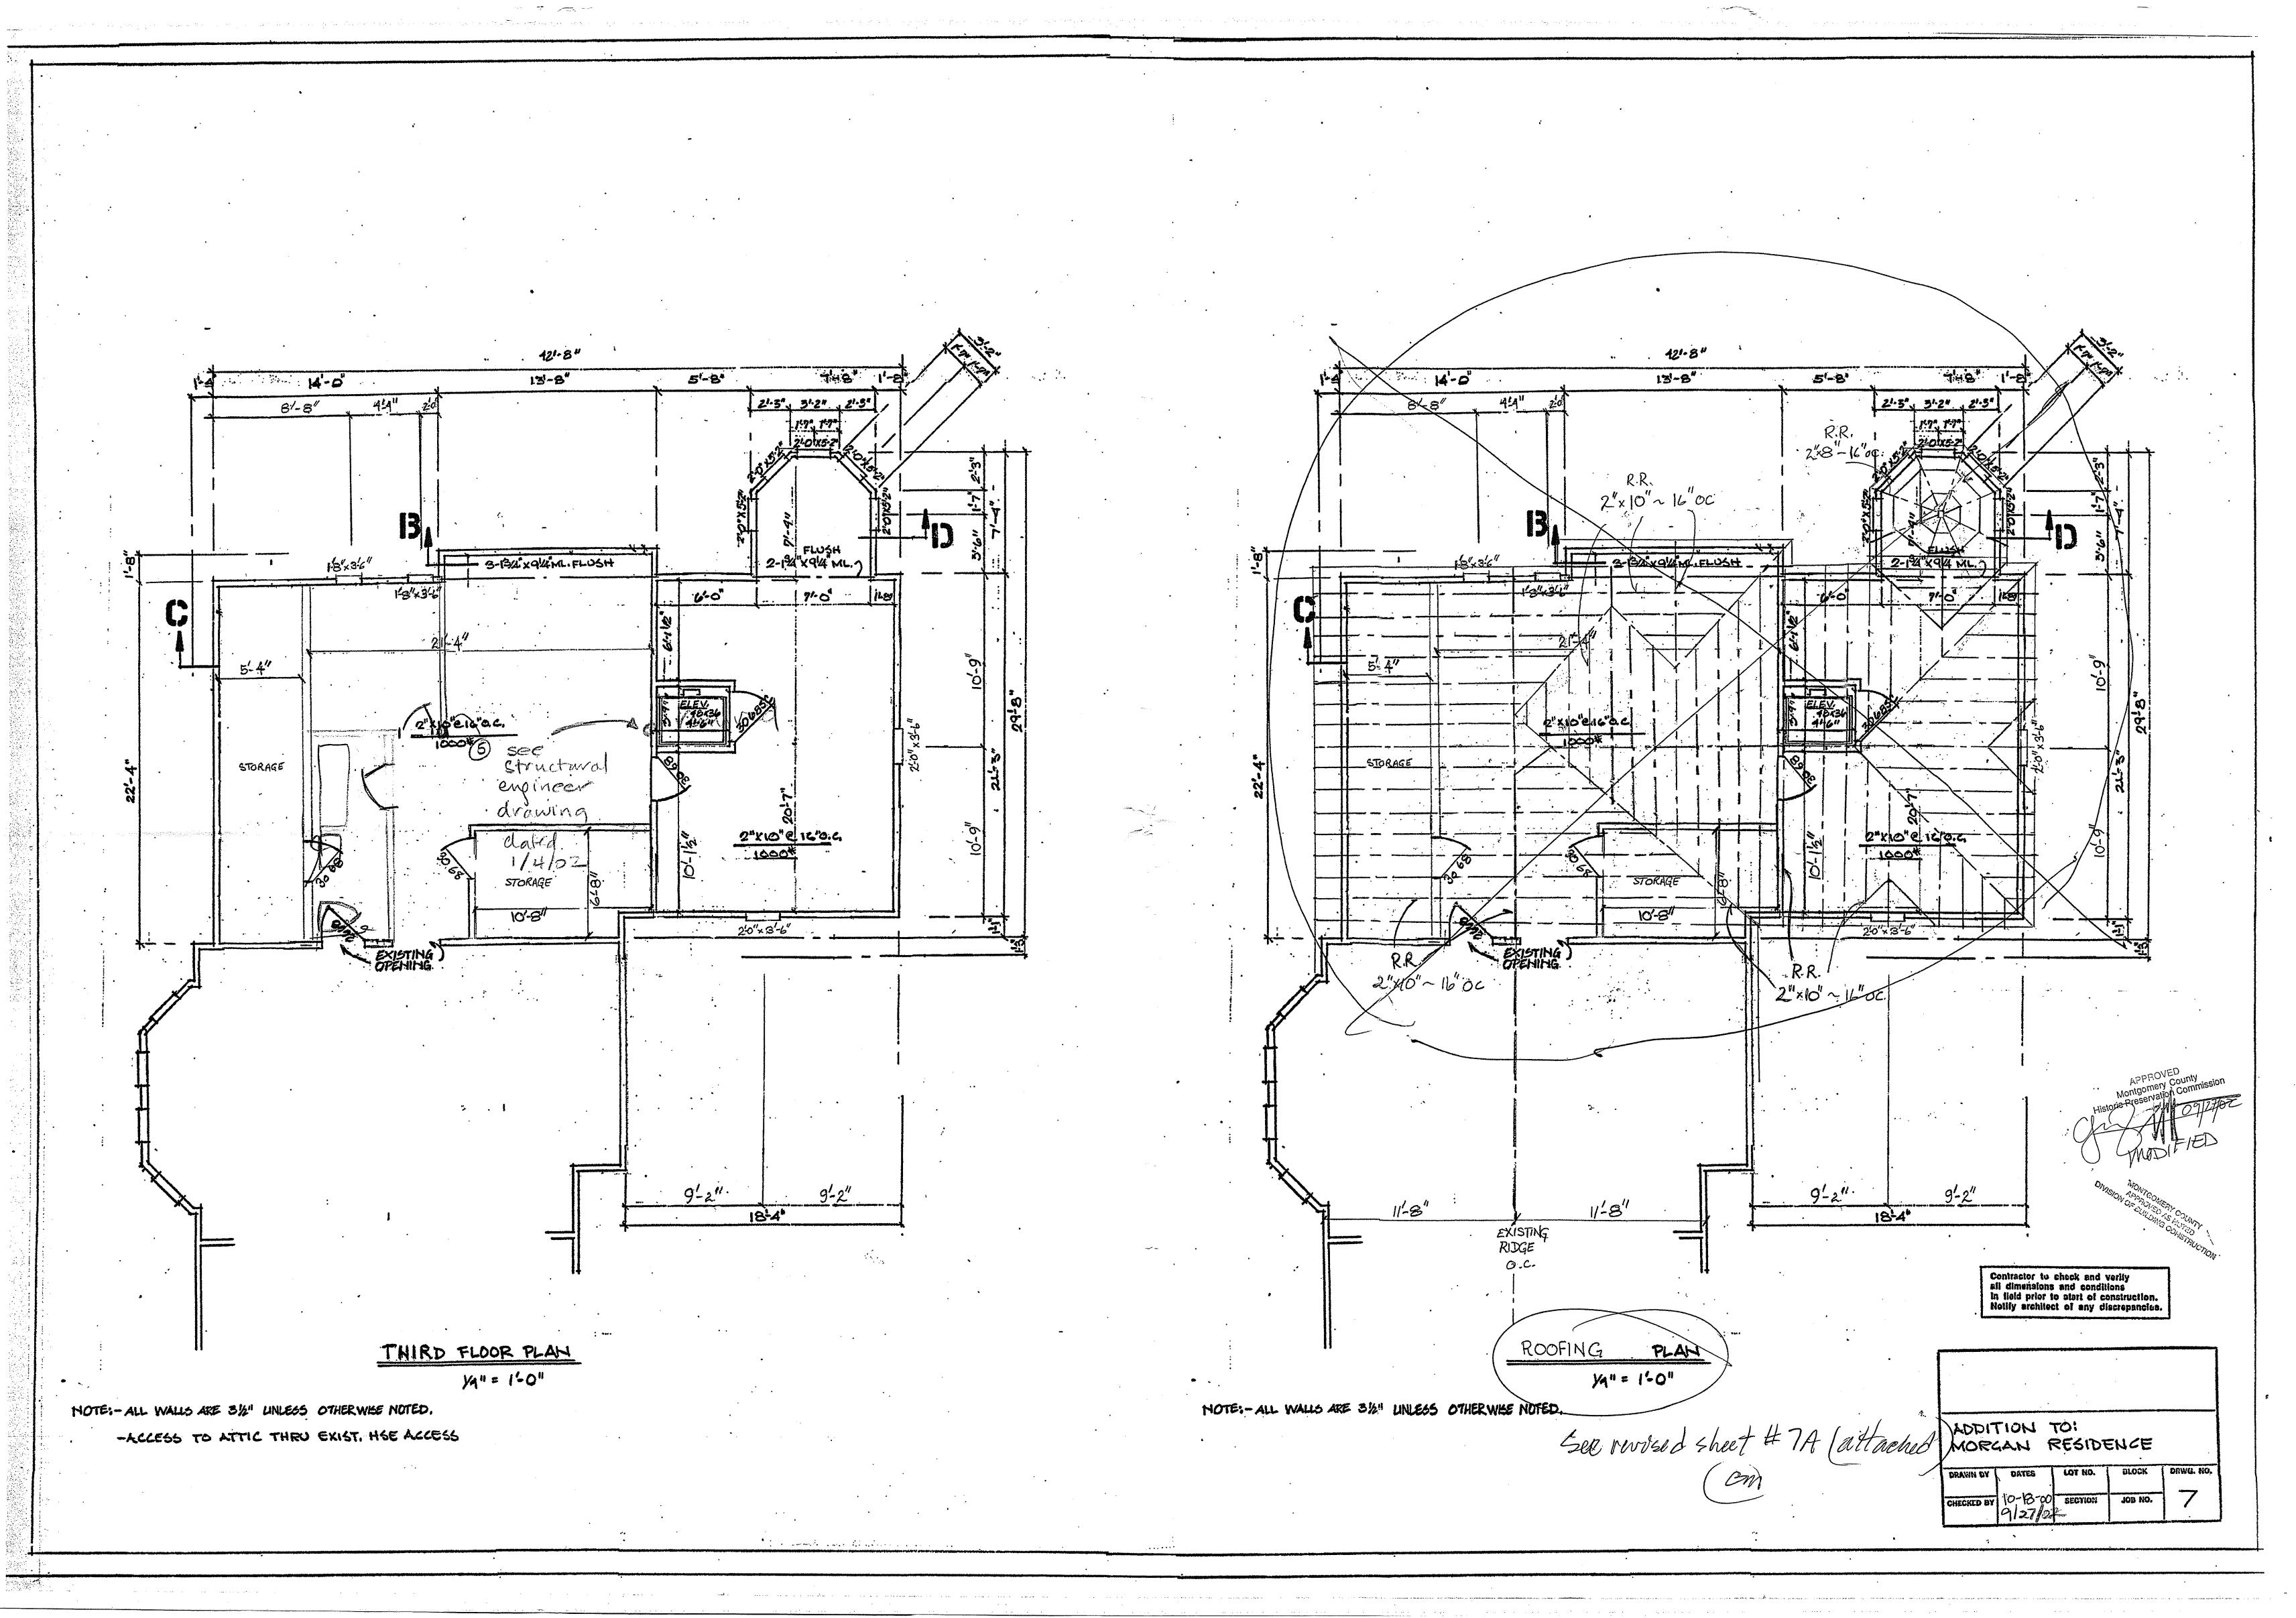
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MONTGOMERY COUNTY APPROVED AS NOTED DIVISION OF EUILDING CONSTRUCTION APPROVED Montgomery County Historic Preservation Commission Contractor to check and verify all dimensions and conditions in field prior to start of construction. Notify architect of any discrepancies. CLAUDE C. LAPP ARCHITECT 11820 PARKLAWN DRIVE, SUITE 100 ROCKVILLE, MD 20852-2529 301-881-6855 FAX 301-770-9163 REGIST ADDITION TO: MORGAN RESIDENCE DRAWN BY DATES LOT NO. BLOCK DRVG. NO. B-14-CC CHECKED BY 10-6-00 SECTION JOB NO. 4 SECTION JOB NO. CHECKED BY 9/27/0

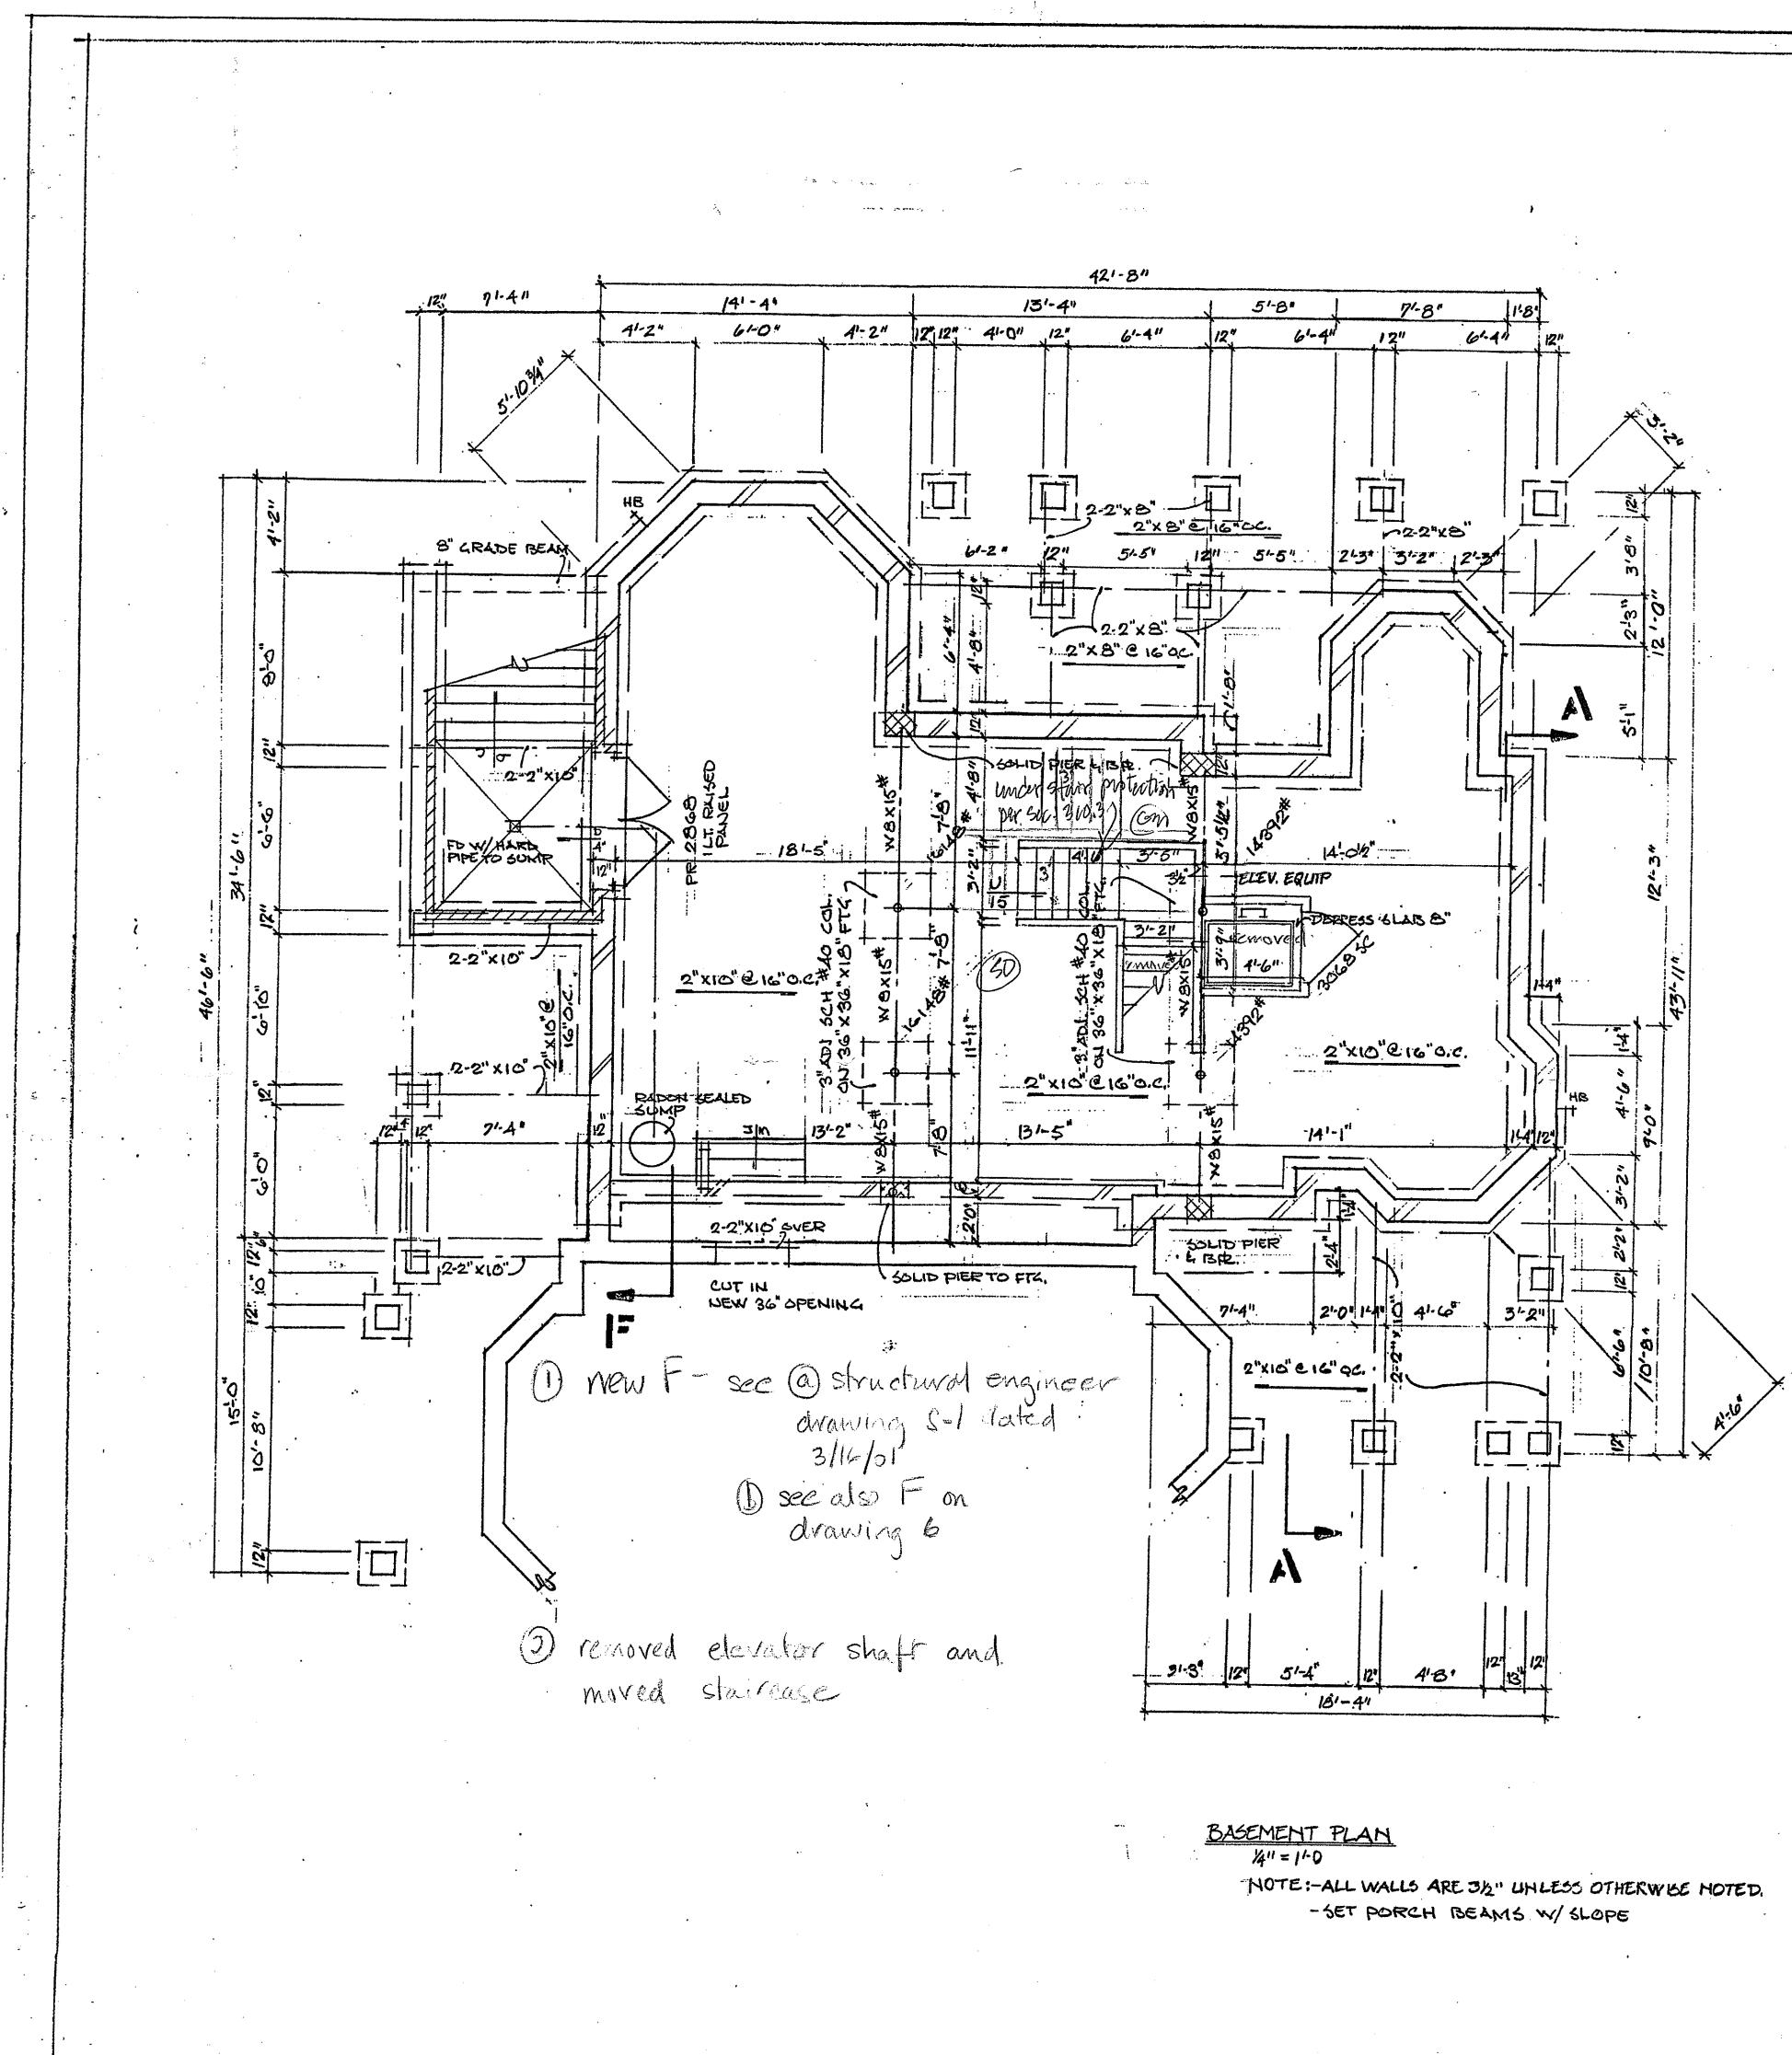

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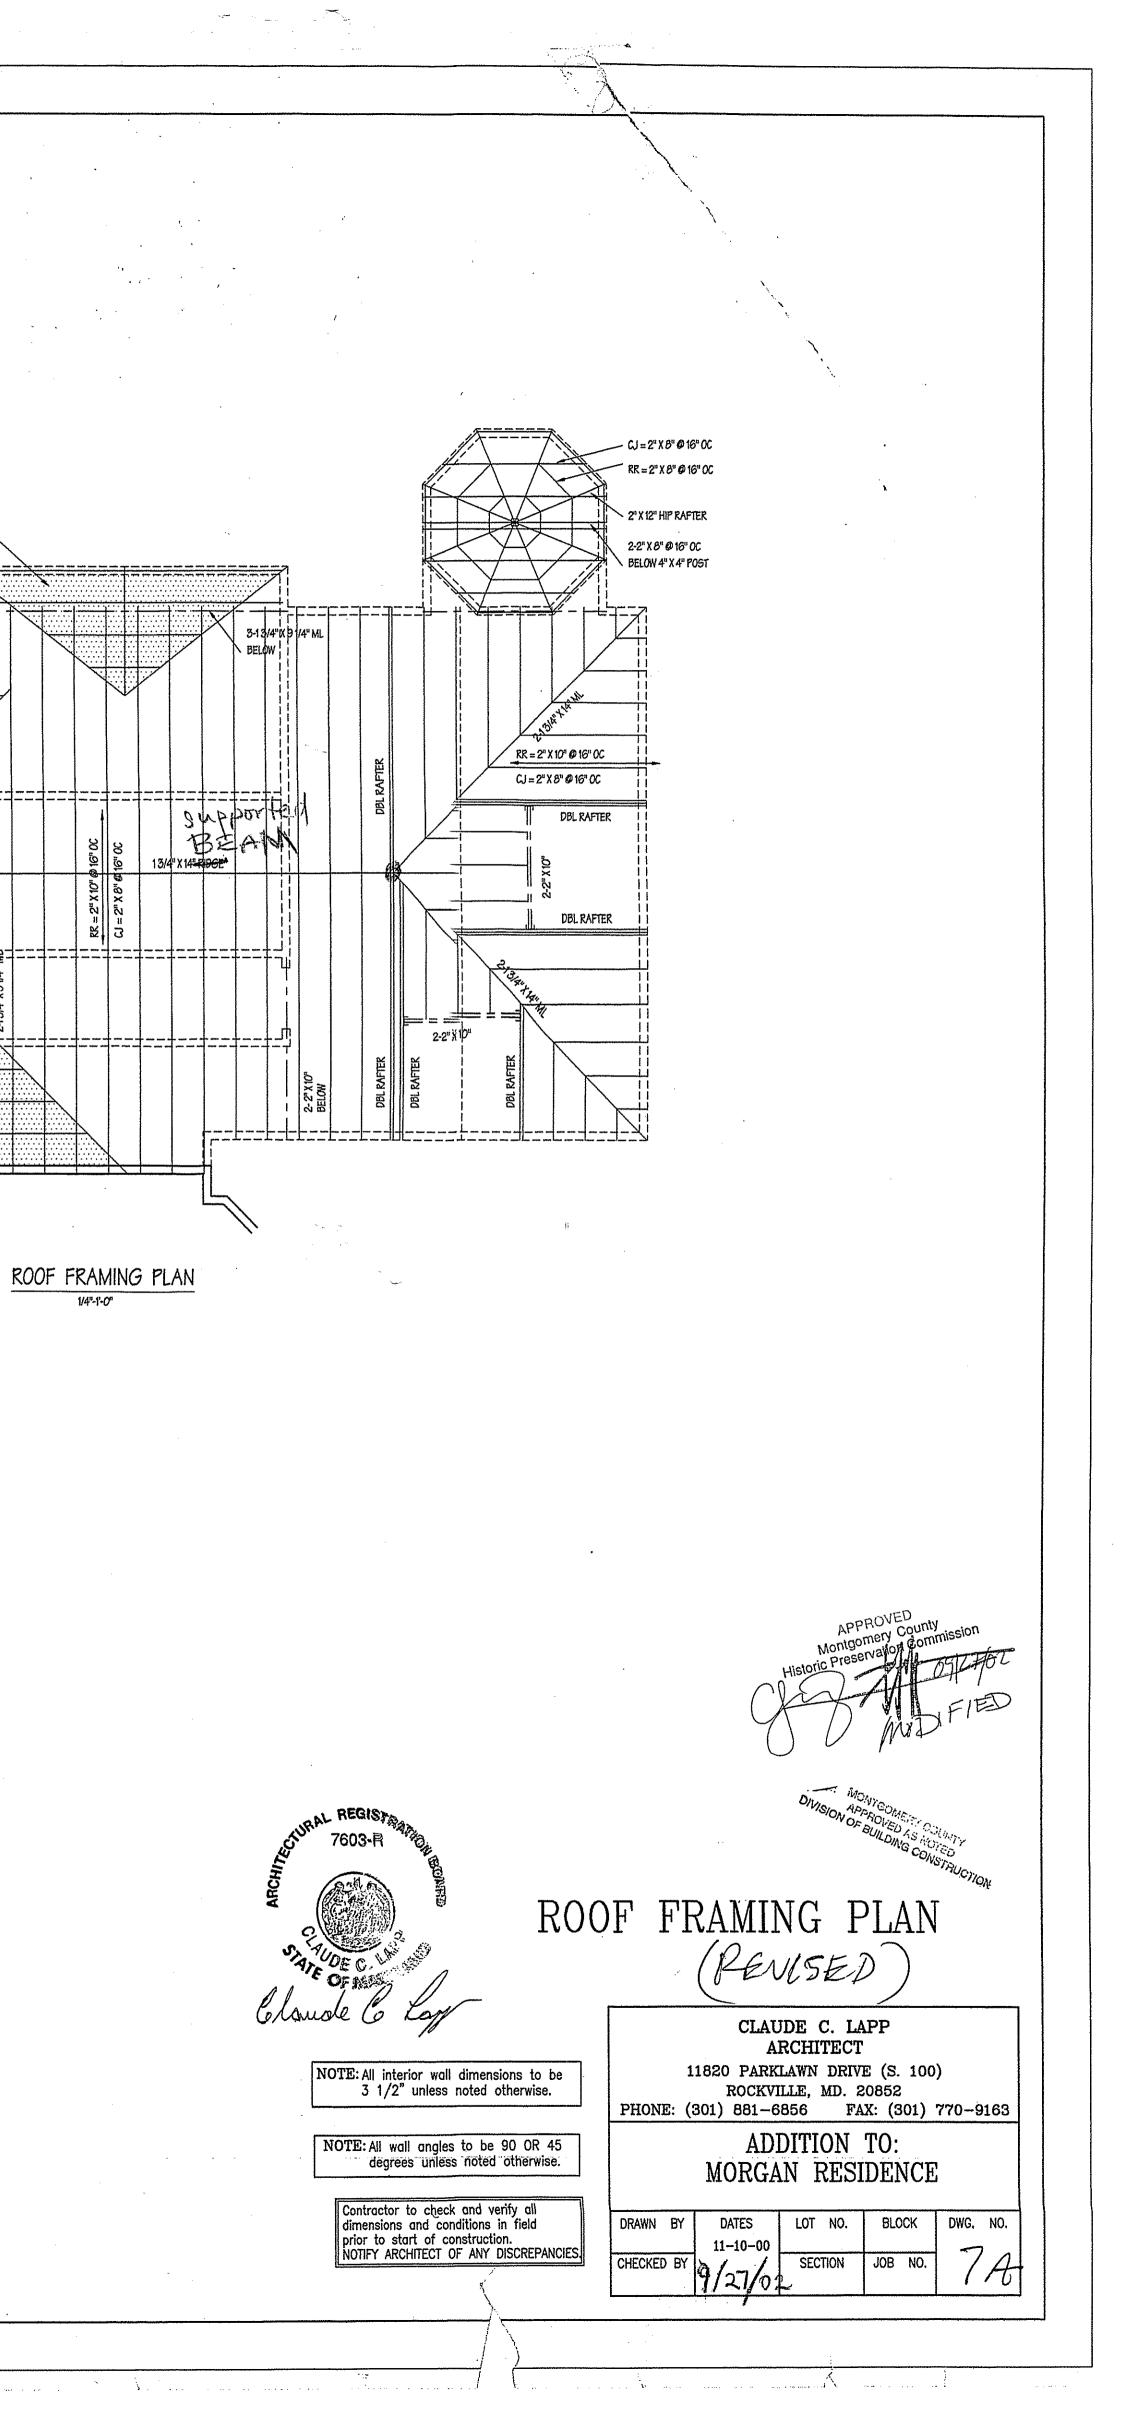
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May 3, 2001

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Mrs. Pam Morgan 4710 Waverly Avenue Garrett Park, MD 20896

Dear Mrs. Morgan:

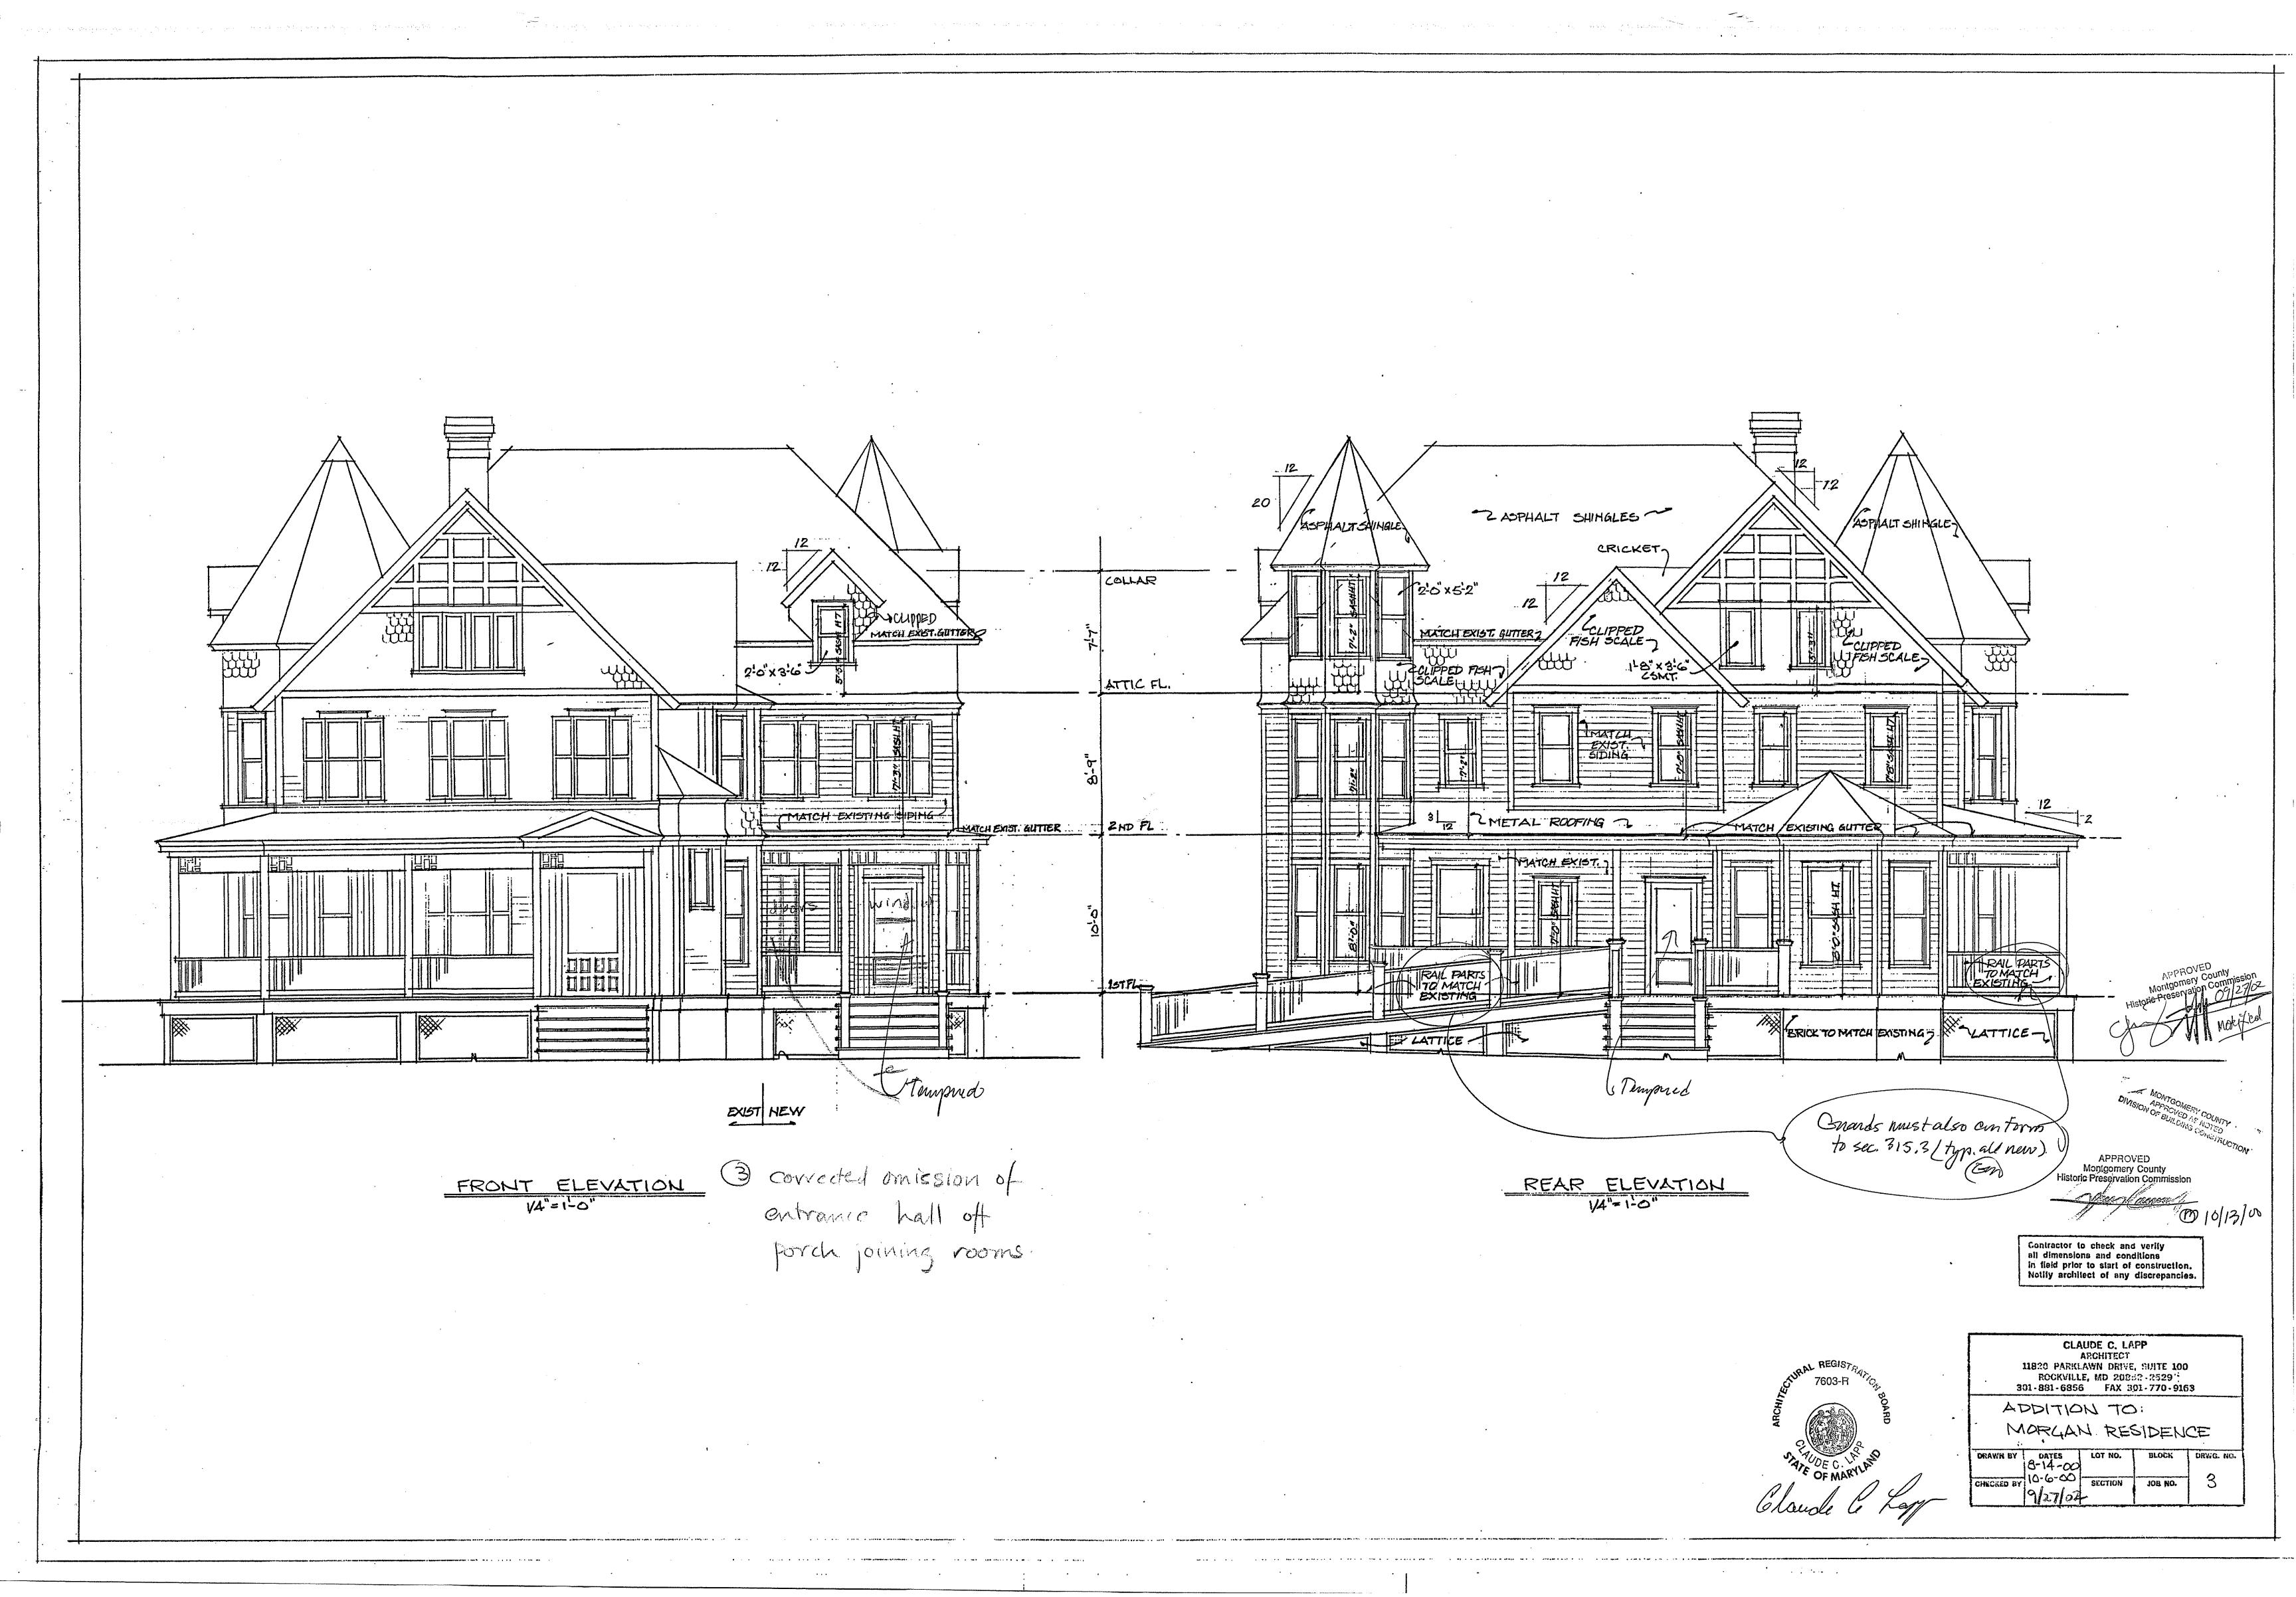Thank you for sending me your proposed revisions to your approved HAWP (Case # 30/13-00B) dating May 10, 2000. The following proposed projects are approved at staff level:

- 1. The continuance of the existing pattern of fish scale around the new addition on the first and second floor.
- 2. The use of 1/1, double-hung, Pella, wood windows on the new addition.
- 3. The installation of three, 5'3" wide double hung windows in each sunroom wall on the "left elevation."
- 4. The installation of larger windows in the two bays in the bedroom on the "right elevation" and the elimination of the one window shown on the straight wall.
- 5. The installation of a basement awning window on the "right elevation."

Any additional alterations to the exterior of the house would need to be reviewed by the Historic Preservation Commission prior to the project's commencement.

If you have any additional questions, please do not hesitate to contact me at 301-563-3404.

Sincerely,

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Michele Naru Historic Preservation Planner

Cc: Garret Park Mayor and LAP

#### Proposed Modifications to the Plans for 4710 Waverly Avenue, Garrett Park

#### as Approved by Montgomery County Historic Preservation Commission on 10/13/00

#### Case Number: 30/13-00B

The first six proposed modifications are hopefully quite minor and restore our original intention in our drawings given initial approval by the HAWP review on 5/10/00. These six modifications correct omissions or errors by the architect who drew the plans which were subsequently approved by the Commission Staff.

1

approved

Continue the existing pattern of fish scale around the house, on the exterior between first and second floor. As required in item #3 in "Approved with Conditions" for the gable ends, clipped fish scale shingles will be used. See Circle 15 in the attachment to the Commission Staff Report for HAWP review on meeting date 5/10/00.

All new roofing, including on the porches, will be the same as the existing section of the house. When the new roofing is applied, the existing roofing will be replaced for needed repairs. There will be no metal roofing on any new (or old) porches. All roofing will be asphalt roofing shingles.

The windows will be double-hung Pella wood windows throughout the new section as stated on Circles 13, 15, 17, 19 of the Commission Staff Report for HAWP review on meeting date 5/10/00. No old windows will be reused. However, contrary to item #5 in "Approved with Conditions" the windows will not be true divided light. Pella mullion inserts for divided light are available if required. (The existing house has double-hung windows, not divided light which, I believe, would look quite out of place in the new addition.)

The windows drawn by the architect on the Approved Plans are smaller than those shown on the attachment to the Commission Staff Report for HAWP review on meeting date 5/10/00. As drawn by the architect, insufficient light will enter the living space, unnecessarily. This is particularly true in the single-story sunroom at the rear of the house. Three adjacent double hung windows in each sunroom wall are proposed (total window width 5'3" in each 6' wall). The other window in the left elevation (Circle 17) would match this, also being a three double hung window. Another window change is to use larger windows in the two bays in the bedroom on the right but eliminate the one window shown in the straight wall (to provide furniture wall space).

5. A basement window on the right side is needed for cross ventilation to the basement door.

The architect incorrectly removed the door access from the existing house to the new bedroom on the right side of the addition. See the 6'7" wall shown on Circle 11 in

1

the attachment to the Commission Staff Report for HAWP review on meeting date 5/10/00. The Approved Plan needs to be modified to re-instate this wall.


The last two proposed modifications are perhaps more significant and are changes to the attachment to the Commission Staff Report for HAWP review on meeting date 5/10/00, as well as changes to the Approved Plans as drawn by the architect.

7.

We would like to include two pre-fabricated fireplaces on the left side of the new addition, one in the basement and one on the first floor. This will require chimney flues which will be interior to the house framing. The flues will show only on the roof as shown in the attached modified drawing of the left elevation of the Approved Plans. The chimney surround on the roof will be framed and will be covered with the same wood clapboard siding as on the new addition's exterior.

8. The Approved Plans show a flat porch roof on the right side of the new addition. We would like to add code-compliant railing and put a door from the second floor bedroom of the new addition out onto this flat roof. These railings are shown in the attached modified drawing of the right elevation of the Approved Plans.

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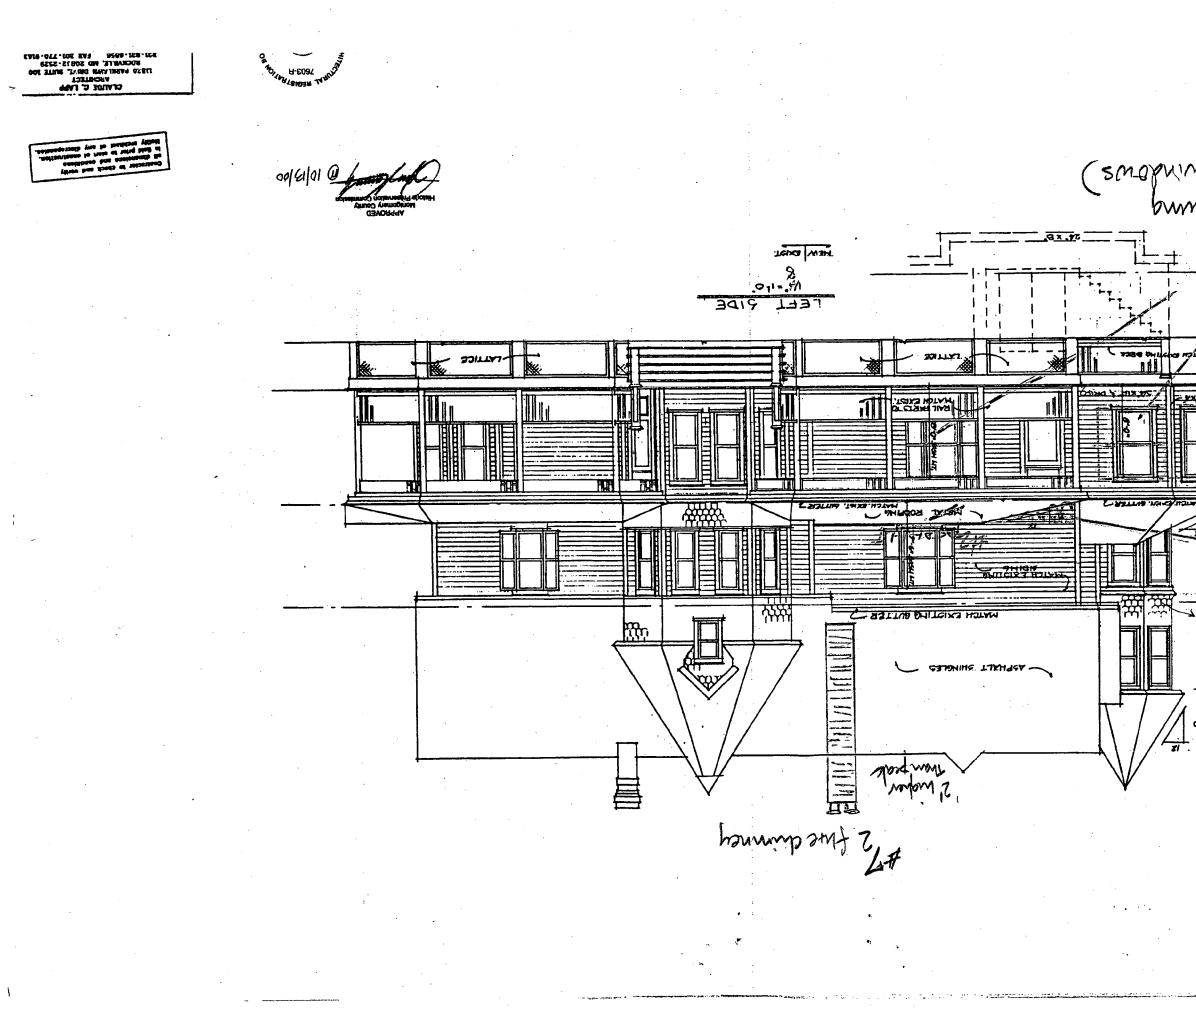

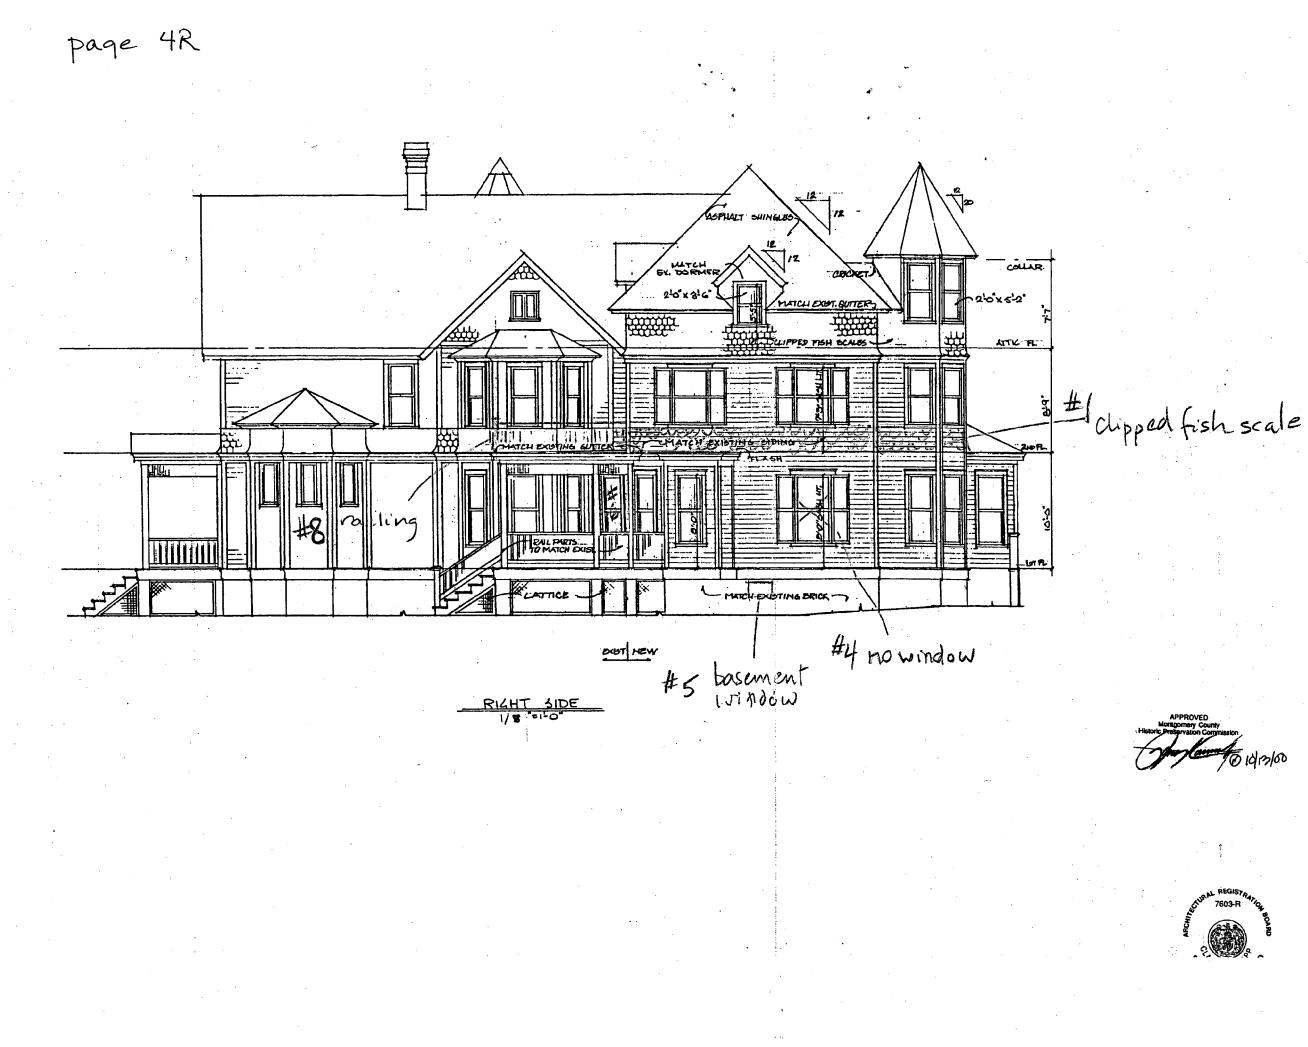
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CLAUDE C. LAPP ARCHTELT 11820 PANKLAWN DRVF, SUITE 100 ROCKWILE, MO 20932-7529 301-881-6855 FAX 301-770-9163 ADDITION TO: MORGAN RESIDENCE




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page 6R (There is no page 7R since front and rear elevations are on one page.) #7 thim ney 20 2 ADPHALT SHIMALES CRICKET COLLAR 2-0 × 5-2 CLIDOG / CLIPPED -----UUU LIPPED 1244 CALEUUU 30 000V ALL I ILB"X B'C 2:0 x 3:4 ATTIC FL. railing FATCH METAL ROOFING DOG ANTER DIPHONGNITIATC M T AU EMETS LATTICE EXIST NEW

FRONT ELEVATION

REAR ELEVATION

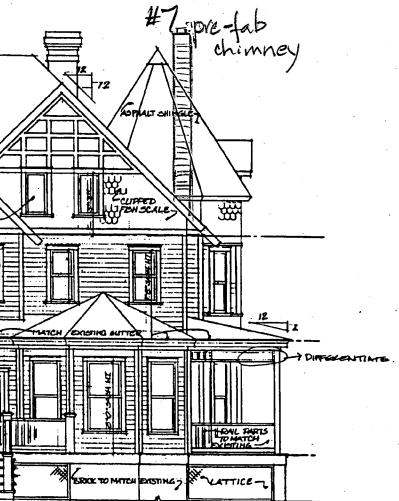

10/19/00

CLAUDE C. LAPP ARCHITECT 1839 PARILAWN DRYE, SUITE 100



# ADDITION TO: MORGAN RESIDENCE 4710 WAVERLY AVENUE, GARRETT PARK, MD 20896

1) All construction to be in conformance with C.A.B.O., one and two family dwelling code, 1995 edition & all MONTGOMERY COUNTY additions and revisions thereto.	16) All brick units A.S.T.M. C 216.
2) Design live loads:	17) All mortar shal
<ul> <li>Sleeping room load 30 p.s.f.</li> <li>Floor load</li></ul>	18) Backfilling agai framing is in place overturning.
<ul> <li>Deck load</li></ul>	19) Maximum allow
3) Soil bearing to be 2000 p.s.f. minimum.	20) All reinforcing Unless otherwise no
4) Design wind load 20 p.s.f.	21) Steel post cap
5) Maximum height of fill above basement slab ta be 7' -0".	Bolts shall be A.S.T
6) Bottom of all concrete footings to be 24" minimum below finished grade.	22) Steel columns specified otherwise.
7) Foundation walls shall comply to C.A.B.O. Sec. R-401. thru 404.	23) All structural w
8) Foundation drainage shall comply to C.A.B.O. Sec. R-405.	accordance with the published by The N
9) Foundation waterproofing shall comply to C.A.B.O. Sec. R-406.	shall be of the fol
10) Top of garage slab to be 4" belaw any adjacent finished floor.	CLASSIFICATIO
11) Attached Garages shall comply to C.A.B.O. Sec. R-309.	POSTS #1 D.F HEADERS, BE
12) Concrete floors shall comply to C.A.B.O. Sec. R-505.	
13) All concrete to be 150 p.c.f. and conform to the latest A.C.I. 318 specifications. Porches, garages, slabs and steps exposed to weather, to be 3500 p.s.i. air entrained concrete. Foundation walls, exterior walls and other vertical concrete work to be 3000 p.s.i. air entrained concrete. All other concrete to be 3000 p.s.i.	RAFTERS, JO
14) All c.m.u. used in basement and foundation walls shall be load bearing units conforming to A.S.T.M. C 90-70 for hollow units. At wood past and wood beam	Gang-Lam B
bearing locations on c.m.u. wall cells shall be filled solid with grout or mortar for top two course minimum.	24) All headers to
15) All c.m.u. walls shall have standard truss type DUR—O—WALL bed joint reinforcing at maximum 16" vertical spacing.	25) Provide double long, follow C.A.B.C
	26) Splices of the staggered a minim
	stuggereo a minim

# GENERAL NOTES

in exterior shall conform to A.S.T.M. C 62 or

be type "S" conforming to A.S.T.M. C 270-82.

nst basement walls shall not be performed until first floor and top of reinforced c.m.u. walls are braced against

able lateral pressure on basement walls 30 p.s.f.

steel to be grade 40 and conform to A.S.T.M. Spec. A 615.

plates to conform to A.S.T.M., Spec. A 36, Fy = 36,000 p.s.i. I.M. A 307 or better.

in basement to be adjustable 3"I.D. S40 columns unless

wood framing, including roof and floor sheathing, to be in e "National Design Specifications for Wood Construction", lational Forest Products Association. Framing lumber llowing grades or better:

ATION	SIZE	BENDING "Fb"	MODULUS OF ELASTICITY "E"
D.F.		1200	1600000
BEAMS, ROOF HIPS #1 S.P.	2x4 2x6 2x8 2x10 2x12	1850 1650 1500 1300 1250	1700000 1700000 1700000 1700000 1700000
JOISTS AND STUDS #2 H.F.	2X4 2X6 2X8 2X10 2X12	1000 1000 1000 1000 1000	1500000 1500000 1500000 1500000 1500000
m Beams (Fv = 285 PSI)	all	2600	1900000

be 2 - 2" x 10" s unless specified otherwise.

jack studs at each end of headers and beams up to 4'-0'', with longer spans.

bottom and top portion of a double top plate must be um of 4'-0".

27) All roof, floor and girder trusses to be designed by truss manufacturer to carry required loads and to be installed according to manufacturer's specifications.

28) Contractor to provide architect with shop drawings for all roof and floor trusses for approval.

29) Provide solid blocking under all jack studs not bearing directly on joists or T.J.I.'s.

30) In those cases where floor trusses are not centered directly over the studs, splices of the top plate shall occur only over the studs.

31) Where installation of plumbing, heating or other pipes necessitates cutting of top plates, a metal tie not less than eighteen gauge, forty-five thousandths (0.045)" thickness and 1 1/2" wide shall be fastened to the plate across and to each side of the opening with not less than 16d nails.

32) Double beams, double hip and valley rafters shall be nailed securely together to ensure that the two members act conjointly in resisting the applied load.

33) Unless specified otherwise provide the following lintel over masonry openings:

BRICK: * UP Ta	3'-0" 5'-0" 8'-0" 9'-0"	3 1/2" x 3 1/2" x 1/4" 3 1/2" x 4" x 1/4" 3 1/2" x 5" x 5/16" 3 1/2" x 6" x 5/16"
STONE: UP TO	3'-0" 5'-0" 8'-0" 9'-0"	6" X 4" X 5/16" 6" X 6" X 5/16" 6" X 6" X 3/8" 6" X 8" X 7/16"

\* Provide one ongle per 4" of brick thickness. \* Provide one angle per 6" of stone thickness.

All angles to have 4" bearing at each end min.

34) All untreated lumber to be minimum of 8" above finsished grade. All lumber in contact with concrete or c.m.u. to be pressure treated.

35) All prefab fireplaces to be U.L. rated and installed according to manufacturers specifications.


36) Fireplaces with terminations higher than 35'-0" above adjacent grade to be solid masonry.

37) Chimney and fireplace construction to be in accordance with C.A.B.O. Chapter 10 and fig. R-1003.I.

CLAUDE C. LAPP ARCHITECT 11820 PARKLAWN DR. ROCKVILLE, MD 20852 TEL. 301-881-6856 FAX. 301-770-9163

38) Fireplace hearth to project 20" from front of facing and 12" to side of opening.
39) Firestopping shall be provided according to C.A.B.O. Sec. R $-$ 602.7. The integrity of all firestopping shall be maintained.
40) Draftstopping shall be provided according to C.A.B.O Sec. R - 602.7.
41) Provide radon mitigation according to C.A.B.O. Sec. R - 324.
42) Provide interconnected smoke detectors to protect all floors, bedrooms, and basement according to C.A.B.O. Sec. R-316
43) Stairways shall comply with C.A.B.O. Sec. R—314. Minimum headroom to be 6'—8" clear at all points. Minimum tread to be 9". Maximum riser to be 8 1/4". as per 4—97 amendments.
44) Handralls_& guardrails shall comply to C.A.B.O. Sec. R-315.
45) All exits shall comply to C.A.B.O. Sec. R-310.
46) Sleeping room windows shall comply with C.A.B.O. Sec. R—310.2.1. & 4—97 amendments. Maximum sill height 44" obove finished floor.
47) All Glazing shall comply to C.A.B.O. Sec. R-308.
48) All Ceiling heights shall comply to C.A.B.O. Sec. R-305.
49) All exterior wall coverings shall comply to C.A.B.O. Sec. R-703.
50) All gas piping shall conform to N.F.P.A. 54.
51) Electrical wiring must conform to the 1993 National Electrical Code and County Requirements.
Note: Builder shall provide roof framing plans signed and sealed by truss manufacturer and shop drawings for floor joists at framing inspection.
Note: Trusses shall be braced per. manufactures recommendations.

APPROVED Montgomery County

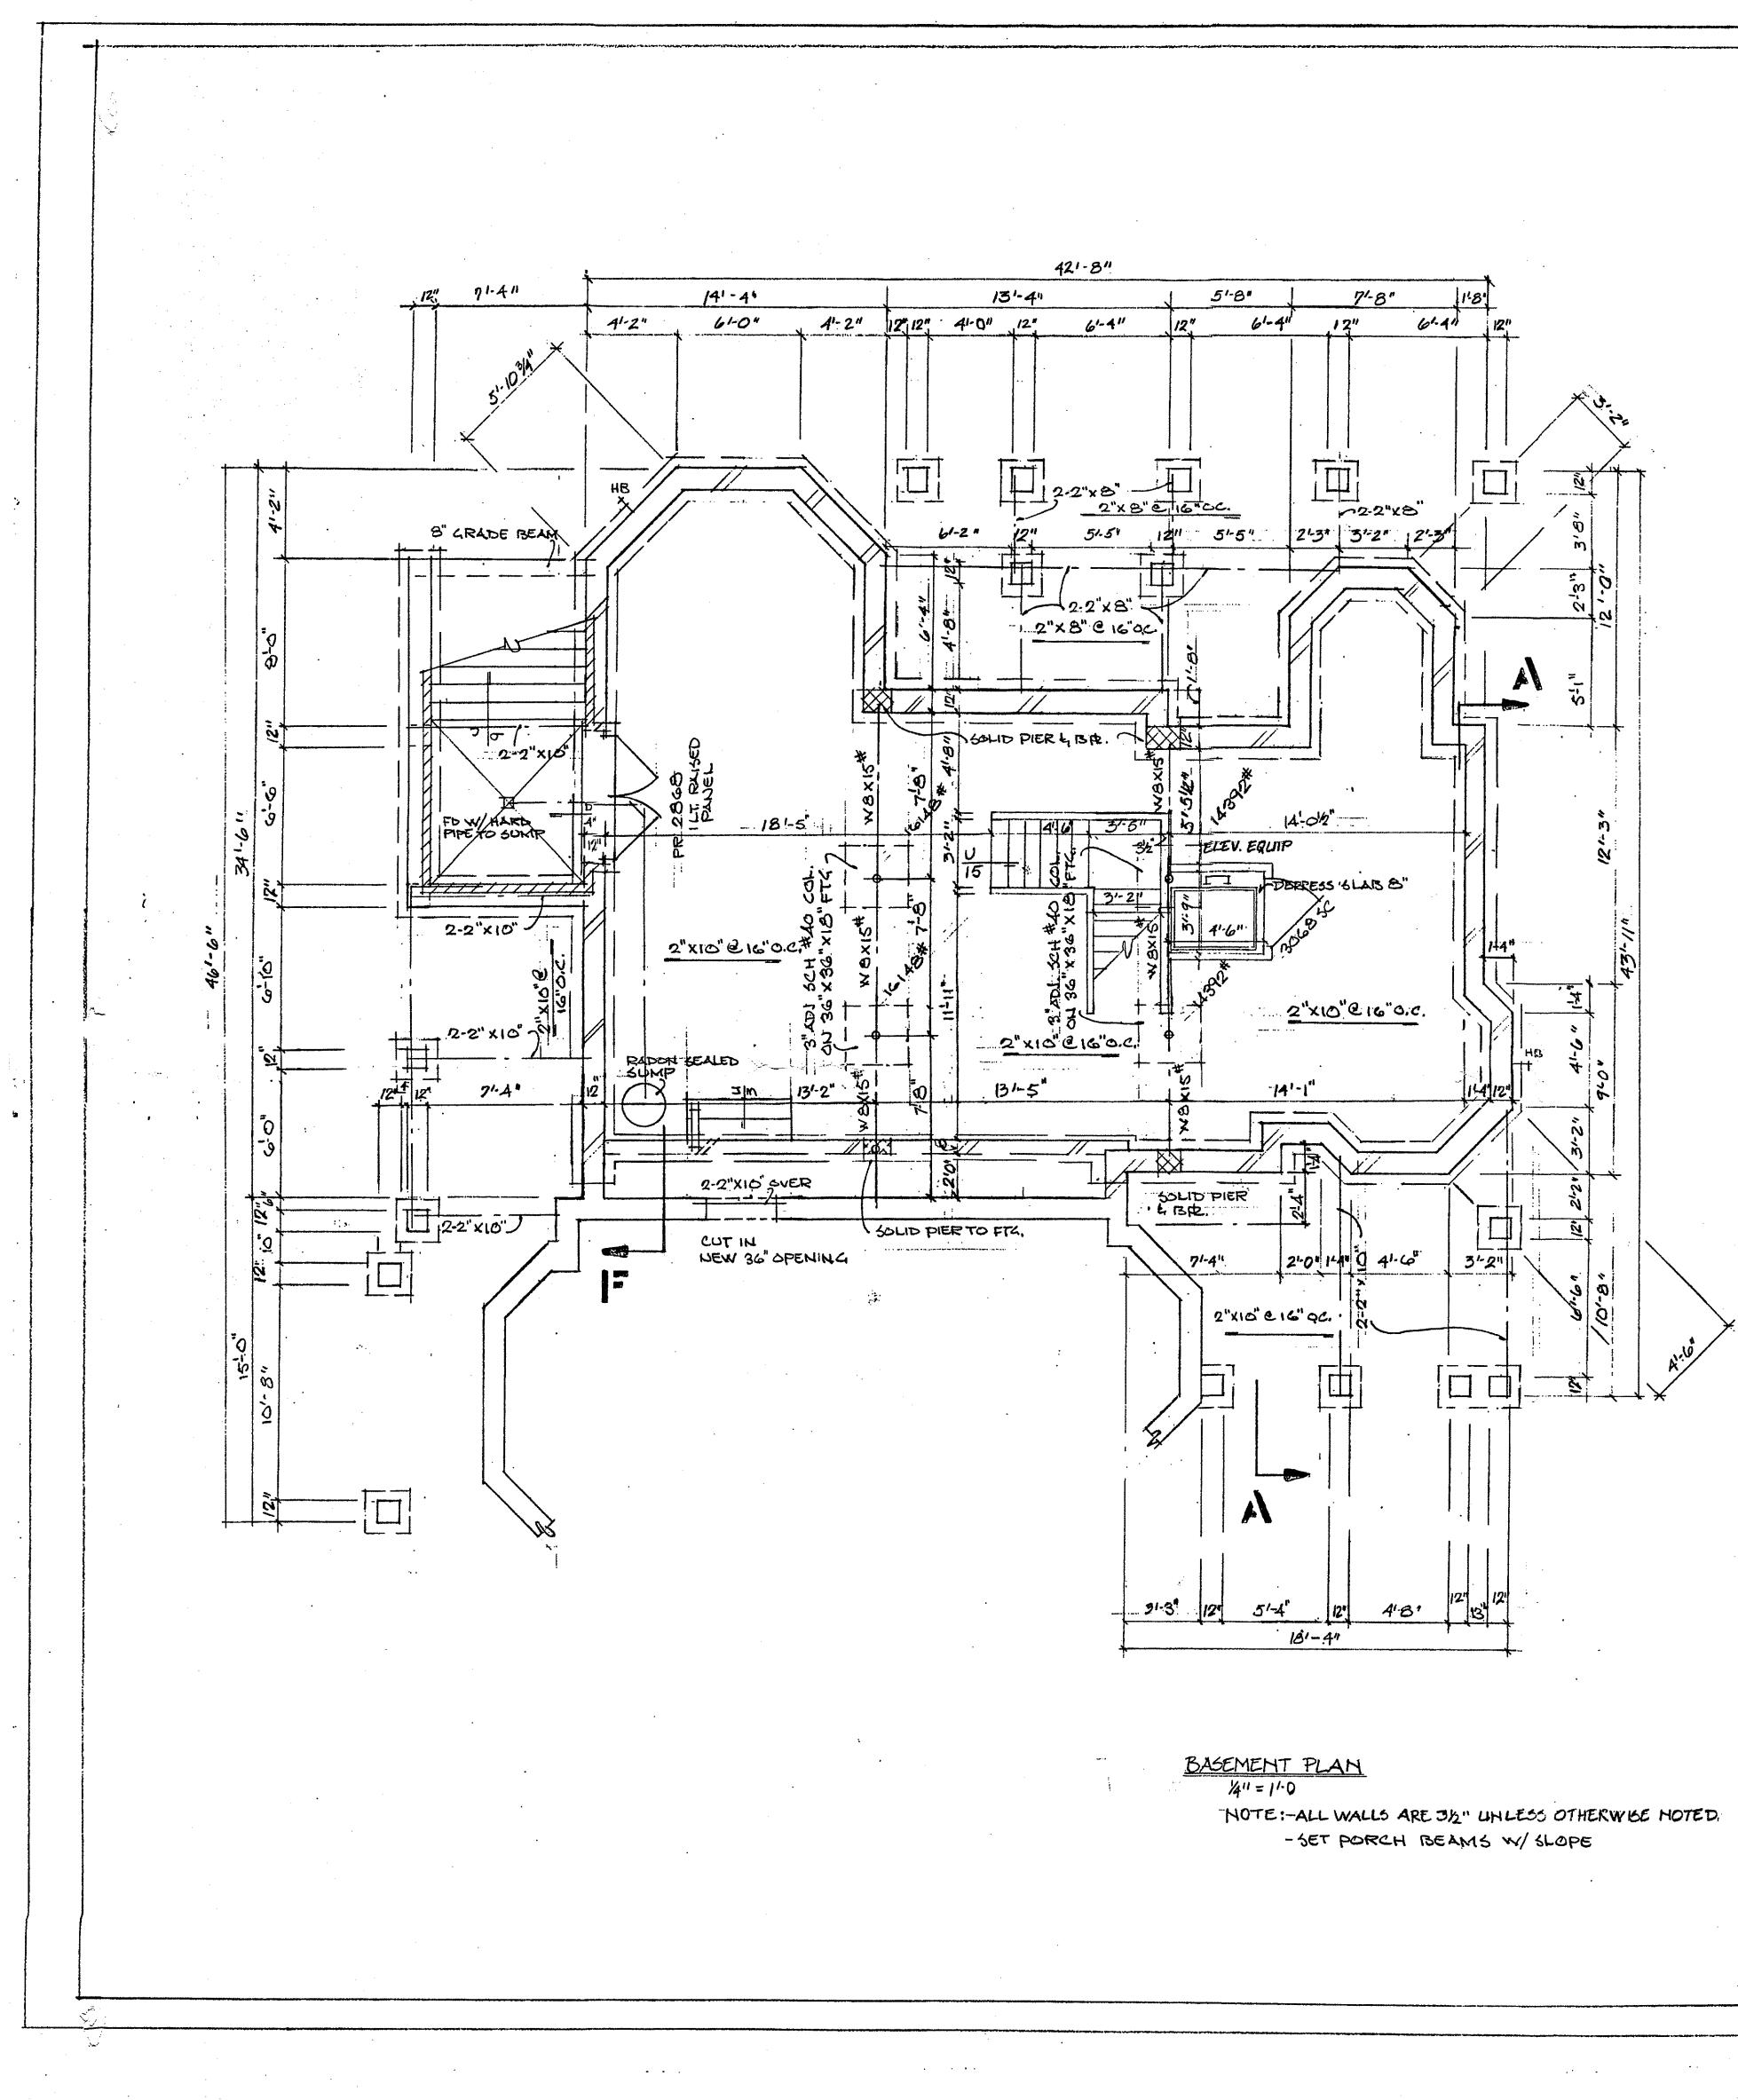


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Contractor to check and verily all dimensions and conditions in field prior to start of construction. Notify architect of any discrepancies.

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ADDI	TION	TO:	. <b>.</b>	
MOR	GAN	RESI	DENC	E
DRAWN BY	DATES	LOT NO.	ELOCK	Dagg. NO.
		SECTION	JOB ND.	T) <b>\</b>


<del>بد</del>ر ۲۰۰



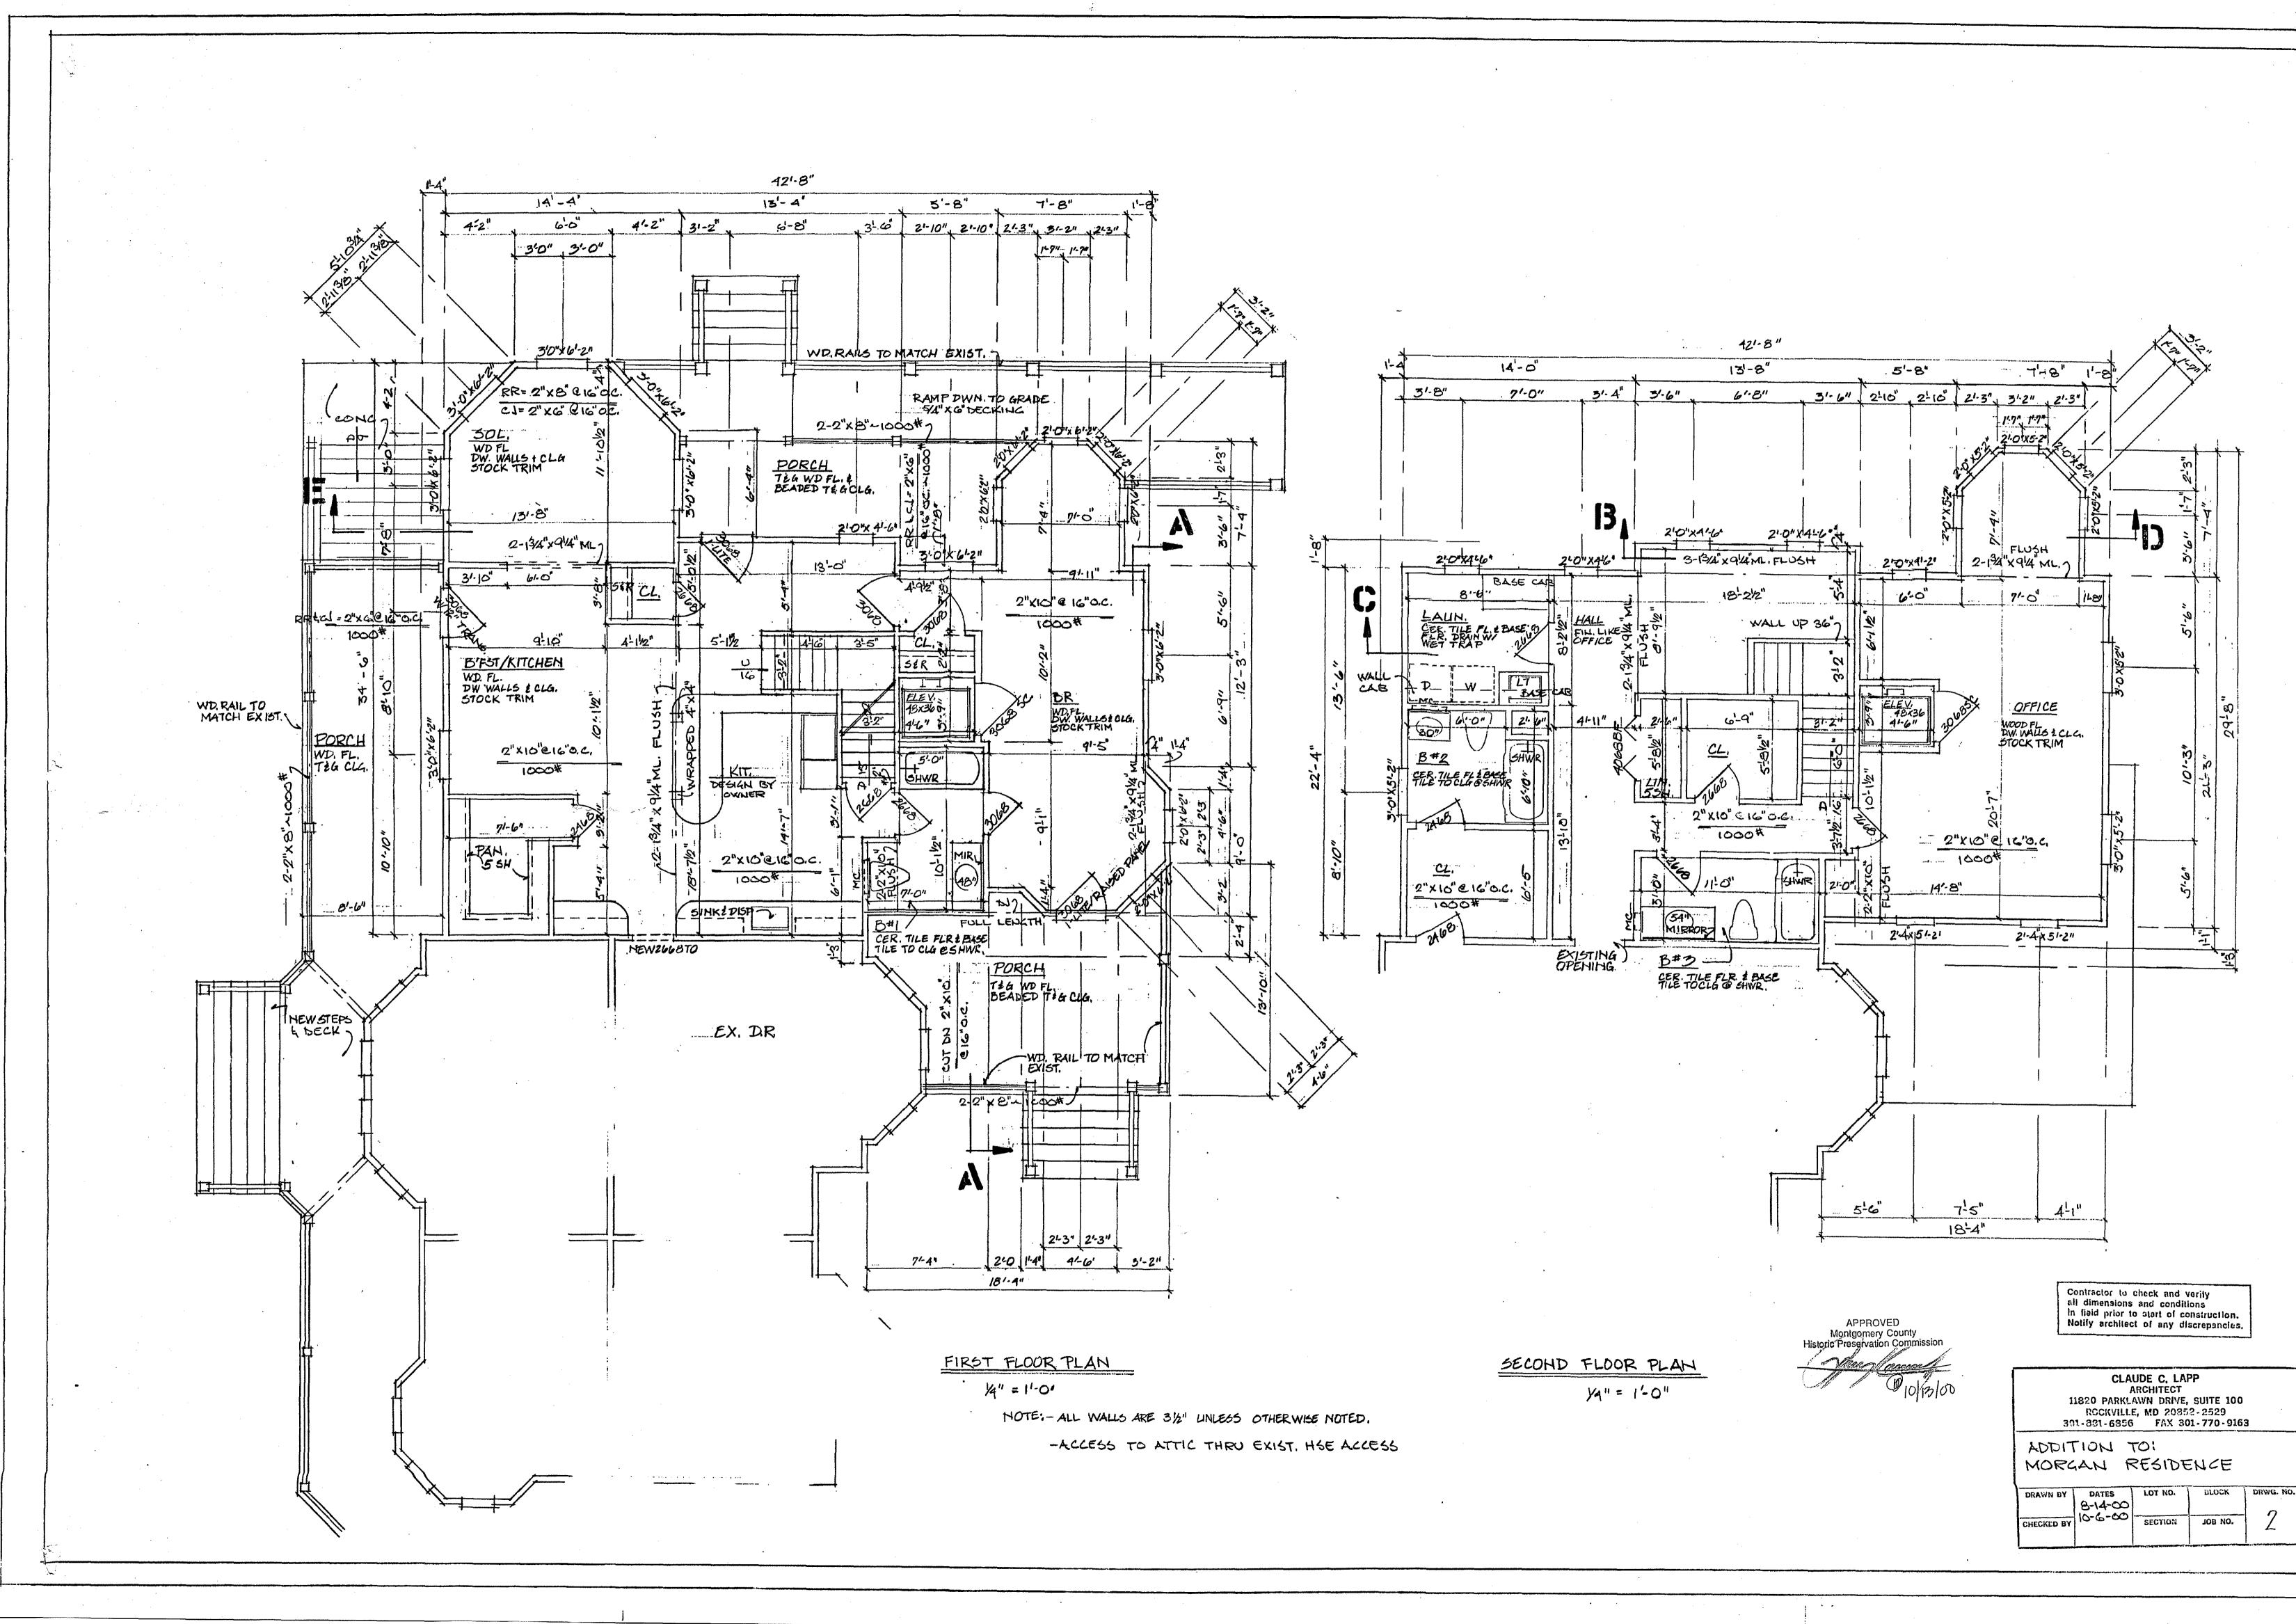



# Contractor to check and verify all dimensions and conditions in field prior to start of construction. Notify architect of any discrepancies. CLAUDE C. LAPP ARCHITECT 11820 PARKLAWN DRIVE, SUITE 100 ROCKVILLE, MD 20852-2529 301-881-6855 FAX 301-770-9163 ADDITION TO: MORGAN RESIDENCE • DRAWN BY DATES LOT NO. BLOCK DRWG. NO. 8-14-CC CHECKED BY 10-6-00 SECTION JOB NO. 4

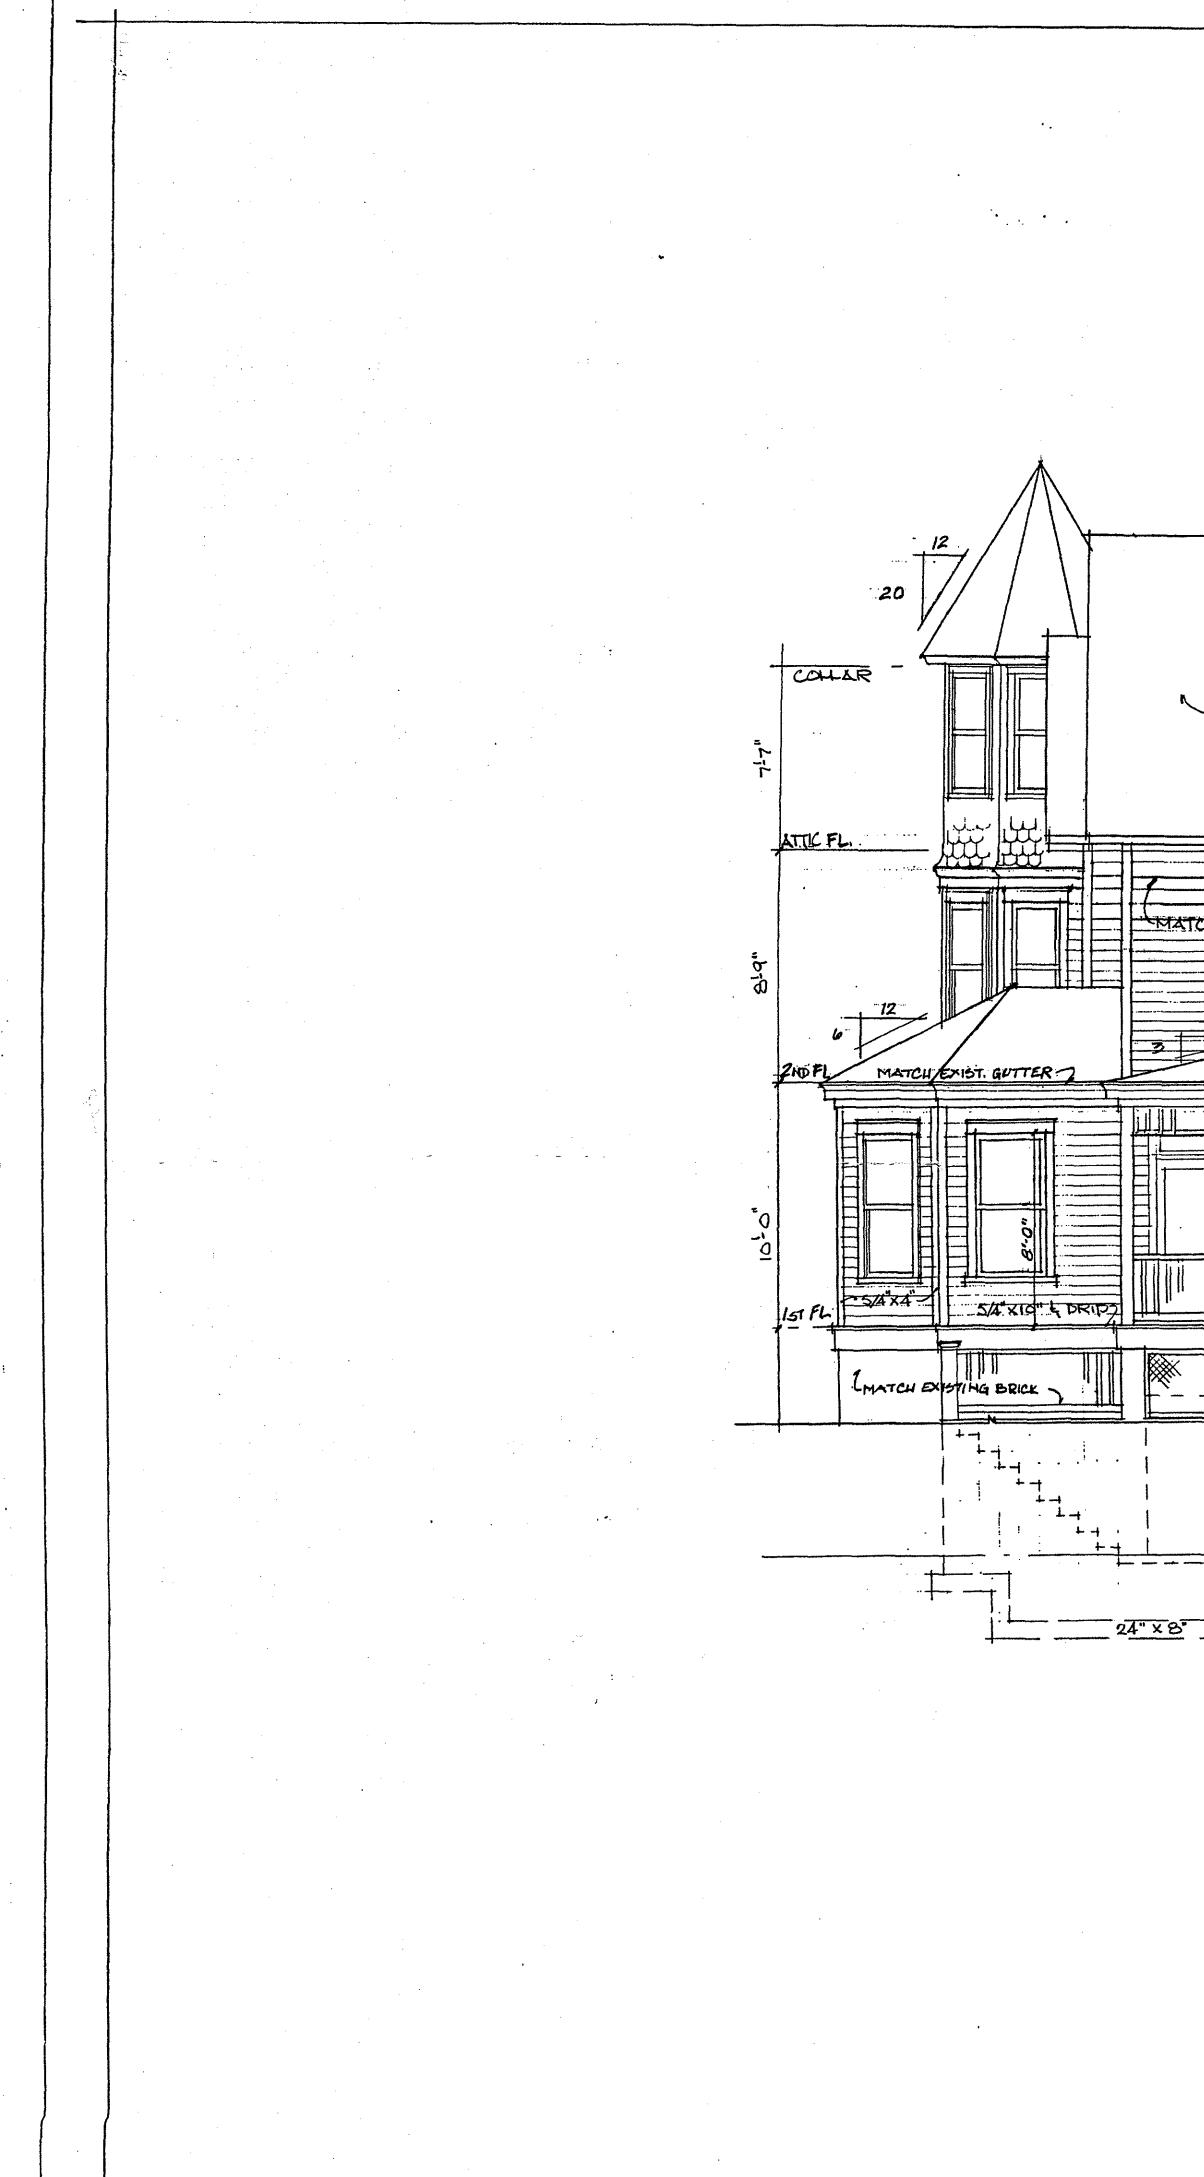


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SECTIONS 3/8"=1-0"

Contractor to check and verify all dimensions and conditions in field prior to start of construction. Notify architect of any discrepancies.

CLAUDE C. LAPP ARCHITECT 11820 PARKLAWN DRIVE, SUITE 100 ROCKVILLE, MD 20852-2529 301-931-6356 FAX 301-770-9163				
ADDITION TO: MORGAN RESIDENCE				
DRAWN BY	DATES	lot no.	WLOCK	DRWG. ND.
CHECKED BY		SECTION	JOB NO.	6

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# MONTGOMERY COUNTY DEPARTMENT OF PARK & PLANNING

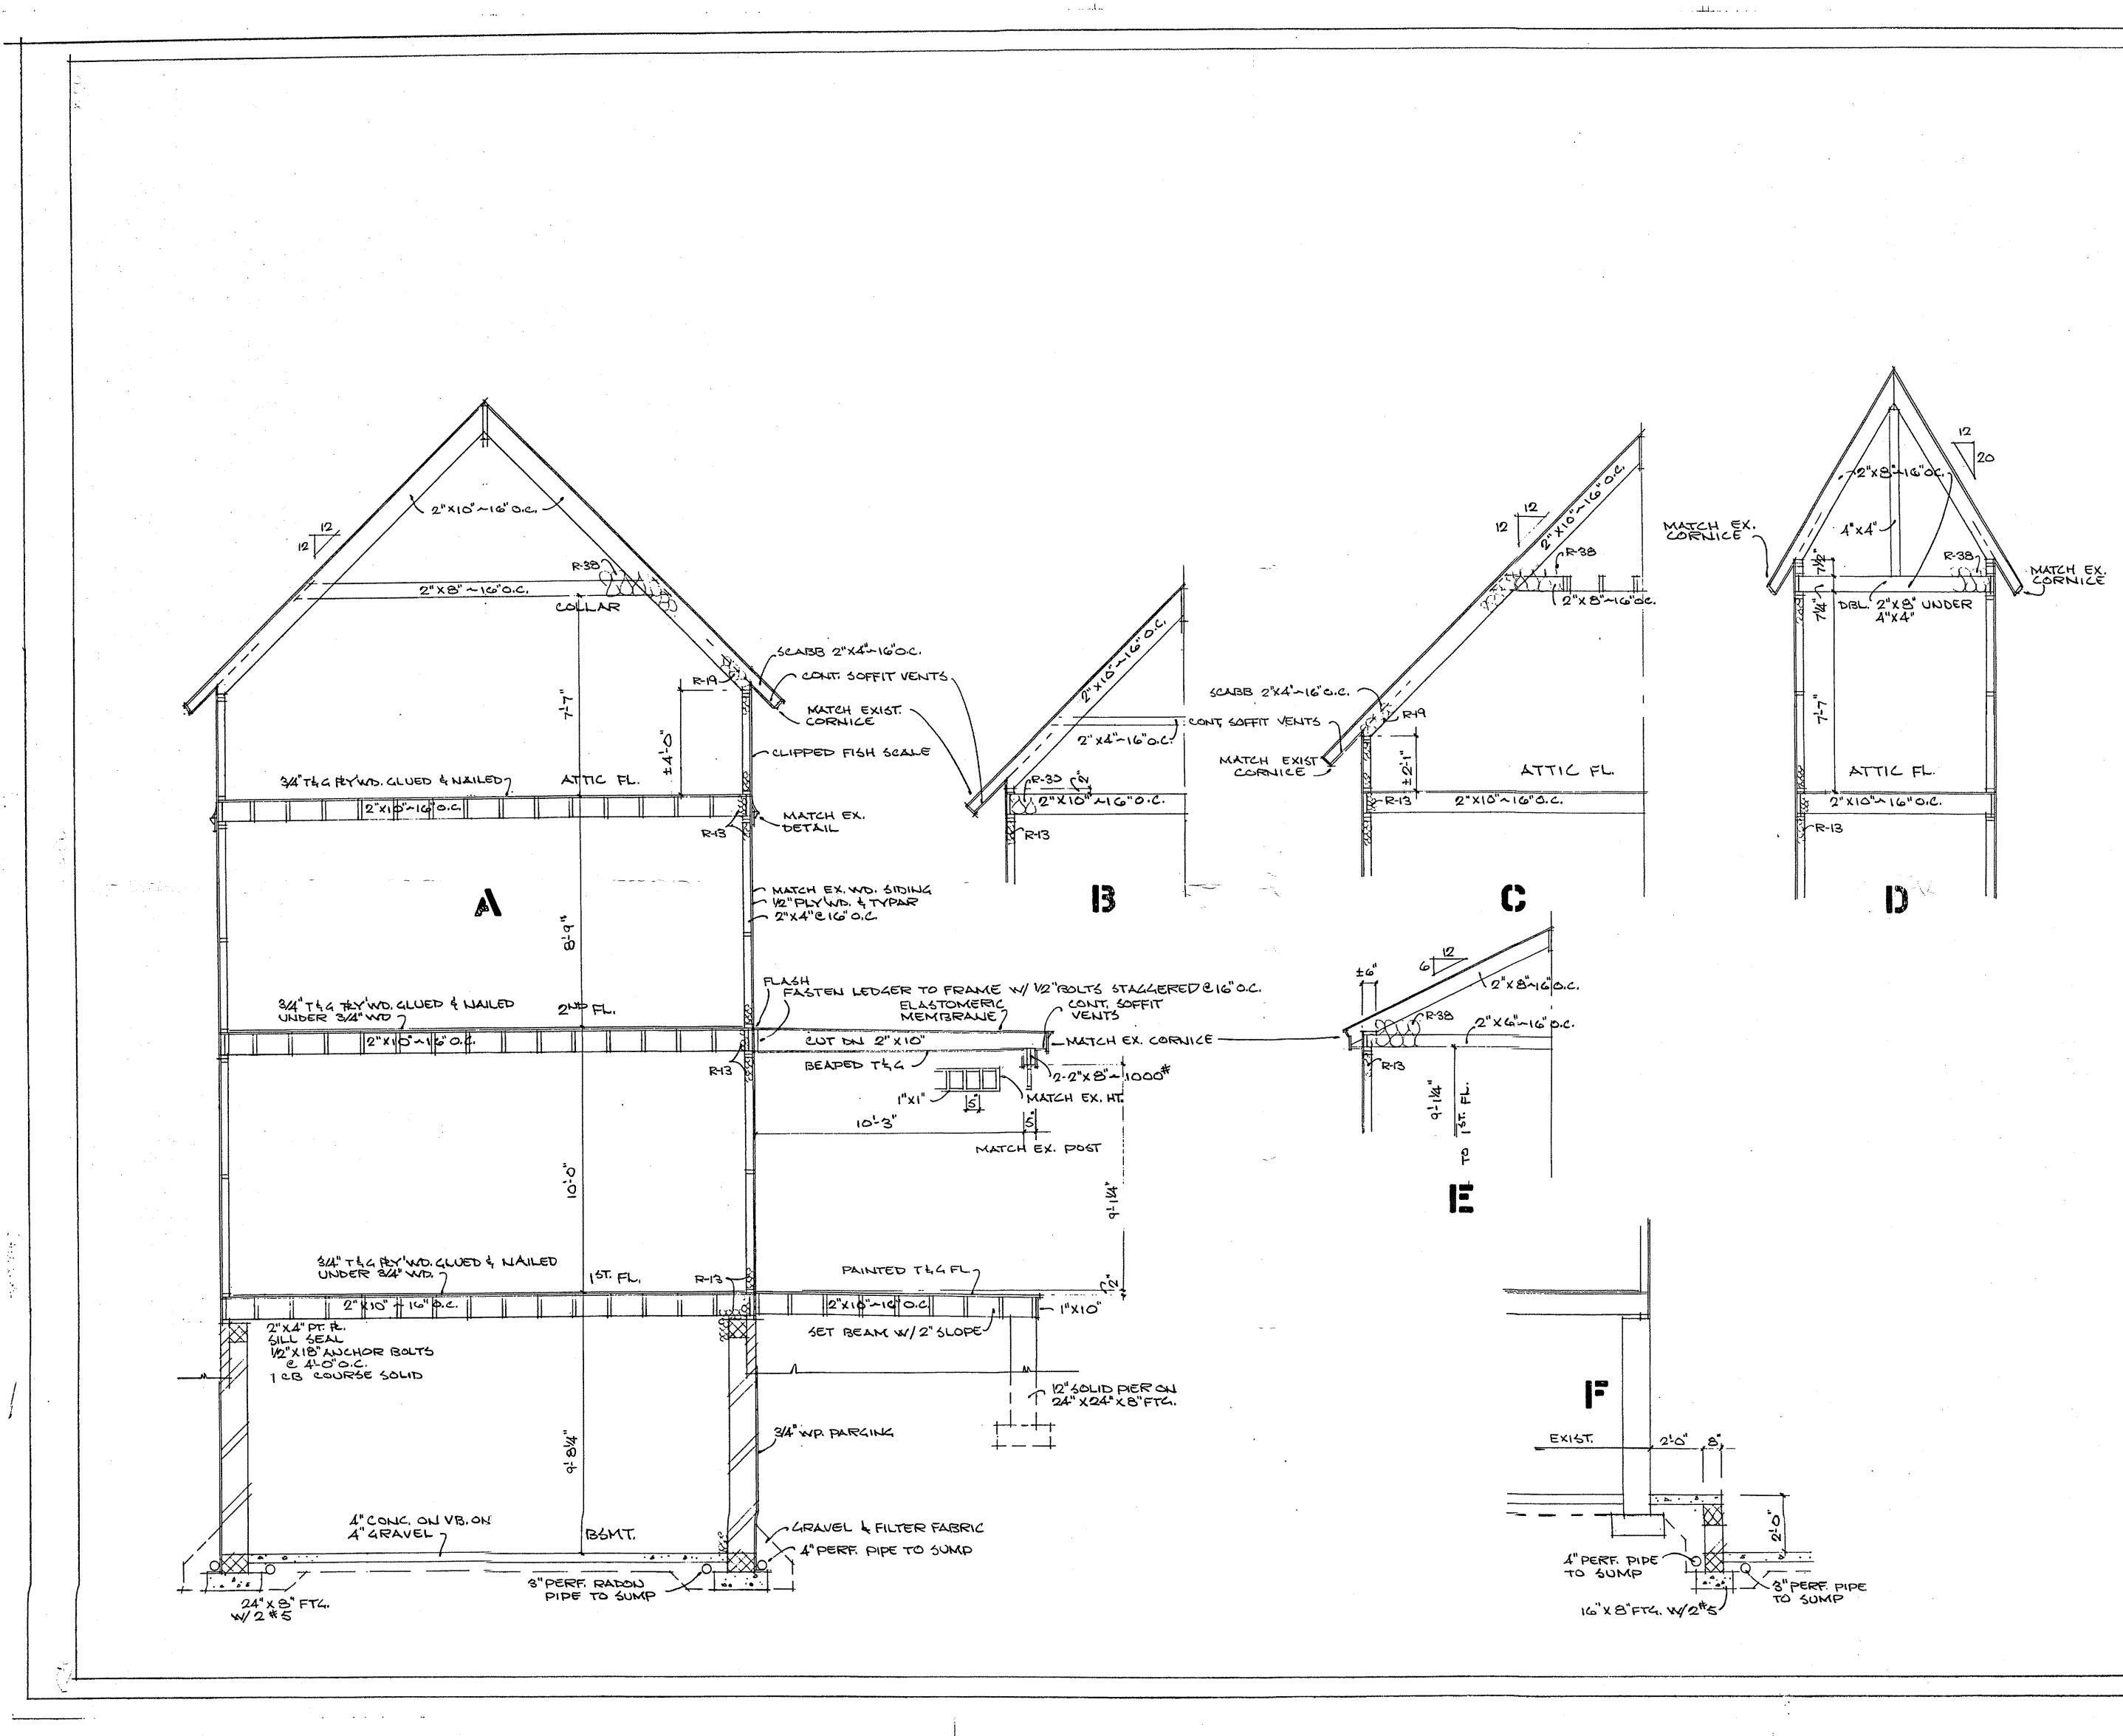THE MARYLAND-NATIONAL CAPITAL PARK AND PLANNING COMMISSION

8787 Georgia Avenue Silver Spring, Maryland 20910-3760

13/00 Date:

# **MEMORANDUM**

TO:	Robert Hubbard, Director Department of Permitting Services	
FROM:	Gwen Wright, Coordinator Historic Preservation	
SUBJECT:	Historic Area Work Permit DP5# 217797	HPC# 30/13-00B

The Montgomery County Historic Preservation Commission has reviewed the attached application for an Historic Area Work Permit. This application was:

·	_Approved
X	Approved with Conditions: 1. The spindlework and details on the new north elevation porch be the same size but.
	of different patterns and be constructed from wood. 2. The wood clapboard on the new additions should be 2" larger in width and be separated from the original massing with vertical wood trim. 3. The gable ends of the new construction are to be ornamented with a <i>clipped</i> fish scale shingle- to differentiate them from the original. 4. The window surrounds are to be of simpler design as to not replicate the existing. 5. The owner will use new door applications and not salvaged doors from Old House Parts. The new windows and doors will be wood. The windows will be true-divided light. 6. Healthy trees to be removed should be replaced with a tree on the County's Native Species Listsomewhere on the said property.

and HPC Staff will review and stamp the construction drawings prior to the applicant's applying for a building permit with DPS; and

THE BUILDING PERMIT FOR THIS PROJECT SHALL BE ISSUED CONDITIONAL UPON ADHERENCE TO THE APPROVED HISTORIC AREA WORK PERMIT (HAWP).

Applicant: FICHARD AND PAM MOREN Address: 4710 WAVER AVE, GAMETPARK

and subject to the general condition that, after issuance of the Montgomery County Department of Permitting Services (DPS) permit, the applicant arrange for a field inspection by calling the Montgomery County DPS Field Services Office at 240-777-6210 prior to commencement of work <u>and</u> not more than two weeks following completion of work.

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2	
	COMERY COMERY
	MARYLEND 301/563-3400
	APPLICATION FOR
	HISTORIC AREA WORK PERMIT
	Contact Person: Pam Morgan
	Daytime Phone No.: $\frac{301-942-1030}{FX 301-942-9025}$
	Tax Account No.: 000 303 12
	Name of Property Owner: Richard C & PN Morgan Daytime Phone No.: 301-942-1030 Address: 4710 Warry Ave. Po Box 424 Garrett Park, MD 20896-0424
ч	Street Number City Steet Zip Code
	Contractor: tbd ov ourselves Phone No.:
	Agent for Owner: <u>tbd</u> or <u>nonc</u> Daytime Phone No.:
	LOCATION OF BUILDING/PREMISE
	House Number: 4710 Street Waverly Avenue
	Town/City: <u>Garrett Park</u> Nearest Cross Street: <u>Montrose</u> <u>Avenue</u> Lot: 16+PFLF17 Block: <u>99</u> Subdivision: <u>Garrett Park</u> 003 = SUB
	Liber:
	PART ONE: TYPE OF PERMIT ACTION AND USE
	1A. CHECK ALL APPLICABLE: CHECK ALL APPLICABLE:
	Construct Of Extend of Alter/Renovate A/C Slab Of Room Addition of Porch Deck Shed
	□ Revision □ Repair □ Revocable □ Fence/Wall (complete Section 4) □ Other: dviveway,
	1B. Construction cost estimate: \$ 120,000 tree removal
	1C. If this is a revision of a previously approved active permit, see Permit #
	PART TWO: COMPLETE FOR NEW CONSTRUCTION AND EXTEND/ADDITIONS 2A. Type of sewage disposel: 01 12 WSSC 02 C Septic 03 C Other:
	2A. Type of sewage disposal:       01 12 WSSC       02
	PART THREE: COMPLETE ONLY FOR FENCE/RETAINING WALL
	3A. Heightinches    inches
	<ul> <li>3B. Indicate whether the fence or retaining wall is to be constructed on one of the following locations:</li> <li>On party line/property line</li> <li>Entirely on land of owner</li> <li>On public right of way/easement</li> </ul>
	I hereby cartify that I have the authority to make the foregoing application, that the application is correct, and that the construction will comply with plans approved by all agencies listed and I hareby acknowledge and accept this to be a condition for the issuance of this parmit. Richard C. Morgan
	Pamela N. Morlon 4/18/60 Signature of owner or authorized agent Date
	Approved: X W/CONDITIONS or Chairperon, Historic reservation Commission Disapproved:Signature:Date: 10 13/00 Application/Permit No.: 217797 Date Filed: Date Issued:
	Application/Permit No.:       2       1       1       Date Filed:       Date Issued:         Edit 6/21/99       SEE REVERSE SIDE FOR INSTRUCTIONS       30/13-00B

### LOWING ITEMS MUST BE COMPLETED THE **REQUIRED DOCUMENTS** APPLICATION.

### 1. WRITTEN DESCRIPTION OF PROJECT

- a. Description of existing structure(s) and environmental setting, including their historical features and significance: Garrett Park is a well-known historic town described in the Master Phn. house was Duilt 1891 as a summer in It has home table Hoors ing attic onda ina had an extensive addition at the Yrav construction interior onginal an extension 16 £ previous owners at believe CX DOSO to code monitat : Givina mbe aspens trozen Other inf erior-construction problems include sinkly , which g for b. General description of project and its effect on the historic resourca(s), the anvironmental setting, and, whare applicable, the historic district: the project is to and improve the interior extend. extensione. be streng Thened. atim m drate Low stopped, and plumbing re in Walls and The extension i be used for an elderly seni-inva The project inch dee a roump for disabled acer 50 changes at The rear are visible from the public right not variante -01 2. SITE PLAN
  - a. the scale, north arrow, and date; 11 99.1 b. dimensions of all existing and proposed structures; and 1

c. site features such as walkways, driveways, fences, ponds, streams, trash dumpsters, mechanical equipment, and landscaping.

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### 3. PLANS AND ELEVATIONS

You must submit 2 copies of plans and elevations in a format no larger than 11" x 17", Plans on 8 1/2" x 11" paper are preferred,

- a. Schematic construction plans, with marked dimensions, indicating location, size and general type of walls, window and door openings, and other fixed features of both the existing resource(s) and the proposed work.
- b. Elevations (facades), with marked dimensions, clearly indicating proposed work in relation to existing construction and, when apprepriate, context. All materials and fixtures proposed for the exterior must be noted on the elevations drawings. An existing and a proposed elevation drawing of each facade affected by the proposed work is required.

### 4. MATERIALS SPECIFICATIONS

General description of materials and manufactured items proposed for incorporation in the work of the project. This information may be included on your design drawings. ່ນ ເ

### 5. PHOTOGRAPHS

- a. Clearly labeled photographic prints of each facede of existing resource, including datails of the affected portions. All labels should be placed on the front of photographs.
- b. Clearly label photographic prints of the resource as viewed from the public right-of-way and of the adjoining properties. All labels should be placed on the front of photographs.

### 6. TREE SURVEY

If you are proposing construction adjacent to or within the dripline of any tree 6" or larger in diameter (at approximately 4 feet above the ground), you must file an accurate tree survey identifying the size, location, and species of each tree of at least that dimension.

### 7. ADDRESSES OF ADJACENT AND CONFRONTING PROPERTY OWNERS

For ALL projects, provide an accurate list of adjacent and confronting property owners (not tenants), including names, addresses, and zip codes. This list should include the owners of all lots or parcels which adjoin the parcel in questian, as well as the owner(s) of lot(s) or parcel(s) which lie directly across the street/highway from the parcel in question. You can obtain this information from the Department of Assessments and Texation, 51 Monroe Street, Rockville, (301/279-1355).

PLEASE PRINT (IN BLUE OR BLACK INK) OR TYPE THIS INFORMATION ON THE FOLLOWING PAGE. PLEASE STAY WITHIN THE GUIDES OF THE TEMPLATE, AS THIS WILL BE PHOTOCOPIED DIRECTLY DNTD MAILING LABELS.



# MONTGOMERY COUNTY DEPARTMENT OF PARK AND PLANNING

THE MARYLAND-NATIONAL CAPITAL PARK AND PLANNING COMMISSION

8787 Georgia Avenue Silver Spring, Maryland 20910-3760

# **MEMORANDUM**

DATE: 10/13/00

TO: Local Advisory Panel/Town Government

FROM: Historic Preservation Section, M-NCPPC Robin D. Ziek, Historic Preservation Planner Perry Kephart, Historic Preservation Planner Michele Naru, Historic Preservation Planner

SUBJECT: Historic Area Work Permit Application - HPC Decision

OPEK. The Historic Preservation Commission reviewed this project on A copy of the HPC decision is enclosed for your information.

Thank you for providing your comments to the HPC. Community involvement is a key component of historic preservation in Montgomery County. If you have any questions, please do not hesitate to call this office at (301) 563-3400.



# MONTGOMERY COUNTY DEPARTMENT OF PARK & PLANNING

THE MARYLAND-NATIONAL CAPITAL PARK AND PLANNING COMMISSION

8787 Georgia Avenue Silver Spring, Maryland 20910-3760

00 Date:

# MEMORANDUM

TO:	Historic Area Work Permit Applicants
FROM:	Gwen Wright, Coordinator Historic Preservation Section
SUBJECT:	Historic Area Work Permit Application - Approval of Application/Release of Other Required Permits DPS# 217797 HPC# 30/13-00B

Enclosed is a copy of your Historic Area Work Permit application, approved by the Historic Preservation Commission at its recent meeting, and a transmittal memorandum stating conditions (if any) of approval.

You may now apply for a county building permit from the Department of Permitting Services (DPS) at 255 Rockville Pike, second floor, in Rockville. Please note that although your work has been approved by the Historic Preservation Commission, it must also be approved by DPS before work can begin.

When you file for your building permit at DPS, you must take with you the enclosed forms, as well as the Historic Area Work Permit that will be mailed to you directly from DPS. These forms are proof that the Historic Preservation Commission has reviewed your project. For further information about filing procedures or materials for your county building permit review, please call DPS at 240-777-6370.

If your project changes in any way from the approved plans, either before you apply for your building permit or even after the work has begun, please contact the Historic Preservation Commission staff at 301-563-3400.

Please also note that you must arrange for a field inspection for conformance with your approved HAWP plans. Please inform DPS/Field Services at 240-777-6210 of your anticipated work schedule.

Thank you very much for your patience and good luck with your project!

# HISTORIC PRESERVATION COMMISSION STAFF REPORT

Address:	4710 Waverly Ave, Garrett Park	Meeting Date:	05/10/00	
<b>Resource:</b>	Garrett Park Historic District	<b>Report Date:</b>	05/03/00	
Review:	HAWP	Public Notice:	04/26/00	
<b>Case Number: </b> 30/13-00B		Tax Credit: None		
Applicant:	Richard and Pam Morgan	Staff: Michele Naru		
PROPOSAL	.: Side and rear additions	RECOMMEND: A	pprove w/ cond.	

# PROJECT DESCRIPTION

SIGNIFICANCE:Outstanding Resource in Garrett Park Historic District.STYLE:Queen AnneDATE:1889

This three-story, three-bay frame dwelling is an outstanding resource located in the Garrett Park Historic District. The house has a full-width front gable roof ornamented with a hexagonal tower. The walls are clad in clapboard with wood shingle and half-timber detailing in the gable ends. A one-story, wrap-around porch with pedimented entry extends across the front elevation of the house. The porch is ornamented with elaborate spindlework porch supports, frieze and balustrade. Alterations to the original main block of the house includes two rear additions, one circa 1898 and one circa 1986.

### PROPOSAL:

The applicant proposes to increase the the existing house 1241 sq. ft. by (Circle ):

- 1. Extending the existing wrap-around porch around the south elevation and constructing a two-story side addition with a 2-1/2 story hexagonal tower (to house a new elevator) and rear porch. The vocabulary of the existing front porch and the original block of the house will be continued throughout the new porch extension and two-story addition.
- 2. Constructing a one-story porch on the north elevation. This porch will also mimic the existing vocabulary of the original porch.
- 3. Constructing a 1-1/2 story addition on top of the existing non-historic, one-story, rear addition. Extending this addition by constructing a new 2-1/2 story extension and 1 story sunroom to its east elevation.

- 4. Constructing a ramp at the rear to allow for disabled access.
- 5. Removing original driveway and constructing a new driveway along the south side of the house.

The materials used on the new additions and porches will match the fabric of the original block. These elements include porch spindlework and details, clapboard siding, half-timbering and shingles in the gable ends, true-divided light wood windows and doors from Old House Parts.

# **STAFF DISCUSSION**

Staff applauds the care and thought that has been put into the architectural design of these new additions. Staff feels that much of the design is respectful of the original structure and is in keeping with the period of the house. However, staff is concerned with the alterations to the original block of the house. This is an outstanding resource in the historic district and is subject to the highest level of review. Changes to the main block of an outstanding resource are problematic.

The continuation of the wrap-around porch along is south elevation as proposed will change the existing character defining configuration of the house. The Queen Anne Style is notable for it's a-symmetrical porch types. Changing the original configuration of the porch will alter the historic integrity and the a-symmetrical design of this outstanding resource. It is for these reasons that staff does not support this alteration to the main block.

Staff generally supports alterations to outstanding resources on rear additions that are not visible from the public right-of-way. Although, the design scheme for the 2-1/2 story, c.1898 rear addition will result in no changes to the original block of the house, additions to a building that have acquired historic significance in its own right should generally be preserved. This addition is a very large addition to this outstanding resource in Garrett Park. Staff is concerned with the magnitude of this project and would encourage the applicant to reduce its size. Staff notes that this proposed addition is designed to provide a living space for an elderly semi-invalid family member. The applicant needs this additional space and an elevator to accommodate the expansion of their household. Staff supports the modifications to the rear although the modifications will be sacrificing the integrity of the historic rear addition.

Staff feels that the height of the proposed 2-1/2 story, c. 1898, rear addition is not problematic due to the lot's grading. The existing house sits on a lot that is significantly above street level. Therefore, the alterations to the rear will not be visible from the right-of-way. (The chimney on the main block is not visible from the public right-of-way and staff notes that the chimney is notably taller than the proposed height of the new addition.)

Staff is concerned that the proposed rear changes will read as part of the original massing of the house. Staff would encourage the applicant to change the materials and design of the details so

the new additions read clearly as contemporary additions to the house. In order to differentiate the original from the new staff suggests that:

- 1. The spindlework and details on the new north elevation porch be the same size but of different patterns.
- 2. The clapboard on the new additions should be 2" larger in width and be separated from the original massing with vertical wood trim.
- 3. The gable ends are to be ornamented with an imbrication of a different pattern (See Circle ) and the half-timbering is not to be used.
- 4. The window surrounds are to be of simpler design as to not replicate the existing.
- 5. The owner should use new door applications and not salvaged doors from Old House Parts. The use of historic salvaged pieces on new construction gives a false sense of history.

The rear, one-story addition was built in 1986. Staff does approve the modifications to this addition.

The applicant is also proposing a change in the location of the lot's driveway. Presently the driveway is located along the north elevation. The applicant desires to move the driveway parallel to the south elevation of the house. Staff encourages this modification, because the existing driveway separates the house from the adjacent lot which is part of the owners property. Moving this driveway erases this division and allows one to view the adjacent parcel as being associated with the house.

The applicant has provided the Commission with a tree survey indicating the trees to be removed for this proposal (Circle ). The applicant has also provided staff with a letter from a certified arborist on the status of the trees to be removed (Circle ). The trees to be removed are a 12"dia. cedar, 7"dia. dogwood, 18"dia. evergreen, 14"dia. evergreen, and three trees are potentially dead or dying. Removal of healthy trees is generally discouraged, however, this lot is heavily wooded and staff feels that the removal of these trees will not adversely affect the lot's environmental setting. As a pro-active measure, staff would encourage the applicant to plant a tree on the lot for every healthy tree to be removed.

The **Garrett Park LAP** has not responded to the HAWP application at the time this report was prepared.

# **STAFF RECOMMENDATION**

Staff recommends that the Commission **approve with conditions** the HAWP application as being consistent with Chapter 24A-8(b)2:

The proposal is compatible in character and nature with the historical, archeological, architectural or cultural features of the historic site or the historic district in which an historic resource is located and would not be detrimental thereto or to the achievement of the purposes of this chapter,




and with the Secretary of the Interior Guideline #9:

New additions, exterior alterations, or related new construction will not destroy historic materials, features and spatial relationships that characterize the property. The new work shall be differentiated from the old and will be compatible with the historic materials, features, size, scale and proportion, and massing to protect the integrity of the property and its environment.

and with the conditions:

- 1. Applicant to get staff level approval for all exterior materials to be used on the new additions and extensions.
- 2. Healthy trees to be removed should be replaced with a tree on the native species list somewhere on said property.
- 3. New wood doors to be installed on new additions. Historic salvaged doors are not to be used.
- 4. The wrap-around front porch is not continued around the south elevation.

with the general condition applicable to all Historic Area Work Permits that the applicant will present 3 permit sets of drawings to HPC staff for review and stamping prior to submission for permits. After issuance of the Montgomery County Department of Permitting Services (DPS) permit, the applicant will arrange for a field inspection by calling the DPS Field Services Office at 240-777-6370 prior to commencement of work and not more than two weeks following completion of work.

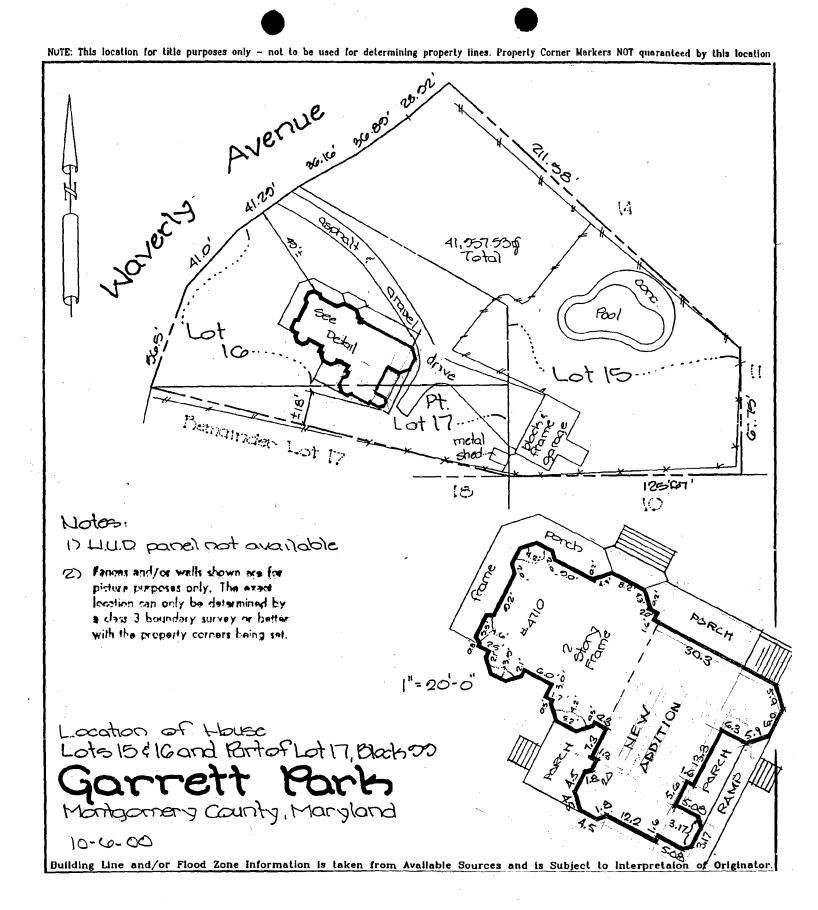

1.1.12.127-259-149

MECcheck COMPLIAN	CE REPORT
1995 Model Energy	Code
MECcheck Software	Version 2.0

Permit #
Checked by/Date

COUNTY: Montgomery STATE: Maryland HDD: 4999 CONSTRUCTION TYPE: Single Family DATE: 10-7-1997

DATE OF PLANS: 10-6-2000

TITLE: PROJECT INFORMATION: Addition to: Morgan Residence

# COMPLIANCE: PASSES

Required UA = 643 Your Home = 625

	Area or	Insul	Sheath	Glazing/Door	
	Perimeter	<b>R-Value</b>	<b>R-Value</b>	<b>U-Value</b>	UA
CEILINGS	 220	19.0	0.0		11
CEILINGS	880	38.0	0.0		26
WALLS: Wood Frame, 16" O.C.	3025	13.0	0.0		249
WALLS: Masonry	87	13.0	0.0		7
GLAZING: Windows or Doors	519			0.500	260
BSMT: 8.7' ht/5.5' bg/8.7' insul.	1136	13.0			64
SLAB FLOORS: Unheated, 36.0" insul	. 11	4.0		· .	8
WALLS: Wood Frame, 16" O.C. WALLS: Masonry GLAZING: Windows or Doors BSMT: 8.7' ht/5.5' bg/8.7' insul.	3025 87 519 1136	13.0 13.0 13.0	0.0		249 7 260 64

COMPLIANCE STATEMENT: The proposed building design represented in these documents is consistent with the building plans, specifications, and other calculations submitted with the permit application. The proposed building has been designed to meet the requirements of the 1995 CABO Model Energy Code.

\_\_\_\_\_\_

Builder/Designer

Date

MECcheck INSPECTION CHECKLIST 1995 Model Energy Code MECcheck Software Version 2.0

DATE:	10-7-1997
Bldg. Dept. Use	
	CEILINGS:
[]	1. R-19
	Comments/Location
[]	2. R-38 Comments/Location
	WALLS:
[]	1. Wood Frame, 16" O.C., R-13
•••	Comments/Location
[]	2. Masonry, R-13 Comments/Location
	WINDOWS AND GLASS DOORS:
[]	1. U-value: 0.50
•••	For windows without labeled U-values, describe features:
	<pre># Panes Frame Type Thermal Break? [ ] Yes [ ] No</pre>
	Comments/Location
	BASEMENT WALLS:
[]	1. 8.7' ht/5.5' bg/8.7' insul., R-13
	Comments/Location
	SLAB-ON-GRADE FLOORS:
[]	1. Unheated, 36.0" insul., R-4
	Comments/Location
	Slab insulation to extend down from the top of the slab to at
	least 36" OR down to at least the bottom of the slab then
	horizontally for a total distance of 36".
	AIR LEAKAGE:
[]	Joints, penetrations, and all other such openings in the building
	envelope that are sources of air leakage must be sealed. Recessed
	lights must be type IC rated and installed with no penetrations
	or installed inside an appropriate air-tight assembly with a 0.5"
	clearance from combustible materials and 3" clearance from insulation.
`	VAPOR RETARDER:
[]	Required on the warm-in-winter side of all non-vented framed
	ceilings, walls, and floors.
	MATERIALS IDENTIFICATION:
[]	Materials and equipment must be identified so that compliance can
	be determined. Manufacturer manuals for all installed heating
	and cooling equipment and service water heating equipment must be
	provided. Insulation R-values and glazing U-values must be clearly
	marked on the building plans or specifications.
	DUCT INSULATION:
[]	Ducts in unconditioned spaces must be insulated to R-5.

Ducts outside the building must be insulated to R-8.0.

DUCT CONSTRUCTION:

[] All ducts must be sealed with mastic and fibrous backing tape. Pressure-sensitive tape may be used for fibrous ducts. The HVAC system must provide a means for balancing air and water systems.

TEMPERATURE CONTROLS:


[] Thermostats are required for each separate HVAC system. A manual or automatic means to partially restrict or shut off the heating and/or cooling input to each zone or floor shall be provided.

MISC REQUIREMENTS:

[] Refer to the MECcheck Manual for requirements relating to swimming pools, HVAC piping conveying fluids above 120 F or chilled fluids below 55 F, and circulating hot water systems.

----NOTES TO FIELD (Building Department Use Only)-----

House Location page 8.7 Lots 15 & 16, Section No. 99 DETAIL : 1" = 20' Sub Lot 1 of 17 in Mrs Hadassah H. Hellen's Subdivision of Lot No 17, Section 99 As Amended Addition GARRETT PARK Montgomery County, Maryland in - 10375 opy . I hereby certify that the plan shown hereon is correct, and that the SHINGLE improvements are correctly shown on this plan. August 20, 1962 William Neal Hurley, Jr., Surveyor .×. Scale: 1" - 40' Plat Book A, Plat 24 r J.A. 4, Folio 121 Md 3025 AVENUE see enlargement for 1"= 201 scale. LOT 15 : 23219 not included Lot 16 . 13941 SUB LOT OF 17 . 4796 \$ TOTAL = 41,956 \$ SEE DETAIL DRAWING 240-13 1 AVER L 100 p 22. le tine driveway REMAINING PART OF Lot 17 Not INCLUDED 28.7

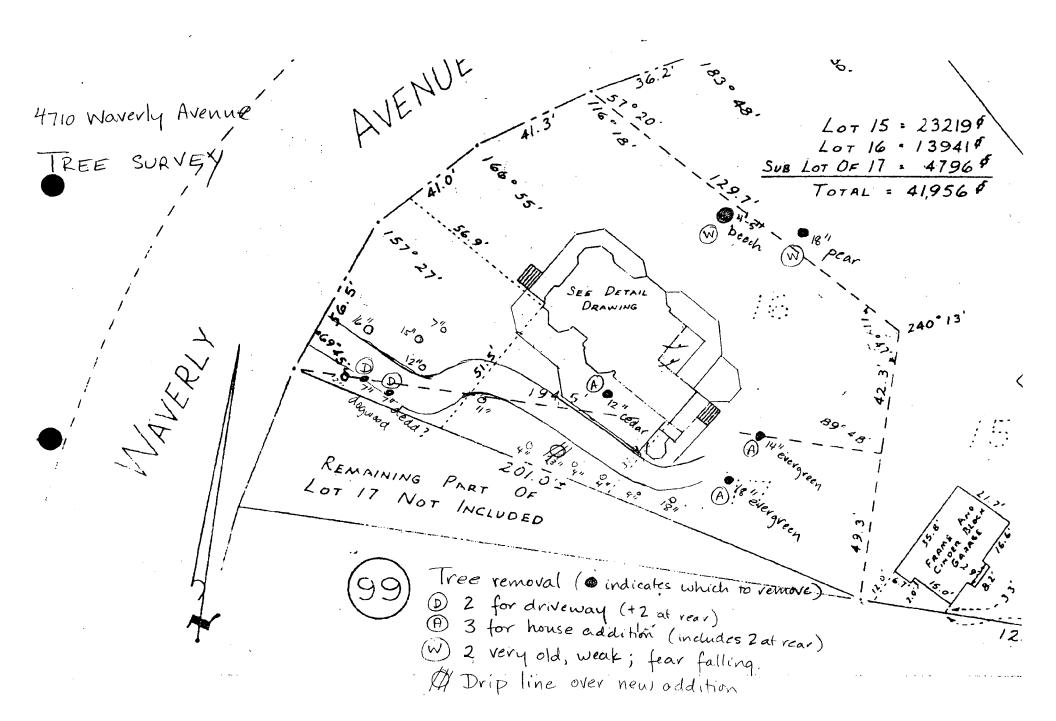

4710 Waverly Over. Garrett Parko Adjacent and Confronting Property Owners

Hat Rye and Bill Spinard 4702 Waverly Ave Po Box 312 Garrett Park, MD 20896-0312

(adjacent north east)


Left and Margaret Human 4709 Noverly Ave PO Box 113 Garrett Park, MD 20896-0113

(confronting, north)

Glenn and Kitty Roberts (confronting, north west) 4711 Waverly Ave Po Box 159 Garrett Park, MD 20896-0159

Ken and Jane Saloman (adjacent, south) 4716 Waverly Ave Po Box 227 Garrett Park, MD 20896-0227

Ruby Freer (rear, east) 10934 Montrose Rd PO Box 144 Gavrett Park, MD 20896-0144 (no building visible from rear)

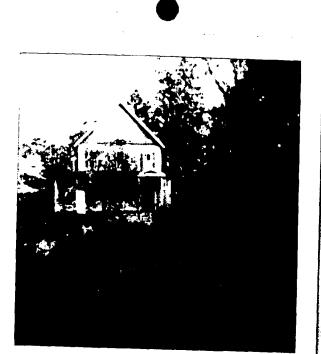

4710 Waverly Ave. from 4711 Waverly Ave.

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4710 Waverly Ave. front elevation from public right of way

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4710 Waverly Ave.
 from 4716 Waverly Ave.
 (left elevation)



4710 Waverly Ave. from 4716 Waverly Ave. (left elevation)



4710 Waverly Ave. from 4709 Waverly Ave.



4710 Waverly Ave. right elevation from public right of way



4710 Waverly Ave. right elevation from own private yard



4710 Waverly Ave. from 4702 Waverly Ave.



4710 Waverly Ave. rear elevation from own private yard



4710 Waverly Ave. rear elevation from own private yard

Coriginal photographs alocady submitted to Michelle Nary, Mart Co Dept of Park & Planning, 301-563-3400)

