4923 Dorset Arenve, Chovy Chur HPC Pax No. 35/36-08B Somerset H.D.

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HISTORIC PRESERVATION COMMISSION

Isiah Leggett County Executive Jef Fuller Chairperson

Date: 25 September, 2008

MEMORANDUM

| TO: | Carla Reid, Director |
|-------|-----------------------------------|
| | Department of Permitting Services |
| FROM: | Rachel Kennedy, Senior Planner |
| | Historic Preservation Section |

SUBJECT: Historic Area Work Permit #494294, Second-story addition over existing one-story addition.

Maryland-National Capital Park & Planning Commission

The Montgomery County Historic Preservation Commission (HPC) has reviewed the attached application for a Historic Area Work Permit (HAWP). This application was approved at the September 24, 2008 meeting.

The HPC staff has reviewed and stamped the attached construction drawings.

THE BUILDING PERMIT FOR THIS PROJECT SHALL BE ISSUED CONDITIONAL UPON ADHERENCE TO THE ABOVE APPROVED HAWP CONDITIONS AND MAY REQUIRE APPROVAL BY DPS OR ANOTHER LOCAL OFFICE BEFORE WORK CAN BEGIN.

Applicant: John Stewart and Sharon Stoliaroff.

Address: 4823 Dorset Avenue, Chevy Chase. Somerset Historic District.

This HAWP approval is subject to the general condition that the applicant will obtain all other applicable Montgomery County or local government agency permits. After the issuance of these permits, the applicant must contact this Historic Preservation Office if any changes to the approved plan are made.



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| | HISTORIC PRESERVATION COMMISSION | | |
| e e e e e e e e e e e e e e e e e e e | *ARYLAN 301/563-3400 | | |
| | APPLICATION FOR | | |
| | | | |
| | HISTORIC AREA WORK PERMIT | | |
| · · · · | Contact Person: KB1 TONS | | |
| | Daytime Phone No.: 301. 840. 9121 × 7 | 2 | |
| | Tax Account No.: DETABOOI GUULDE; 703-981.8812 | | |
| | Name of Property Owner: bun Stwart/Sharon Ste bayume Piton No.: 301-1054 - 2989 | | |
| | Address: 4823 DOEGET AVE CUDENY CUDEE MAP JOBIE | <i>`</i> > | |
| | Street Number City Staet Zip Code | | |
| | Contractor: Uppking & POFECTAC. Phone No.: 301-840-9121 X2 | 2 | |
| | Contractor Registration No.: MHTC \$ (119 | • | |
| | Agent for Owner: | 2 | |
| | LOCATION OF BUILDING/PREMISE | | |
| | House Number: 4823 Street DOREST AVE. | | |
| | Town/City: | | |
| | Lot: Block: Subdivision:O44 | | |
| | Liber: Folio: Parcet: | | |
| | PART ONE: TYPE OF PERMIT ACTION AND USE | | |
| | 1A. CHECK ALL APPLICABLE: CHECK ALL APPLICABLE: | | |
| | 🗆 Construct 🖉 Extend 🖉 Alter/Renovate 🛛 🎜 A/C 🗆 Slab 🖉 Room Addition 🗆 Porch 🗆 Deck 🗆 Shed | | |
| | 🗆 Move 🔹 Install 💭 Wreck/Raze 💿 Solar 🗆 Fireplace 🗔 Woodburning Stove 💭 Single Family | | • |
| | Revision Repair Revocable Fence/Wall (complete Section 4) Other: | • | ÷ |
| · | 1B. Construction cost estimate: \$ 226 K | • | |
| | 1C. If this is a revision of a previously approved active permit, see Permit # | | |
| | PART TWO: COMPLETE FOR NEW CONSTRUCTION AND EXTEND/ADDITIONS | •, | |
| | 2A. Type of sewage disposal: 01 🖉 WSSC 02 🗆 Septic 03 🗆 Other: | | |
| | 28. Type of water supply: 01 🗹 WSSC 02 🗌 Well 03 🗌 Other. | | |
| | PART THREE: COMPLETE ONLY FOR FENCE/RETAINING WALL | | |
| | 3A. Height feet inches | | |
| | 3B. Indicate whether the fence or retaining wall is to be constructed on one of the following locations: | | • |
| | On party line/property line Entirely on land of owner On public right of way/easement | | |
| | | | |
| | I hareby certify that I have the authority to make the foregoing application, that the application is correct, and that the construction will comply with plans approved by all agancies listed and I hereby acknowledge and accept this to be a condition for the issuance of this permit. | i | |
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| | The second | | |
| | Signature of owner or euthorized agent Usete | | |
| | Approved: TK For Cheirperson, Historic Preservation Commission | | |
| | | | |
| | Application/Permit No.: 494314 Date Field: 8/27/08 Date issued: | | |
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| | Edit 6/21/99 SEE REVERSE SIDE FOR INSTRUCTIONS | | |
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THE FOLLOWING ITEMS MUST BE COMPLETED AND THE REQUIRED DOCUMENTS MUST ACCOMPANY THIS APPLICATION.

1. WRITTEN DESCRIPTION OF PROJECT

a Description of existing structure(s) and environmental setting, including their historical features and significance: SHINGLE STYLE HOUSE BUILT C. 1910 FOR DC. JAMES DELGON; SERVED AS BEE LAB FOR US DA BUICON OF ENDINDLOGY 1917-1939. A FLAT. FOOFFO ADDITION (1 FLOOD + BSINT) WAS ADDED TO THE N.W. CORNER OF THE HOUSE C. 1960'S HOUSE IS IN SOMERSET HISTORIC DISTRET. MAIN HOUSE IS CROSS GABLED SHINGLED. 1960 & ADDITION IS BUILT. UP ROOF, BELCH, I CLAPBOARD WI TEMM. AT REAR OF HOUSE, SCREENED PORCH WAS ADDED IN LATE 1900'S AFTER TREE DAMAGE.

b. General description of project and its effect on the historic resource(s), the environmental setting, and, where applicable, the historic district: THE PEOPLESE PEOPLECT AFFECTS THE 1960'S FLAT PORTED ADDITION ON LY. A POOM WHILE ADDED ON TOP OF THE FLATEORED 1960'S ADDITION, WHICH HAS ALWAYS APPEARED SOMEWHAT: TRINCATED NEXT TO THE ARACEFUL PROPORTIONS OF THE ORIGINAL HOUSE, THE NEW POOM WILL HAVE A PITZUED POOF GABLED IN HARMONY WITH THE MAIN HOUSE'S POOF LANES. SID INK, WILL BE STAINED SHINGLES TO MATCH THE HOUSE, AND THE ENTITY of SCALE OF THE NEW FENESTED TION WILL 2. SITE PLAN ALGO DEFED. TO THE MAIN HOUSE'S ARCHITECTORE.

TK,

Site and environmental setting, drawn to scale. You may use your plat. Your site plan must include:

- a. the scale, north arrow, and date:
- b. dimensions of all existing and proposed structures; and

c. site features such as welkways, driveways, fences, ponds, streams, trash dumpsters, mechanical equipment, and landscaping.

3. PLANS AND ELEVATIONS

You must submit 2 copies of plans and elevations in a format no larger than 11" x 17". Plans on 8 1/2" x 11" paper are preferred.

- a. Schematic construction plans, with marked dimensions, indicating lacation, size and general type of walls, window and door openings, and other fixed features of both the existing resource(s) and the proposed work.
- b. Elevations (facades), with marked dimensions, clearly indicating proposed work in relation to existing construction and, when appropriate, context. All materials and fixtures praposed for the exterior must be noted on the elevations drawings. An existing and a proposed elevation drawing of each facade affected by the proposed work is required.

4. MATERIALS SPECIFICATIONS

General description of materials and manufactured items proposed for incorporation in the work of the project. This information may be included on your design drawings.

5. PHOTOGRAPHS

- a. Clearly labeled photographic prints of each facade of existing resource, including details of the affected portions. All labels should be placed on the front of photographs.
- b. Clearly label photographic prints of the resource as viewed from the public right-of-way and of the adjoining properties. All labels should be placed on the front of photographs.

6. TREE SURVEY

If you are proposing construction adjacent to or within the dripline of any tree 6" or larger in diameter (at approximately 4 feet above the ground), you must file an accurate tree survey identifying the size, location, and species of each tree of at least that dimension.

7. ADDRESSES OF ADJACENT AND CONFRONTING PROPERTY OWNERS

For <u>ALL</u> projects, provide an accurate list of adjacent and confronting property owners (not tenants), including names, addresses, and zip codes. This list should include the owners of all lots or parcels which adjoin the parcel in question, as well as the owner(s) of lot(s) or parcel(s) which lie directly across the street/nighway from the parcel in question. You can obtain this information from the Department of Assessments and Taxation, 51 Monroe Street, Rockville, (301/279-1355).

PLEASE PRINT (IN BLUE OR BLACK INK) OR TYPE THIS INFORMATION ON THE FOLLOWING PAGE. PLEASE STAY WITHIN THE GUIDES OF THE TEMPLATE, AS THIS WILL BE PHOTOCOPIED DIRECTLY ONTO MAILING LABELS.

| Address: | 4823 Dorset Avenue, Chevy Chase | Meeting Date: | 09.24.2008 |
|--------------|---|----------------|----------------|
| Resource: | Contributing Resource Somerset Historic District | Report Date: | 09.17.2008 |
| Applicant: | John Stewart and Sharon Stoliaroff Kai Tong, Architect | Public Notice: | 09.10.2008 |
| Review: | HAWP | Tax Credit: | None |
| Case Number: | 35/36-08B | Staff: | Rachel Kennedy |
| PROPOSAL: | Second-story addition over existing one-story addition | | |

MONTGOMERY COUNTY HISTORIC PRESERVATION COMMISSION STAFF REPORT

STAFF RECOMMENDATION:

Staff is recommending that the HPC approve this HAWP application.

ARCHITECTURAL DESCRIPTION

| SIGNIFICANCE: | Contributing Resource Within The Somerset Historic District |
|---------------|---|
| STYLE: | Shingle Style |
| DATE: | circa 1910 |

HISTORIC CONTEXT

Excerpted from: Clare Lise Cavicchi, *Places from the Past: The Tradition of Gardez Bien..,* Bold text highlights applicant's property.

36/35 SOMERSET HISTORIC DISTRICT (1890)

Somerset Heights, established in 1890, was one of Montgomery County's earliest streetcar suburbs. Five U.S. Department of Agriculture scientists formed the Somerset Heights Land Company, together purchasing 50 acres of the Williams Farm just outside of Washington D.C. Founders platted a community with a grid system of streets named after counties in England. Large lots with 30-foot setbacks sold for prices lower than those in the District of Columbia, were promoted as healthful and free of malaria. Three electric trolley lines and a steam railway (the present Georgetown Branch) were nearby for an easy commute to the District, while low taxes and the ability to vote in Maryland were also attractive selling points.

The Somerset Heights Land Company provided only minimal amenities to early residents. The company installed rudimentary water and sewer service. Though it promised improved roads, thoroughfares were muddy streets for many years. In addition, sewer problems, roaming farm animals, frozen water pipes, and lack of local schools and fire rescue were conditions plaguing early residents. In 1905, there were 35 families living in Somerset. Citizens successfully petitioned for a State Charter to incorporate as a town government and elected a mayor on May 7, 1906. The town council greatly improved the community's

quality of life, upgrading roads, repairing pipes, providing adequate water service, and contracting for fire service.

Most of the houses in Somerset were not architect-designed showplaces but builder's versions of planbook designs. Residents were solidly middle class, many of who worked for the USDA. Resident community founders did not construct high-style architectural gems, as in Chevy Chase's Section 2 or Otterbourne. If their houses, the first built in the community, set a tone for subsequent residences it was one of unassuming comfort.

Four of the company founders, Dr. Harvey E. Wiley, Dr. Charles Crampton, Dr. Daniel E. Salmon, and Miles Fuller had built large homes for themselves, by 1895. The intersection of Summit and Dorset Avenues, where the houses clustered, is known locally as Founder's Corners. The first house built in Somerset was the Wiley-Ringland House (1891 NR), 4722 DorsetAvenue, which Harvey Wiley, founder of the Pure Food and Drug Act, intended as a home for his parents. Its cubical Four Square form is enlivened with a polygonal bay and wrap-around porch. After a 1978 fire, the house was abandoned and is now in the process of restoration. Daniel Salmon, a community founder, built the Salmon House (1893), 4728 Dorset Avenue, a front-gable Colonial Revival residenœ with wrap-around porch. Salmon was an internationally known scientist and chief of the USDA's Bureau of Animal Industry. The first occupied house in Somerset was the Crampton House (1893), 4805 DorsetAvenue. Dr. Crampton, assistant chief of the USDA's Bureau of Chemistry, was Somerset's first mayor.

Early examples of standardized builder houses are found in Somerset. In 1900, developer Edward C. Halliday contracted with builders Richard and William Ough to build speculative houses. Most of the Ough houses date from 1901 and are Four Squares with gable-on-hip roofs.

The Biggs House, 4718 Cumberland, (1899) was the first house in Somerset with central heating and radiators. Warren W. Biggs was Mayor of Somerset from 1912 16. One of the few examples of high-style architecture in Somerset is the Nelson House (c1910), 4823 Dorset Avenue. Dr. James Nelson, a USDA entomologist built this multi-gabled, Shingle Style house.

Today, the mature trees, landscaping, and original grid system of streets complement the visual streetscape established a century ago. Other important features enhancing the historic character of the Somerset community include: the spacing and rhythm of the buildings, the uniform scale of the existing houses, the relationship of houses to the street, the ample sized lots and patterns of open space in the neighborhood.

PROPOSAL:

The applicant is proposing to add a second story to a one-story flat-roof 1960s garage/side entrance addition. (Garage was removed in 2007). The space will be used for a master bedroom suite. The second story addition will be constructed of frame and will be approximately 2'6" lower than the peak of the main house roof. The proposed addition is set on the footprint of the first story with the exception of a 2' overhang on the rear (north) wall and two sets of projecting bay windows on the south and west elevations. In sum, the applicant proposes:

-The roof will be a steeply pitched side gable with projecting eaves to match the main house. It will be covered in architectural gray asphalt shingles to match the main house.

-Cover the frame of the structure with stained (green) cedar shingles to match the cedar shingles on the main house. The first story is clad in wood siding with a brick foundation.

-The windows utilized will be nine-over-one simulated divided light double-hung wood sash. There will be no doors.

-All trim will be wood.

-An AC unit will be relocated under the front stair of the 1960s addition (first story). This unit will be blocked from public view by the stair itself and screened on the sides by wood lattice.

APPLICABLE GUIDELINES:

When reviewing alterations and new construction within the Somerset Historic District several documents are to be utilized as guidelines to assist the Commission in developing their decision. These documents include *Montgomery County Code Chapter 24A (Chapter 4A)*, and the *Secretary of the Interior's Standards for Rehabilitation (Standards)*. The pertinent information in these documents is outlined below.

Montgomery County Code; Chapter 24A

The Commission shall instruct the director to deny a permit if it finds, based on the evidence and information presented to or before the commission that the alteration for which the permit is sought would be inappropriate, inconsistent with or detrimental to the preservation, enhancement or ultimate protection of the historic site or historic resource within an historic district, and to the purposes of this chapter.

The Commission shall instruct the director to issue a permit, or issue a permit subject to such conditions as are found to be necessary to insure conformity with the purposes and requirements of this chapter, if it finds that:

- 1. The proposal will not substantially alter the exterior features of a historic site or historic resource within a historic district; or
- 2. The proposal is compatible in character and nature with the historical archaeological, architectural or cultural features of the historic site or the historic district in which a historic resource is located and would not be detrimental thereto of to the achievement of the purposes of this chapter; or

Secretary of the Interior's Standards for Rehabilitation

- #9 New additions, exterior alterations, or related new construction shall not destroy historic materials that characterize the property. The new work shall be differentiated from the old and shall be compatible with the massing, size, scale, and architectural features to protect the historic integrity of the property and its environment.
- #10 New additions and adjacent or related new construction shall be undertaken in such a manner that if removed in the future, the essential form and integrity of the historic property and its environment would be unimpaired.

STAFF DISCUSSION

Staff is recommending that the Commission <u>approve</u> this HAWP application as being consistent with the Montgomery County Code and *Standards*. As noted in the historic context section, the property in question is the circa 1910 Nelson house. The proposed work is respectful of the property's original historic fabric and introduces minimal change. The top story addition attempts to mimic the proportions and materials of the main house, yet can still be read as a later appendage to the main house; thus, respecting its integrity. All materials used are traditional materials that have a proven track record on or in proximity to historic buildings. Most importantly, the proposed work does not alter any spaces or features essential to the property's historic character. All change is introduced on a nonhistoric 1960s addition.

STAFF RECOMMENDATION:

Staff recommends that the Commission <u>approve</u> the HAWP application as being consistent with Chapter 24A-8(b)(1) & (2);

and with the Secretary of the Interior's Standards for Rehabilitation;

and with the general condition that the applicant shall present the **3 permit sets of drawings to Historic Preservation Commission (HPC) staff for review and stamping**prior to submission for the Montgomery County Department of Permitting Services (DPS) building permits;

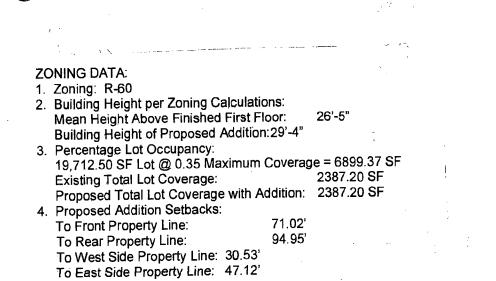
and with the general condition that the applicant shall notify the Historic Preservation Staff if they propose to make **any alterations** to the approved plans. Once the work is completed the applicant will **contact the staff person** assigned to this application at 301-563-3407 or <u>rachel.kennedy@mncppc-mc.org</u> to schedule a follow-up site visit.

p.2

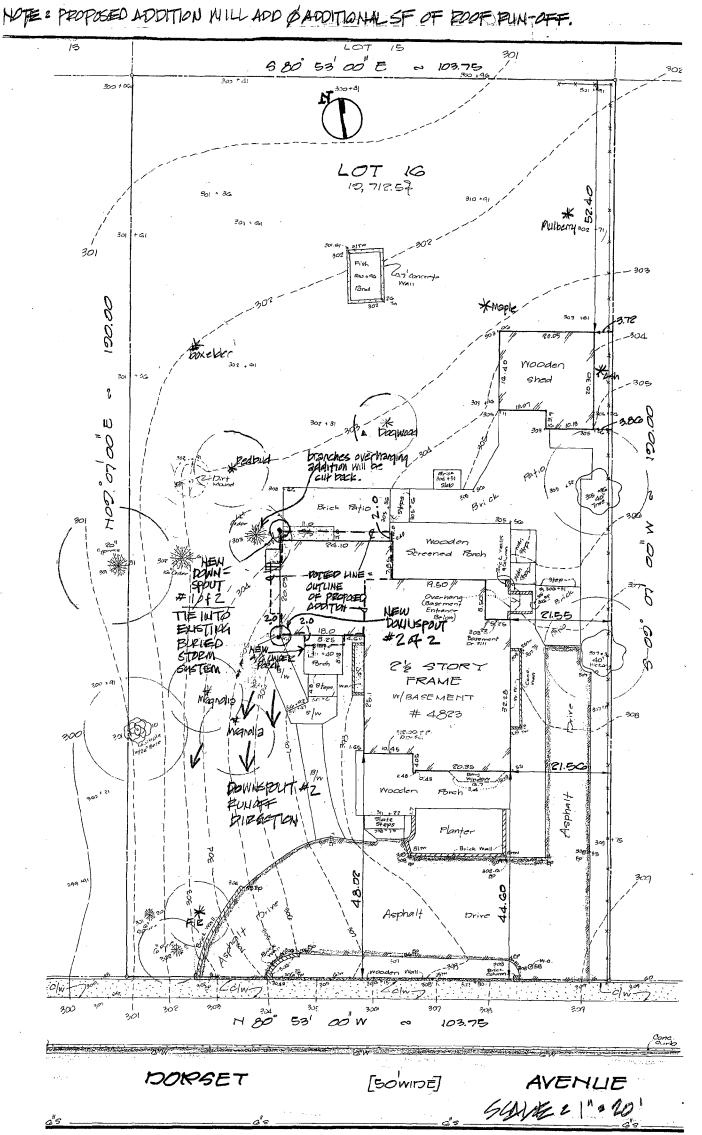
| HAWP APPLICATION: MAILING ADDRESSES FOR NOTIFING [Owner, Owner's Agent, Adjacent and Confronting Property Owners] | | |
|--|---------------------------------------|--|
| Owner's mailing address | Owner's Agent's mailing address | |
| John I. Stewart, Jr. | Kai Tong, AIA | |
| Sharon Stoliaroff | Hopkins and Porter, Inc. | |
| 4823 Dorset Avenue | 12944-C Travillah Road | |
| Chevy Chase, MD 20815 | Suite 204 | |
| Adjacent and confront | ing Property Owners mailing addresses | |
| Alan Proctor | Bill and Betsy Hanlon | |
| Anne Coffey | 4824Cumberland Avenue | |
| 4900 Cumberland Avenue | Chevy Chase, MD 20815 | |
| Chevy Chase, MD 20815 | | |
| Larry Hoover | Kip Johnson | |
| Barbara Hoover | Judy Brocies | |
| 4822 Cumberland Avenue | 4820 Cumberland Avenue | |
| Chevy Chase, MD 20815 | Chevy Chase, MD 20815 | |
| Barton Rubenstein | house under construction | |
| Shareen Rubenstein | | |
| 4819 Dorset Avenue | 4920 Dorset Avenue | |
| Chevy Chase, MD 20815 | Chevy Chase, MD 20815 | |
| | | |
| David Schwartz | Stephen Springer | |
| Gail Schwartz | Caroline Springer | |
| 4822 Dorset Avenue | 4824 Dorset Avenue | |
| Chevy Chase, MD 20815 | Chevy Chase, MD 20815 | |

Continued

| MAILING ADDRESSES FOR NOTIFING Adjacent and Confronting Property Owners] |
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| |
| Owner's Agent's mailing address |
| Kai Tong, AIA |
| Hopkins and Porter, Inc. |
| 12944-C Travillah Road |
| Suite 204 |
| nting Property Owners mailing addresses |
| Dan Hirsch |
| Brenda Gruss |
| 4902 Dorset Avenue |
| Chevy Chase, MD 20815 |
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John Stewart and Sharon Stoliaroff 4823 Dorset Avenue Town of Somerset, Maryland 22 August 2008





A-002 SCALE 3/16"=1'-0"

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| | Hopkins & Porter Construction | 12944C Travllah Road Potomac MD 20854 Tel 301-840-9121 |
|-------|--|--|
| | STEWART RESIDENCE | 4823 Dorset Avn. Chevy Chase, MD |
| | 30 Apr. 2008 19 May 2008 | |
| | Existing | |
| ATION | South Elevation DISCIPLINE & SHEET © 2007 Hopkins & Porter Co | Dn D2 Number |



Q-102A

| Hopkins & Porter Construction | 12944C Travilah Road Potomac MD 20854 Tel 301-940-9121 |
|---|--|
| STEWART Residence | 4823 Dorset Avn. Chevy Chase, MD |
| 30 APR. 2008 09 MAY 2008 16 MAY 2008 19 MAY 2008 21 AUG. 2008 | |

PROPOSED SOUTH ELEVATION

SCALE 3/16"=1'-0"

© 2007 Hopkins & Porter Construction In

DISCIPLINE & SHEET NUMBER



A-004 SCALE 3/16"=1'-0"

| | Hopkins & Porter Construction | 12944C Travilah Road Potomac MD 20854 Tel 301-840-9121 |
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| | STEWART RESIDENCE | 4823 Dorset Avn. Chevy Chase, MD |
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| ST ELEVATION | Existing West Elevation A-00 Discipline & Sheet Nu | 4 (IZ) |
| 5"= '-0" | © 2007 Lizzlizz & Date Care | truction in |

© 2007 Hopkins & Porter Construction In-



| | Hopkins & Porter Construction | |
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| | STEWART RESIDENCE 4823 Dorset Avn. Chevy Chase, MD | |
| | 30 APR. 2008 19 May 2008 21 Aug. 2008 | |
| D WEST ELEVATION | Proposed West Elevation A-104A DISCIPLINE & SHEET NUMBER © 2007 Hopkins & Porter Construction | $\left(13\right)$ |



EXISTING NORTH ELEVATION A-003 SCALE 3/16"=1'-0"

| | Hopkins & Porter | Construction | 12944C Travilah Road Potomac MD 20854 Tel 301-840-9121 | · · · |
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| | STEWART | KESIDENCE | 4823 Dorset Avn. Chevy Chase, MD | |
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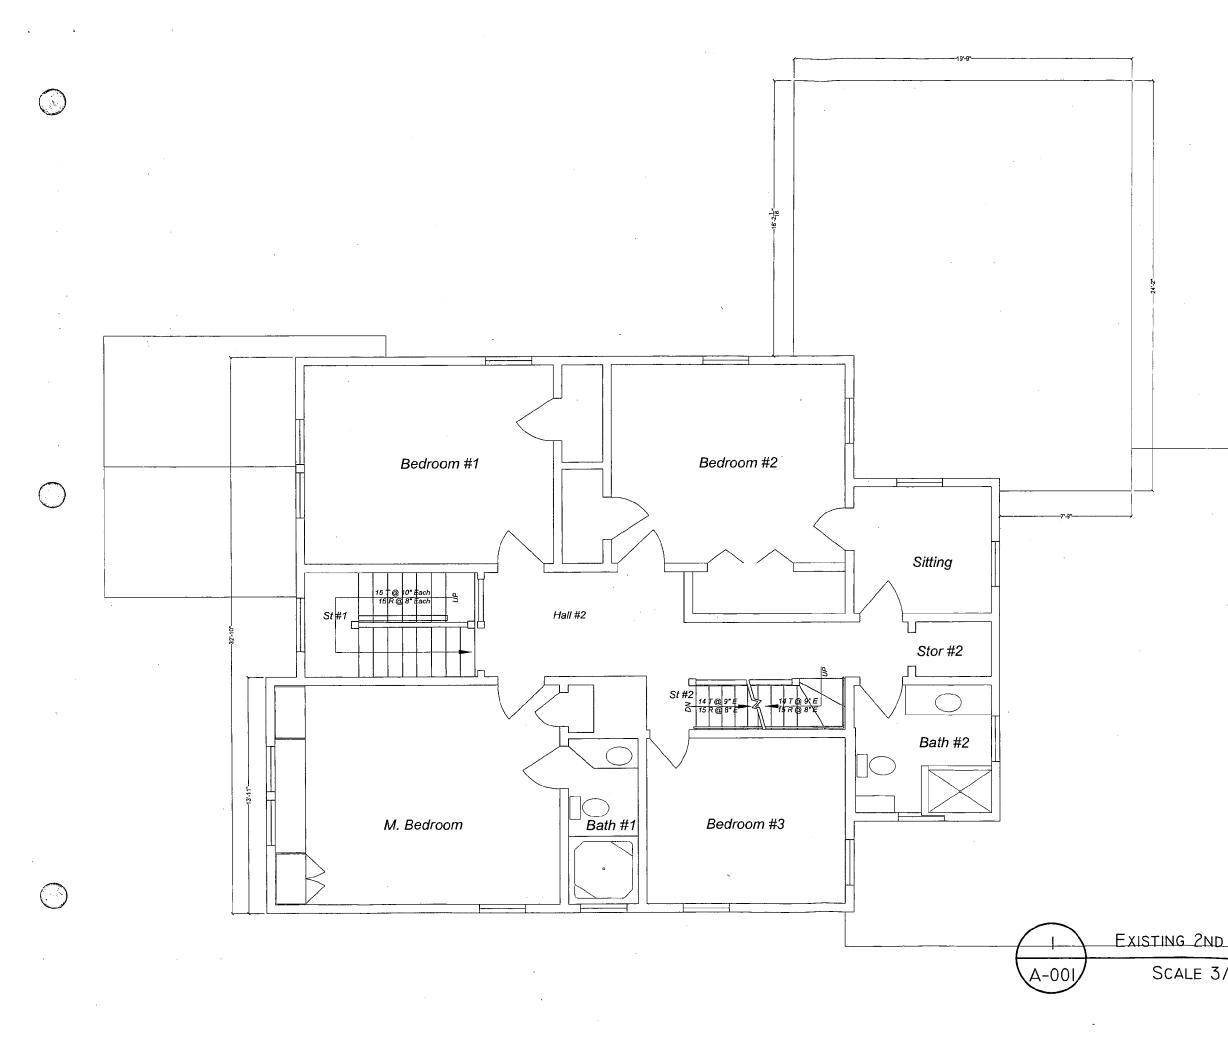


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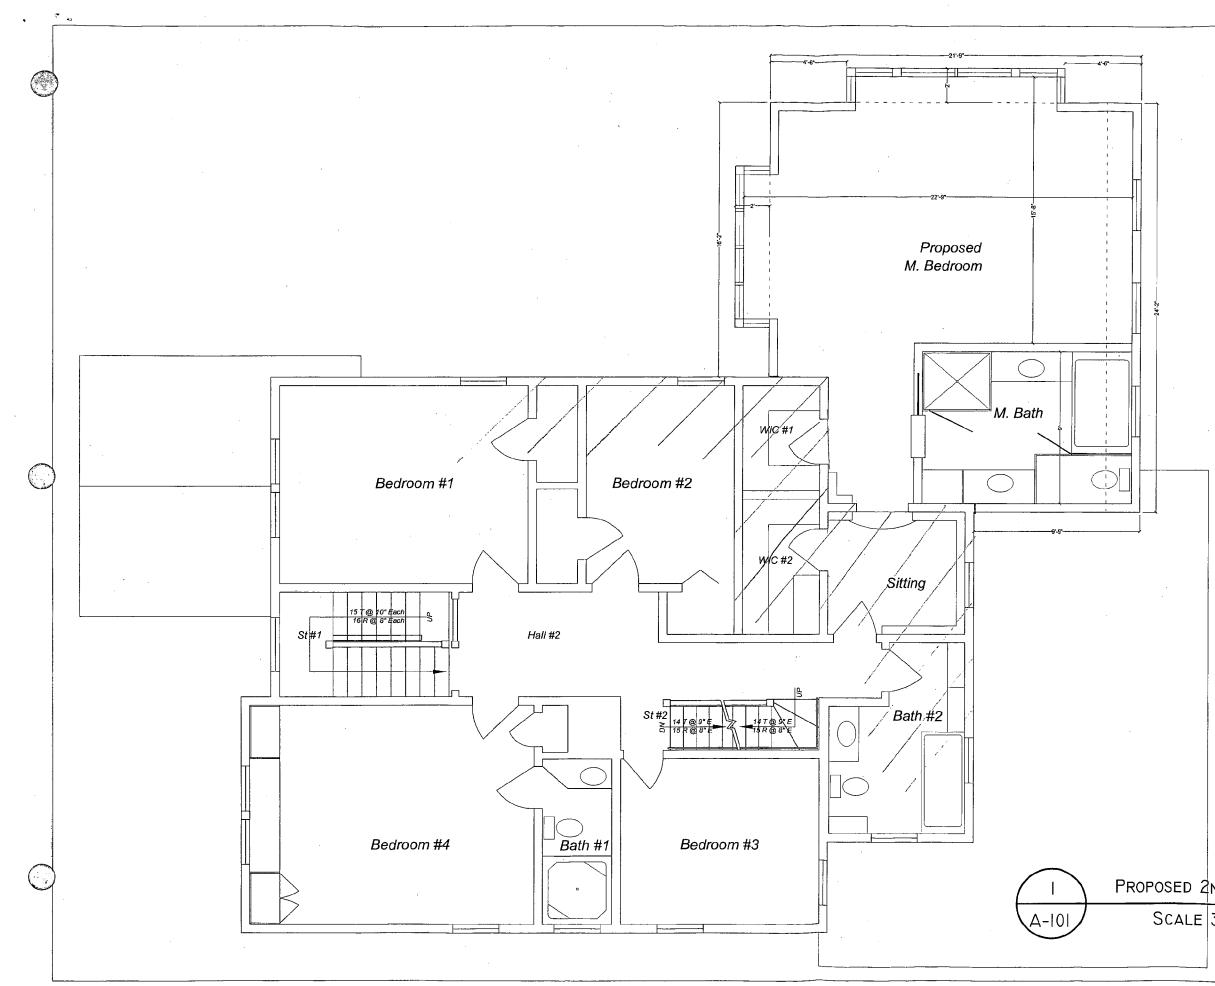
Porter 40-9121 Ď Construction ઝ Hopkins 2944 Stewart RESIDENCE QW ъ . Chevy 4823 30 APR. 2008 19 MAY 2008 21 AUG. 2008 Proposed North (Rear) Elevation



© 2007 Hopkins & Porter Construction Inc.



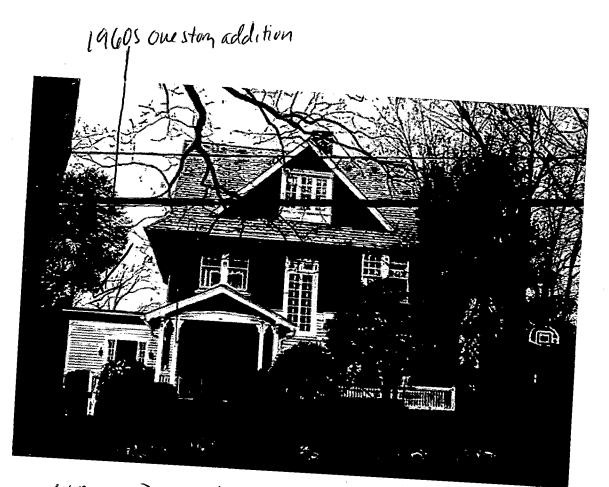
| | Hopkins & Porter Construction | • |
|--------------|--|----|
| | STEWART RESIDENCE 4823 Dorset Am. Chevy Chase, MD | |
| | 30 Apr. 2008 | |
| D_FLOOR PLAN | Existing Second Floor Plan A-001 DISCIPLINE & SHEET NUMBER | 6) |



| | Hopkins & Porter Construction |
|------------------------------|---|
| | |
| • | STEWART RESIDENCE 4823 Dorset Avn. Chevy Chase, MD |
| | 30 Apr. 2008 16 May 2008 19 May 2008 |
| | |
| | |
| | Proposed |
| | Second Floor Plan |
| ND FLOOR PLAN 3/16"=1'-0" | A-101 DISCIPLINE & SHEET NUMBER © 2007 Hopkins & Porter Construction Inc. |
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4823 Dorset Avenue, Aprial View.



4823 Dorset Avenue, Summerset Historie District Front (surth) Elevation.

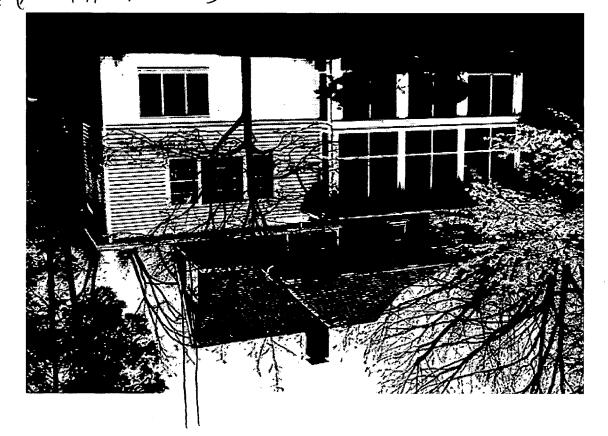


4823 Dorset Avenue, Somerset Historic Distinct East elevation.





MONAN (1401) ELENOYAN. HBJ3 DOUSET HURINE, SOMANSET HISTORE DISTING



1960s and-stary addition

1960s one-story addition



4923 Dorset Avenue, Somerset Historie District West Clevahun.



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| Address: 4 | 89.3 DORS | ET AVE | VORIN (1105E 1 | AP 10BIB | |
| Street Nun | ber | City City | *Stant | | |
| Contractorr: | 1 | ter Inc. | Phone No.: DO | 0.9121 ×22 | |
| Contractor Registration No.: | M TONICA A | 1A Davit | ime Phone No.: 301-84 | 0.9121×22 | |
| | | | | | |
| LOCATION OF BUILDING/P | <u>REMISE</u> | | aler ME | | |
| House Number: | AMBOLET | Nearest Cross Street: 54 | REF AVE. | | |
| Town/City: | : 2 Subdivision | | | <u> </u> | |
| Lot: Block | | | · <u>····································</u> | ······································ | |
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| PART ONE: TYPE OF PERM | IT ACTION AND USE | | | | |
| 1A. CHECK ALL APPLICABLE: | · · ·································· | | | | |
| Construct Z Ext | • | AC Siab | Room Addition 🗀 Pore | | |
| Move Inst Revision Rep | | 🗋 Solar 🗀 Frieda | sce 🗆 Woodburning Stove | Single Family | |
| 1B. Construction cost estimate | · · · · | | | | |
| 1C. If this is a revision of a pre | | see Permit # | | | |
| | | | | | |
| PART TWO: COMPLETE F | | _ | | | |
| 2A. Type of sewage disposal2B. Type of water supply: | | • | | | |
| | | | · _ • • • • • • • • • • • • • • • • • • | · | |
| PART THREE: COMPLETE | ONLY FOR FENCE/RETAININ | VG WALL | | | |
| 3A. Heightfeet | inches | | | | |
| | - | structed on one of the following | | | |
| On party line/property | line 🗋 Entirely on | land of owner L | In public right of way/easement | | |
| | | g application, that the application nd accept this to be a condition | n is correct, and that the constructio for the issuance of this permit. | n will comply with plans | |

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THE FOLLOWING ITEMS MUST BE COMPLETED AND THE REQUIRED DOCUMENTS MUST ACCOMPANY THIS APPLICATION.

1. WRITTEN DESCRIPTION OF PROJECT

a Description of existing structures) and environmental setting, including their historical features and significance: SHINGUE STYLE HOUSE BUILT C. 1910 FOR DC. JAMES DELGON; SERVED AS BEE LAB FOR US DA BUICON OF ENDINDONGLY 1917-1939, A FLAT. FOOFFO ADDITION (I FLADE + BSINT) WAS ADDED TO THE N.W. CORNER OF THE HOUSE C. 1960'S HOUSE IS IN SOMERSET HISTORIC DISTRET. MAIN HOUSE, IS CROSS GABLED SHINGLED. 1960 & ADDITION IS BUILT. UP ROF, BRICK, I CLAPBOARD MI TRM. AT REAR OF HOUSE, SCREENED PORCH WAS ADDED W. LATE 1900 & AFTER TREE DAMAGE.

b. General description of project and its effect on the historic resource(s), the environmental setting, and, where applicable, the historic district THE PEOPOSED PEONECT AFFECTS THE 1960'S FLAT PORTED ADDITION ON UY, A POOM WILL BE ADDED ON TOP OF THE FLAT PORTED 1960'S ADDITION ON UY, A POOM WILL BE ADDED ON TOP OF THE FLAT PORTED 1960'S ADDITION ON UY, A POOM WILL BE ADDED ON TOP OF THE FLAT PORTED 1960'S ADDITION ON UY, A POOM WILL BE ADDED ON TOP OF THE FLAT PORTED 1960'S ADDITION ON UY, A POOM WILL BE ADDED ON TOP OF THE FLAT PORTED 1960'S ADDITION ON UY, A POOM WILL BE ADDED ON TOP OF THE NEW POOM WILL HAVE A PITCHED POOF GABLED IN HARMONY WITH THE MAIN HOUSE'S POOF UNDER. SID INC, WILL BE STAINED SHINGLES TO MATCH THE HOUSE, AND THE ENTIMIN'S SCALE OF THE NEW FENEST POTION WILL 2. SITE PLAN ALGO DEFED. TO THE MAIN HOUSE'S ARCHITECTURE.

Site and environmental setting, drawn to scale. You may use your plat. Your site plan must include:

- a. the scale, north arrow, and date;
- b. dimensions of all existing and proposed structures; and
- c. site features such as walkways, driveways, fances, ponds, streams, trash dumpsters, mechanical equipment, and landscaping.

3. PLANS AND ELEVATIONS

You must submit 2 copies of plans and elevations in a format no larger than 11" x 17". Plans on 8 1/2" x 11" paper are preferred.

- a. Schematic construction plans, with marked dimensions, indicating location, size and general type of walls, window and door openings, and other fixed features of both the existing resource(s) and the proposed work.
- b. Elevations (facades), with marked dimensions, clearly indicating proposed work in relation to existing construction and, when appropriate, context, All materials and fixtures proposed for the exterior must be noted on the elevations drawings. An existing and a proposed elevation drawing of each facade affected by the proposed work is required.

4. MATERIALS SPECIFICATIONS

General description of materials and manufactured items proposed for incorporation in the work of the project. This information may be included on your design drawings.

5. PHOTOGRAPHS

- Clearly labeled photographic prints of each facede of existing resource, including details of the affected portions. All labels should be placed on the front of photographs.
- b. Clearly lebel photographic prints of the resource as viewed from the public right-of-way and of the adjoining properties. All labels should be placed on the front of photographs.

6. TREE SURVEY

If you are proposing construction adjacent to or within the dripline of any tree 6" or larger in diameter (at approximately 4 feet above the ground), you must file an accurate tree survey identifying the size, location, and species of each tree of at least that dimension.

7. ADDRESSES OF ADJACENT AND CONFRONTING PROPERTY OWNERS

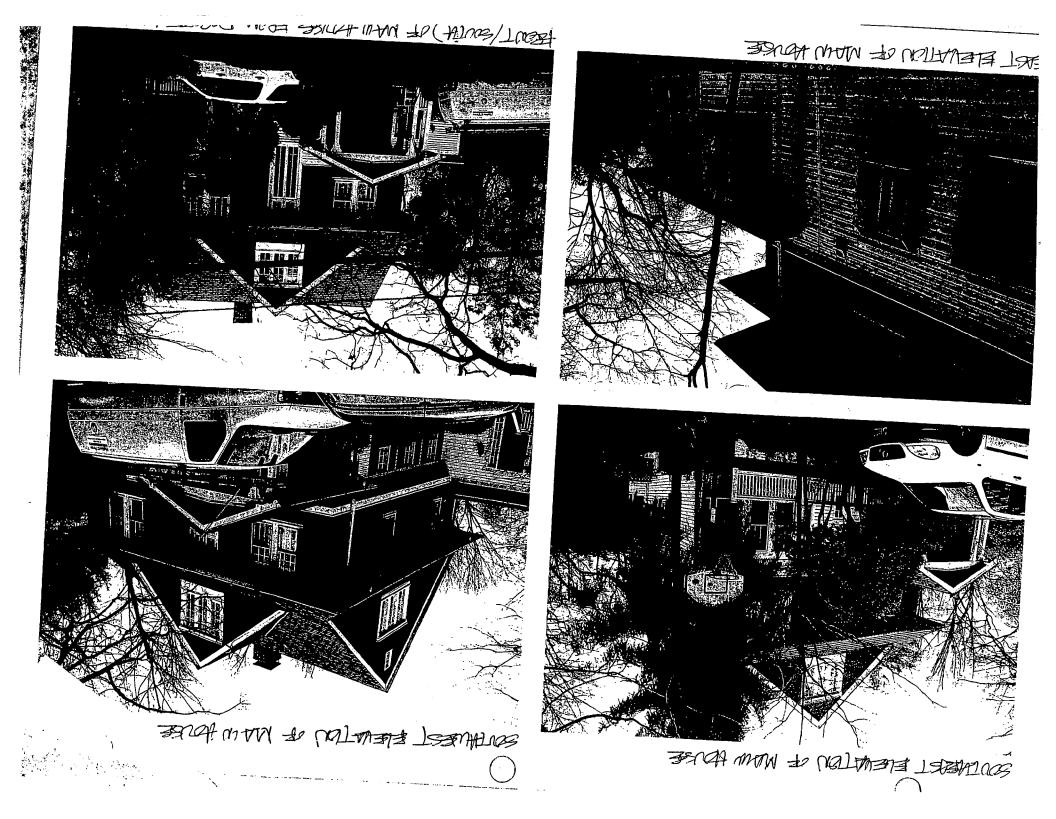
For <u>ALL</u> projects, provide an accurate list of adjecent and confronting property owners (not tenants), including names, addresses, and zip codes. This list should include the owners of all lots or percels which adjoin the parcel in question, as well as the owner(s) of lot(s) or parcel(s) which lie directly across the street/highway from the parcel in question. You can obtain this information from the Department of Assessments and Taxation, 51 Monroe Street, Rockville, (301/279-1355).

PLEASE PRINT (IN BLUE OR BLACK INK) OR TYPE THIS INFORMATION ON THE FOLLOWING PAGE. PLEASE STAY WITHIN THE GUIDES OF THE TEMPLATE, AS THIS WILL BE PHOTOCOPIED DIRECTLY ONTO MAILING LABELS.

| HAWP APPLICATION: MAILING ADDRESSES FOR NOTIFING [Owner, Owner's Agent, Adjacent and Confronting Property Owners] | | | |
|--|--|--|--|
| Owner's mailing address | Owner's Agent's mailing address | | |
| John I. Stewart, Jr. | Kai Tong, AIA | | |
| Sharon Stoliaroff | Hopkins and Porter, Inc. | | |
| 4823 Dorset Avenue | 12944-C Travillah Road | | |
| Chevy Chase, MD 20815 | Suite 204 | | |
| Adjacent and confron | ting Property Owners mailing addresses | | |
| Alan Proctor | Bill and Betsy Hanlon | | |
| Anne Coffey | 4824Cumberland Avenue | | |
| 4900 Cumberland Avenue | Chevy Chase, MD 20815 | | |
| Chevy Chase, MD 20815 | | | |
| Larry Hoover | Kip Johnson | | |
| Barbara Hoover | Judy Brocies | | |
| 4822 Cumberland Avenue | 4820 Cumberland Avenue | | |
| Chevy Chase, MD 20815 | Chevy Chase, MD 20815 | | |
| Barton Rubenstein | house under construction | | |
| Shareen Rubenstein | | | |
| 4819 Dorset Avenue | 4920 Dorset Avenue | | |
| Chevy Chase, MD 20815 | Chevy Chase, MD 20815 | | |
| David Schwartz | Stephen Springer | | |
| Gail Schwartz | Caroline Springer | | |
| 4822 Dorset Avenue | 4824 Dorset Avenue | | |
| Chevy Chase, MD 20815 | Chevy Chase, MD 20815 | | |

Continued

| Continued, page 2 of 2 | | | | |
|--------------------------------|--|--|--|--|
| Dwner's mailing address | Owner's Agent's mailing address | | | |
| John I. Stewart, Jr. | Kai Tong, AIA | | | |
| Sharon Stoliaroff | Hopkins and Porter, Inc. | | | |
| 4823 Dorset Avenue | 12944-C Travillah Road | | | |
| Chevy Chase, MD 20815 | Suite 204 | | | |
| | | | | |
| Adjacent and confron | ting Property Owners mailing addresses | | | |
| Leo Mondale | Dan Hirsch | | | |
| Sarah Patton | Brenda Gruss | | | |
| 4902 Dorset Avenue | 4902 Dorset Avenue | | | |
| Chevy Chase, MD 20815 | Chevy Chase, MD 20815 | | | |
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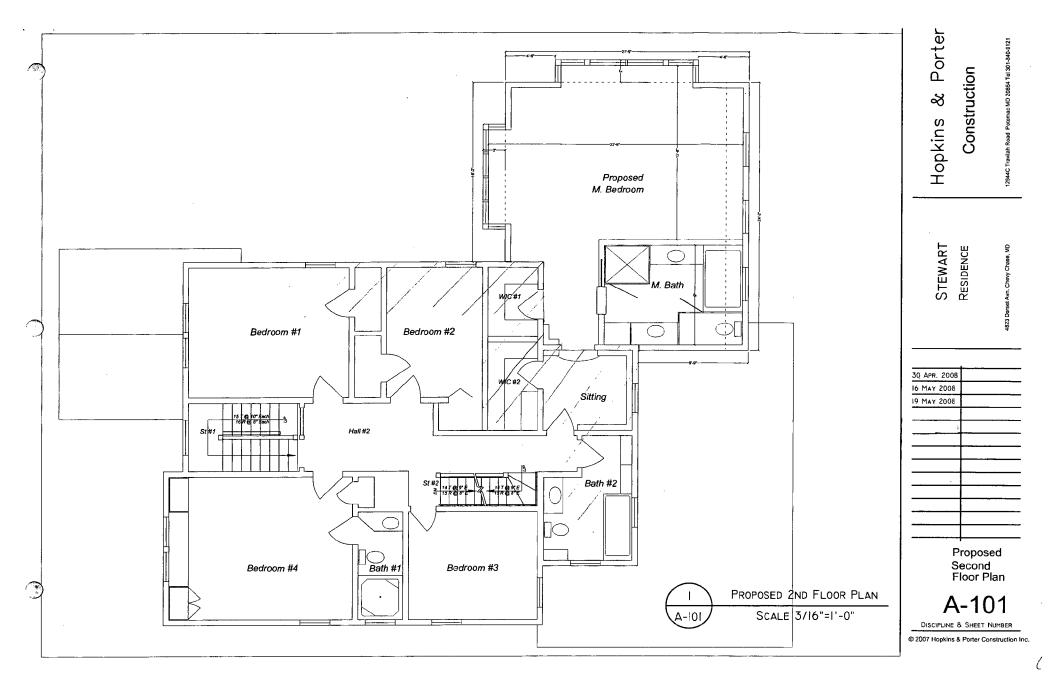


ADDITION - SEEN FROM FRONT DRIVE HERE.

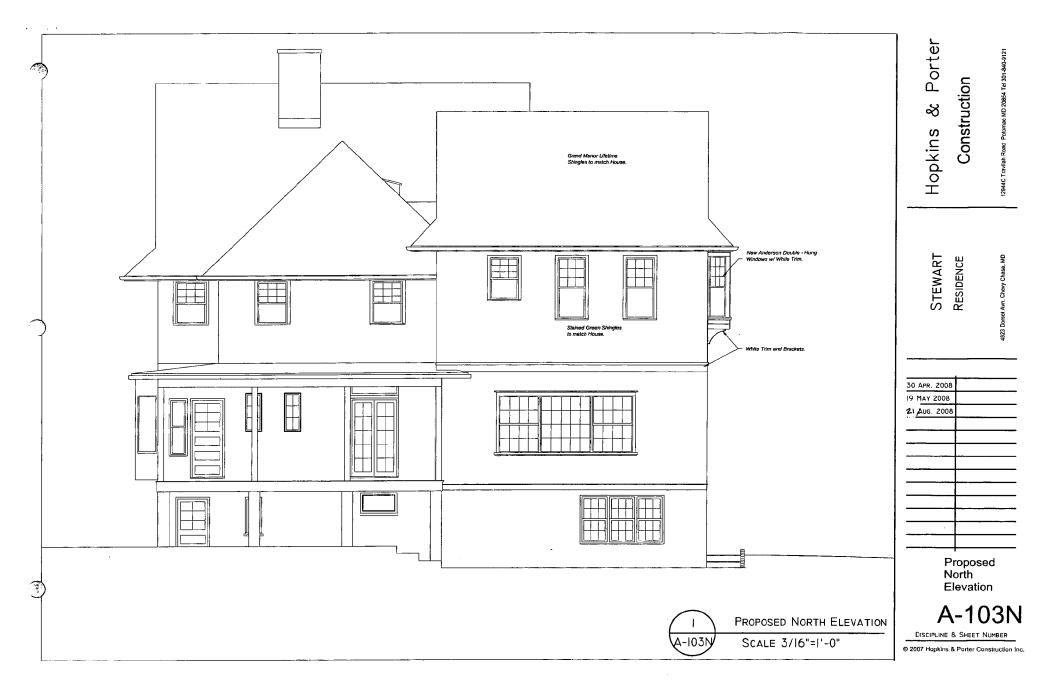


PAFTIAL FRONT (SOUTH) ELEVATION

SOUTHLEST COPLER

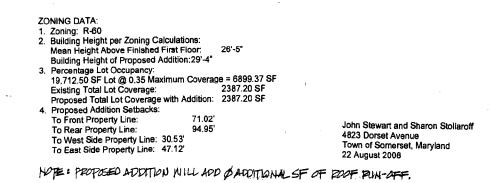


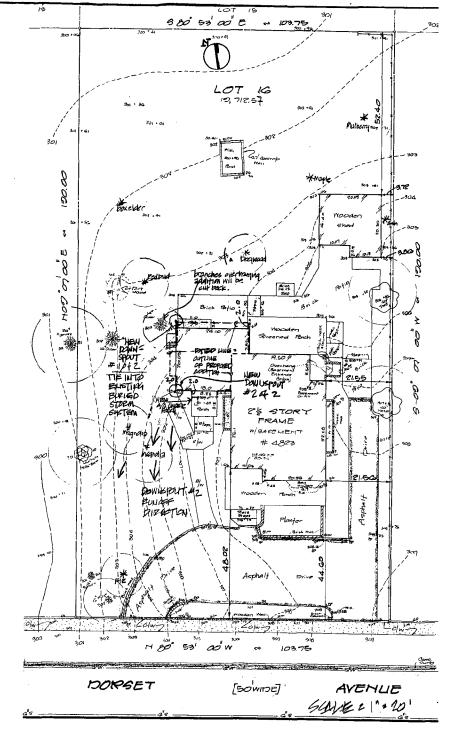


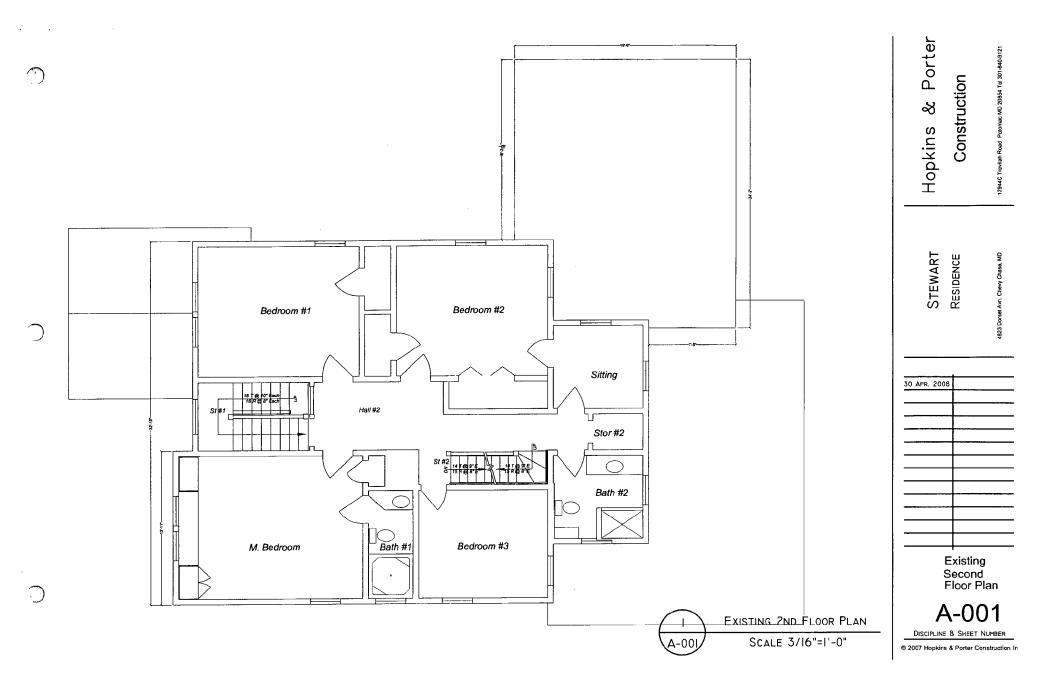




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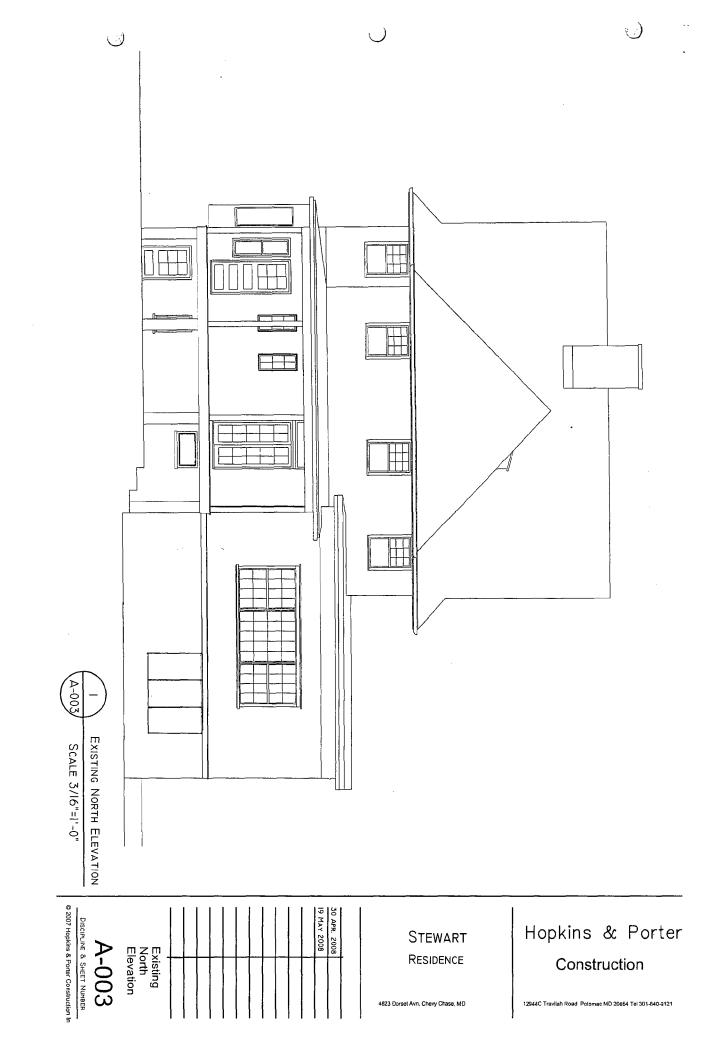






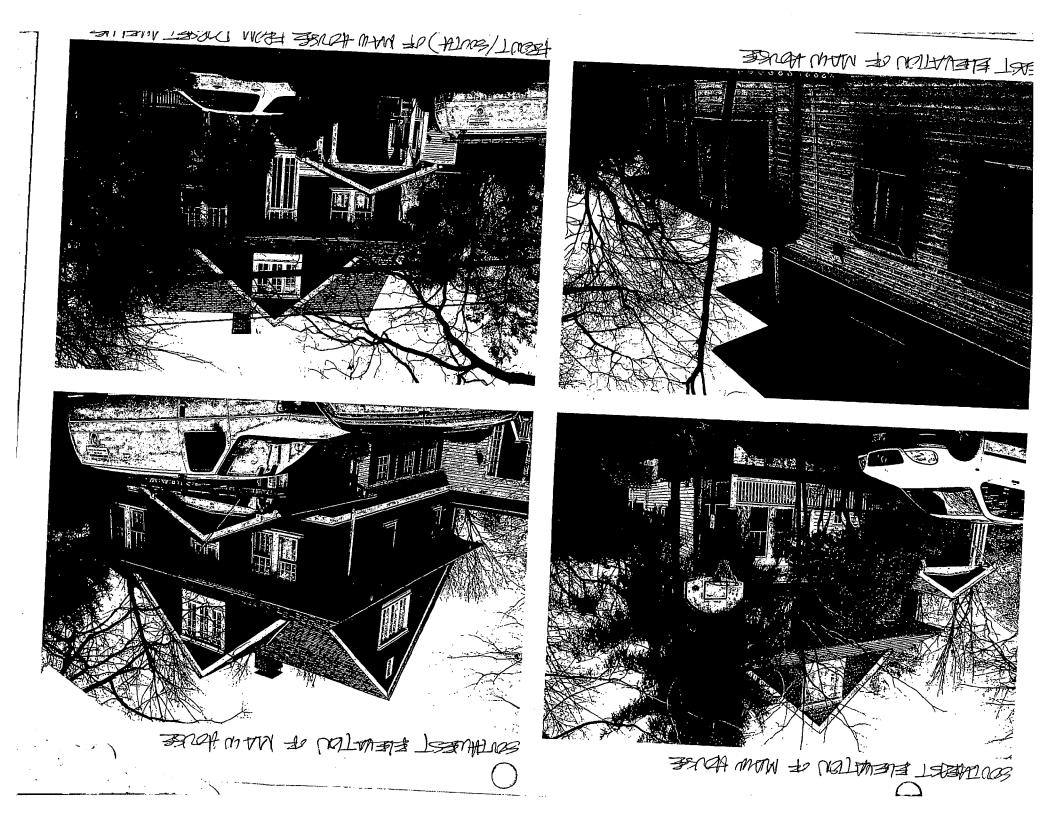


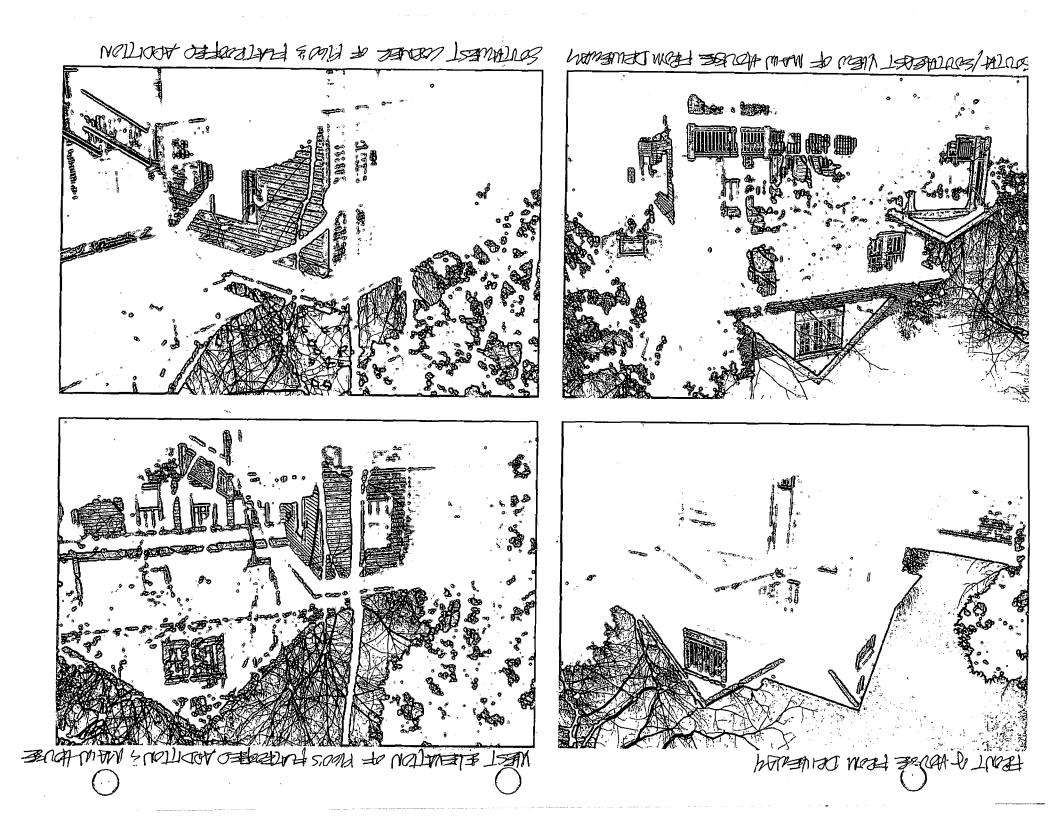


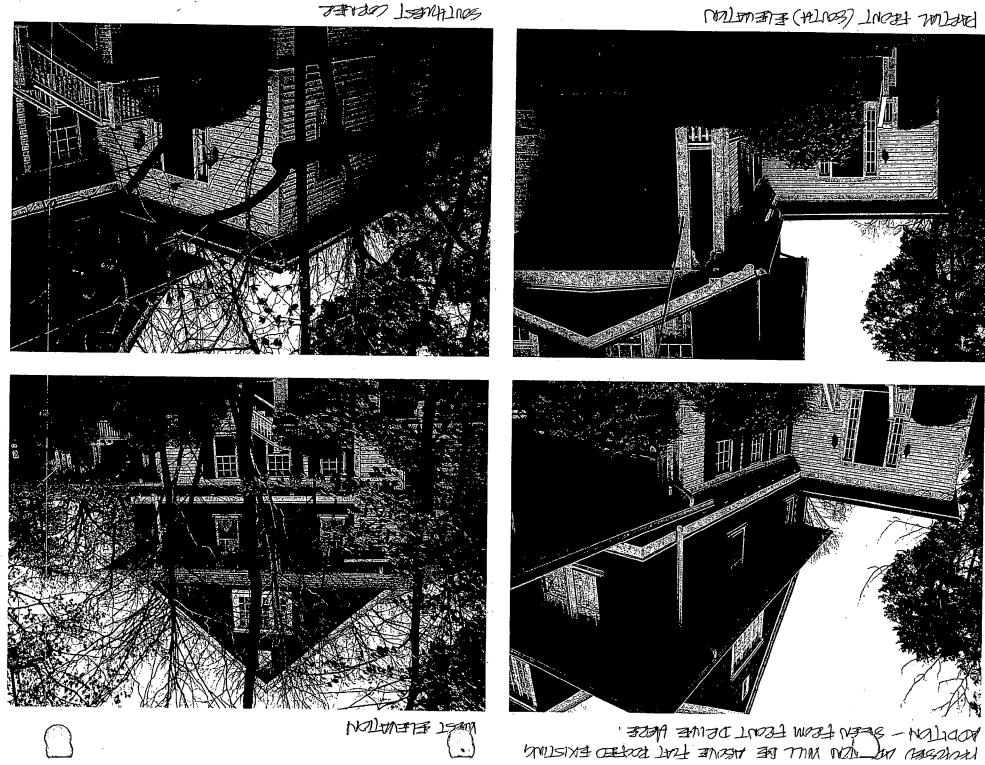




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From: Sent: To: Cc: Subject: DrSharon@aol.com Wednesday, September 10, 2008 3:54 PM Kennedy, Rachel jstewart@crowell.com; kai@hopkinsandporter.com Re: Dorset Avenue

Dear Rachel,

Thanks for all your help and the good news about our tax credit. We are delighted that you have been assigned to our addition. I have passed the questions on to Kai, our architect at Hopkins and Porter. We presented our plans to the Town of Somerset Council Meeting on September 2. They approved them without any changes. Please let me know if you have any further questions or need more info. Best regards, Sharon

In a message dated 9/10/2008 2:16:06 P.M. Eastern Daylight Time, Rachel.Kennedy@mncppc-mc.org writes:

HI Sharon,

Just wanting to let you know that I have been assigned your HAWP case for the 24th September meeting. I am just getting the packet and will email or call with any questions.

Rachel

PS: You tax credit was approved for the majority of the costs, including all but one of the lights (which they don't normally do)! Final amount was \$27,651.27.

1

Rachel Kennedy

Senior Planner

Countywide Planning | Historic Preservation Section

Maryland-National Capital Park and Planning Commission

301-563-3400 phone | 301-563-3412 fax

1109 Spring Street, Suite 801

Silver Spring, MD 20910

rachel.kennedy@mncppc-mc.org, http://www.mc-mncppc.org/historic/

Mailing Address:

8787 Georgia Avenue

Silver Spring, MD 20910

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Mailing Address:

8787 Georgia Avenue

Silver Spring, MD 20910

Psssst...Have you heard the news? There's a new fashion blog, plus the latest fall trends and hair styles at StyleList.com.

From: Sent: To: Cc: Subject: Kai Tong [kai@hopkinsandporter.com] Monday, September 15, 2008 10:13 AM Kennedy, Rachel DrSharon@aol.com RE: 4823 Dorset Avenue

Hi Rachel,

1. We will go with traditional wood trim throughout, to simplify the review with HPC. We will not use Miratec.

2. You are correct - there will be no board siding on the second story addition. Only cedar shingles.

3. We can affirm at this point that the windows will be SDL. If the owners decide to upgrade to TDL later, we will get separate prior clearance from your department.

Please let me know if this answers all your questions. Thank you for articulating HPC's concerns so precisely. I am at the office this morning, and available by cellular later in the day. Thanks!

Kai Tong

Kai Tong, AIA Director, Hopkins & Porter Architecture Department 301-840-9121x22 <u>kai@hopkinsandporter.com</u> cellular: 703-981-8812

From: Kennedy, Rachel [mailto:Rachel.Kennedy@mncppc-mc.org] Sent: Monday, September 15, 2008 9:31 AM To: Kai Tong Cc: DrSharon@aol.com Subject: RE: 4823 Dorset Avenue

Thanks Kai. So, to recap the materials below:

- 1) Area with chronic moisture exposure will be made of Miratec. Miratec is a plastic composite material? I could not tell from the website exactly what it is made of. Some wood, some plastic?
- 2) There will be no board siding on the second story addition. Only cedar shingles will be used to side the house.
- 3) Trim will be made of real wood of various species.

The HPC does not have a track record approving materials like Miratec. I would suggest altering this to a moistureresistant type of wood to facilitate your application. Let me know if your clients decide to do this asap so I can include it in my report.

In terms of the windows, you are welcome to use SDL on the addition (not on the main house, fyi). Of course, the HPC would not mind of you used TDL instead, but TDL is not required.

From: Kai Tong [mailto:kai@hopkinsandporter.com] Sent: Friday, September 12, 2008 9:34 AM To: Kennedy, Rachel Subject: RE: 4823 Dorset Avenue

Hi Rachel,

From:Kai Tong [kai@hopkinsandporter.com]Sent:Tuesday, September 16, 2008 10:34 AMTo:Kennedy, RachelSubject:Stewart/Dorset Avenue 1 of 5 viewsAttachments:IMG_0288.JPG

Hi Rachel,

Attached is one of five separate email images I am sending you.

Also, this will confirm that the windows for the addition will be wood windows, to be painted inside and outside. Thanks for your help.

,

Kai

Kai Tong, AIA

From: Sent: To: Subject: Kai Tong [kai@hopkinsandporter.com] Friday, September 12, 2008 9:34 AM Kennedy, Rachel RE: 4823 Dorset Avenue

Hi Rachel.

Thank you for forwarding your questions to me yesterday. The answers are numbered per your emailed questions:

1. The Andersen windows currently specified are nine-over-one simulated-divided-light double hung windows. Sharon and John and I would be happy to upgrade to true-divided-light windows if you feel it would be a more appropriate window, and would facilitate our application. Andersen does not offer a true-divided-light, so we would go with a high quality manufacturer, either Marvin or Kolbe, who do offer TDL windows. SDL

2. The addition's roof peak will be about 2'-6" lower than the peak of the main house's roof.

3. Yes, that is correct. The north side of the addition will overhang the north wall of the structure below by 2'-0". We feel that would give much needed relief to what would otherwise be a rather sheer and tall north wall.

4. The shingles specified are identical to the shingles currently on the main house, which are Certainteed's best residential shingle that they make - Grand Manor with a lifetime warranty. They are designed to show depth and dimension. http://74.6.239.67/search/cache?ei=UTF-8&p=grand+manor+lifetime+shingles&fr=yfp-t-501&u=www.certainteed.com/CertainTeed/Homeowner/Homeowner/Roofing/Northeast/GrandManor-NE.htm&w=grand+manor+lifetime+%22life+time%22+shingles+shingle&d=AyUGofReRVC3&icp=1&.intl=us

The siding specified will be identical to the siding on the main house, which are cedar shingles that have been stained.

The trim will be top grade primed and painted wood [Windsor One] trim. - this is wal wood http://www.windsorone.com/moldings/default.asp

For any areas that might be subject to chronic high moisture exposure, such as fascia boards behind gutters, we will use primed and painted wood [Miratec] moulding, which has a 30 year warranty against rot, insect damage, delamination, and http://www.miratectrim.com/pageBuild.asp?PageID=A product m - This is a plashe-bared could?

The brackets will be primed and painted wood.

Rachel, if your Historic Preservation Section has a preference for using traditional wood [lumber] for exterior trim, instead of the engineered wood products above, we would be happy to defer to your expertise. We feel the above products produce a much more trouble-free trim for the homeowner, are convincingly accurate in appearance, and do not convey any sense of being artificial, synthetic or manufactured. However, we do not want the use of these materials to be an issue that will detract from our application being as historically responsive as it should be.

5. There will be no siding on the new addition except for the stained shingle siding that matches the stained shingle siding of the main house.

6. Yes, this is correct, except for the overhang on the north side. Also, there are projecting window bays on the south elevation and west elevation of the addition, per the floor plan A-101.

7. The roof shingle colors specified for the addition will match the main house's existing shingle color, which is a beautiful gray.

The cedar shingles on the exterior walls of the addition will be stained to match the main house's cedar wall shingles. which are a beautiful green.

8. The A/C unit will be under the porch, below and behind the porch stairs. The A/C unit will be blocked from public view from the street by the stairs to the porch. The sides of the porch are enclosed in wood lattice, which will further screen the A/C unit from view.

Thank you, Rachel, for your attention to detail in your questions. If there is any aspect of our design or my responses to your questions that can be clarified or modified to make our application more fully attuned to the Historic Preservation Section's mission, please do not hesitate to let me know. I am available by email and office phone, or, more immediately, cellphone all day and over the weekend.

Sincerely,

Kai Tong

Kai Tong, AIA Director, Hopkins & Porter Architecture Department 301-840-9121x22 kai@hopkinsandporter.com cellular: 703-981-8812

From: Kennedy, Rachel [mailto:Rachel.Kennedy@mncppc-mc.org] Sent: Thursday, September 11, 2008 2:29 PM To: Kai Tong Subject: FW: 4823 Dorset Avenue

From: Kennedy, Rachel Sent: Wednesday, September 10, 2008 3:09 PM To: 'DrSharon@aol.com' Subject: 4823 Dorset Avenue

Hi Sharon,

I have some initial questions regarding your HAWP for a second story addition. Let me know if you would prefer I contact the architect.

- 1) What type of Anderson windows will you be using? True-divided lights? Simulated divided lights? It looks like they will be nine over one windows to match the main house.
- 2) It looks like the addition's roofline will be lower than the main house roof line. Correct? Any idea about how much lower?
- 3) It looks like the second story addition overhangs a small amount on the north elevation (rear). IS that correct? If so, by how much approximately?
- 4) What material will the shingles, trim, and brackets be made of?
- 5) Will the shingles cover the entire second story. If I remember correctly, the first story has wood siding with a brick foundation (more brick visible on the rear). Will any siding be used for the second story addition?
- 6) The addition seems to be exactly on the footprint of the first story existing. Is this correct?
- 7) You are planning to use architectural asphalt shingles on the second story? I see that is what is on your house already, correct? Just curious, what color will you use? (HPC will not review this, but if you know if couldn't hurt to mention it).
- 8) Finally, the ac unit will be placed under the porch on the front elevation. How will it be screened from public view?

I look forward to working with you on this. I think it looks very compatible with the original house. Rachel Rachel Kennedy Senior Planner Countywide Planning | Historic Preservation Section Maryland-National Capital Park and Planning Commission 301-563-3400 phone | 301-563-3412 fax 1109 Spring Street, Suite 801 Silver Spring, MD 20910 rachel.kennedy@mncppc-mc.org, <u>http://www.mc-mncppc.org/historic/</u> Mailing Address: 8787 Georgia Avenue Silver Spring, MD 20910

From: Sent: To: Subject: Kai Tong [kai@hopkinsandporter.com] Sunday, September 14, 2008 12:09 PM Kennedy, Rachel dorset avenue, somerset

Rachel,

Greetings. Just a quick follow-up to my Thursday email to you.

1. The color of the shingles used on the roof was Stonegate Gray.

2. The green stain for the cedar shingles is Benjamin Moore HC-135 Lafayette Green, from Benjamin Moore's Historic Colors Collection.

Again, thank you, and please feel free to call with questions.

Sincerely,

Kai Tong

Kai Tong, AIA Director, Hopkins & Porter Architecture Department 301-840-9121x22 kai@hopkinsandporter.com cellular: 703-981-8812

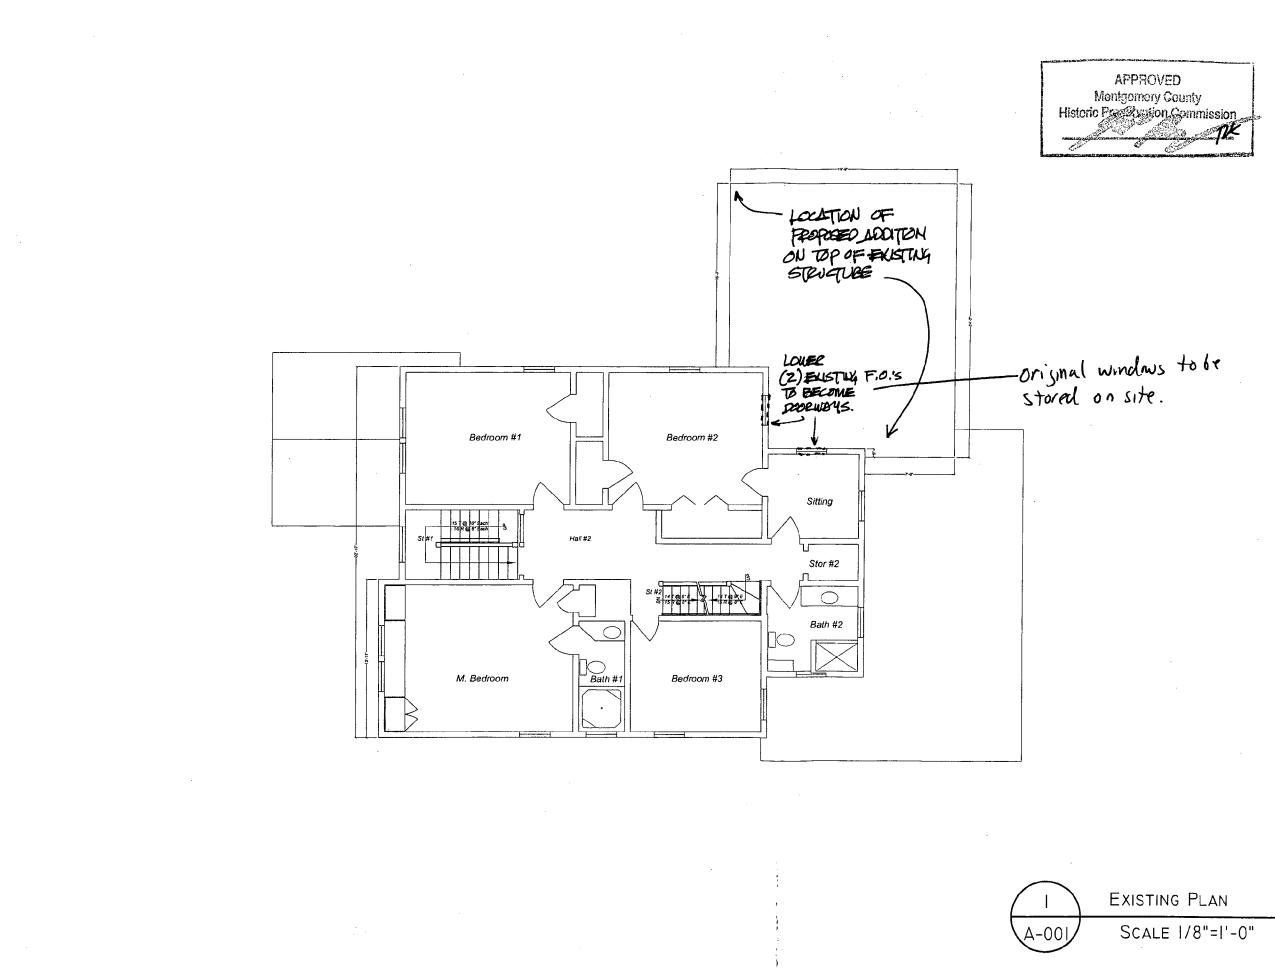
From: Sent: To: Subject: Kennedy, Rachel Wednesday, September 10, 2008 3:09 PM 'DrSharon@aol.com' 4823 Dorset Avenue

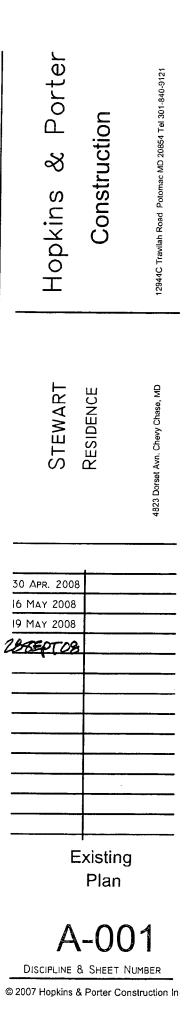
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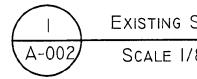




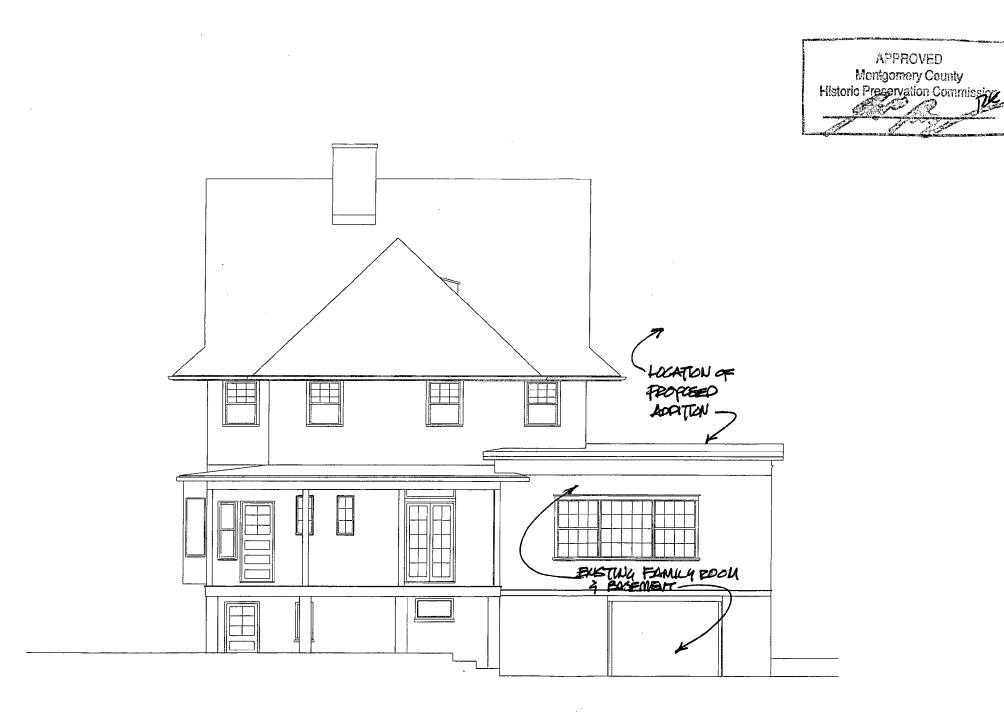


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|------------------------------|--|--|
| | STEWART RESIDENCE 4823 Dorret Avn. Chevy Chase, MD | |
| | 30 APR. 2008 19 MAY 2008 | |
| South Elevation /8"=1'-0" | Existing South Elevation A-002 DISCIPLINE & SHEET NUMBER © 2007 Hopkins & Porter Construction In- | |

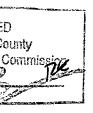


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A-003

SCALE 1/8"=1'-0"





EXISTING NORTH ELEVATION



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EXISTING SCALE 1/8"=1'-0" A-004

DISCIPLINE & SHEET NUMBER © 2007 Hopkins & Porter Construction In-

| Wesr | ELEVATION |
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Existing West Elevation

A-004

STEWART RESIDENCE

Avn. Chevy Chase, MD 4823 Dor

ac MD 20854 Tel 301-840-9121

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Porter Construction న Hopkins

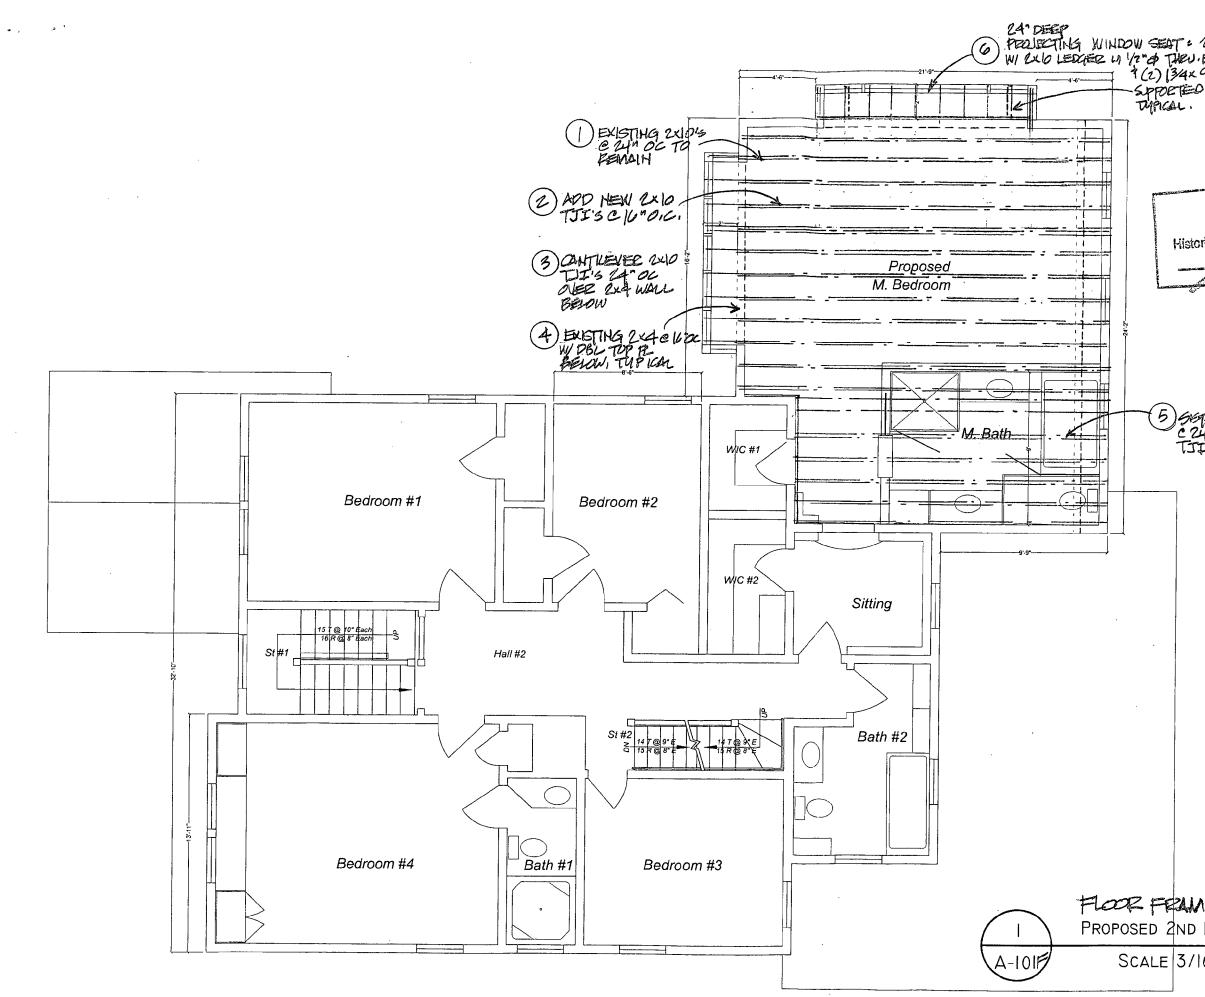


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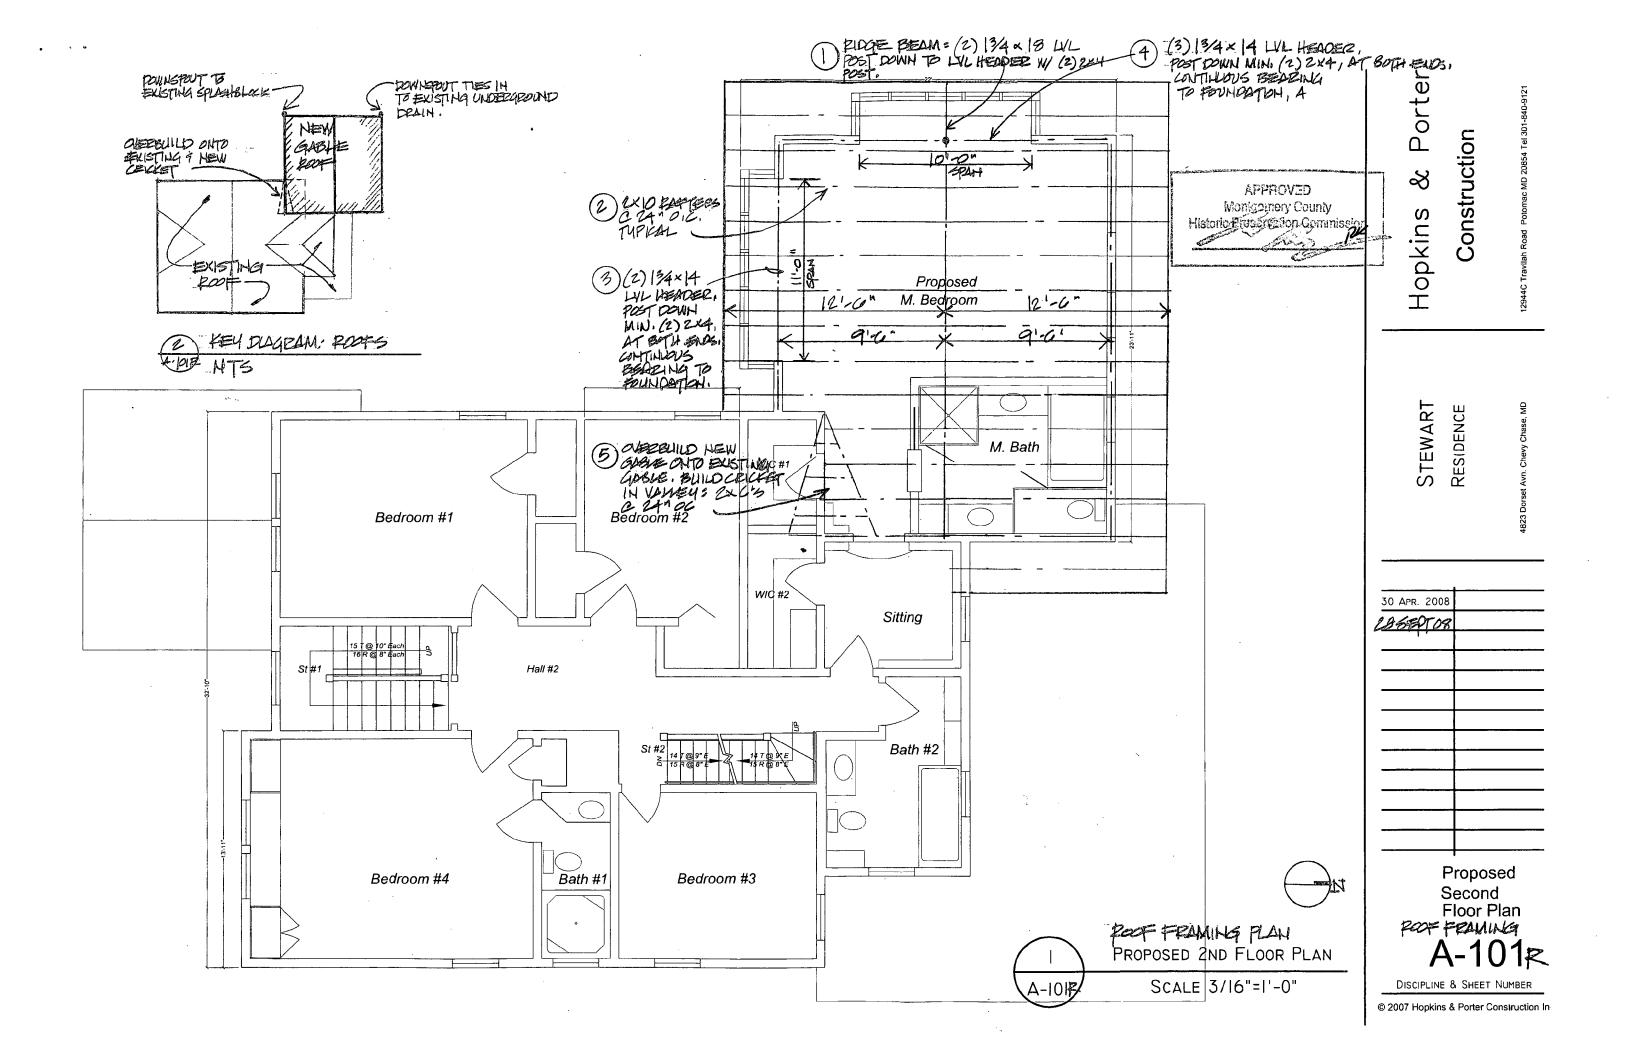
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| | STEWART RESIDENCE 4823 Dorset Avn. Chevy Chase, MD | |
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| SOUTH ELEVATION | Proposed South Elevation A-102/ Discipline & Sheet Number | - - - |
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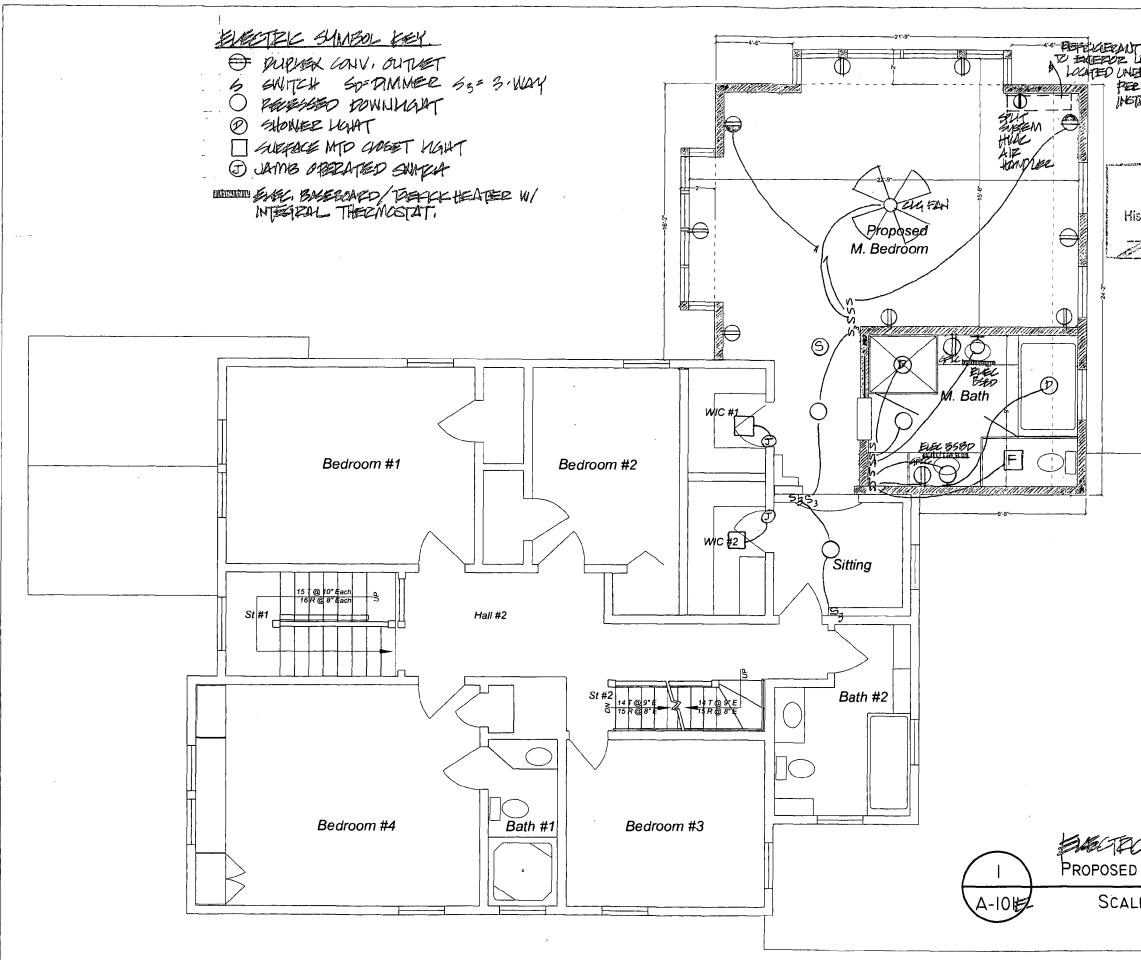




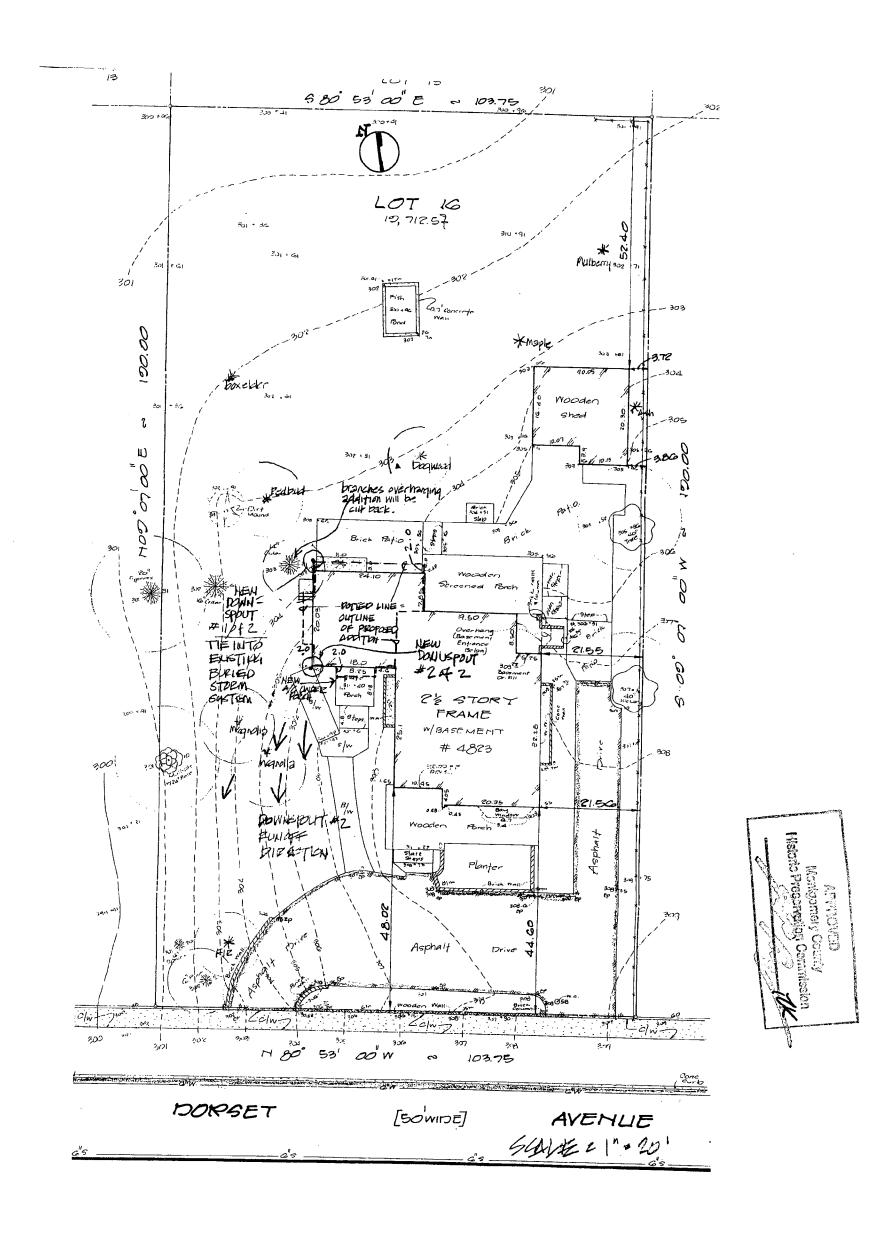


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| ZAL FLAN D 2ND FLOOR PLAN ALE 3/16"=1'-0" | Proposed Second Floor Plan A-101 DISCIPLINE & SHEET NUMBER © 2007 Hopkins & Porter Construction In | |



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