
18 cm

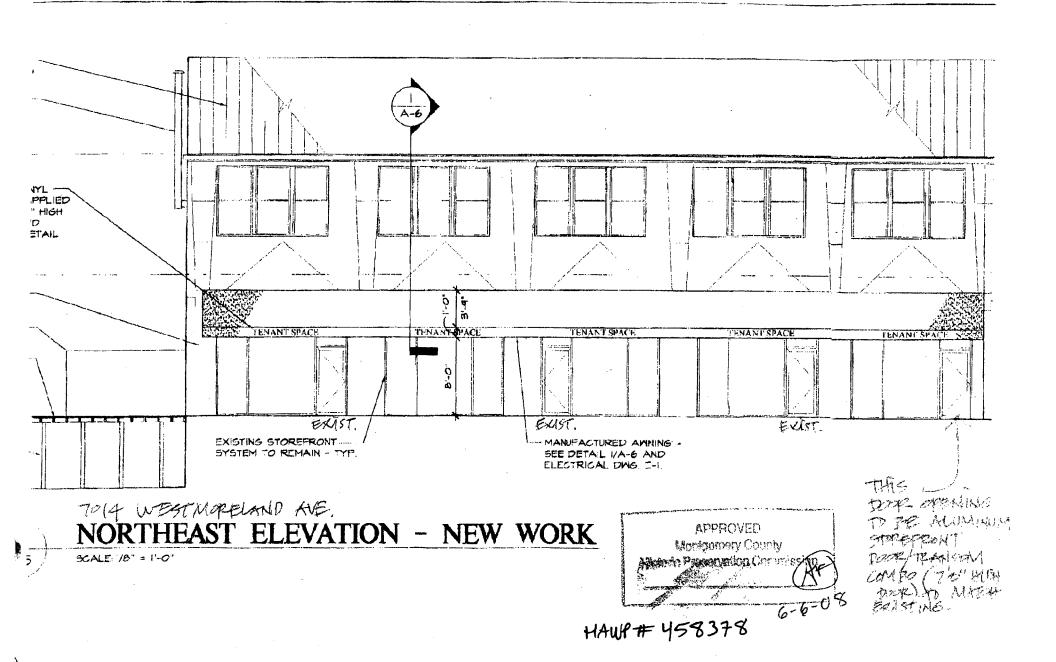

To: Scott Whipple

From Mike Hirschman

October 19, 2009

Re: 7014 Westmoreland Ave Takema Park, MD

(8) pages Total

Tax - 301 563-3412

10.19.09 NO HAMP PEQUIPED.

Please find enclosed the site plan of drawings of the project @ 7014 Westminland Avenue We discussed on the phone this morning. Please remembe this is Phone II (fine phone) of the project. You wanted review on Phase I because the project of the project. You wanted review on Phase I because the project pehind the building in the alley.


Please cell or email me if you next cay additional information.

Thanks In your help.

Mike

240-832-1815 Mikehe cutania Construction. com

11415 Somerset Avenue • Beltsville, MD 20705 • P 301,931,7665 • F 301,931,7669

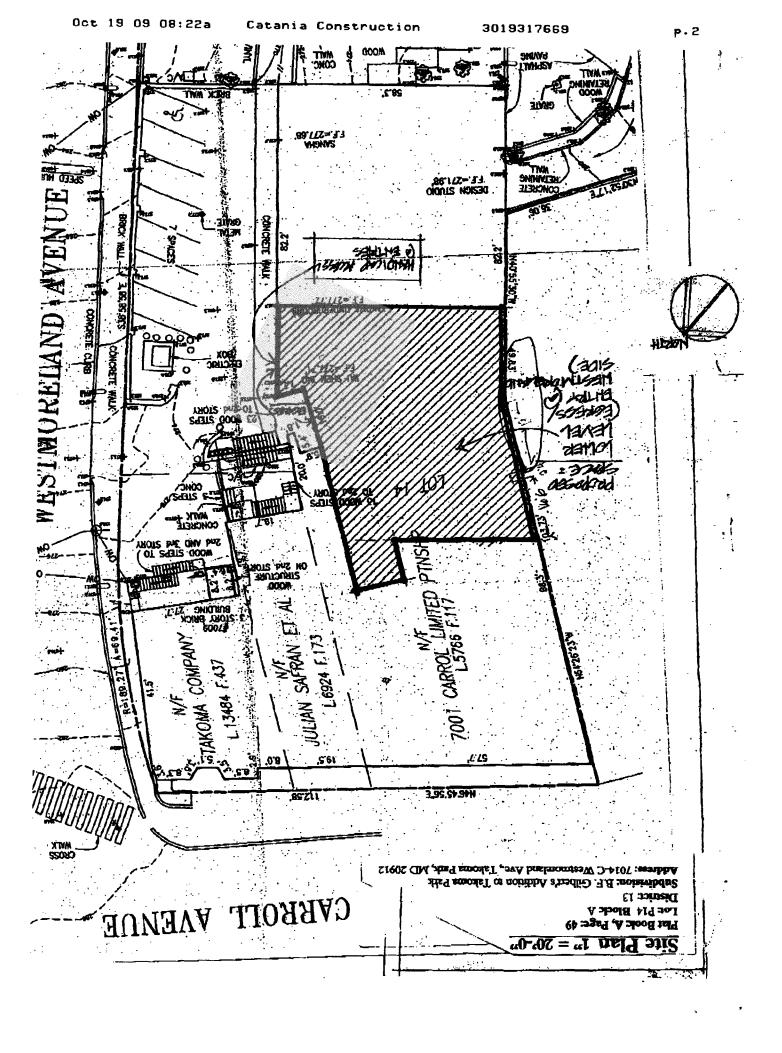


HJR STRUCTURAL ENGINEERS, LTD. RE: Wall Repair

4803 LEVADA TERRACE ROCKVILLE, MARYLAND 20853 301-460-4803 FAX 301-460-1344 COMM TOP Westmareland COMM NO 09081

RE: Wall Repair SHEET NO. 1 OF GO
CALCULATED BY he pare 10/9/09

THE MONE

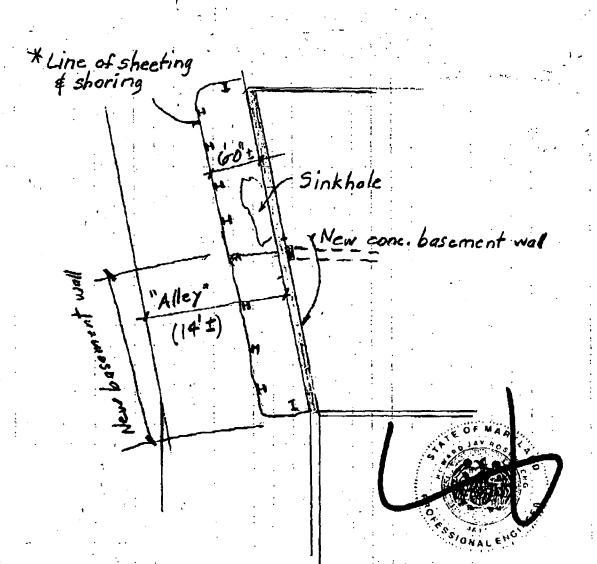

SCHEMATIC PLAN

To resert out Considerations in territy dentity that hess ducuments were chebried on approved by the and that have also because of the second corresponding unity national corresponding the level of the State of Maryland intense for individual to the second and the second and

No scale * To be designed by contractor's engineer

${ m HJR}$ structural engineers, Ltd.

4803 LEVADA TERRACE ROCKVILLE, MARYLAND 20853 301-460-4803 FAX 301-460-1344

COMM. 7014 West more land RE: Wall Repair CALCULATED BY LY	COMM. NO. 09081
RE: Wall Repair	SHEET NO. 4 OF 6
CALCULATED BY	DATE 10/9/09
CLIENT LEVIN	<u>,′ ′ ′ </u>

STRUCTURAL NOTES

- 1. All work to be in accordance with the 2006 IBC and the Amendments to the Building Code of Montgomery County, Maryland
- General Conditions shall be the AIA A 201, General Conditions for Construction.
- Contractor shall verify all dimensions and conditions in the field. Notify engineer of any discrepancies.
- 4. The purpose of these drawings is to depict a method of removing a bowed-in terra cotta basement wall. Methods of repair are suggested; contractor may use alternate methods provided they are submitted in writing to the engineer and approved.
 - A. Secure area in "Alley" in accordance with MOSHA regulations,
 - B. Install temporary shoring towers under the interior concrete floor slab to a snug tight position.
 - C. Install, in the outside "alley", sheeting and shoring at a sufficient distance away from the bowed-in wall to allow for workers to excavate, remove the existing bowed-in basement wall, and install the new reinforced concrete wall. Contractor shall have prepared sheeting and shoring drawings, signed and sealed by a Maryland professional engineer and submit for review by HJR Structural Engineers.
 - D. Excavate, in the alley, adjacent to the howed-in wall, down to the bottom of the existing footing. (It is assumed that there is a footing present).
 - E. Working in approximately four (4) foot sections, remove the bowed-in basement wall from the concrete slab down to the bottom of the existing footing. The purpose of working in four foot sections is to sustain the upper terra cotta wall and roof

Miss documents were prepared or approved by miss and the large daily licensed partnerspored by miss and partnerspored by missing professional services under the terms of the State of Mayabard, License No. 4531 Experience terms are also and a con-



HJR structural engineers, Ltd.

4803 LEVADA TERRACE ROCKVILLE, MARYLAND 20853 301-460-4803 FAX 301-460-1344

COMM. 7014 Westmoreland COMM. NO. 09081
RE Wall Repair SHEET NO. 5 OF 6
CALCULATED BY byr DATE TO 9/09
CLIENT Levin

without resorting to "needling". Contractor may use alternate methods as long as they are submitted for review by the engineer.

- F. Install the new 12" x 36" footing in sections with proper dowels.
- G. Install the new 12" thick reinforced concrete wall, again installed in four (4) foot sections, leaving horizontal dowels exposed in preparation to receive the adjacent new wall sections.

 Alternatively, contractor may choose to temporarily support the upper wall in its entirety and remove the bowed-in basement wall at one time. In either case, or in any other case, the contractor shall submit for review, a plan for performing this work.
- H. Prior to placing the new concrete basement wall, submit reinforcing steel shop drawings for review.
- I. Upon form removal, provide membrane waterproofing on the wall-exterior complete with protection board and drainage board.
- 5. Provide temporary support as required. Temporary shoring and support and job site safety are the sole responsibilities of the contractor.
 - Design Live Loads: First Floor: 100 psf, Roof = 30 psf; Wind = 90 mph.
 - Concrete for footings and wall: f'c = 4,000 psi. Concrete exposed to weather shall be air entrained with 6% +/-1%. All concrete to be normal weight concrete.

Concrete protection for reinforcement: Reinforcing bars to have a minimum concrete cover as specified in ACI 318. Formwork to be in accordance with ACI 347.

- Professional Confidences. I hornby configurate 60. Fabricate and provide supporting accessories in accordance these operations were proposed or appropriately the ACI Manual of Standard Practice, ACI 315, and CRSI angineer under the laws of the State of Acidental and accessories in accordance to the state of Acidental and accessories in accordance to the state of Acidental and accessories in accordance to the state of Acidental and accessories in accordance to the state of Acidental and accessories in accordance.
 - 10. Backfill: Proper precaution shall be taken to brace walls when backfilling. Backfill shall be clean, porous material, and shall be

6.

HJR STRUCTURAL ENGINEERS, LTD.

4803 LEVADA TERRACE ROCKVILLE, MARYLAND 20853 301-460-4803 FAX 301-460-1344

COMM. 7014 Westmoreland	COMM. NO. 09081
RE: Wall Repair	SHEET NO. 6 OF 6
CALCULATED BY 12 1	DATE 10/9/09
CLIENT LEVIN	
004.6	

compacted to 95% maximum optimum density in accordance with ASTM D 698. Install new asphaltic concrete paving per Civil Engineering consultant's recommendations.

11. Provide shop drawings for all elements



Professional Certifications. I hereby carmly that these documents were prepared or approved by me, and that I am a duly licensed professional engineer under the laws of the State of Marylano. License No. 4831 Expiration Cata: April 25, 2011



HISTORIC PRESERVATION COMMISSION

Isiah Leggett County Executive Jef Fuller Chairperson

Date: July 26, 2007

MEMORANDUM

TO:

Carla Reid Joyner, Director

Department of Permitting Services

FROM:

Anne Fothergill, Senior Planner

Historic Preservation Section

Maryland-National Capital Park & Planning Commission

SUBJECT:

Historic Area Work Permit #458378, Awning installation

The Montgomery County Historic Preservation Commission (HPC) has reviewed the attached application for a Historic Area Work Permit (HAWP). This application was **Approved** at the July 25, 2007 meeting.

The HPC staff has reviewed and stamped the attached drawings.

THE BUILDING PERMIT FOR THIS PROJECT SHALL BE ISSUED CONDITIONAL UPON ADHERENCE TO THE ABOVE APPROVED HAWP CONDITIONS AND MAY REQUIRE APPROVAL BY DPS OR ANOTHER LOCAL OFFICE BEFORE WORK CAN BEGIN.

Applicant:

Takoma Westmoreland, LLC

Address:

7014 Westmoreland Ave, Takoma Park

This HAWP approval is subject to the general condition that the applicant will obtain all other applicable Montgomery County or local government agency permits. After the issuance of these permits, the applicant must contact this Historic Preservation Office if any changes to the approved plan are made.





DPS -#

HISTORIC PRESERVATION COMMISSION 301/563-3400

APPLICATION FOR HISTORIC AREA WORK PERMIT

	Daytime Phone No.: 202-364-4510
Tax Account No : 161301078470	
Name of Property Owner, Takoma Westmoreland LLC	Daytime Phone No.: 202-354-4510
Address: 5151 Wisconsin Avenue, NW Suite 501, Washington	n, DC 20016
Street Number City Contraction: A-+ Display	Start Zip Code Phone No.:
Contractor Registration No.:	
Agent for Owner:	Daytime Phone No.:
OCATION OF BUILDING/PREMISE	
	Street 7014 Westmore and 17012 Westmore
Town-City: Takoma Park Yearest Cross	
, or some our statements	
iber: Felio: Parcer:	
PART ONE: TYPE OF PERMIT ACTION AND USE	
A CHECK ALL APPLICABLE: CHE	CK ALL APPLICABLE:
Construct : Extend : Alter/Renovate	A/C i Slab Till Room Addition Till Porch Till Deck Till Shed
	AC in Stab To Room Addition To Porch Collect Collection Solar Conference To Woodburning Stove Collections Shingle Family
Move Install 17 Wreckflare 7.5	
Move Install C WreckRaze S Revision C Repair C Revocable	Solar C Fireplace Woodburning Stove C Single Family Fence/Wall (complete Section 4) (/) Other:
Move Install Wreck-Raze S Revision Repair Revocable B. Construction cost estimate.	Solar Fireplace Woodburning Stove C Single Family Fence/Wall (complete Section 4) (/) Other:
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SEE REVERSE SIDE FOR INSTRUCTIONS


THE FOLLOWING ITEMS MUST BE COMPLETED AND THE REQUIRED DOCUMENTS MUST ACCOMPANY THIS APPLICATION.

١.	RITTEN DESCRIPTION OF PROJECT				
	 Description of existing structure(s) and environmental setting, including their historical features and significance; 				
	We will be adding awnings on three areas of the building located on Westmoreland Avenue	e			
	General description of project and its effect on the historic resource(s), the environmental setting, and, where applicable, the historic district:				
	The awning will have a minimal impact on the structure and setting. It should enhance the	-			
	appearance and safety of the property. No components of the facade will be removed or modified, the awning will be attached to the front of the facades which are currently made or	of			
	EFIS or cement.				
					
2.	TE PLAN				
	te and environmental softing, drawn to scale. You may use your plat, Your site plan must include:				
	the scale, north arrow, and diffe;"				
	dimensions of all existing and proposed structures; and				
	site features such as walkways, driveways, fences, ponds, streams, trash dumpsters, mechanical equipment, and landscaping.				
3.	ANS AND ELEVATIONS				
	w must submit 2 copies of class and elevations in a format no larger than 111 x 171. Plans on 8 1/21 x 111 paper are preferred.				
	Schematic construction plans, with marked dimensions, indicating location, size and general type of walls, window and door openings, at fixed features of both the existing resource(s) and the proposed work.	nd othe			
	Elevations (facades), with marked dimensions, clearly indicating proposed work in relation to existing construction and, when appropriate, co. All materials and fixtures proposed for the exterior must be noted on the elevations drawings. An existing and a proposed elevation drawing of facade affected by the proposed work is required.				
4.	ATERIALS SPECIFICATIONS				
	sherel description of materials and manufactured nems proposed for incorporation in the work of the project. This information may be included using a drawings	on you			
5.	HOTOGRAPHS				
	Clearly labeled photographic prints of each facade of existing resource, including details of the affected portions. All labels should be placed on front of photographs	the			
	Clearly label photographic points of the resource as viewed from the public right-of-way and of the adjoining properties. All labels should be plate front of photographs	aced o			
5.	BEE SURVEY				
	you hie proposing construction adjacent to or within the drightne of any tree 6" or larger in diameter (at approximately 4 feet above the ground), its: file an accurate tree survey identifying the size lipbellon, and species of each free of at least that dimension.	you '			
7	DDRESSES OF ADJACENT AND CONFRONTING PROPERTY OWNERS				

Rockville, (301/279-1355).

PLEASE PRINT (IN BLUE OR BLACK INK) OR TYPE THIS INFORMATION ON THE FOLLOWING PAGE. PLEASE STAY WITHIN THE CUIDES OF THE TEMPLATE, AS THIS WILL BE PHOTOCOPHED DIRECTLY ONTO MAILING LABELS.


for ALL projects, provide an accurate list of adjacent and confronting property owners (not tenants), including names, addresses, and rip codes, This list should include the owners of all lots or parcels which adjoin the percel in question, as with as the owner(s) of lot(s) or parcel(s) which lie directly across the street/highway from the parcel in question. You can obtain this information from the Department of Assessments and Taxation, 51 Morroe Street.

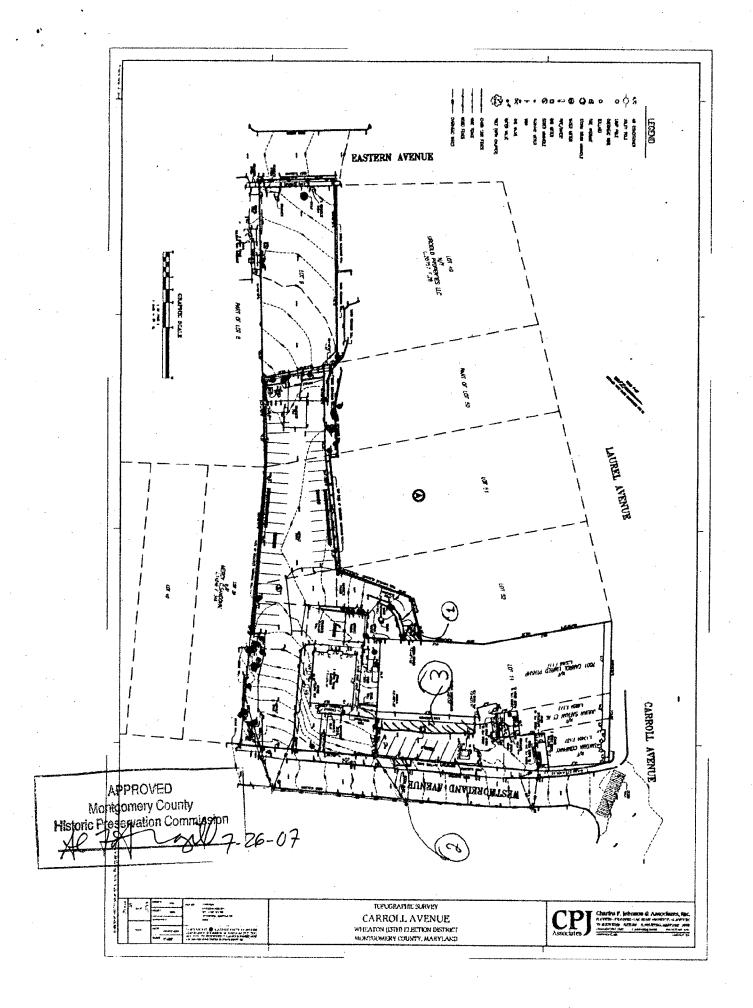

Existing Property Condition Photographs (duplicate as needed)



Detail:

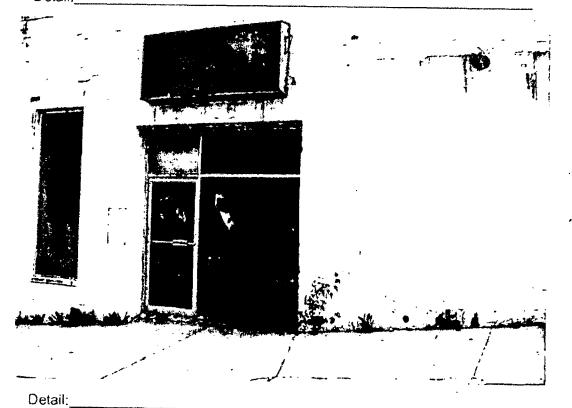


Applicant:

APPROVED
Mortigomery County
Historic Freservation Commission

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7-26-07

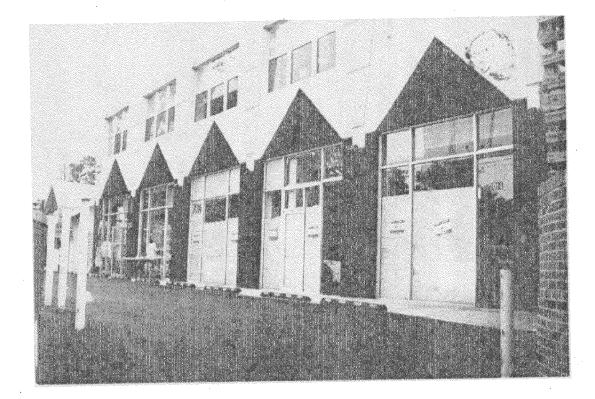

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Shade portion to indicate North

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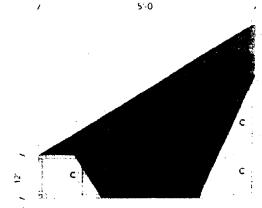
Montgomery County

Historic Preservation Commission

7-76-07

TENANT SPACE

ENLARGED AWNING SIGN DETAIL SCALE: 1/2" = 1'-0"



ENLARGED AWNING SIDE DETAIL SCALE: 3/8" = 1'-0"

TEMPORE


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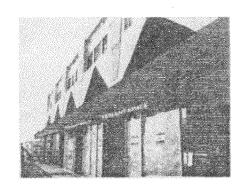
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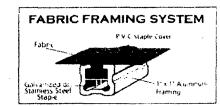
TENANT SPACE


AWNING SIGN DETAIL FRONT VIEW SCALE: 1/8" = 1'-0"

Manufacture one (1x) shed style awning to be installed on building front above glass widow and front doors. The awning materia is Signmaster Supreme Bright Blue #633. The bottom area of the awning will have a 12" valance with removable fabric panels that have white heat sealed letters applied. Awning frame will be made from 1" x 1" square aluminum tubing. Awning will be mounted to brick building by double expansion bolts. Two rows of flourescent lamps will be mounted to the back of the inner frame to give the awning illumination. One row of flourescent lamps will be mounted 12" from the front of the valance to illuminate the valance area.





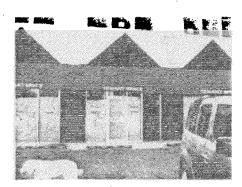

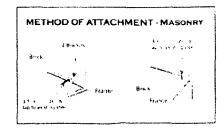

PREPARED AND PROVIDED BY.



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REVISIONS

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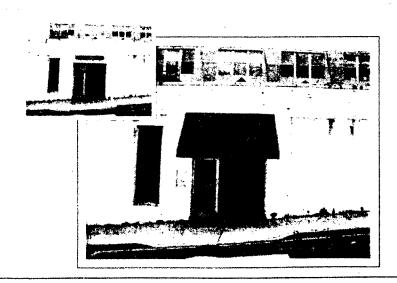
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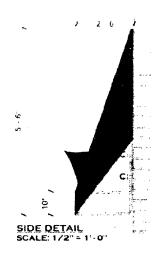
Historic Preservation Commission


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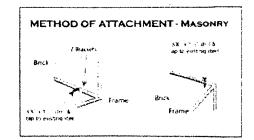
AWNING SIGN DETAIL SCALE: 1/2" = 1'-0"


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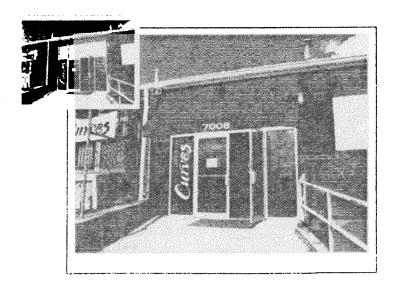









AWNING SIGN DETAIL, SCALE: 3/4" = 11.0"

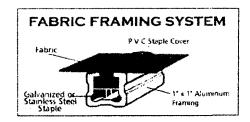
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PAGE: 1

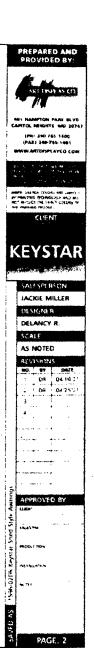APPROVED

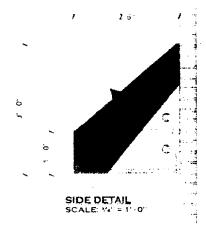Montgomery County

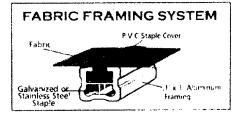Historic Preservation Commission

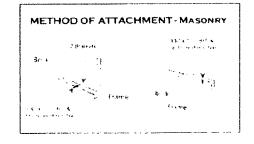-26-07

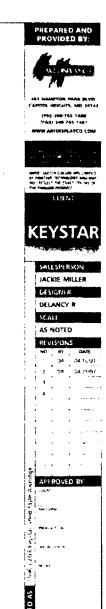MONTGOMERY COUNTY HISTORIC PRESERVATION COMMISSION STAFF REPORT

Address:

7012-14 Westmoreland Avenue, Takoma Park

Meeting Date: 07/25/07

Applicant:

Takoma Westmoreland LLC

Report Date: 07/18/07

Resource:

Non-Contributing Resource

Public Notice: 07/11/07

Takoma Park Historic District

Review:

HAWP

Tax Credit:

None

Case Number: 37/03-07W

Staff:

Anne Fothergill

PROPOSAL: Awning installation

STAFF RECOMMENDATION

Staff is recommending that the HPC approve this application.

PROJECT DESCRIPTION

SIGNIFICANCE:

Non-Contributing Resource within the Takoma Park Historic District

STYLE:

Commercial

DATE:

1940

PROPOSAL

The applicants are proposing to install fabric awnings above entries to commercial space in three areas of the building. Two of the entry areas face Westmoreland and one faces the parking lot behind the building.

The City of Takoma Park's Facade Advisory Board has reviewed and approved this proposal.

APPLICABLE GUIDELINES

When reviewing alterations and new construction within the Takoma Park Historic District several documents are to be utilized as guidelines to assist the Commission in developing their decision. These documents include the historic preservation review guidelines in the approved and adopted amendment for the Takoma Park Historic District (Guidelines), Montgomery County Code Chapter 24A (Chapter 24A), and the Secretary of the Interior's Standards for Rehabilitation (Standards). The pertinent information in these documents is outlined below.

Takoma Park Historic District

According to the Takoma Park Guidelines, Non-Contributing Resources in the Takoma Park Historic District are "either buildings that are of little or no architectural and historical significance to the historic district or are newer buildings that have been constructed outside of the district's primary periods of historical importance. These types of resources should receive the most lenient level of design review."

The Guidelines also state: "Most alterations and additions to Non-Contributing Resources should be approved as a matter of course. The only exceptions would be major additions and alterations to the scale and massing of non-Contributing Resources which affect the surrounding streetscape and/or landscape and could impair the character of the historic district as a whole."

Montgomery County Code; Chapter 24A

A HAWP permit should be issued if the Commission finds that:

- 1. The proposal will not substantially alter the exterior features of a historic site or historic resource within a historic district.
- 2. The proposal is compatible in character and nature with the historical archaeological, architectural or cultural features of the historic site or the historic district in which a historic resource is located and would not be detrimental thereto of to the achievement of the purposes of this chapter.

In the case of an application for work on a historic resource located within a historic district, the Commission shall be lenient in its judgment of plans for structures of little historical or design significance or for plans involving new construction, unless such plans would seriously impair the historic or architectural value surrounding historic resources or would impair the character of the historic district.

Secretary of the Interior's Standards for Rehabilitation:

Standard #2 The historic character of a property will be retained and preserved. The removal of distinctive materials or alteration of features, spaces, and spatial relationships that characterize a property will be avoided.

Standard #9: New additions, exterior alterations, or related new construction will not destroy historic materials, features, and spatial relationships that characterize the property. The new work shall be differentiated from the old and will be compatible with the historic materials, features, size, scale and proportion, and massing to protect the integrity of the property and its environment.

STAFF DISCUSSION

Non-Contributing Resources in the Takoma Park Historic District receive the most lenient level of design review. The HPC considers alterations to Non-Contributing Resources in terms of their impact on the overall streetscape and environmental setting of the historic district. The addition of awnings to this commercial building will not adversely impact the streetscape or the historic district. Staff recommends approval.

STAFF RECOMMENDATION

Staff recommends that the Commission *approve* the HAWP application as being consistent with Chapter 24A-8 (b) 2:

The proposal is compatible in character and nature with the historical, archeological, architectural or cultural features of the historic site or the historic district in which an historic resource is located and would not be detrimental thereto or to the achievement of the purposes of this chapter,

and with the Secretary of the Interior's Standards for Rehabilitation,

and with the general condition applicable to all Historic Area Work Permits that the applicant will present <u>3 permit sets of drawings</u> to HPC staff for review and stamping prior to submission for permits (if applicable). After issuance of the Montgomery County Department of Permitting Services (DPS) permit, the applicant will arrange for a field inspection by calling the DPS Field Services Office at (240) 777-6370 or online at www.permits.emontgomery.org prior to commencement of work and not more than two weeks following completion of work.





Edit 6/21/99

RETURNIO DEPARTMENT OF PERMITTING SCRINCES

755 ROCKVILLE PINE 200 FEOOR, ROCKVILLE I/O 2008

246 777-8249

DDS . #

HISTORIC PRESERVATION COMMISSION 301/563-3400

APPLICATION FOR HISTORIC AREA WORK PERMIT

	Contact Person: Bruce Levin
	Daytime Phone No.: 202-364-4510
Tax Account No. 161301078470	
Name of Property Owner: Takoma Westmoreland LLC	DayLinte Phone No : 202-364-4510
Address: 5151 Wisconsin Avenue, NW Suite 501, Washington, D	C 20016
Street Humber Uty Contraction: Art Display	State Zip Code Phone No.:
Contractor Registration No.	
Agent for Owner:	Daytime Phone No.:
LOCATION OF BUILDING/PREMISE	
House Number: DBA Comman Type Stee	1 7014 Westmoreland 17012 Westmoreland Ave
Town/City Takoma Park Vearest Cross Stree	
PART ONE: TYPE OF PERMIT ACTION AND USE	
1A CHECK ALL APPLICABLE: CHECK A	IL APPLICABLE:
	Fig. Slab Fig. Room Addition Fig. Porch 12 Deck 12 Shed
	Fireblace Woodburning Stove Single Family
·	e/Wall (complete Section 4) (r) Other:
18 Construction cost estimate: \$	Awaings
1C. If this is a revision of a proviously approved active permit, see Permit #	
PART TWO: COMPLETE FOR NEW CONSTRUCTION AND EXTEND/ADD	TIONS
ZA Type of sawage disposal: 01 17 WSSC 02 17 Septic	03 🗔 Other:
28 Type of water supply 01 T WSSC 02 T Well	03 Other:
PART THREE: COMPLETE ONLY FOR FENCE/RETAINING WALL	
JA Height feet inches	
18 Indicate whether the lence of retaining wall is to be constructed on one of the	a following location
On party line	C) On public right of wayressement
The state of the s	Construite right of Hope constront
I hereby certify that I have the authority to make the foregoing application, that the	
approved by all agencies listed and I hereby acknowledge and accept this to be a	o Cammon for the issuance Or tras perma.
	6/25/07
Signature of owner or exchanged equal	Once Once
1150270	
Approved 900016 for Che	uperson, Historic Preservation Commission
Disapproved Signature:	Cate:
Application/Permit No Cate	Filed: (0/29/01 Date Issued:

THE FOLLOWING ITEMS MUST BE COMPLETED AND THE REQUIRED DOCUMENTS MUST ACCOMPANY THIS APPLICATION.

1.	. M	RITTEN DESCRIPTION OF PROJECT
	a.	Description of existing structure(s) and environmental setting, including their historical features and significance;
		We will be adding awnings on three areas of the building located on Westmoreland Avenue
		General description of project and its effect on the historic resource(s), the environmental setting, and, where applicable, the historic district:
	U.	The awning will have a minimal impact on the structure and setting. It should enhance the
		appearance and safety of the property. No components of the facade will be removed or
		modified, the awning will be attached to the front of the facades which are currently made of
		EFIS or cement.
	•	
2.	<u>\$1</u>	TE PLAN
	Şi	te and environmental setting, drawn to scale. You may use your plat. Your afte pen must include:
	a.	the scale, north errow, and date;
	h	dimensions of all existing and proposed structures; and
	b.	
	C.	site features such as walkways, driveways, fences, pands, streams, trash dumpsters, mechanical equipment, and landscaping.
1.	2	ans and elevations
	Yo	u must submit 2 copies of class and elevations in a format no larger than 11° x 17°. Plans on \$ 1/2° x 11° paper are preferred.
	ā.	Schemetic construction plans, with marked dimensions, indicating location, size and general type of walls, window and door openings, and other fixed features of both the existing resource(s) and the proposed work.
	b	Elevations (facades), with marked dimensions, clearly indicating proposed work in relation to existing construction and, when appropriate, context. All materials and fixtures proposed for the exterior must be noted on the elevations drawings. An existing and a proposed elevation drawing of each facade affected by the proposed work is required.
4.	M	aterials specifications
		morel description of materials and manufactured items proposed for incorporation in the work of the project. This attermation may be included on you sign drawings.
5.	면	HOTOGRAPHS
		Clearly labeled photographic prints of each facade of existing resource, including details of the affected partians. At labels should be placed on the front of photographs
	ð.	Clearly label photographic prints of the resource as viewed from the public right-of-way and of the adjoining properties. All labels should be placed on the front of photographs.
6.	73	REE SURVEY
		you are proposing construction adjacent to or within the displine of any blee 6" or larger in diameter (at approximately 4 feet above the ground), you are file an accurate tree survey identifying the size, location, and species of each tree of at feast that dimension.
7	A	PORESSES OF ADJACENT AND CONFRONTING PROPERTY OWNERS


Rockwile, (301/279-1355).


PLEASE PRINT (IN BLUE OR BLACK INK) OR TYPE THIS INFORMATION ON THE FOLLOWING PAGE. PLEASE STAY WITHIN THE GUIDES OF THE TEMPLATE, AS THIS WILL BE PHOTOCOPIED DIRECTLY ONTO MAILING LABELS.

For Att projects, provide an accurate list of adjacent and confronting property owners (not tenants), including names, addresses, and tip codes. This list should include the owners of all lots or parcels which adjoin the parcel in question, as well as the owner(s) of lot(s) or parcel(s) which lie directly across the street/highway from the parcel in question. You can obtain this information from the Department of Assessments and Taxation, 51 Mosroe Street.

HAWP APPLICATION: MAILING ADDRESSES FOR NOTIFING [Owner, Owner's Agent, Adjacent and Confronting Property Owners]


Owner's mailing address	Owner's Agent's mailing address
Brucelevin	
C/O KeystarllC	
SISI Wisconsin Ave, NW Suite SOI	
Washington DC 20016	
Adjacent and confronting	Property Owners mailing addresses
John Urciolo	Julian Satran
Urciolo Properties, LLC	7504 Royal Dominion Prive
6935 Laurel Avenue	Bethesda, MD 208174658
Juite 100	,
Takoma Park, MD 20912	
Mercy C. Sandoval 7006 Westenorland Arenne	
7006 Westenorland Avenue	
Takoma Perk, MD 20912	

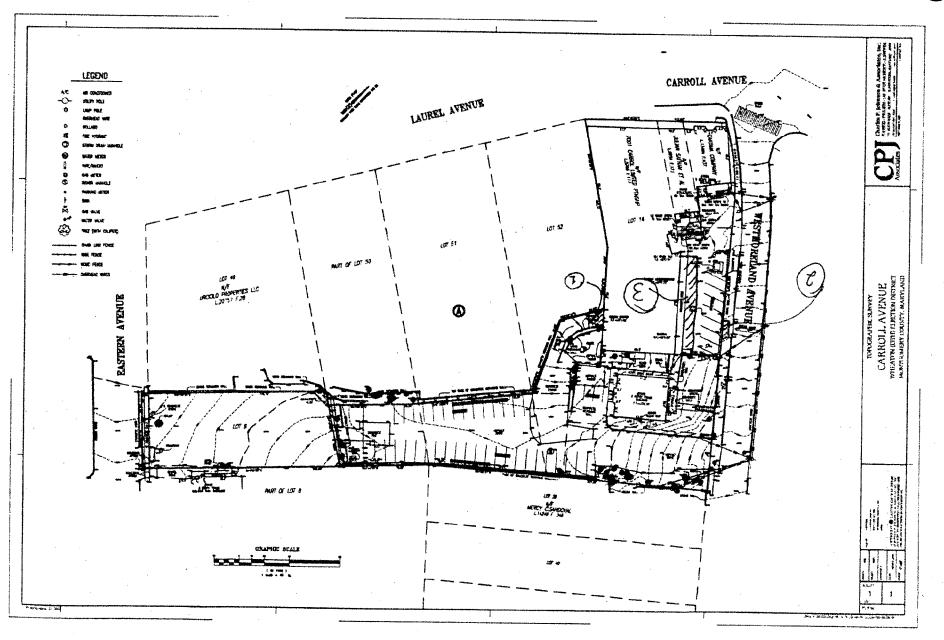


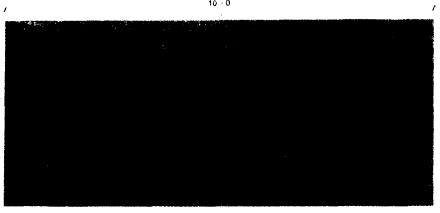



AWNING SIGN DETAIL SCALE: 1/2" = 1'-0"

Manufacture one (1x) shed style awning to be installed on brick building above glass widow and front door. The awning material is Signmaster Supreme Bright Blue #633. Awning frame will be made from 1*x 1* square aluminum tubing. Awning will be mounted to brick building by double expansion bolts. Two rows of flourescent lamps will be mounted to the back of the inner frame to give the awning illumination.

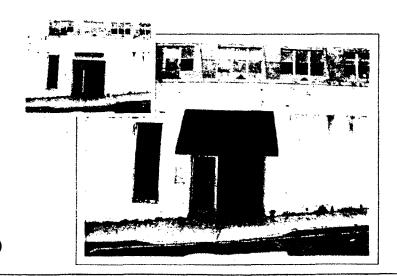

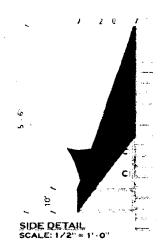

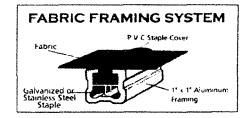

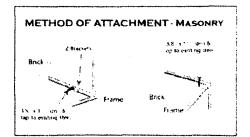





491 MARPTON PAILS BLVD CAPTON, NEWSHIE BAD 20743 (PNI 240-765 1440

(PRI) 340-765-1481 (FRIO 346-766-1481 WWW-ARTDISPLAYCO COM

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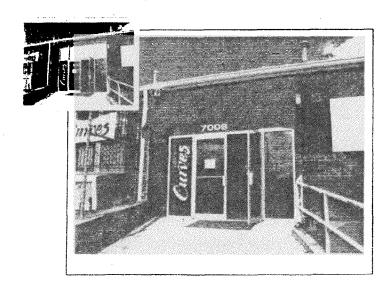
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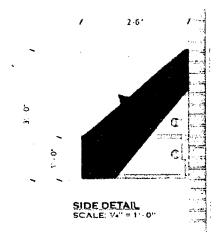
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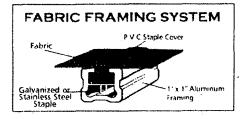
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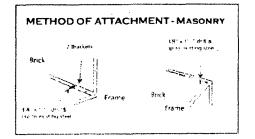
AWNING SIGN DETAIL SCALE: 3/4" = 1'-0"

Manufacture one (1x) shed style awning to be installed on brick building above glass widow and front doors. The awning material is Signmaster Supreme Bright Blue #633. The bottom area of the awning will have a 12° valance with white vinyl address applied. Awning frame will be made from 1" x 1" square aluminum tubing. Awning will be mounted to brick building by double expansion bolts. Two rows of flourescent lamps will be mounted to the back of the inner frame to give the awning illumination.













EDT REALFTON MEAN MEND CAPTION HEROSTIN, USD 1874 (PRI) 340-745-1440; (PAI) 340-745-144;

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PAGE: 1

TENANT SPACE

ENLARGED AWNING SIGN DETAIL SCALE: 1/2" = 1'-0"

5'-0


ENLARGED AWNING SIDE DETAIL SCALE: 3/8" = 1'-0"


13-8

AWNING SIGN DETAIL FRONT VIEW SCALE: 1/8" = 1'-0" Manufacture one (1x) shed style awning to be installed on building front above glass widow and front doors. The awning materia is Signmaster Supreme Bright Blue #633. The bottom area of the awning will have a 12° valance with removable fabric panels that have white heat sealed letters applied. Awning frame will be made from 1" x 1" square aluminum tubing. Awning will be mounted to brick building by double expansion bolts. Two rows of flourescent lamps will be mounted to the back of the inner frame to give the awning illumination. One row of flourescent lamps will be mounted 12" from the front of the valance to illuminate the valance area.





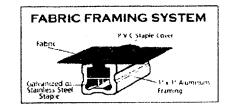

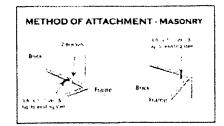

PREPARED AND PROVIDED BY:



(Pti) 249 765 1406 (PAX) 246-765-1401



JACKIE MILLER

DESIGNER


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SCALE AS NOTED

Existing Property Condition Photographs (duplicate as needed)




Detail:_

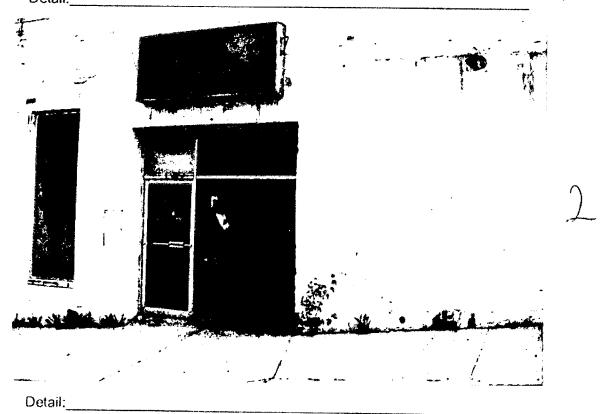

Applicant:

Page:_

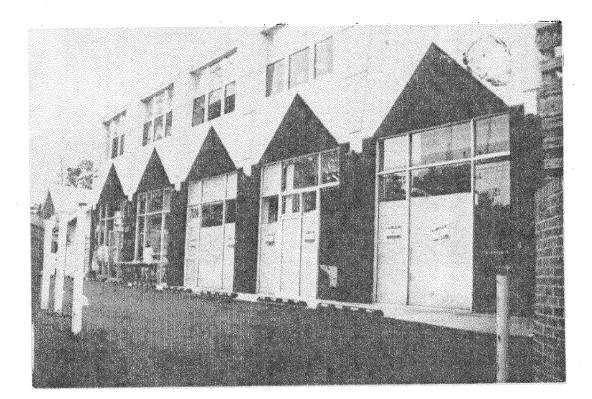

Shade portion to indicate North

Applicant:

Page:__([])

City of Takoma Park, Maryland

Housing & Community Development

Telephone: (301) 891-7119 Fax: (301) 270-4568



7500 Maple Avenue Takoma Park, MD 20912

July 5, 2007

Mr. Jef Fuller, Chair Historic Preservation Commission 1109 Spring Street, Suite 801 Silver Spring, Maryland 20910

RE: 7001 Carroll Avenue - 7014 Westmoreland Avenue, Takoma Park - Proposed Awnings

Dear Mr. Fuller:

The Takoma Park Facade Advisory Board met on Tuesday, June 19, 2007, to review a proposal submitted by Mr. Bruce Levin, owner of Westmoreland, LLC, for the installation of awnings above all openings on three faces of the Westmoreland Avenue property - 7008 - 7014. The application is to be considered by the Historic Preservation Commission later this summer.

The Board found the proposal to be in general compliance with the design guidelines developed for the area and endorsed the proposal as presented with the following condition:


The color is to be loden green fireresist material.

If you have any questions regarding the Board's action, please call.


Thank you for the ongoing efforts of the Commission to preserve the unique architectural character of our historic business district.


Sincerely,

Ilona Blanchard Senior Planner

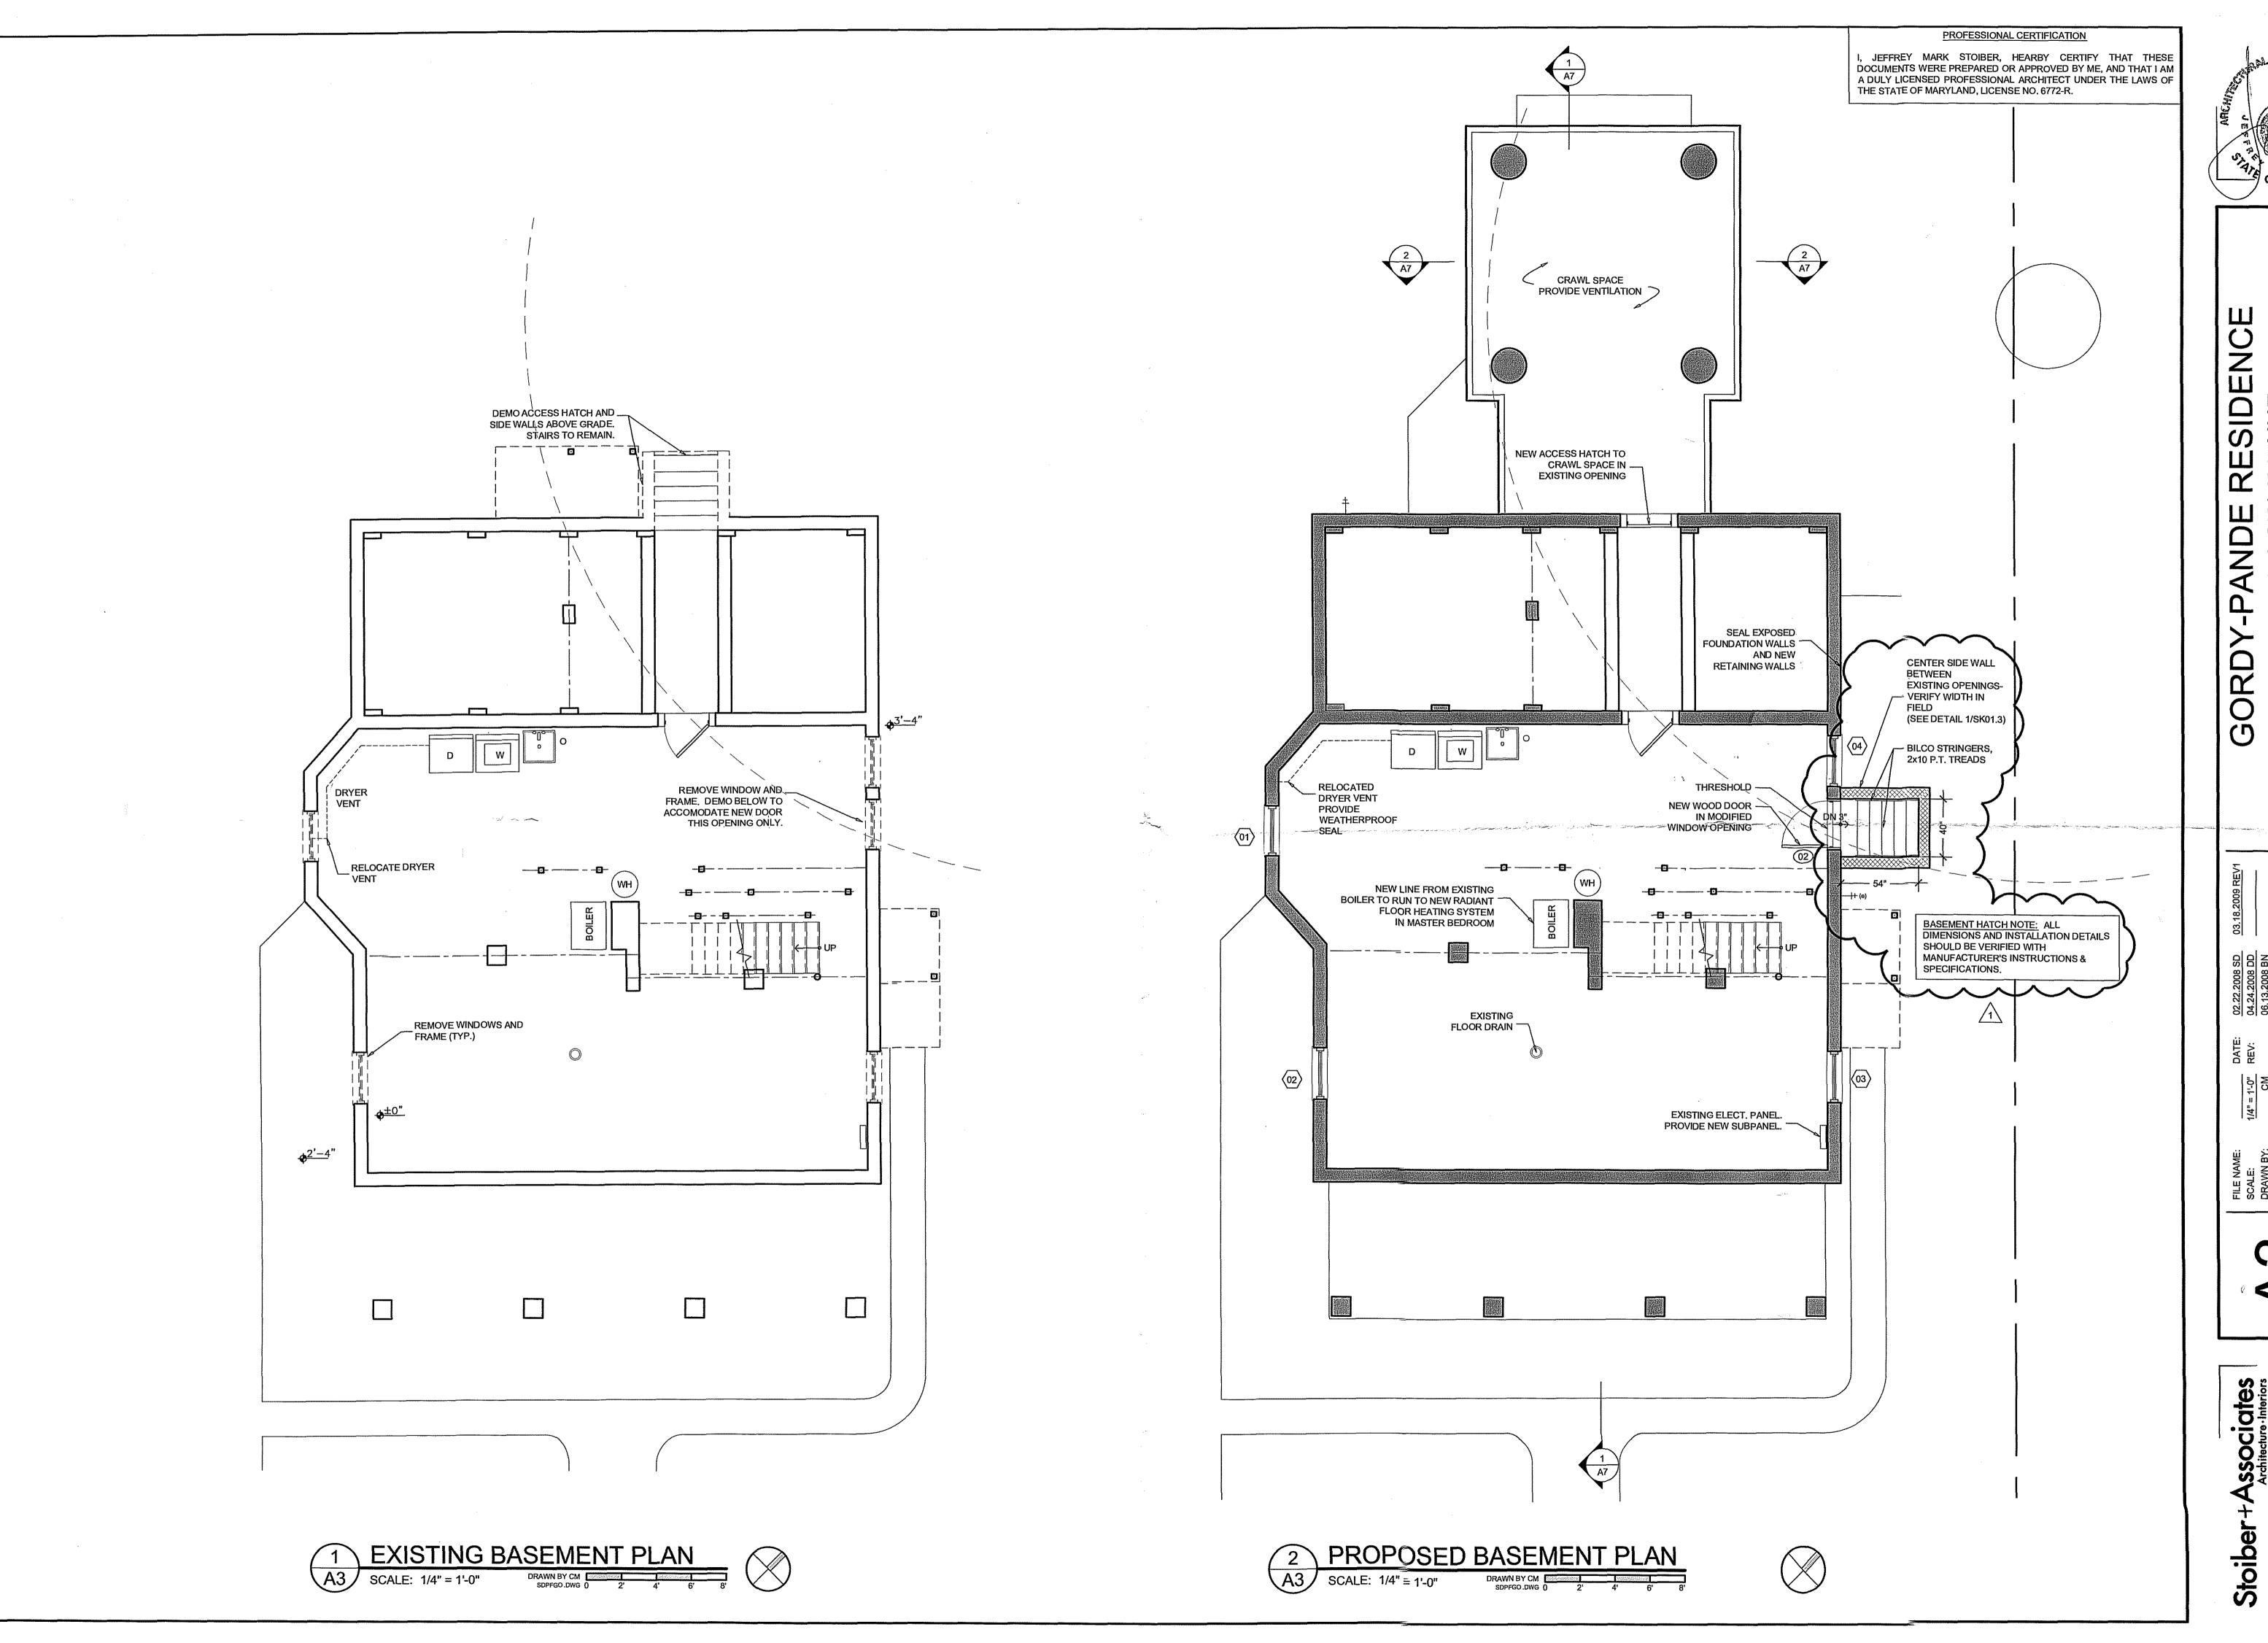

GORD

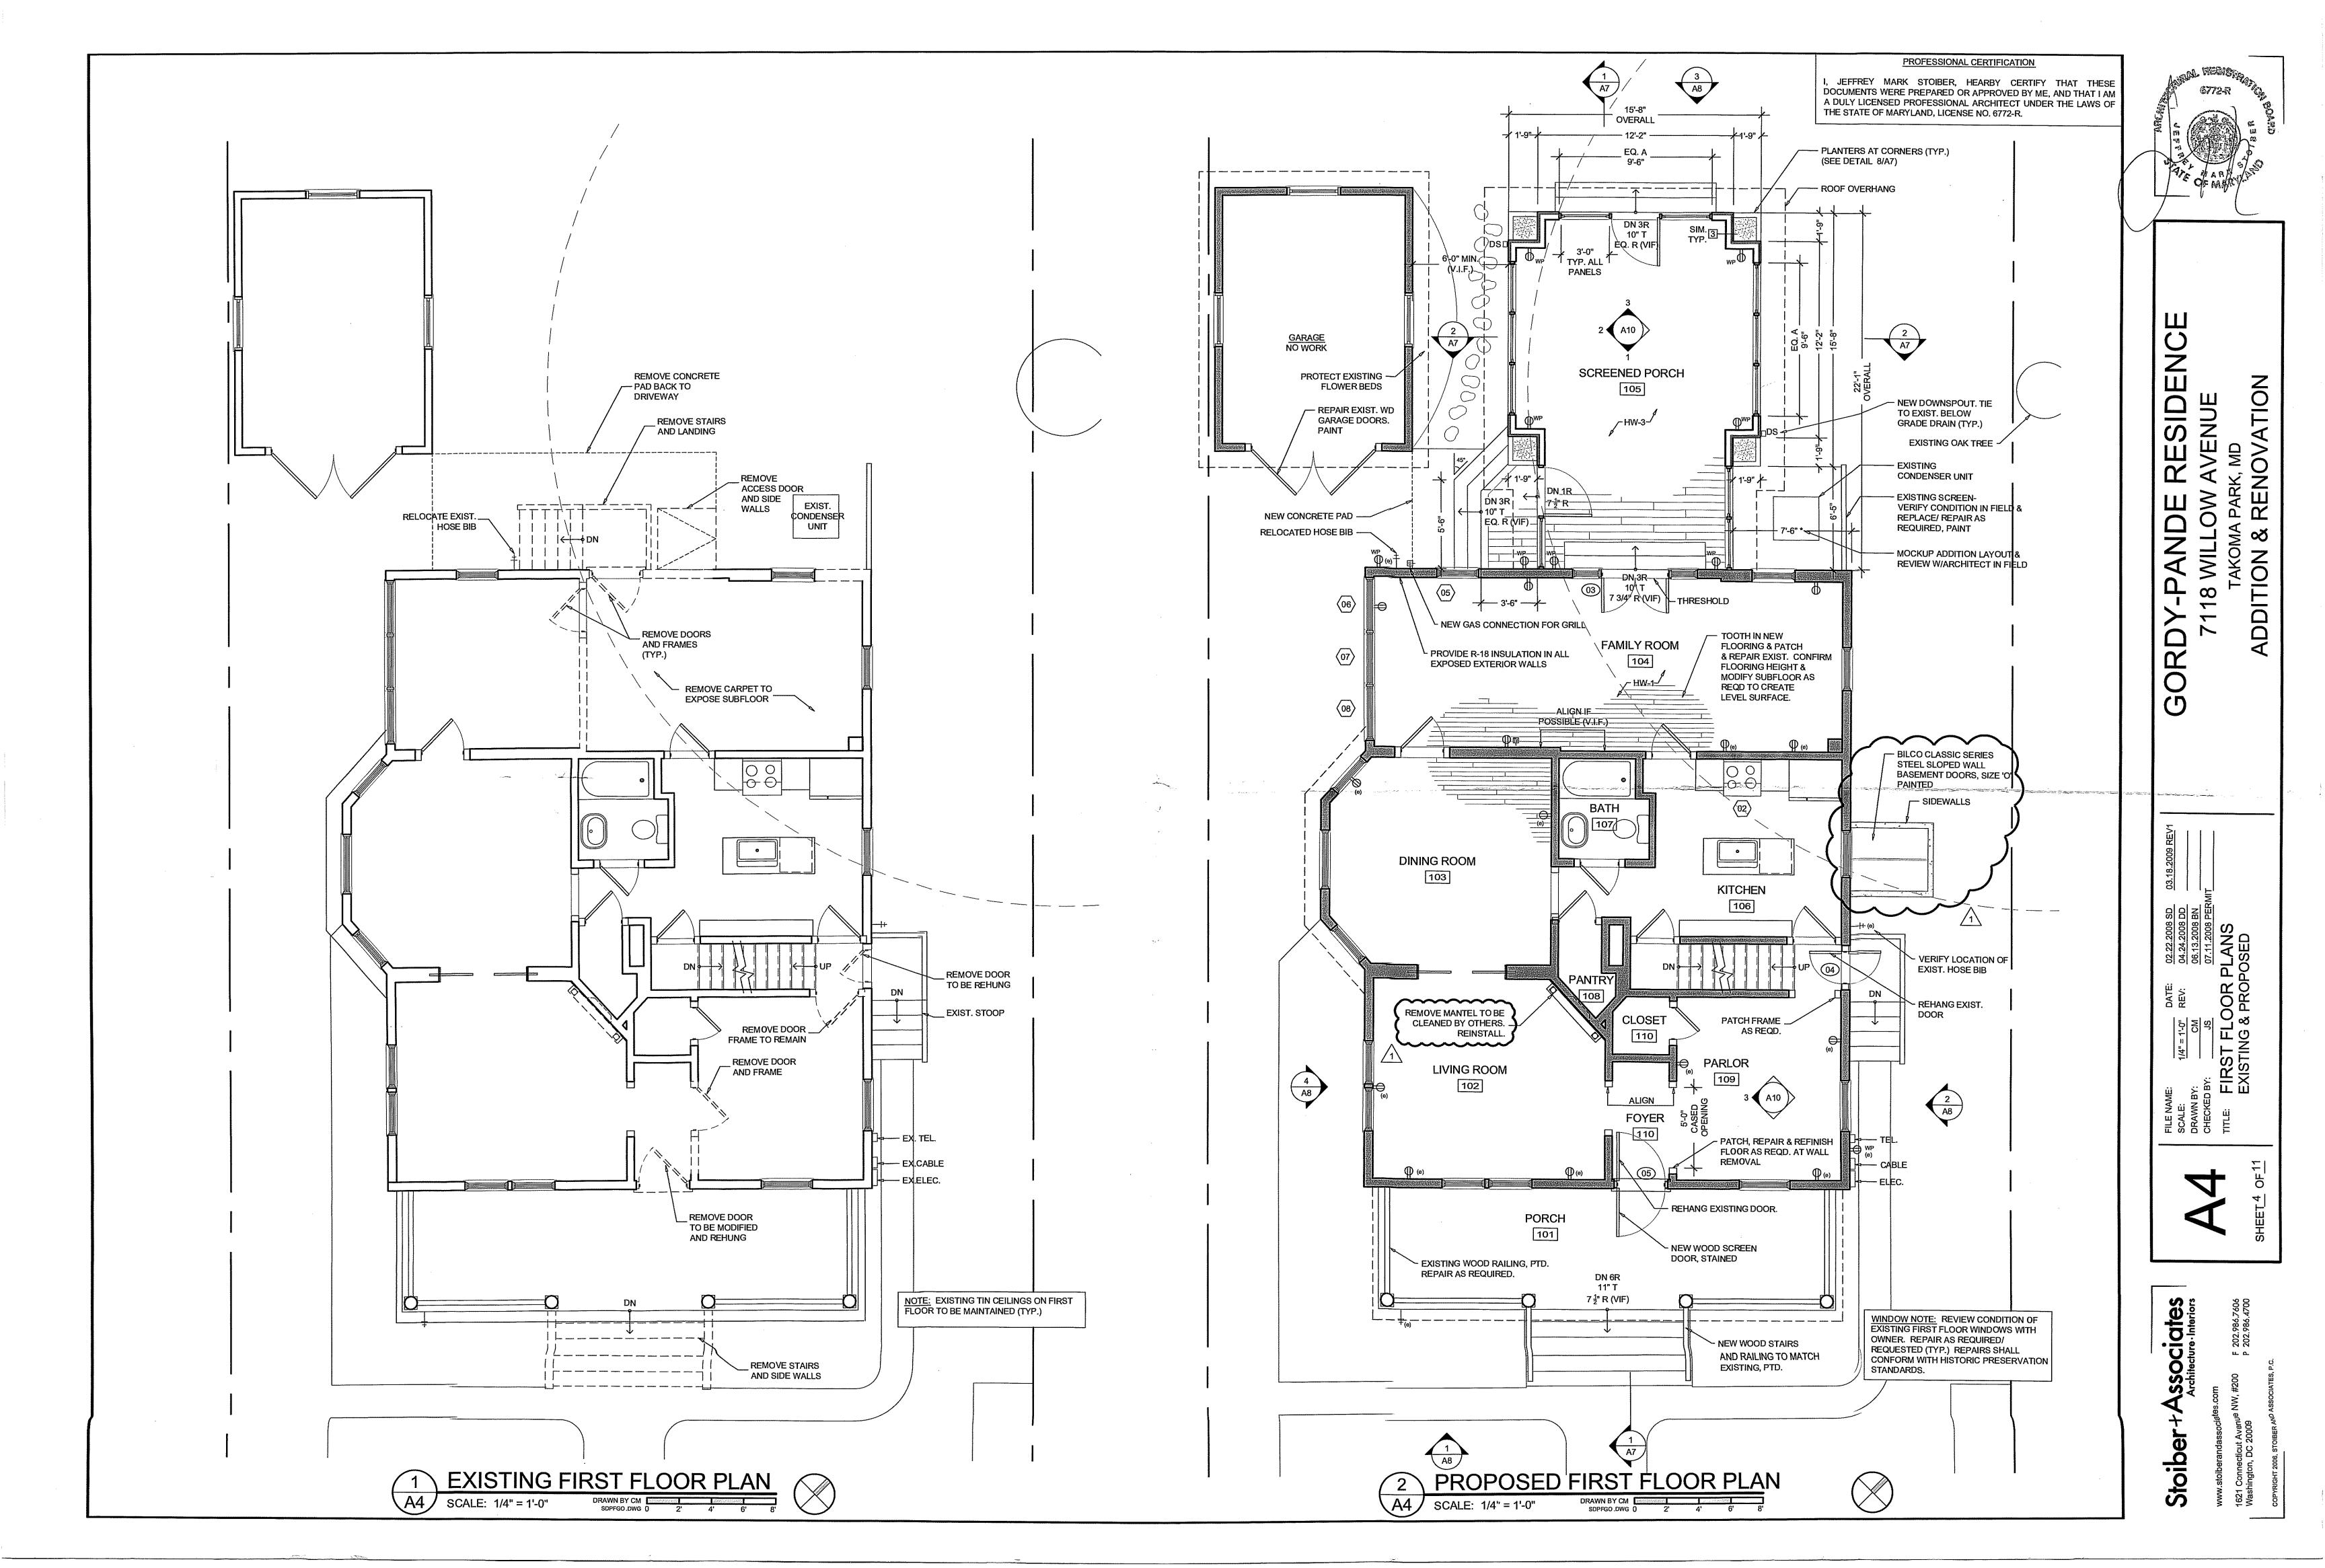

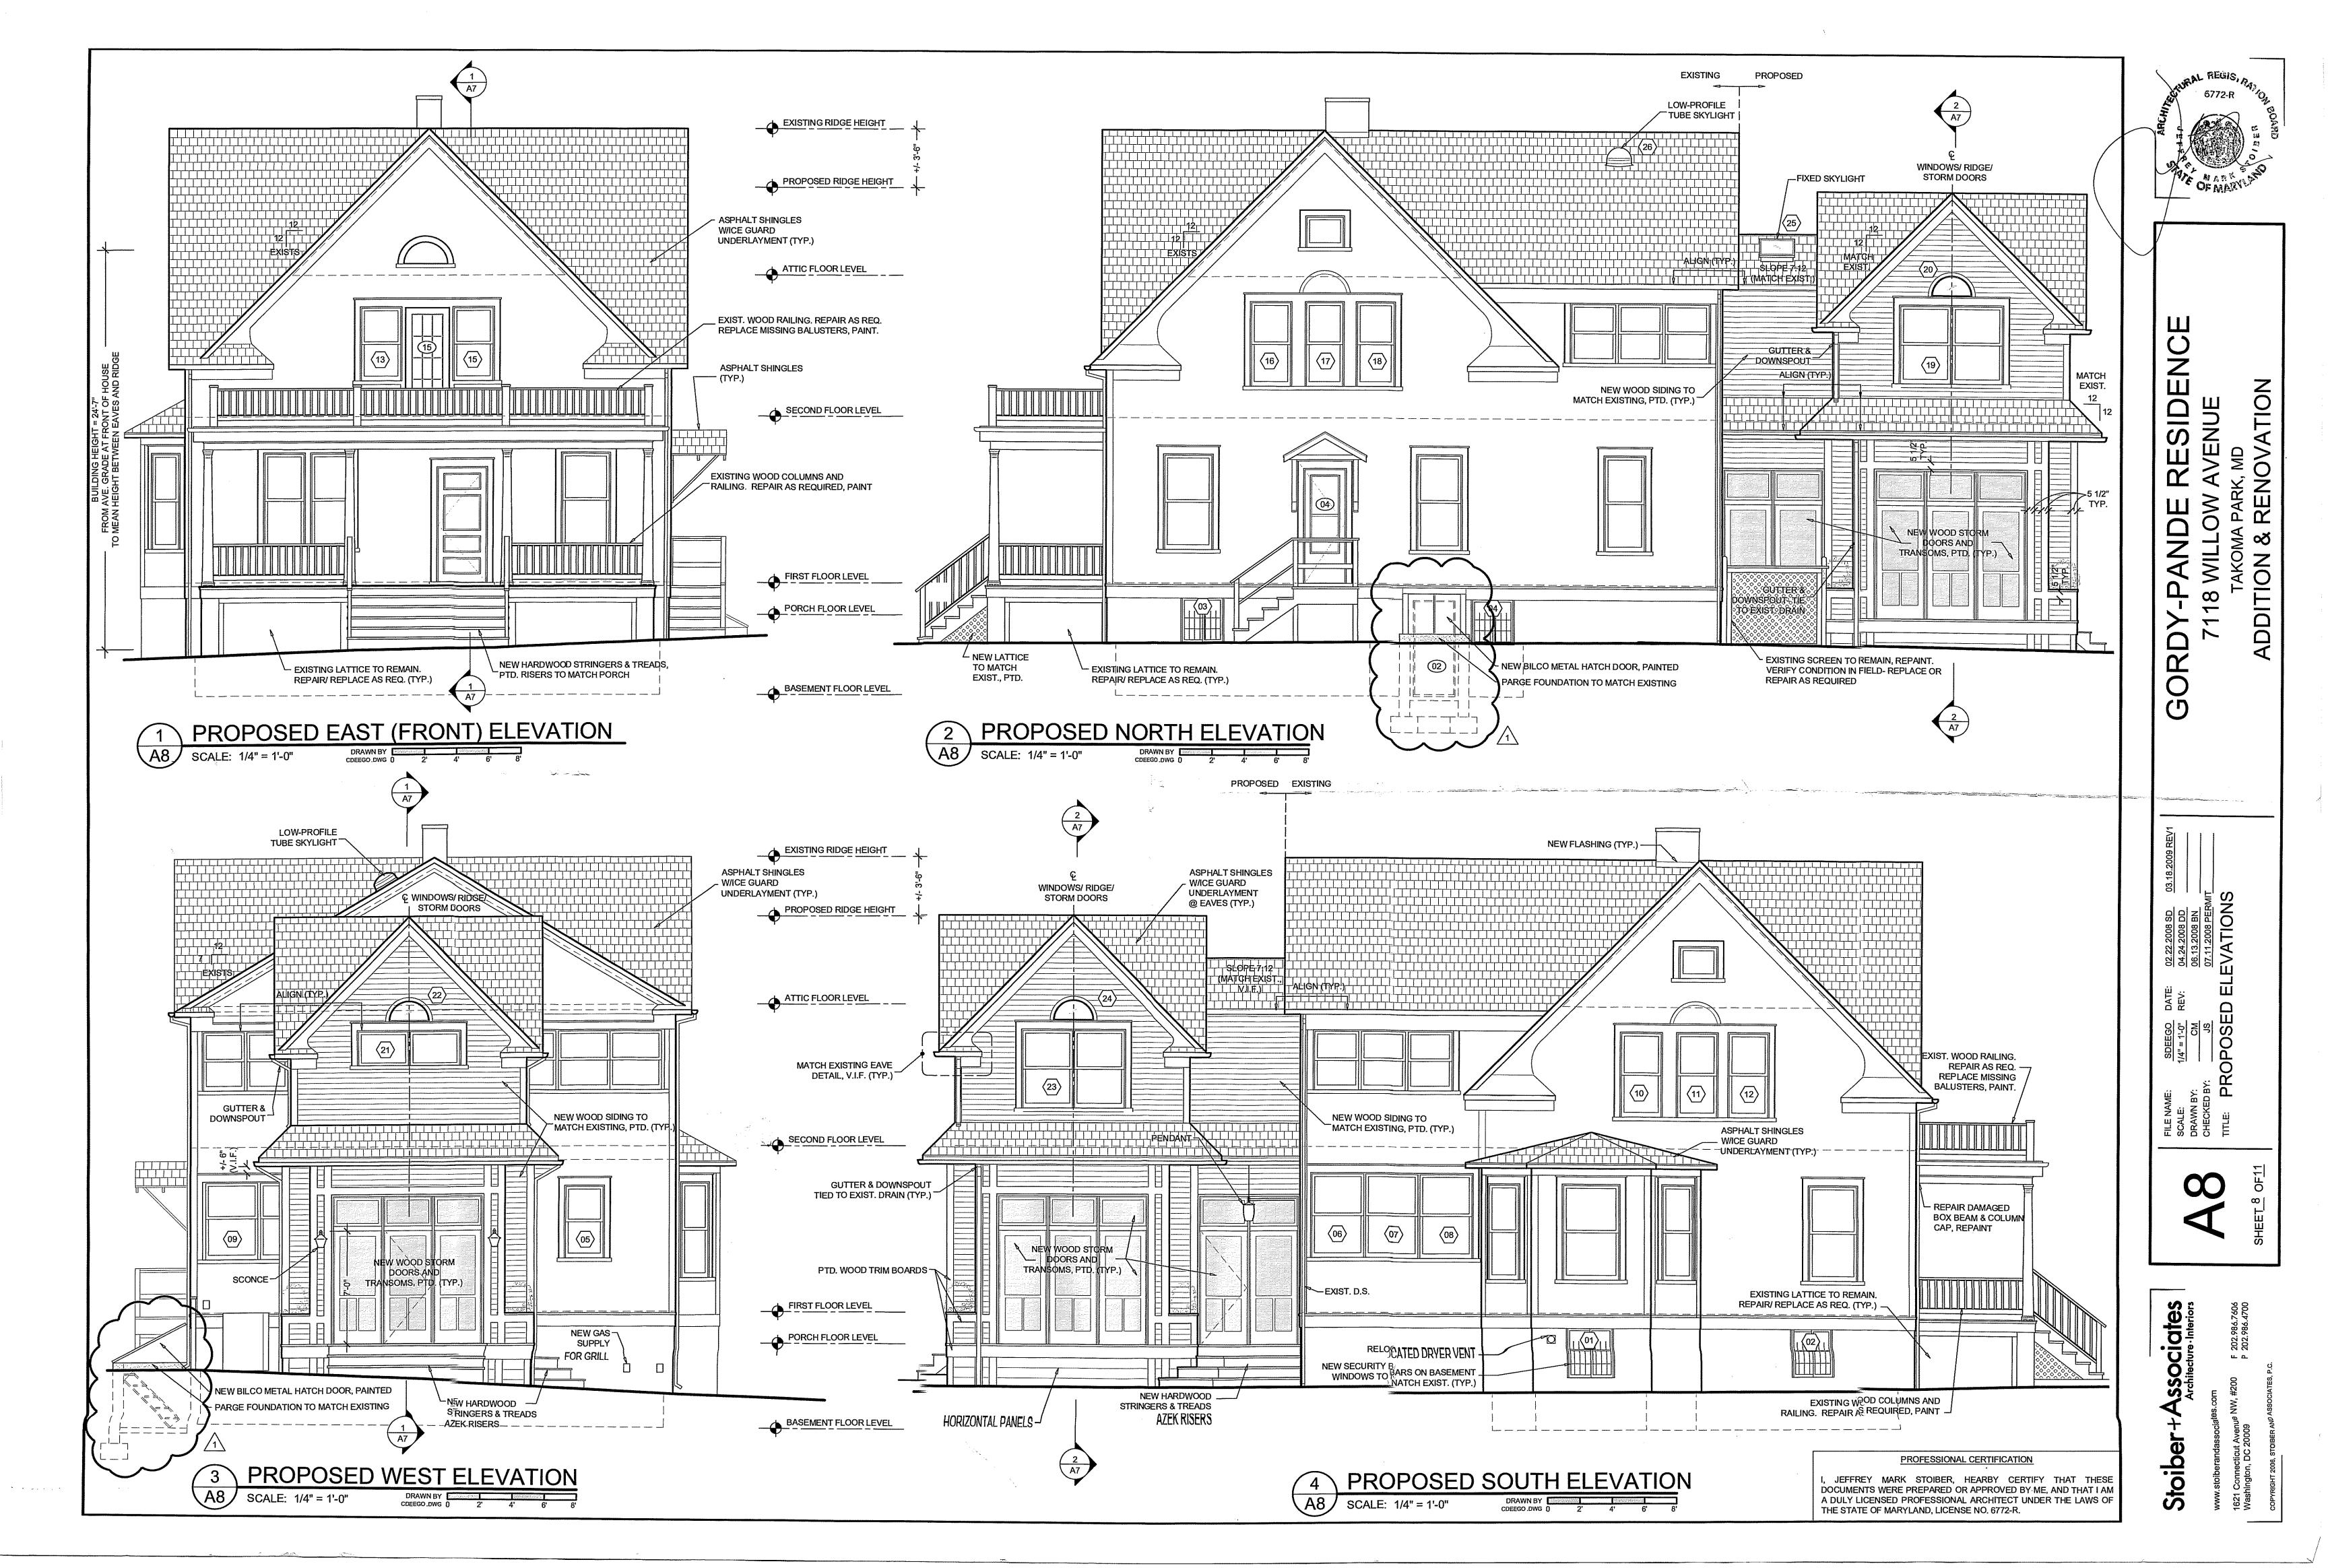

AWNING INSTALLATION WORK AT 7014 WESTMORELAND AVE.

TAKOMA PARK, MARYLAND, 20912

DRAWING INDEX

TITLE SHEETS

TI - TITLE SHEET


ARCHITECTURAL

- A-I CODE ANALYSIS, GENERAL NOTES & SITE PLAN
- A-2 FLOOR PLANS DEMOLITION BASEMENT AND FIRST FLOOR
- A-3 FLOOR PLANS NEW WORK BASEMENT AND FIRST FLOOR
- A-4 ELEVATIONS DEMOLITION
- A-5 ELEVATIONS NEW WORK
- A-6 AWNING DETAILS

ELECTRICAL

BASEMENT AND FIRST FLOOR PLANS

SITE LOCATION MAP

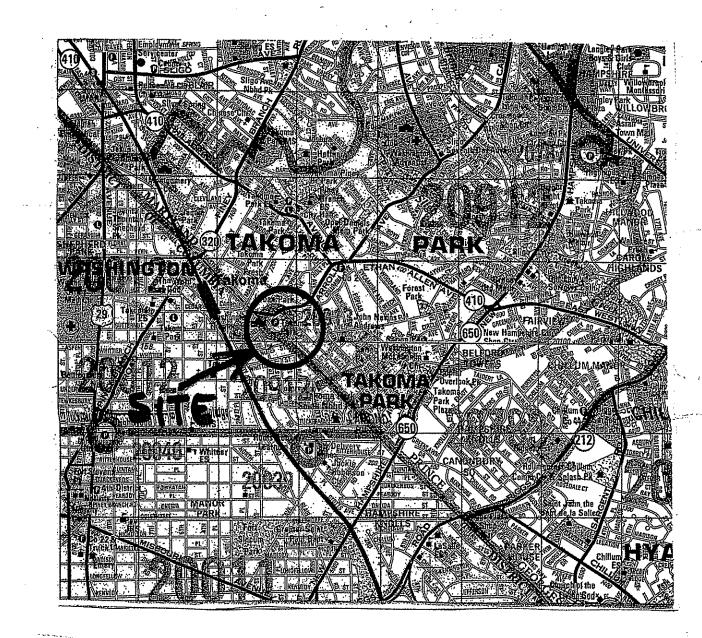

PROJECT:

EXTERIOR AWNING WORK AT 7014 WESTMORELAND AVE. TAKOMA PARK, MD 20912


OWNER:

TAKOMA WESTMORELAND L.L.C. 5151 WISCONSIN AVE., N.W., SUITE 501 WASHINGTON, DC 20008

ARCHITECT:

THEODORE A. CAGE, ARCHITECT 2745 29TH ST, N.W. NO. 605 WASHINGTON, D.C. 20008

> 240-855-4454 202-234-5975

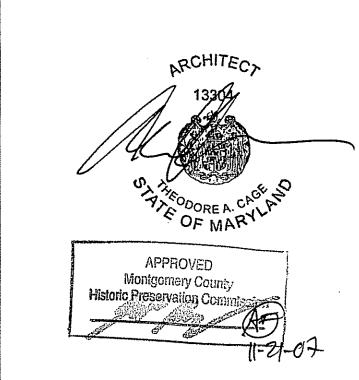

SUED FOR:	
RMIT SUBMISSION	10/31/07

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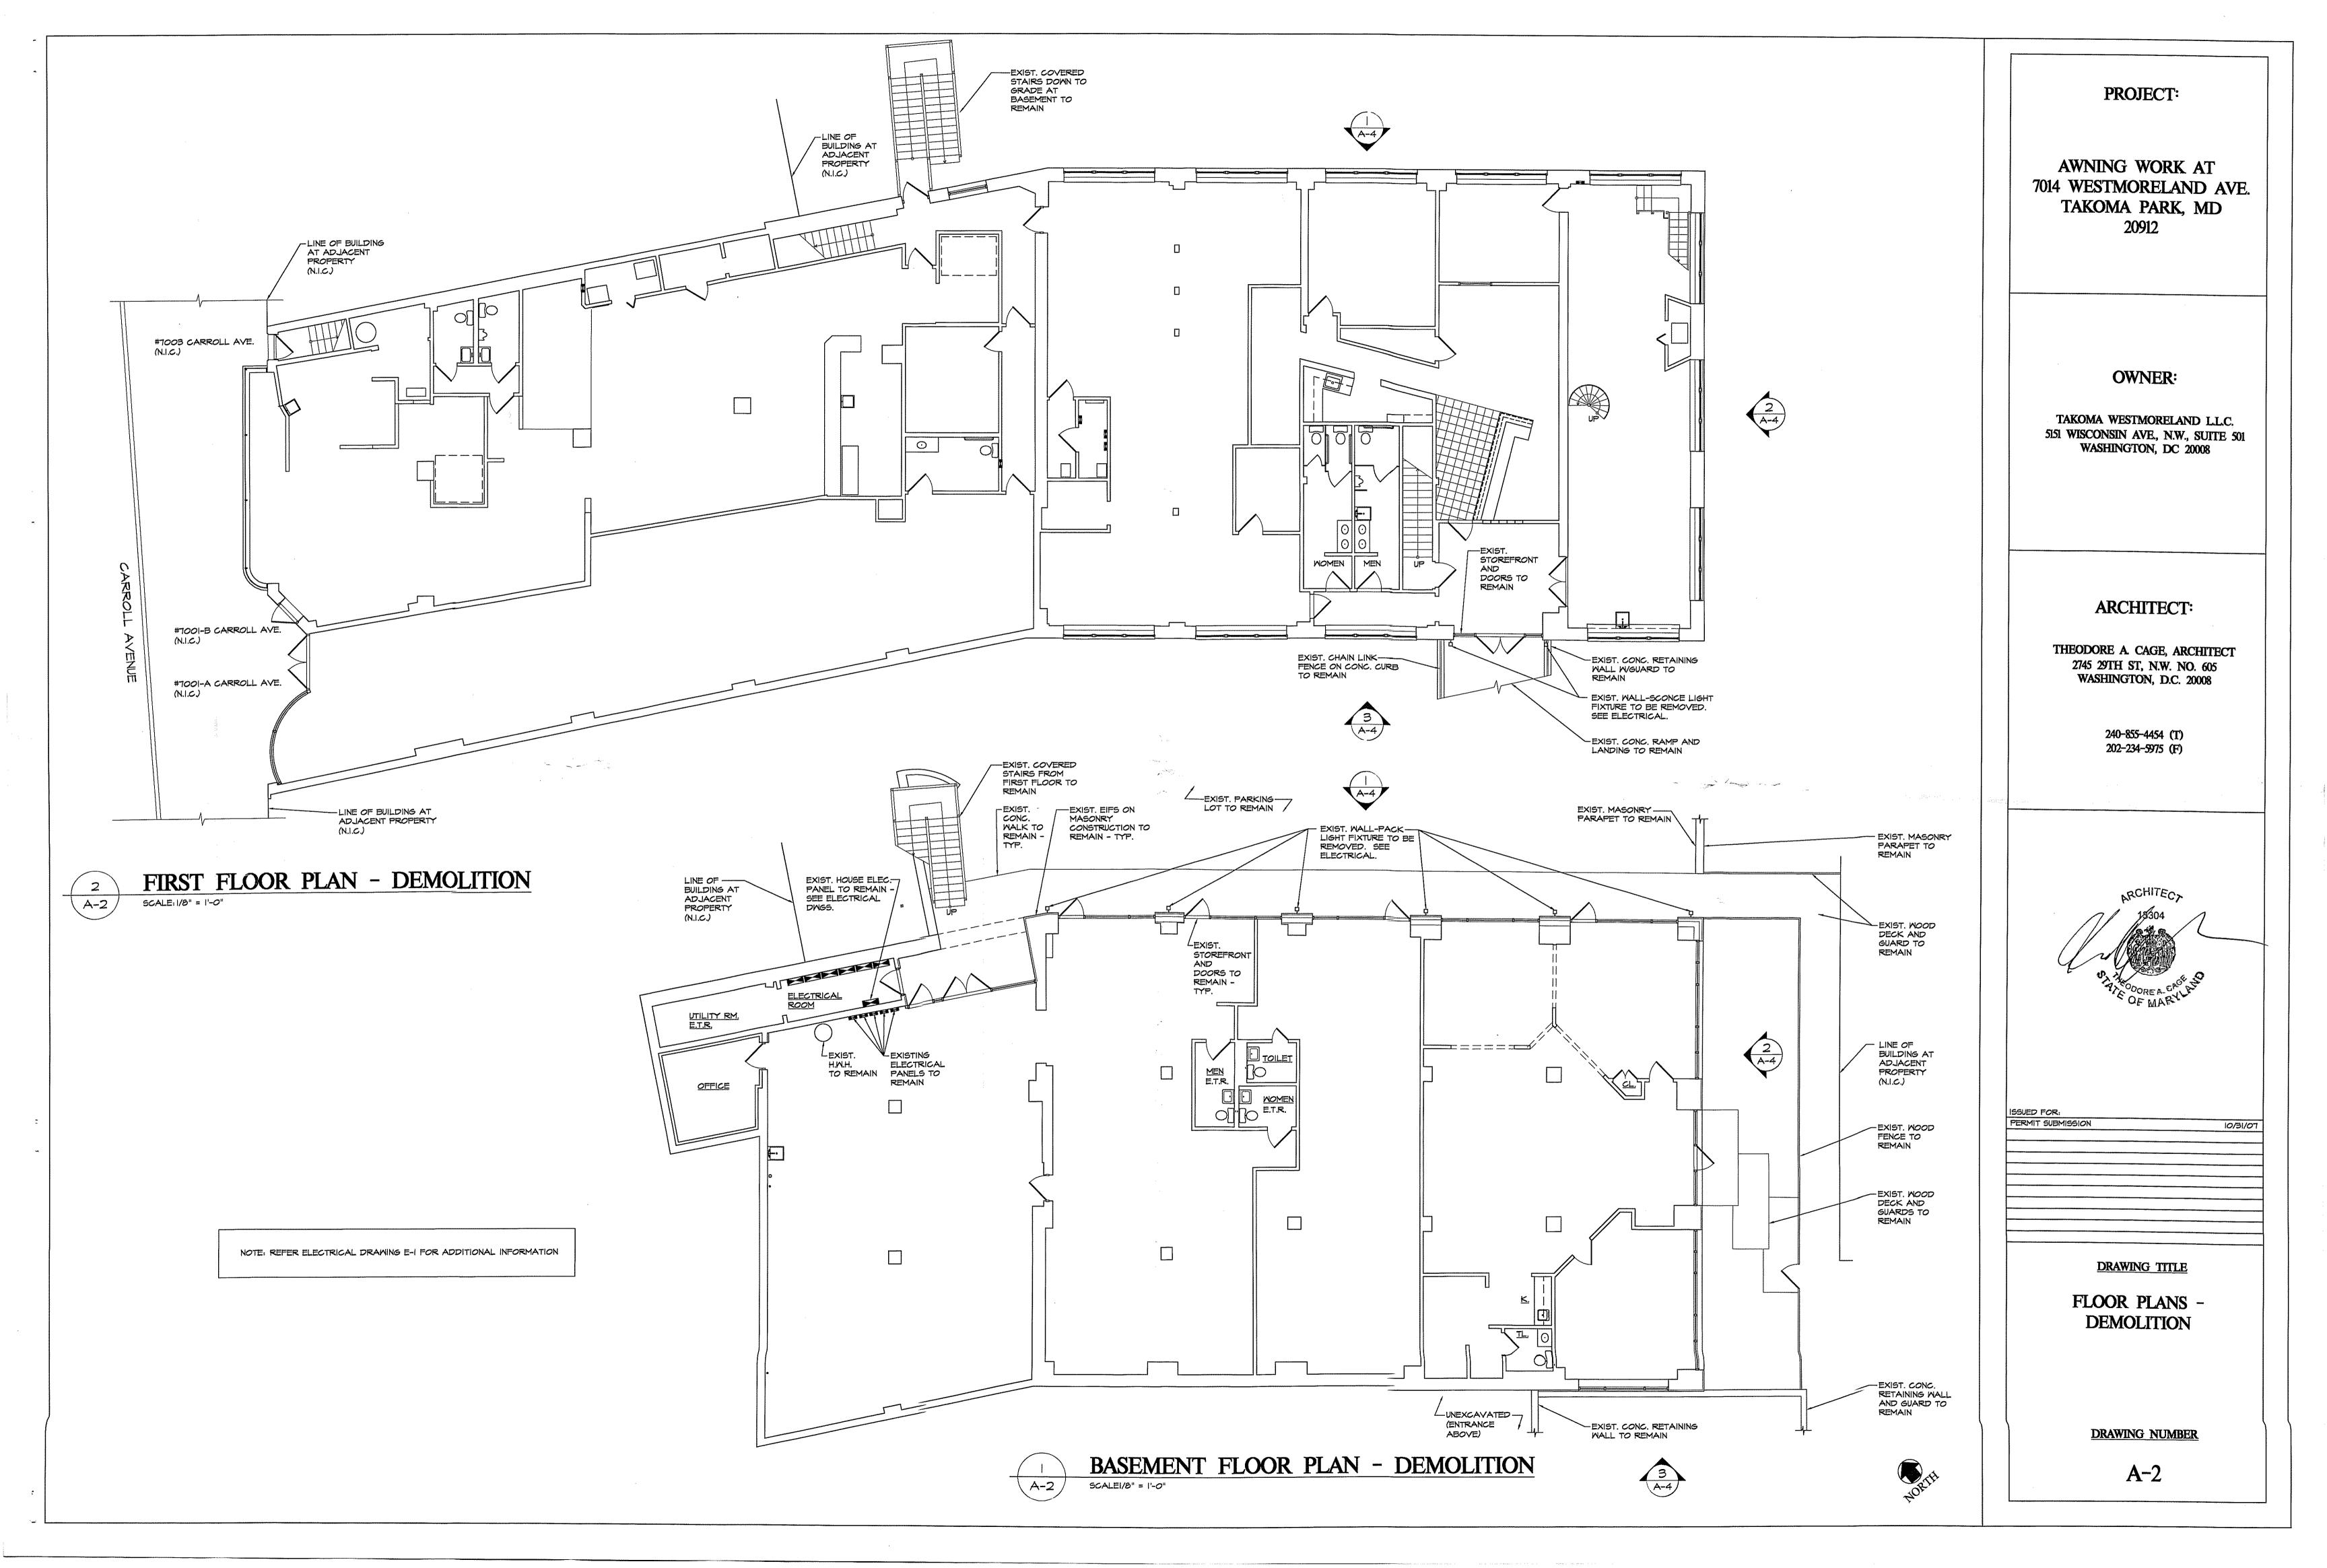
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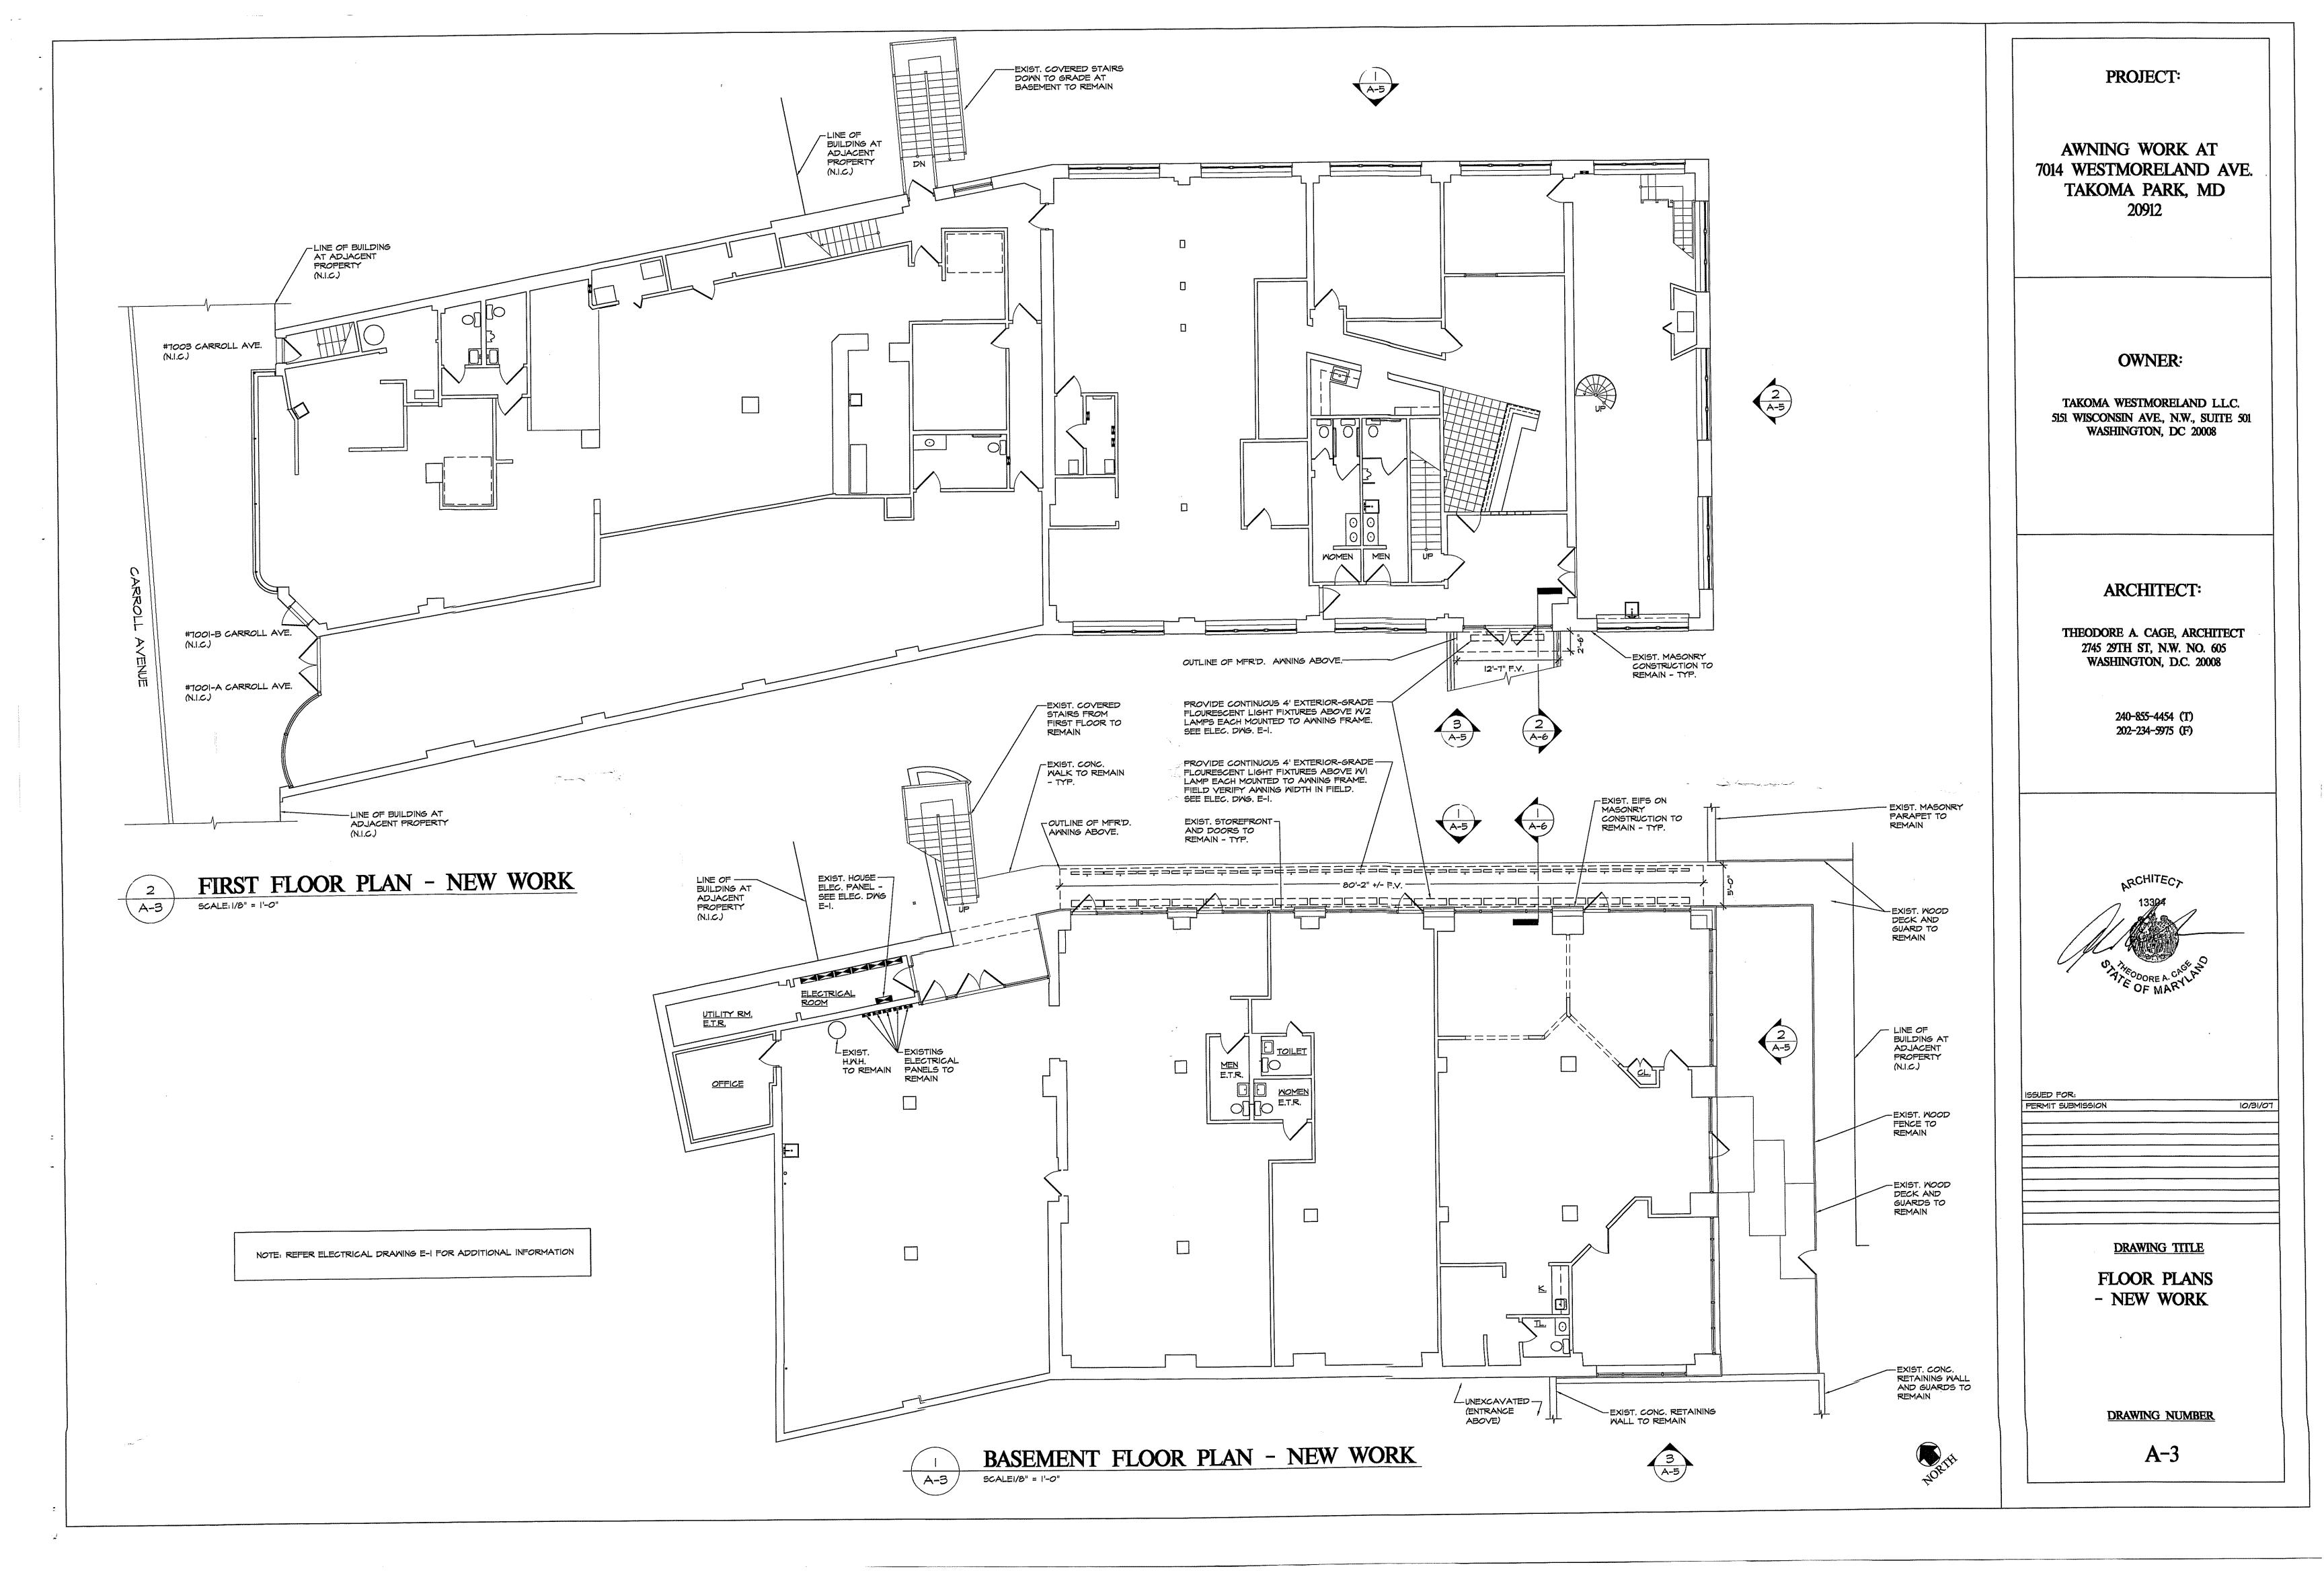
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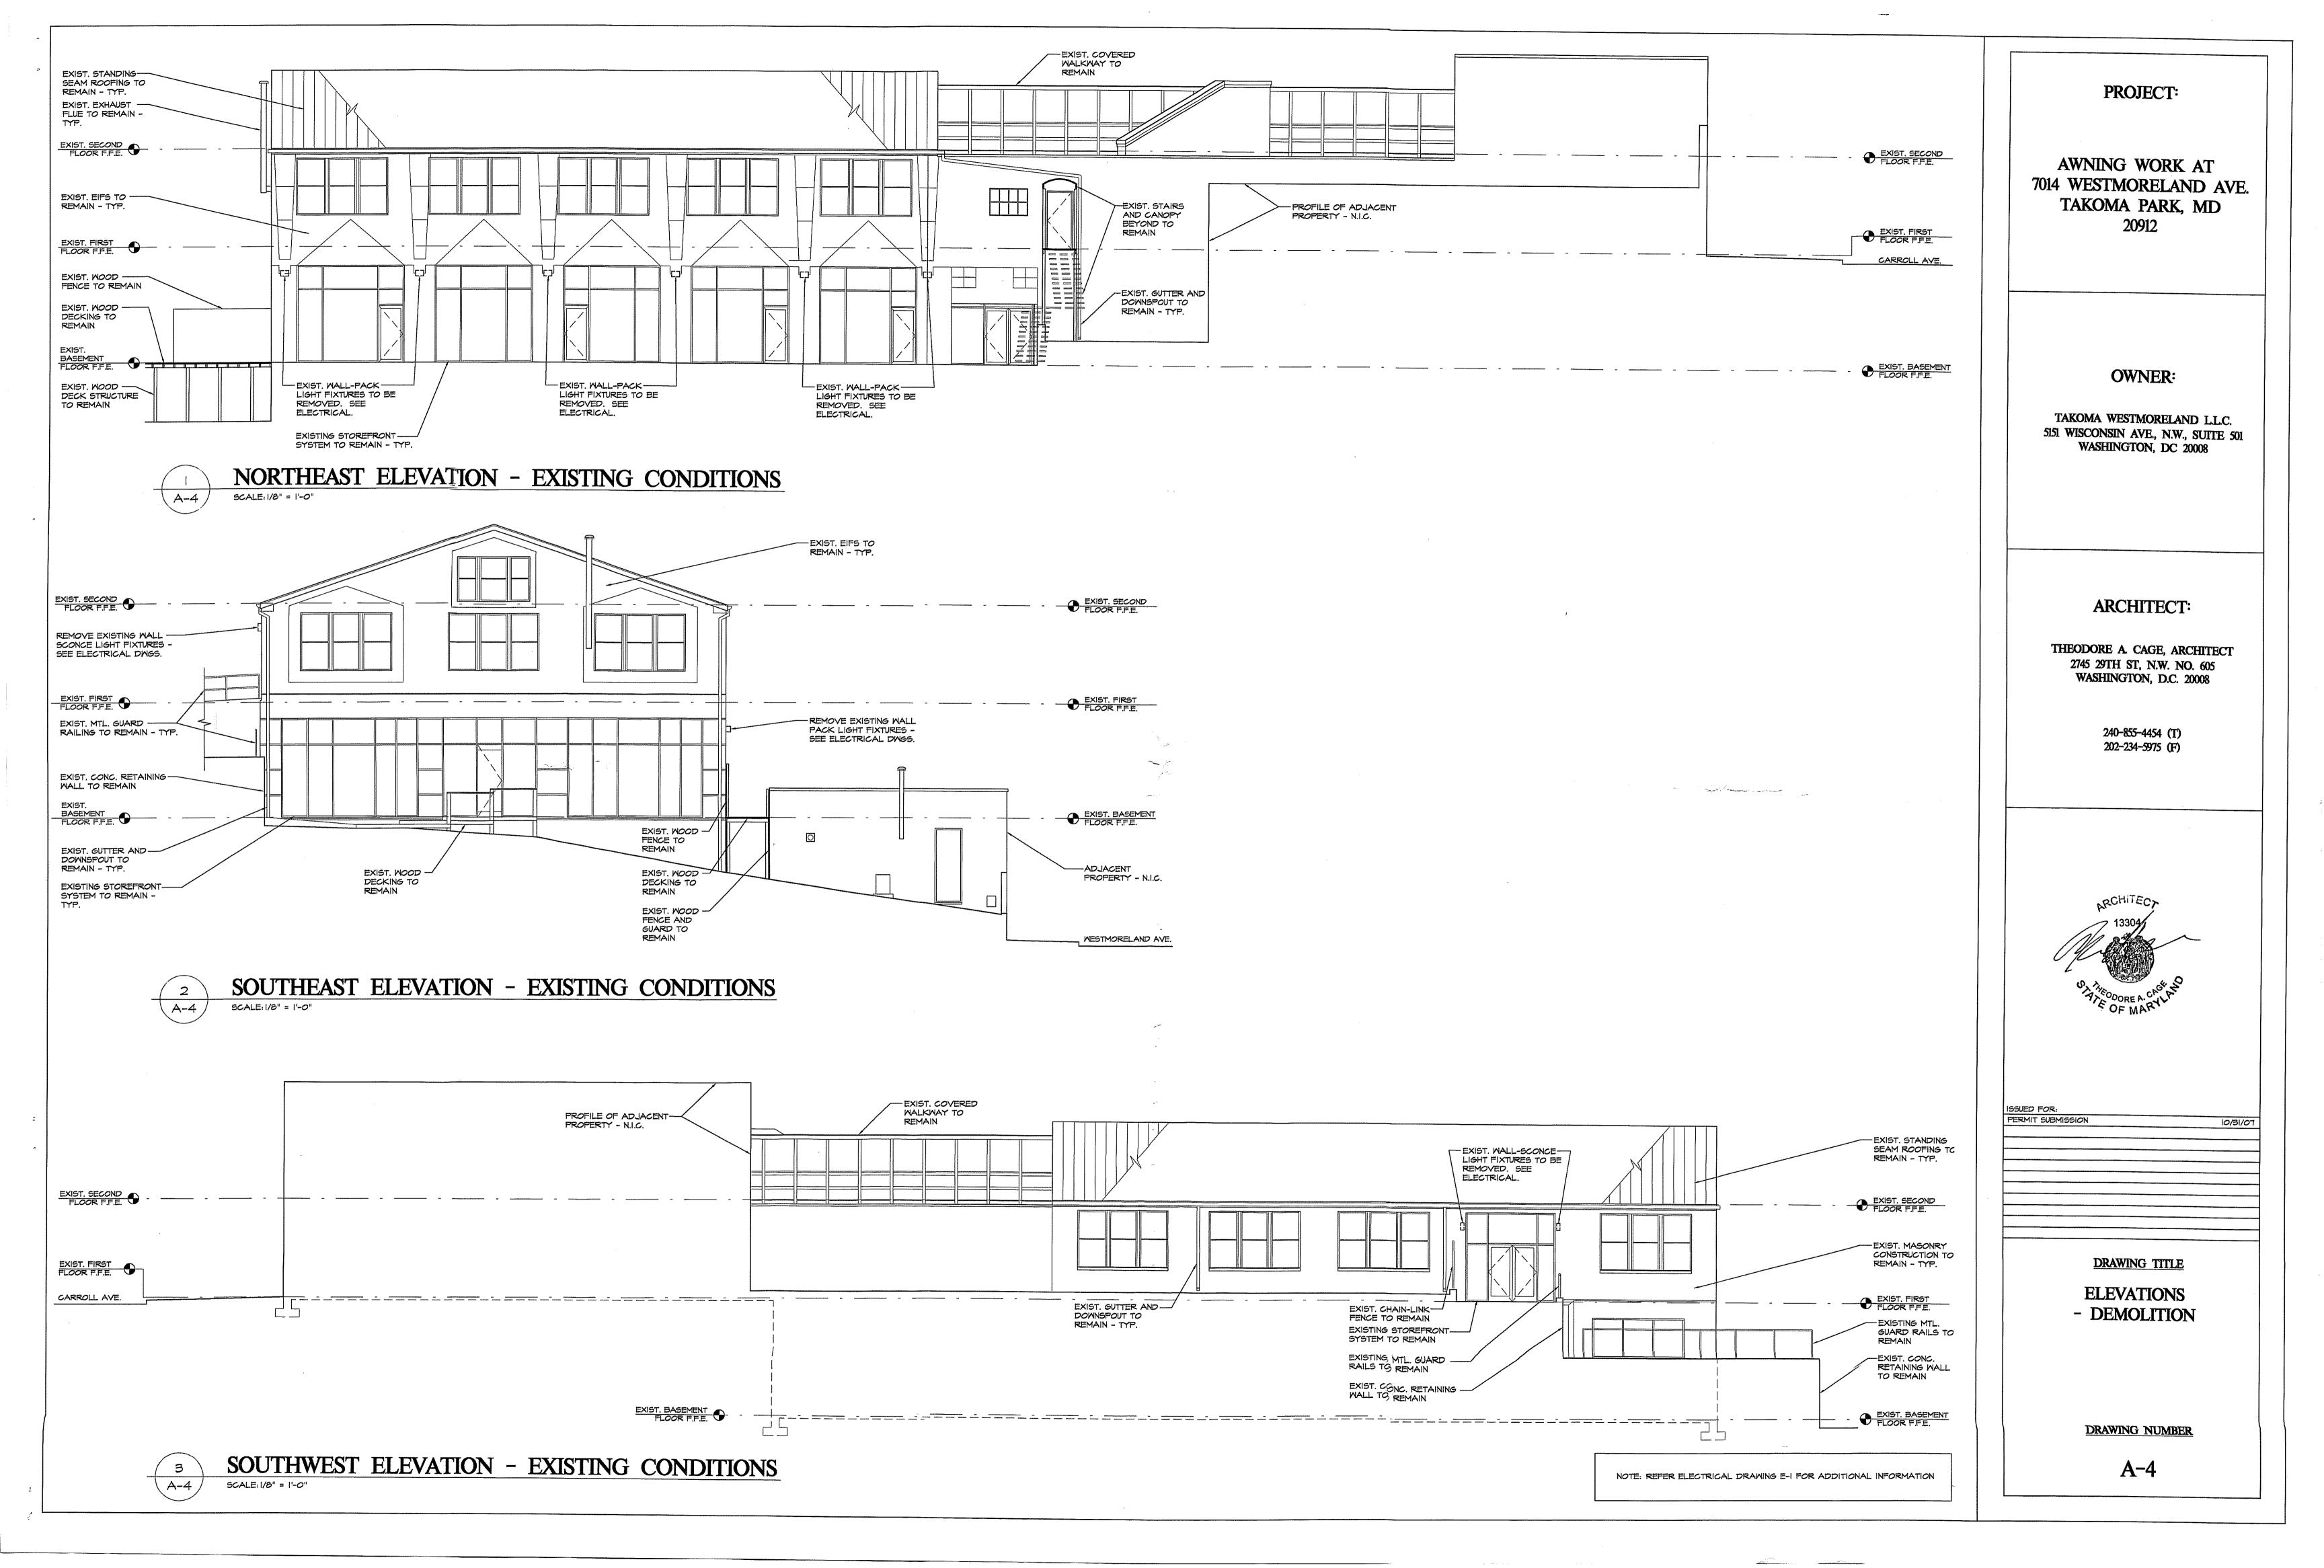
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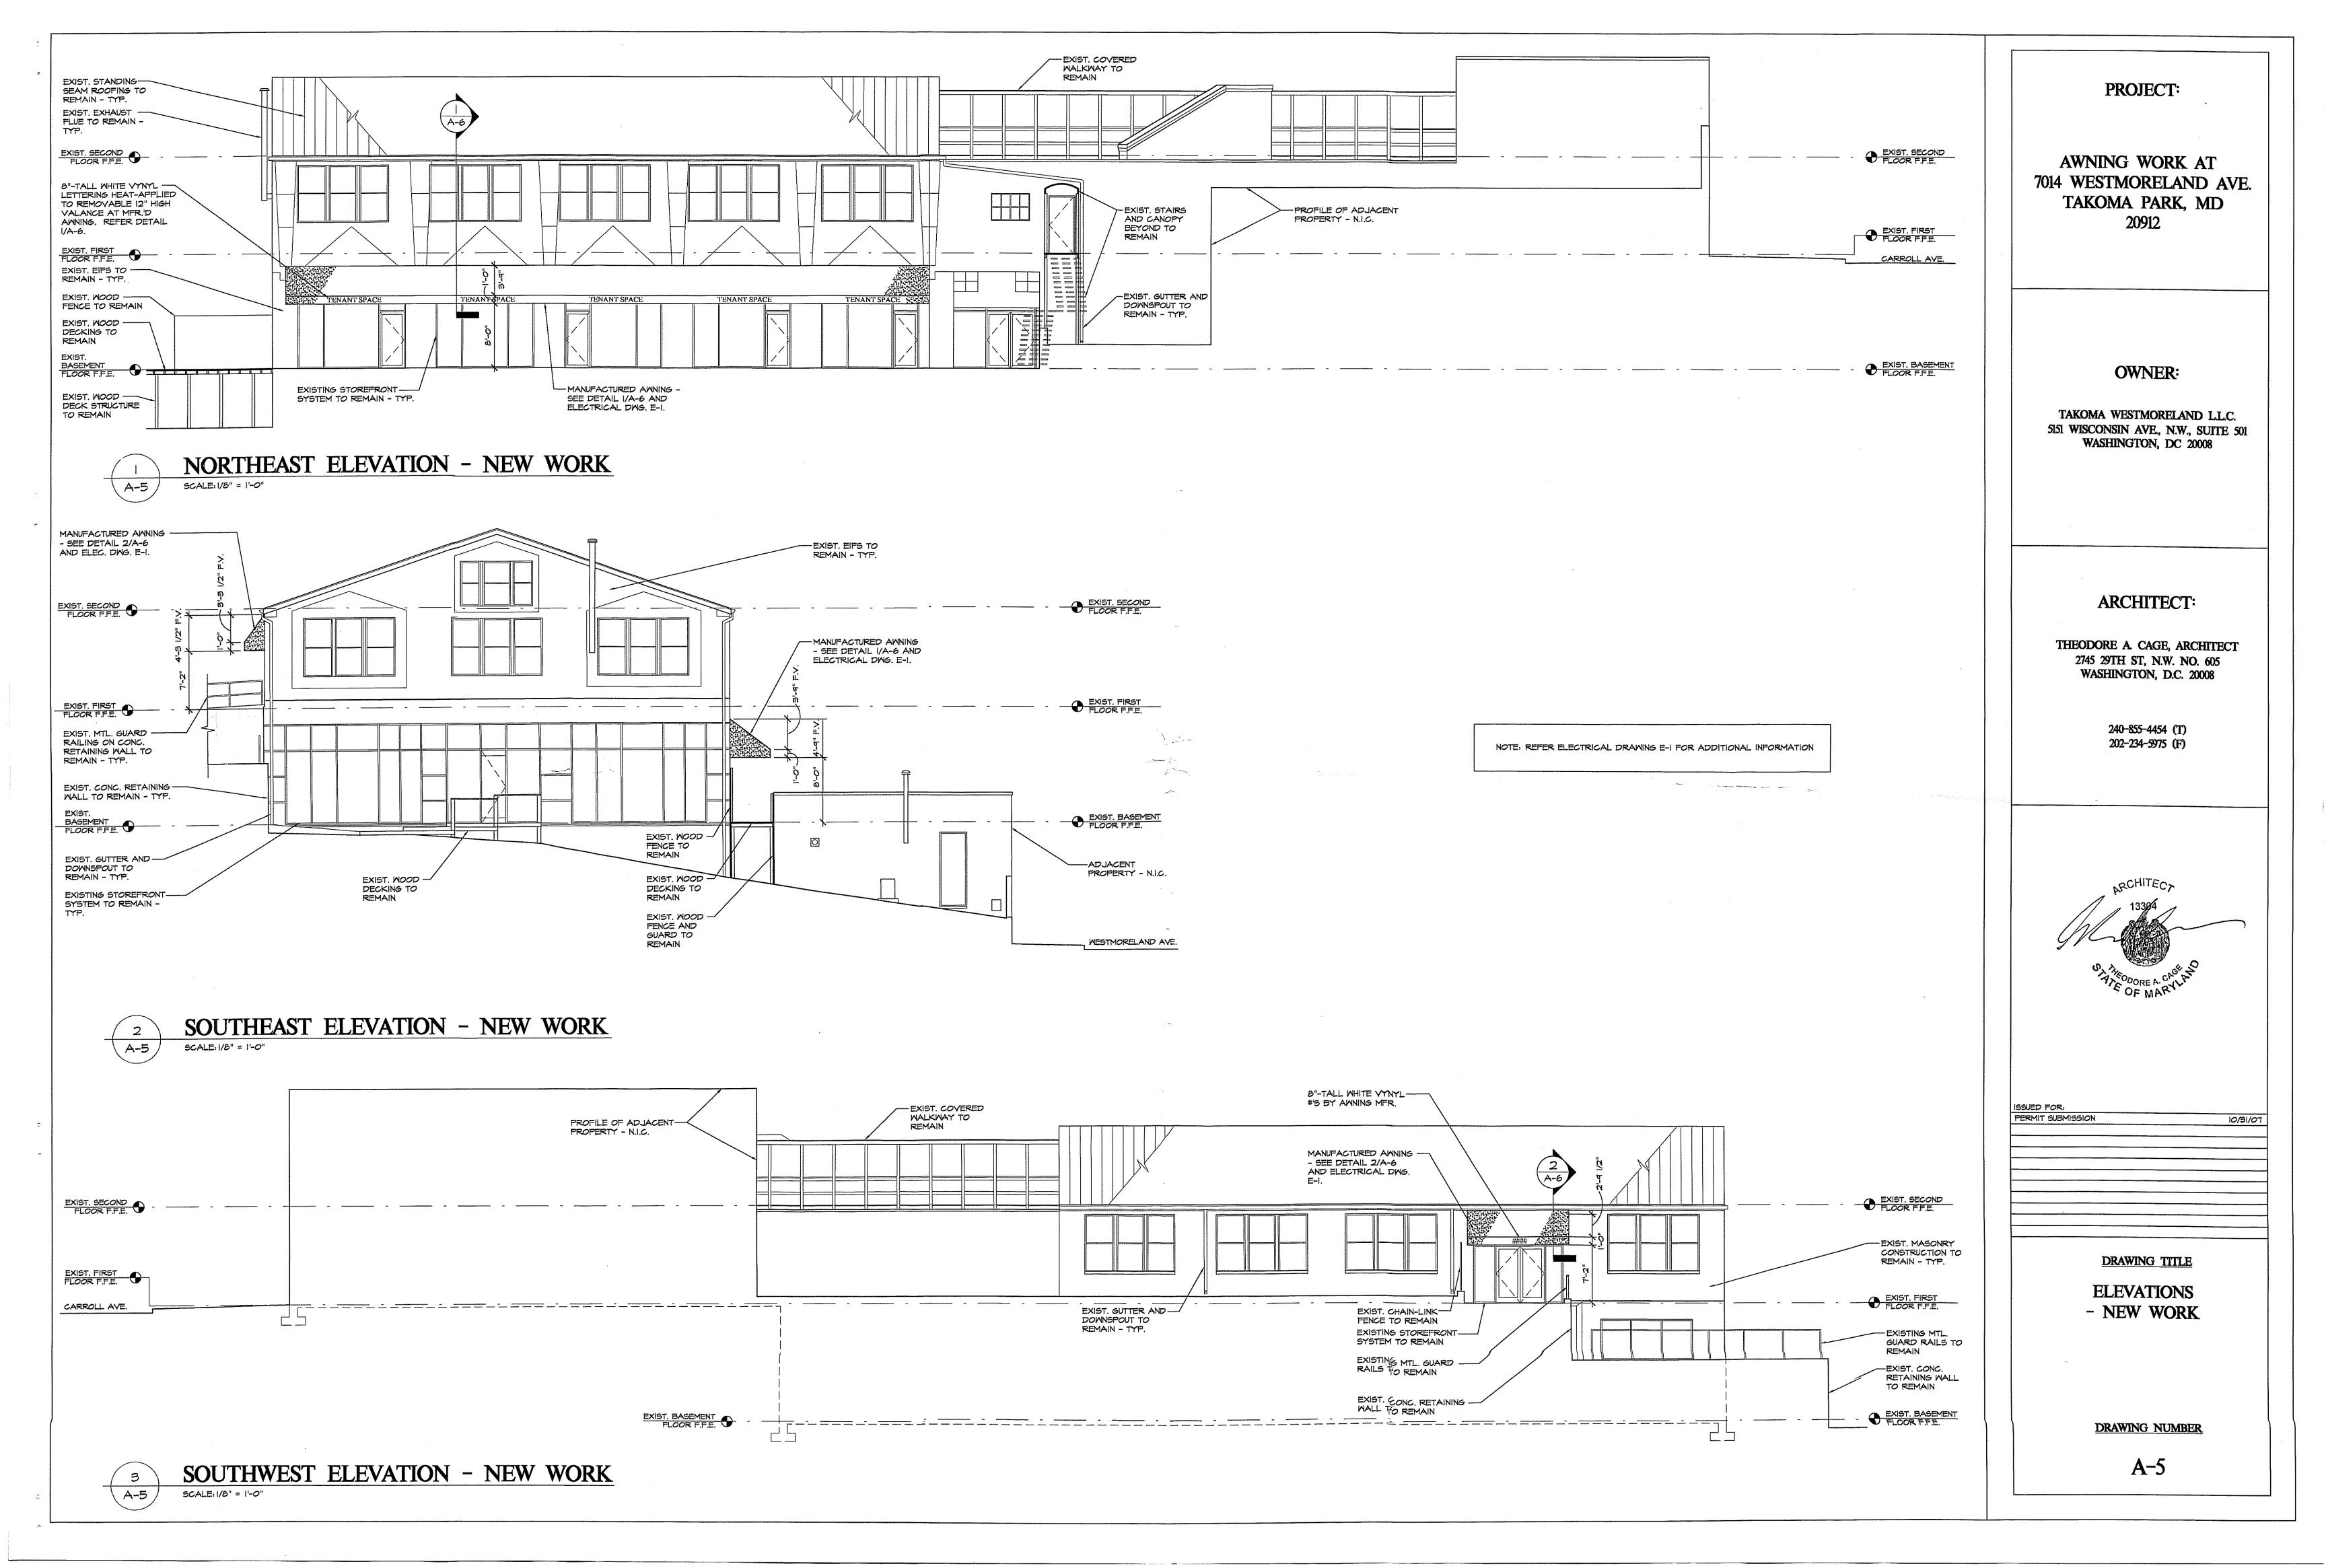
SCOPE NARRATIVE: CODE ANALYSIS: PROJECT: 7014 WESTMORELAND AVE. SCOPE OF WORK INCLUDES INSTALLATION OF MANUFACTURED AWNINGS WITH ALUMINUM FRAMES AND FABRIC COVERINGS AT EXTERIOR OF EXISTING BUILING OVER EXISTING ENTRANCES AT BASEMENT AND FIRST FLOOR ENTRANCES. WORK ALSO INCLUDES REMOVAL OF EXISTING EXTERIOR LIGHT FIXTURES AND FURNISHING AND INSTALLATION OF NEW AWNING-MOUNTED EXTERIOR FLOURESCENT LIGHT FIXTURES. ALL NEW ELECTRICAL FIXTURES TO BE CONNECTED TO EXISTING HOUSE PANEL AT EXISTING ELECTRICAL ROOM CODE ANALYSIS: SEE ARCH. PLANS, ELEVATIONS, SECTIONS, DETAILS AND ELECTRICAL DWG. E-I FOR DETAILED SCOPE INFO. AWNING WORK AT APPLICABLE CODES: 7014 WESTMORELAND AVE. INTERNATIONAL BUILDING CODE 2003 NATIONAL ELECTRICAL CODE 2002 TAKOMA PARK, MD 20912 GENERAL NOTES USE AND OCCUPANCY CLASSIFICATION: EXISTING MIXED UNSEPARATED USE GROUPS M/B/A-2/A-3 (NO CHANGE IN USE) I. ALL WORK IS TO BE DONE IN ACCORDANCE WITH LOCAL CODE REQUIREMENTS. 2. THE PROJECT CONSISTS OF ALL LABOR AND MATERIALS NECESSARY AND INCIDENTAL TO THE DEMOLITION AND CONSTRUCTION SHOWN ON THESE DRAWINGS NOT SPECIFICALLY INDICATED TO BE PERFORMED OR FURNISHED BY OTHERS. (RECORD) \$46'26'12"W (SURVEY) N46'45'56'E TYPE OF CONSTRUCTION: CONSTRUCTION TYPE IIB (EXISTING) 3. THE GENERAL CONTRACTOR SHALL BE COMPLETELY AND SOLELY RESPONSIBLE FOR ALL CONSTRUCTION MEANS, METHODS, TECHNIQUES, SAFETY, SEQUENCE, PROCEDURES AND PRECAUTIONS. GENERAL BUILDING HEIGHTS AND AREAS: 4. UNLESS OTHERWISE INDICATED, DRAWINGS ARE TO SCALE. HOWEVER, IN THE EVENT OF A DISCREPANCY BETWEEN SCALED AND WRITTEN DIMENSIONS, THE WRITTEN DIMENSION SHALL PREVAIL. FOR EXISTING MIXED UNSEPARATED USE GROUPS M/B/A-2/A-3 W/TYPE IIB CONSTRUCTION, UNDER MOST RESTRICTIVE EXISTING USE GROUPS A-2 AND A-3. OWNER: 5. IN THE EVENT OF A DISCREPANCY BETWEEN A LARGE SCALE DETAIL AND A SMALLER SCALE DRAWING, THE DETAIL SHALL GOVERN. (NO CHANGE) 55' HEIGHT ALLOWED, 36'-O" EXISTING (NO CHANGE) 2 STORIES PLUS BASEMENT ALLOWED, 2 STORIES PLUS BASEMENT EXISTING (NO 6. UNLESS OTHERWISE NOTED, ALL PLAN DIMENSIONS ARE TO FINISH WALL SURFACES AT EXISTING CONSTRUCTION, DIMENSIONS IN ELEVATION ARE FINISH TO FINISH. TAKOMA WESTMORELAND LLC. T. THE CONTRACTOR SHALL BE RESPONSIBLE FOR FIELD VERIFICATION OF ALL DIMENSIONS AND EXISTING CONDITIONS APPLICABLE TO THE WORK. IN THE EVENT OF A DISCREPANCY BETWEEN THE CONSTRUCTION DOCUMENTS AND FIELD CONDITIONS, THE CONTRACTOR SHALL NOTIFY THE ARCHITECT IMMEDIATLY AND BEFORE PROCEEDING WITH THE WORK IN QUESTION. CHANGE) 9,500 S.F. PER FLOOR ALLOWED FOR A-2 AND A-3 USE GROUPS, 6,692 S.F. PER 5151 WISCONSIN AVE., N.W., SUITE 501 FLOOR EXISTING (NO CHANGE) WASHINGTON, DC 20008 8. ALL MATERIALS SHALL BE NEW UNLESS SPECIFICALLY OTHERWISE NOTED. SPRINKLERS: 9. UNLESS SHOWN OR SPECIFIED TO THE CONTRARY, ALL NEW CONSTRUCTION SHALL MATCH EXISTING ADJACENT CONSTRUCTION AS CLOSELY AS POSSIBLE IN TERMS OF COLOR, FINSH, TEXTURE AND GENERAL UNSPRINKLERED (NO CHANGE); SPRINKLERS NOT REQUIRED PER MIXED UNSEPARATED ALLOWANCES IO. THE CONTRACTOR SHALL BE RESPONSIBLE FOR PATCHING AND REPAIRING ANY SURFACES OR MATERIALS DAMAGED DURING DEMOLITION AND CONSTRUCTION ACTIVITIES, REGARDLESS OF WHETHER OR NOT THIS WORK IS INDICATED IN THE CONSTRUCTION DOCUMENTS. II. IF TRADESMEN OR REPRESENTATIVE CUTS, DRILLS, OR WEAKENS THE STRUCTURAL SYSTEM DURING CONSTRUCTION, IMMEDIATE REPLACEMENT (OF IMPROVED STRENGTH) IS TO BE PROVIDED. 7005 -40001-LIMITED FARTNERSHIP L 5786 F. 117 PART OF LOT 14 13. ALL CONSTRUCTION DEBRIS TO BE REMOVED FROM THE JOB SITE AND LEGALLY DISCARDED. ARCHITECT: 16,620 S.F OR 0.3815 ACRES PROPOSED MFR'D. AWNING THEODORE A. CAGE, ARCHITECT PROPOSED MFR'D. -AMNING 2745 29TH ST, N.W. NO. 605 WASHINGTON, D.C. 20008 EXIST, ENTRANCE IST FLR. F.F.=277.72 - EXIST. ENTRANCE BASEMENT MULTI-STORY BLOCK EUILDING AREA=10,319 S.F. EXIST, GRADE -240-855-4454 (T) AT EXIST. IST FLR. - EXIST. GRADE AT EXIST. BASEMENT LEVEL 7001 CARROL 202-234-5975 (F) LIMITED PARTNERSHIP AREA OF 2,693 S.F OR 0.0618 ACRES SPEED HUMP WOR 7010 WESTWORELAND AVENUE 7001 CARROL LIMITED PARTNERSHIP L. 5766 F. 117 PART OF LOT 13 50 S.F OR 0.0080 ACRES WOOD RETAINING WALL REBAR WITH-CAP FOUND 7001 CARROL LIMITED PARTNERSHIP L. 5166 F. 117 PART OF LOT 12 4,396 S.F OR 0.1009 ACRES (#187) EASTERN ISSUED FOR: PERMIT SUBMISSION PARCEL VI 7001 CARROL LIMITED PARTINERSHIP L. 5792 F. 416 TOP OF LOT 13 AND 14 5,175 S.F OR 0.1188 ACRES AVEN FACE OF CONCRETE RETAINING WALL STONE WALLS-(RECORD) S51*15'DD"W 70.00' TO SERVE ADJACENT PROPERTY (RECORD) N50'49'D8"E TO THE SOUTH 1" OPEN N/F MERCY C.SANDOVAL L. 14249 F. 346 PART OF LOT 39 1" OPEN PIPE FOUND PIPE FOUND (HELD FOR POSITION) FORMERLY LOT 15 P.B. A P. 49 DRAWING TITLE SITE PLAN **DRAWING NUMBER** SITE PLAN - EXISTING CONDITIONS AND AREAS OF NEW WORK NOTE: REFER DEMOLITION AND NEW WORK PLANS, DEMOLITION AND NEW WORK ELEVATIONS, AWNING DETAILS, AND ELECTRICAL DRAWING E-I FOR ADDITIONAL INFORMATION **A-1** SCALE: |" = 20"

10/31/07












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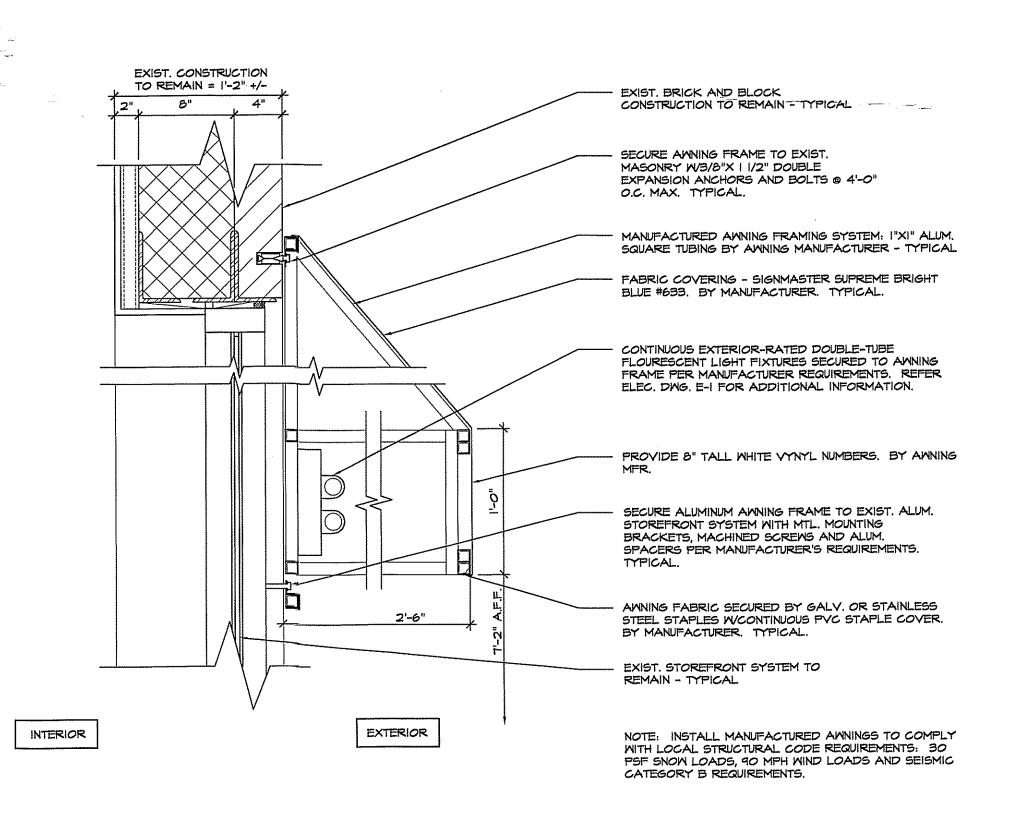
PLAN VIEW

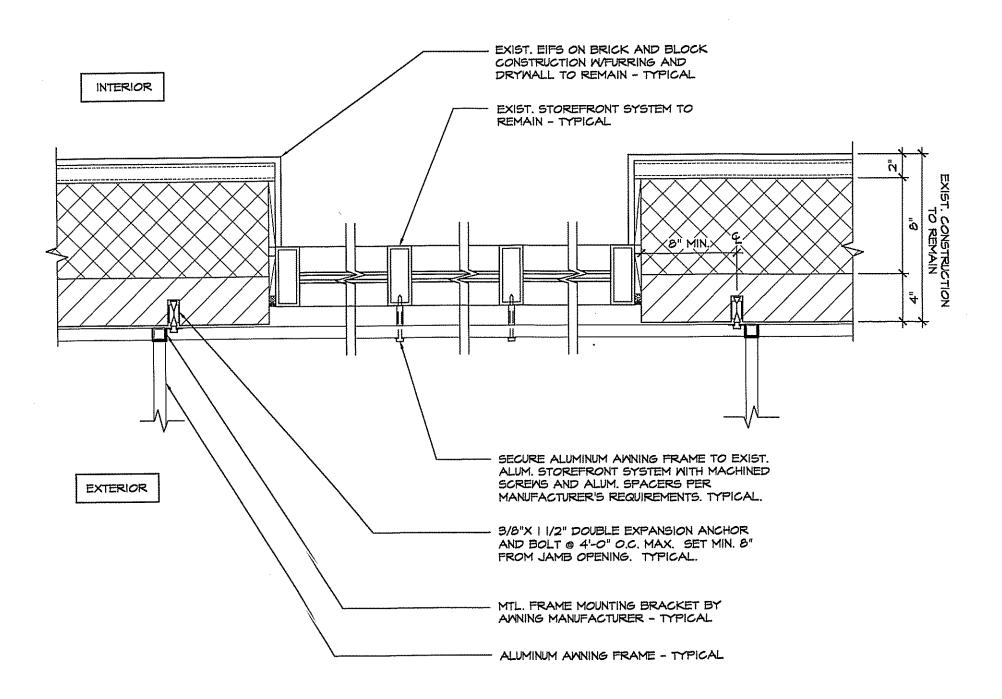



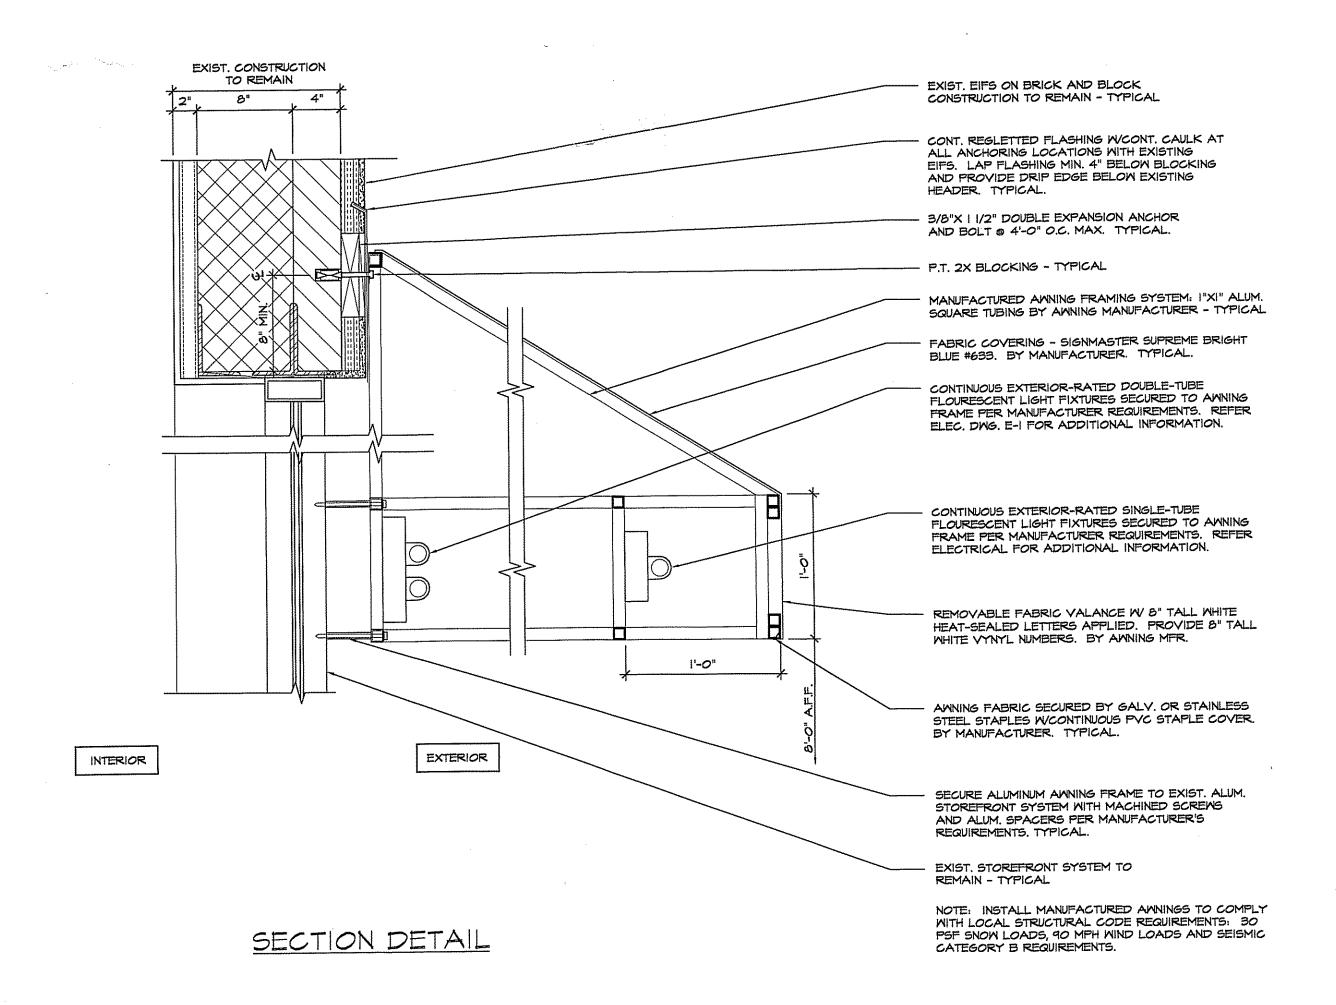

PLAN VIEW

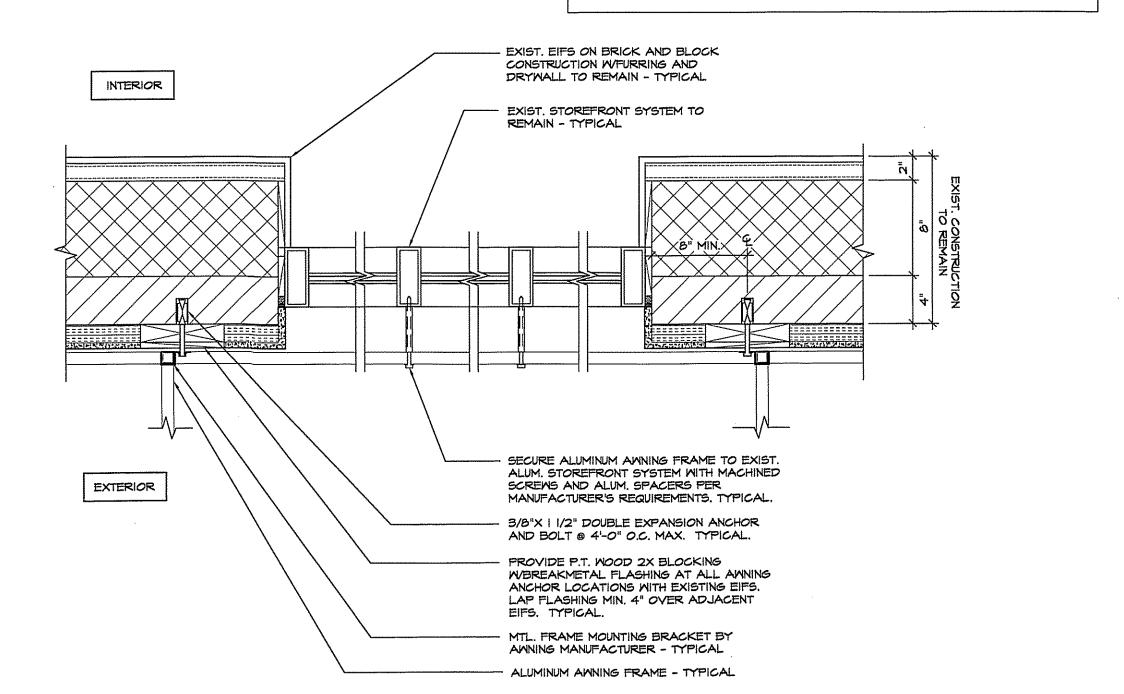

SECTION DETAIL



PROJECT:

AWNING WORK AT 7014 WESTMORELAND AVE. TAKOMA PARK, MD 20912

OWNER:

TAKOMA WESTMORELAND L.L.C. 5151 WISCONSIN AVE., N.W., SUITE 501 WASHINGTON, DC 20008

ARCHITECT:

THEODORE A. CAGE, ARCHITECT 2745 29TH ST, N.W. NO. 605 WASHINGTON, D.C. 20008

> 240-855-4454 (T) 202-234-5975 (F)



MIT SUBMISSION	10/31/07

DRAWING TITLE

ELEVATIONS
- NEW WORK

DRAWING NUMBER

A-6

GENERAL NOTES

- G1. THE SCOPE OF WORK CONSISTS OF THE FURNISHING AND INSTALLING OF A COMPLETE ELECTRICAL SYSTEM AS INDICATED ON THE DRAWINGS AND SPECIFIED HEREIN. THE CONTRACTOR SHALL PROVIDE ALL SUPERVISION, LABOR, MATERIALS, EQUIPMENT, MACHINERY, AND ALL OTHER ITEMS NECESSARY TO COMPLETE THE SYSTEM. THE CONTRACTOR SHALL PROVIDE AND INSTALL ALL EQUIPMENT AS INDICATED ON THE DRAWINGS AND/OR AS REQUIRED FOR A FUNCTIONING ELECTRICAL SYSTEM.
- G2. THE ELECTRICAL BUILD CONTRACTOR SHALL EXAMINE THE DRAWINGS, SPECIFICATIONS AND JOB SITE AND FULLY INFORM HIMSELF OF ALL EXISTING CONDITIONS AND WORK REQUIRED BY THE DRAWINGS AND SPECIFICATIONS.
- G3. THE ENTIRE ELECTRICAL INSTALLATION SHALL CONFORM TO THE 2002 EDITION OF THE NATIONAL ELECTRICAL CODE, LOCAL JURISDICTION REQUIREMENTS. AND LOCAL STATE CODE REQUIREMENTS.
- G4. ALL ELECTRICAL EQUIPMENT SHALL BEAR THE UNDERWRITER'S LABORATORIES LABEL PRIOR TO THE PURCHASE OF EQUIPMENT AND
- SUBMIT TO THE ARCHITECT FOR APPROVAL, SIX COPIES OF SHOP DRAWINGS/PRODUCT DATA FOR THE FOLLOWING ITEMS:

A. WIRING DEVICES DISCONNECT SWITCHES C. PANELBOARDS

WIRE/CABLE F. WIRES

- ELECTRICAL CONTRACTOR SHALL OBTAIN AND PAY FOR ALL PERMITS REQUIRED FOR ELECTRICAL WORK.
- PROVIDE TEMPORARY SERVICE AS NECESSARY FOR LIGHTING AND POWER EQUIPMENT (DRILLS, SAWS, ETC.). VERIFY TEMPORARY REQUIREMENTS WITH GENERAL CONTRACTOR. TEMPORARY LIGHTING AND POWER SHALL MEET OSHA REQUIREMENTS AND LOCAL CODES. TEMPORARY POWER SHALL BE DIRECTED BY COORDINATED WITH THE APARTMENT OFFICE MANAGER OR OWNER,
- ADVANCE NOTICE SHALL BE GIVEN TO THE OWNER BEFORE COMMENCEMENT OF WORK, WHETHER OR NOT AN OUTAGE IS REQUIRED.
- ALL CIRCUITRY, EQUIPMENT, DEVICES, ETC., SHALL BE NEW UNLESS SPECIFICALLY NOTED ON THE PLANS.
- ALL WORK SHALL BE PERFORMED DURING NORMAL WORKING HOURS, MONDAY THROUGH FRIDAY (7 AM TO 5 PM). IF WORK CANNOT BE PERFORMED DURING NORMAL WORKING HOURS THE OWNER SHALL BE NOTIFIED PRIOR TO THE SIGNING OF THE CONTRACT.
- THE ELECTRICAL CONTRACTOR SHALL PERFORM ALL CUTTING AND PATCHING NECESSARY FOR THE SYSTEMS AND EQUIPMENT INSTALLATION. PATCHING SHALL BE UNIFORM IN APPEARANCE AND SHALL MATCH THE SURROUNDING SURFACES.
- G12. THE ELECTRICAL CONTRACTOR SHALL MAINTAIN ACCURATE RECORD DRAWINGS OF ALL WORK AS ACTUALLY INSTALLED. ON COMPLETION OF THE PROJECT TWO (2) COMPLETE SETS OF REPRODUCIBLE DRAWINGS SHALL BE DELIVERED TO THE OWNER AND ONE (1) SET OF DRAWING TO THE A/E FIRM.
- G13. FINAL TESTING: AT THE TIME OF FINAL INSPECTION AND TEST, ALL CONNECTIONS AT PANELBOARDS, DEVICES AND EQUIPMENT, AND ALL SPLICES MUST BE COMPLETED. EACH BRANCH CIRCUIT AND ITS RESPECTIVE CONNECTED EQUIPMENT MUST TEST FREE OF SHORT CIRCUITS. UPON COMPLETION OF THE WORK, CLEAN AND POLISH ALL EXPOSED SURFACES IN ACCORDANCE WITH THE MANUFACTURER'S RECOMMENDATIONS.
- G14. ALL WIRING SHALL BE INSTALLED IN CONCEALED. COORDINATE WITH THE GENERAL CONTRACTOR ON CHANNELING LOCATION ON FINISH AREA NOT AFFECTED BY RENOVATION.

DEMOLITION

- REQUIRED DEMOLITION WORK SHALL NOT BE LIMITED TO THAT PORTION SHOWN ON PLANS ALONE, BUT SHALL INCLUDE ALL NECESSARY WORK TO BE OBTAINED BY THIS CONTRACTOR AFTER VISITING THE SITE PRIOR TO COMMENCE WORK. CONTRACTOR SHALL GATHER ALL THE INFORMATION AND COORDINATE WITH THE NEW OR MODIFIED WORK AS INDICATED ON THE DRAWINGS. ANY MAJOR DISCREPANCIES FOUND ON THE DRAWINGS AND SPECIFICATIONS SHALL BE BROUGHT TO THE ENGINEERS ATTENTION IN WRITING.
- THE SCHEDULING OF DEMOLITION WORK SHALL BE COORDINATED BY THIS CONTRACTOR WITH THE OWNER'S REPRESENTATIVE PRIOR TO PERFORMING THE WORK.
- CONTRACTOR SHALL VISIT JOB SITE TO ASCERTAIN CONDITIONS WHICH MAY AFFECT HIS WORK, AND HE SHALL BE RESPONSIBLE FOR THE INCLUSION OF ALL REQUIRED DEMOLITION IN AREAS UNDERGOING MODIFICATION WHETHER OR NOT SUCH WORK IS INDICATED ON PLANS OR NOTES.
- CONTRACTOR SHALL EXAMINE ARCHITECTURAL DRAWINGS FOR ADDITIONAL DEMOLITION NOTES.
- CONTRACTOR SHALL REMOVE ALL EXISTING OUTDOOR WALL LIGHTING FIXTURES AS INDICATED ON THE ARCHITECTURAL DRAWINGS. UTILIZE EXISTING BRANCH CIRCUITS TO ACCOMMODATE POWER TO NEW LIGHTING FIXTURES. PROVIDE COVERS FOR ALL EXISTING JUNCTION BOXES.

CONTRACTOR SHALL COORDINATE THE FOLLOWING WORK:

A. LOCATION OF EXISTING LIGHT FIXTURES AT THE FIELD. THE FINAL WORK SHALL COMPLY WITH THE INTENT AS SHOWN ON THE DRAWINGS.

ELECTRICAL WORK:

- CONTRACTOR SHALL CLEAN THE PROJECT SITE AT THE END OF EACH WORKING DAY. AFTER REMOVAL OF ALL DEVICES CONTRACTOR SHALL TURN ALL DEVICES OVER TO OWNER'S REPRESENTATIVE FOR HIM TO INSPECT. AFTER INSPECTED BY THE OWNER'S REPRESENTATIVE CONTRACTOR SHALL REMOVE ALL UNNECESSARY DEVICES OR MATERIALS
- CONTRACTOR SHALL RESTORE ALL AREAS AND SYSTEMS AND ASSOCIATED DEVICES, COMPONENTS, ETC., DISTURBED BY HIS WORK TO THE SATISFACTION OF THE OWNER, ARCHITECTS, AND ENGINEERS.

THE CONTRACTOR SHALL MAKE A CAREFUL INSPECTION AT ALL OF THE EXISTING ELECTRICAL POWER AND SYSTEMS PRIOR TO THE MODIFICATION OF THE EXISTING SPACE. PHYSICALLY VERIFY ALL EXISTING BRANCH CIRCUITS AND COORDINATE PANELBOARD OVERCURRENT PROTECTION DEVICE, SIZE AND LOCATION.

PROVIDE A WRITTEN CIRCUIT DIRECTORY FOR EACH NEW CONNECTION TO THE EXISTING PANELBOARD AFFECTED BY HIS WORK.

GROUNDING AND BONDING

1. ALL REQUIRED GROUNDING SHALL BE IN ACCORDANCE WITH NEC.

ELECTRICAL IDENTIFICATION

- COLOR-CODING CONDUCTOR TAPE: COLORED, SELF-ADHESIVE VINYL TAPE NOT LESS THAN 3 MILS THICK BY 1 TO 2 INCHES WIDE.
- EQUIPMENT IDENTIFICATION LABELS SHALL BE ENGRAVED, LAMINATED ACRYLIC OR MELAMINE LABEL: PUNCHED OR DRILLED FOR SCREW MOUNTING. WHITE LETTERS ON A DARK-GRAY BACKGROUND. MINIMUM LETTER HEIGHT SHALL BE 3/8 INCH.

CONDUCTORS AND CABLE

- ALL CONDUCTORS SHALL BE SOFT DRAWN COPPER WIRE HAVING A CONDUCTIVITY OF NOT LESS THAN 98% OF THAT OF PURE COPPER WITH A 600 VOLT RATING. WIRE #10 AND SMALLER SHALL BE SOLID, AND LARGER THAN #10 SHALL BE STRANDED. ALUMINUM CONDUCTORS ARE NOT ACCEPTABLE.
- BRANCH CIRCUITS SHALL BE TYPE THHN OR THWN.
- CONNECTORS SHALL BE FACTORY-FABRICATED AND SPLICES SHALL BE OF SIZE, AMPACITY RATING, MATERIAL, TYPE, AND CLASS FOR APPLICATION AND SERVICE INDICATED.
- 4. IN AREAS NOT SUBJECTED TO DAMAGE AND PERMITTED BY NEC, FOR BRANCH CIRCUITS, METAL CLAD BX (ARMORED CABLE) CABLE MAY BE USED SUBJECT TO APPROVAL BY THE AUTHORITY HAVING JURISDICTION.

RACEWAYS AND BOXES

- 1. ELECTRICAL METALLIC TUBING (EMT): MINIMUM SIZE SHALL BE 3/4", UON.
- 2. FITTINGS SHALL BE PER UL 514B AND COMPATIBLE WITH TYPE OF CONDUIT AND TUBING USED.
- FLEXIBLE METAL CONDUIT SHALL BE GALVANIZED STEEL. FLEXIBLE CONDUIT LOCATED AT WET LOCATIONS SHALL BE THE LIQUID-TIGHT TYPE. MAXIMUM 6' OF LIQUID-TIGHT FLEXIBLE CONDUIT SHALL BE USED FOR THE CONNECTION OF ALL MOTORS AND VIBRATING EQUIPMENT. THE FLEXIBLE METAL CONDUIT SHALL BE THE TYPE APPROVED FOR CONTINUOUS GROUNDING.
- JUNCTION AND PULL BOXES SHALL HAVE SUFFICIENT VOLUME TO ACCOMMODATE THE NUMBER OF CONDUCTORS ENTERING THE BOX IN ACCORDANCE WITH THE REQUIREMENTS OF NFPA 70, ARTICLE 370. PULL AND JUNCTION BOXES SHALL BE FURNISHED WITH SCREW FASTENED COVERS.
- ALL PENETRATIONS OF FLOOR AND WALL SHALL BE FIRE STOPPED IN ACCORDANCE WITH INTERNATIONAL BUILDING CODES, NEC, AND NFPA.

WIRING CONCEALED IN WALL OR CEILINGS.

FLURESCENT FIXTURE, PROGRESS # 1x4 232T8 F LAMP SURFACE MOUNTED 120V

FLURESCENT FIXTURE, PROGRESS # 1x4 131T8 F LAMP SURFACE MOUNTED 120V

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HOMERUN TO HOUSE PANELBOARD

SYMBOLS LIST


NOTES: ALL FIXTURES SHALL BE COORDINATED W/ARCHITECT PRIOR TO PURCHASE AND INSTALLATION.

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1ST FLOOR PLAN SCALE: 1/8" = 1'-0"

DRAWING NOTES

(1) CONNECT TO EXISTING HOUSE PANEL WITH 2#12+1#12G, 3/4"CONDUIT VIA EXISTING TIME SWITCH AND NEW PHOTOCELL. UTILIZE EXISTING 20A/1P CIRCUIT BREAKER WHICH BECOME SPARE AFTER DEMOLITION OF EXISTING LIGHTING SYSTEM IN THE AREA. IN ANY CASE, NEW CIRCUIT WHERE ADDED UNDER THIS RENOVATION, CONTRACTOR WILL PROVIDE NEW 20A/1P CIRCUIT BREAKER UTILIZING AVAILABLE SPACES OR PROVISION. CIRCUIT BREAKER SHALL MATCH EXISTING PANELBOARD BRAND & TYPE.

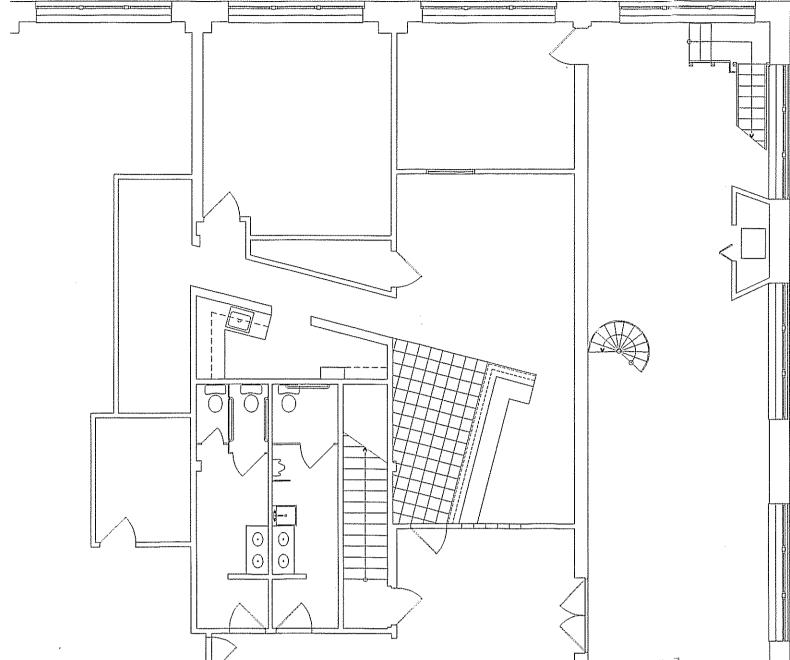

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PROJECT:

AWNING WORK AT

7014 WESTMORELAND AVE. TAKOMA PARK, MD 20912

OWNER:

TAKOMA WESTMORELAND LLC. SISI WISCONSIN AVE, N.W., SUITE 501 WASHINGTON, DC 20008

ARCHITECT:

THEODORE A. CAGE. ARCHITECT 2745 29TH ST. N.W. NO. 605 WASHINGTON, D.C. 20008

> 202-716-3878 (T) 202-234-5975 (F)

NOTE 1 5 EXISTING HOUSE -

SCALE: 1/8" = 1'-0"

BASEMENT FLOOR PLAN



I hereby certify that these documents were prepared or approved by me, and that I am a duly licensed professiona engineer under laws of the State of Maryland, License No. 17028, Expiration Date: Jun

"Professional Certification

RK CONSULTING, LLC

MECHANICAL/ELECTRICAL CONSULTANTS 18503 N. Frederick Ave. Gaithersburg, MD 20879 TEL. (301) 948-2808 FAX. (301) 947-7777 CONTACT PERSON: RUBIC MOVSESSIAN DRAWING TITLE

10-01-07

ISSUED FOR:

PERMIT SET

BASEMENT AND 1ST FLOOR PLANS

DRAWING NUMBER

E-1