37/03-06EEE 7400 MAPLE AVE 07BB COMPANY CONTROL OF THE PROPERTY OF THE PROPERT

HISTORIC PRESERVATION OFFICE THE MARYLAND NATIONAL CAPITAL PARKAND PARINING COMMISSION



RETURNTO: DEPARTMENT OF PERMITTING SERVICES
255 ROCKVILLE PIKE. 2nd FLOOR, ROCKVILLE, MD 20850
240/777-6370

HISTORIC PRESERVATION COMMISSION 301/563-3400

APPLICATION FOR HISTORIC AREA WORK PERMIT

me Phone No.: 301-270-4198 me Phone No.: 301-270-4198 MD 20912 Staet Zip Code Phone No.:
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Room Addition
ce 🗔 Woodburning Stove 📝 Single Family
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☐ Other:
Dther:
ocations:
public right of way/easement

SEE REVERSE SIDE FOR INSTRUCTIONS

THE FOLLOWING ITEMS MUST BE COMPLETED AND THE REQUIRED DOCUMENTS MUST ACCOMPANY THIS APPLICATION.

W	RITTEN DESCRIPTION OF PROJECT
a.	Description of existing structure(s) and environmental setting, including their historical features and significance:
	Three story wood framed craftsman cottage with single story brick extension located on
	heavily wooded lot. House is located in Takoma Park historic district.
b.	General description of project and its effect on the historic resource(s), the environmental setting, and, where applicable, the historic district:
	This application is a revision to previously approved plans. Original plans called for new
	screened porch, new mudroom, and the addition of two rooms above current addition. In
	these plans, screened porch is smaller, mudroom is removed and new addition is also
	simplified. Current plans have been certified as eligible for Maryland State Historic Credit.
Si	TE PLAN
Si	e and environmental setting, drawn to scale. You may use your plat. Your site plan must include:
a.	the scale, north arrow, and date;
h	dimensions of all existing and proposed structures; and
-	
C.	site features such as walkways, driveways, fences, ponds, streams, trash dumpsters, mechanical equipment, and landscaping.
_	
P	ANS AND ELEVATIONS
Yo	u must submit 2 copies of plans and elevations in a format no larger than 11" x 17". Plans on 8 1/2" x 11" paper are preferred.
a.	Schematic construction plans, with marked dimensions, indicating location, size and general type of walls, window and door openings, and other fixed features of both the existing resource(s) and the proposed work.
b.	Elevations (facades), with marked dimensions, clearly indicating proposed work in relation to existing construction and, when appropriate, context. All materials and fixtures proposed for the exterior must be noted on the elevations drawings. An existing and a proposed elevation drawing of each
	facade affected by the proposed work is required.
M	ATERIALS SPECIFICATIONS
Ge	neral description of materials and manufactured items proposed for incorporation in the work of the project. This information may be included on your sign drawings.
P	HOTOGRAPHS
ð.	Clearly labeled photographic prints of each facade of existing resource, including details of the affected portions. All labels should be placed on the front of photographs.
b.	Clearly label photographic prints of the resource as viewed from the public right-of-way and of the adjoining properties. All labels should be placed on

6. TREE SURVEY

the front of photographs.

2.

3.

5.

If you are proposing construction adjacent to or within the dripline of any tree 6" or larger in diameter (at approximately 4 feet above the ground), you must file an accurate tree survey identifying the size, location, and species of each tree of at least that dimension.

7. ADDRESSES OF ADJACENT AND CONFRONTING PROPERTY OWNERS

For ALL projects, provide an accurate list of adjacent and confronting property owners (not tenants), including names, addresses, and zip codes. This list should include the owners of all lots or parcels which adjoin the parcel in question, as well as the owner(s) of lot(s) or parcel(s) which lie directly across the street/highway from the parcel in question. You can obtain this information from the Department of Assessments and Taxation, 51 Monroe Street, Rockville, (301/279-1355).

HISTORIC PRESERVATION COMMISSION

Isiah Leggett County Executive Jef Fuller Chairperson

Date: September 12, 2007

MEMORANDUM

TO:

Carla Reid Joyner, Director

Department of Permitting Services

FROM:

Anne Fothergill, Senior Planner

Historic Preservation Section

Maryland-National Capital Park & Planning Commission

SUBJECT:

Historic Area Work Permit #463822, rear addition and alterations

The Montgomery County Historic Preservation Commission (HPC) has reviewed the attached application for a Historic Area Work Permit (HAWP). This application was **Approved** at the September 11, 2007 meeting.

THE BUILDING PERMIT FOR THIS PROJECT SHALL BE ISSUED CONDITIONAL UPON ADHERENCE TO THE ABOVE APPROVED HAWP CONDITIONS AND MAY REQUIRE APPROVAL BY DPS OR ANOTHER LOCAL OFFICE BEFORE WORK CAN BEGIN.

Applicant:

Ron and Dina Borzekowski

Address:

7400 Maple Avenue, Takoma Park, MD

This HAWP approval is subject to the general condition that the applicant will obtain all other applicable Montgomery County or local government agency permits. After the issuance of these permits, the applicant must contact this Historic Preservation Office if any changes to the approved plan are made.



Original Staff Reports

MONTGOMERY COUNTY HISTORIC PRESERVATION COMMISSION STAFF REPORT

Address:

7400 Maple Avenue, Takoma Park

Meeting Date:

09/11/2007

Resource:

Contributing Resource

Report Date:

09/04/2007

Applicant:

Ron and Dina Borzekowski

Takoma Park Historic District

Public Notice:

08/29/2007

Review:

HAWP

Tax Credit:

Partial

Case Number:

37/03-07BB REVISION

Staff:

Anne Fothergill

PROPOSAL:

Changes to approved rear addition

STAFF RECOMMENDATION

Staff is recommending that the HPC approve this revised HAWP application.

ARCHITECTURAL DESCRIPTION

SIGNIFICANCE:

Contributing Resource within the Takoma Park Historic District

STYLE:

Bungalow

DATE:

c1910-20

BACKGROUND

The applicants were approved for a rear addition in October 2006. In order to be eligible for tax credits from the Maryland Historical Trust, the applicants have revised the plans based on MHT's requirements. This staff report discusses the proposed changes to the approved plans.

PROPOSAL

The applicants are proposing the following changes to their approved rear addition. There are no new proposed changes to the historic house.

- First floor of rear addition reduced with smaller screened porch in location of existing deck and no interior mudroom
- Spiral staircase removed
- New door and wood steps to grade off rear screened porch
- Roof pitch of new rear dormer and second story addition increased
- Changes to fenestration on left side of rear addition and new dormer
- Front dormer windows to remain the same
- Siding for addition is Hardiplank including Hardiplank over existing brick on sides

APPLICABLE GUIDELINES

When reviewing alterations and new construction within the Takoma Park Historic District several documents are to be utilized as guidelines to assist the Commission in developing their decision. These documents include the historic preservation review guidelines in the approved and adopted amendment for the Takoma Park Historic District (Guidelines), Montgomery County Code Chapter 24A (Chapter 24A), and the Secretary of the Interior's Standards for Rehabilitation (Standards). The pertinent information in these documents is outlined below.

Takoma Park Historic District Guidelines

There are two very general, broad planning and design concepts which apply to all categories. These are:

The design review emphasis will be restricted to changes that are at all visible from the public right-of-way, irrespective of landscaping or vegetation (it is expected that the majority of new additions will be reviewed for their impact on the overall district), and,

The importance of assuring that additions and other changes to existing structures act to reinforce and continue existing streetscape, landscape, and building patterns rather than to impair the character of the district.

Contributing Resources should receive a more lenient review than those structures that have been classified as Outstanding. This design review should emphasize the importance of the resource to the overall streetscape and its compatibility with existing patterns rather than focusing on a close scrutiny of architectural detailing. In general, however, changes to Contributing Resources should respect the predominant architectural style of the resource. As stated above, the design review emphasis will be restricted to changes that are *at all visible from the public right-of-way*, irrespective of landscaping or vegetation.

Some of the factors to be considered in reviewing HAWPs on Contributing Resources include:

- All exterior alterations, including those to architectural features and details, should be generally
 consistent with the predominant architectural style and period of the resource and should preserve
 the predominant architectural features of the resource; exact replication of existing details and
 features is, however, not required
- Major additions should, where feasible, be placed to the rear of existing structures so that they are less visible from the public right-of-way; additions and alterations to the first floor at the front of a structure are discouraged, but not automatically prohibited
- While additions should be compatible, they are not required to be replicative of earlier architectural styles
- Some non-original building materials may be acceptable on a case-by-case basis; artificial siding
 on areas visible to the public right-of-way is discouraged where such materials would replace or
 damage original building materials that are in good condition
- Alterations to features that are not visible from the public right-of-way should be allowed a s a matter of course
- All changes and additions should respect existing environmental settings, landscaping, and patterns of open space.

Montgomery County Code; Chapter 24A

• A HAWP permit should be issued if the Commission finds that:

- 1. The proposal will not substantially alter the exterior features of a historic site or historic resource within a historic district.
- 2. The proposal is compatible in character and nature with the historical archaeological, architectural or cultural features of the historic site or the historic district in which a historic resource is located and would not be detrimental thereto of to the achievement of the purposes of this chapter.

STAFF DISCUSSION

The rear addition and other changes had previously been approved by the HPC and now the applicants are proposing an addition that is smaller and other changes that make it more compatible with the historic house. Staff is recommending approval of the proposed changes to the previously-approved addition.

STAFF RECOMMENDATION

Staff recommends that the Commission approve the HAWP application as being consistent with Chapter 24A-8(b)(1) & (2);

and with the Secretary of the Interior's Standards for Rehabilitation;

and with the general condition that the applicant shall present the 3 permit sets of drawings, if applicable, to Historic Preservation Commission (HPC) staff for review and stamping prior to submission for the Montgomery County Department of Permitting Services (DPS) building permits;

and with the general condition that the applicant shall notify the Historic Preservation Staff if they propose to make **any alterations** to the approved plans.



RETURN TO:

DEPARTMENT OF PERMITTING SERVICES

255 ROCKVILLE PIKE, 2nd FLOOR, ROCKVILLE, MD 20850

240/777-6370

HISTORIC PRESERVATION COMMISSION 301/563-3400

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	U,	AUG 2 3 2007	
J N] <u>[</u> //	SILVER SPRING, MD	J

			Contact Person: R	on Borzekowski	
	,		Daytime Phone No.:	301-270-4198	· · · · · · · · · · · · · · · · · · ·
Tax Account No.:					
Name of Property Owner: Ron an	d Dina Borzekowski	6	Daytime Phone No.:	301-270-4198	•
Address: 7400 Maple Ave		oma Park	MD		20912
Street Number		City	Staet		Zip Code
Contractor: owners			Phone No.:		
Contractor Registration No.:			···		
Agent for Owner:			Daytime Phone No.:		
LOCATION OF BUILDING/PREM	ISE		· · · · · · · · · · · · · · · · · · ·	, ,	
House Number: 7400	<u>.</u>	Street	Maple Ave		
Town/City: Takoma Park					
Lot: P17 Block: 5					
Liber: Folio:					
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PART ONE: TYPE OF PERMIT A	CTION AND USE				
1A. CHECK ALL APPLICABLE:		CHECK ALL	APPLICABLE:		•
Construct Extend	Alter/Renovate	Z A/C	© Slab	Addition 💮 🖸 Porch	☐ Deck ☐ Shed
☐ Move ② Install	☑ Wreck/Raze	□ Solar	🗌 Fireplace 🗔 Woodb	ourning Stove	Single Family
Revision - Repair	☐ Revocable	☐ Fence∧	Wall (complete Section 4)	Other:	
1B. Construction cost estimate: \$	200,000	•			
1C. If this is a revision of a previous		see Permit # 4/.	35081		
			<u> </u>		
PART TWO: COMPLETE FOR N	EW CONSTRUCTION AN	ID EXTEND/ADDIT	IONS		
2A. Type of sewage disposal:	01 🗷 WSSC	02 🗔 Septic	03 !T. Other:	·	
2B. Type of water supply:	01 🖾 WSSC	02 🗔 Well	. 03 🗍 Other:	· · · · · · · · · · · · · · · · · · ·	
PART THREE: COMPLETE ONLY	FOR FENCE/RETAINING	: WATT			
3A. Height feet		J TINLE			
	·				
3B. Indicate whether the fence or					•
On party line/property line	Entirely on la	and of owner	On public right of	way/easement	
I hereby certify that I have the authorproved by all agencies listed and Signature of ov	ority to make the foregoing I hereby acknowledge and when the second sec	application, that the diaccept this to be a d	application is correct, and condition for the issuance	that the construction vol this permit. 8/2/27	vill comply with plans
					
Approved:		For Chairp	person, Historic Preservat	ion Commission	
Disapproved:	Signature:			Date:	
Application/Permit No.:	463872	Date F	iled: 8/23/67	Date Issued:	

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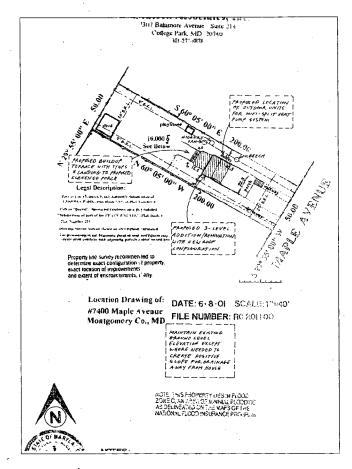
must file an accurate tree survey identifying the size, location, and species of each tree of at least that dimension.

PLEASE PRINT (IN BLUE OR BLACK INK) OR TYPE THIS INFORMATION ON THE FOLLOWING PAGE.
PLEASE STAY WITHIN THE GUIDES OF THE TEMPLATE, AS THIS WILL BE PHOTOCOPIED DIRECTLY ONTO MAILING LABELS.



HAWP APPLICATION: MAILING ADDRESSES FOR NOTIFING [Owner, Owner's Agent, Adjacent and Confronting Property Owners] Owner's Agent's mailing address Owner's mailing address Ron and Dina Borzekowski 7400 Maple Ave Takoma Park, MD 20912 Adjacent and confronting Property Owners mailing addresses Ted and Shannon Howard David Rogers and Rebekah Zanditon 7316 Maple Ave 7402 Maple Ave Takoma Park, MD 20912 Takoma Park, MD 20912 Joshua Wright and Eliza Leighton Bruce Weddle and Dorothy Darah 7401 Maple Ave 7315 Maple Ave Takoma Park, MD 20912 Takoma Park, MD 20912





NEW





DRAWING INDEX:

- T-1 TITLE SHEET; SITE PLAN
- A-1 FIRST FLOOR DEMOLITION PLAN
- A-2 SECOND FLOOR DEMOLITION PLAN
- A-3 THIRD FLOOR AND BASEMENT DEMOLITION PLANS
- A-4 FIRST FLOOR PLAN
- A-5 SECOND FLOOR PLAN
- A-6 THIRD FLODR PLAN A-7 BASEMENT PLAN
- A-8 ROOF PLAN
- A-9 FRONT AND BACK ELEVATIONS
- A-10 SIDE ELEVATION (SOUTHWEST)
- A-11 SIDE ELEVATION (NORTHEAST)
- A-12 SECTION: SCREENED PORCH KITCHEN
- A-13 SECTION: MUD ROOM DINING ROOM
- A-14 SECTION: BEDROOM; WALL DETAIL
- A-15 DETAIL: GREEN ROOF
- FOUNDATION PLAN AND COLUMN BASE DETAIL
- FIRST FLOOR FRAMING PLAN
- SECOND FLOOR FRAMING PLAN
- LOWER ROOF FRAMING PLAN
- MIDDLE ROOF, BAY WINDOW ROOF, THIRD FLOOR FRAMING PLAN UPPER ROOF FRAMING PLAN

- FIRST FLOOR ELECTRICAL PLAN SECOND FLOOR ELECTRICAL PLAN
- THIRD ELOOP AND RASEMENT ELECTRICAL PLANS

SCOPE: DISTURBED SOIL: NEW SCREENED PORCH STAIRS AND LANDING: TOTAL: 67 SF 67 SF

ADDITION:
NEW SCREENED PORCH:
NEW SECOND FLOOR BEDROOMS:
NEW THIRD FLOOR MASTER BEDROOM OORMER:
TOTAL:

RENOVATION: BASEMENT RENOVATION: FIRST FLOOR RENOVATION: 86 SF 407 SF 95 SF SECOND FLOOR RENOVATION: THIRD FLOOR RENOVATION:

- GEIGRAL NOTES:

 1. ALL WORK SPALL BE PERFORMED IN A "MORGMANLIKE" MANNER IN ACCORDANCE WITH IR.C. 2003 AND ALL OTHER APPLICABLE LOCAL CODES CURRENTLY IN FORCE.

 2. SHOULD THE GENERAL CONTRACTOR FIND ANY DISCREPANCIES BETWEEN THE DRAWINGS AND THE EXISTING CONDITIONS, SHE SHALL CONSULT WITH THE ARCHITECT BEFORE PROCEEDING WITH THE WORK.

 3. ALL DURENSONS NOTED ON THE ORAWINGS ARE BEFWEEN FINSH COMPONENTS (E.B., DRIVAUL TO DRIVANL) SOURCE STORES OTHERWISE MOTED (DE, FRAMING TO FRAMING).

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- GENERAL PARTITION NOTES:

 1. ALL NEW EXTERIOR WALLS SHALL BE 2X 6 WOOD FRAMING @ 24" D.C. WITH DOUBLE TOP PLATE WITH X' DRYWALL, SPACKLED AND FINISHED SMOOTH, UNLESS OTHERWISE NOTED.

 2. ALL NEW INTERIOR BEHNING WALLS SHALL BE 2X 4 WOOD FRAMING @ 16" D.C. WITH DOUBLE TOP PLATE WITH X' DRYWALL ON EACH SIDE. SPACKLED AND FINISHED SMOOTH, UNLESS OTHERWISE NOTED.

 3. ALL NEW INTERIOR NOW ABERTING WALLS SHALL BE 2X 4 WOOD FRAMING @ 24" D.C. WITH SINGLE TOP PLATE WITH X' DRYWALL ON EACH SIDE, SPACKLED AND FINISHED SMOOTH, UNLESS OTHERWISE NOTED.

 4. USE AUTHORS OF PRANING TECHNIZES (E.G., THO STUD CORNERS) WHERE POSSIBLE.

- SITE SPECIFICATIONS:

 1. GENERAL CONTRACTOR SHALL PROTECT OR REPAIR ALL DISTURBED AREAS PER COUNTY REQUIREMENTS. IT IS THE INTENTION TO AVOID DESTRUCTION OF EXISTING TREES. GENERAL CONTRACTOR SHALL DISTURBED AREAS PER COUNTY REQUIREMENTS. IT IS THE INTENTION TO AVOID DESTRUCTION OF EXISTING TREES. GENERAL CONTRACTOR SHALL DEMANCATE AN AREA AROUND ALL OWNER-MARKED TREES AND PROTECT THEM FROM ALL CONSTRUCTION ACTIVITIES. AREA OF TREE PROTECTION WILL NOLUDE THE ENTIRE DRIP LINE OF THE TREE OR WITHIN A 1G-FEET PERMIETER OR THE THEIR, WHICHEVER IS GREATER.

 2. REMOVE AND DISPOSE OF ALL CONSTRUCTION CRISIS PER COUNTY AND CITY REQUIREMENTS.

 3. STABLUES ON TEMPORARLY AS NECESSARY FOR CONSTRUCTION. PROVIDE EMOSION CONTROL MEASURES AROUND ALL DISTURBED EARTH AREAS, INCLIDING SILT FENCING AND TEMPORARY SEEDING AS NECESSARY FOR CONSTRUCTION. PROVIDE EMOSION CONTROL MEASURES AROUND ALL DISTURBED EARTH AREAS, INCLIDING SILT FENCING AND TEMPORARY SEEDING AS NECESSARY FOR CONSTRUCTION.
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- APPROPRIATE.

 A STOCKPIE LAL DISTURBED TOPSOIL, TREE BRANCH CLIPPINGS. REPLACE MINIMUM 6 INCH OF TOPSOIL AT FINISH GRADE RE-CONTOUR FINISH GRADE TO SLOPE AWAY FROM BUILDING AT A MINIMUM SLOPE OF 15 DEGREES FOR A MINIMUM OF ZPECT FROM THE EXTERIOR WALL AND A MINIMUM SLOPE OF 5% WITHIN 10 FEET OF THE HOUSE FOR SURFACE DRAINAGE.

 5. HINSIN GRADE SHALL EE A MINIMUM 18 INCHOSE FROM ALL INON-PRESENDER ITERATED WOOD.

 6. VERILY PROPERTY BOLINDRIES AND LOCATIONS OF ALL UTLIES PRIOR TO ANY EXCLANTION.

 7. SOLL COMPACTION FOR ALL FLILED AREAS SHALL HAVEA A MINIMUM COMPACTION OF 50% OF THE MINIMUM ONLY DENSITY AS DETERMINED BY ASTM D689 (ASSITTO DESIGNATION T-29).

ENERGY EFFICIENCY: 1. CEILING:

- 2 WALL
- FXISTING EXTERIOR WALL FLOOR OVER OUTSIDE AIR:
- RIGID INSULATION IN-BETWEEN DOUBLE HEADER

ARCHITECTS

W. WILLIAM HUTCHINS, ALA A. BAMBI MAH, ASSOC. NA 202.352.4553

STRUCTURAL ENGINEER:

WILLIAM UPDIKE 4202 32NO ST MT. RAINER, NO 20712 202.367.5649

BORZEKOWSKI RESIDENCE 7400 MAPLE AVE TAKOMA PARK, MD 20912

PERMIT 11/20/06 REV. PERMIT 07/18/07


WEST TILE

TITLE SHFFT: SITE PLAN

ABT

07/18/2007


AS SHOWN

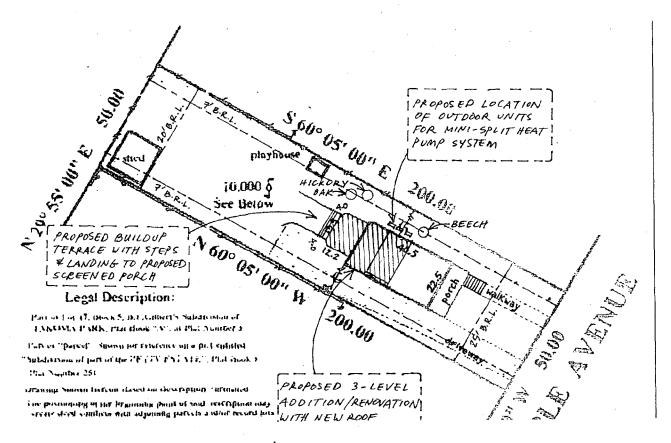

NEW site plan - enlarged

Landtech Associates, Inc.

7307 Baltimore Avenue Suite 214 College Park, MD 20740 301-277-8878

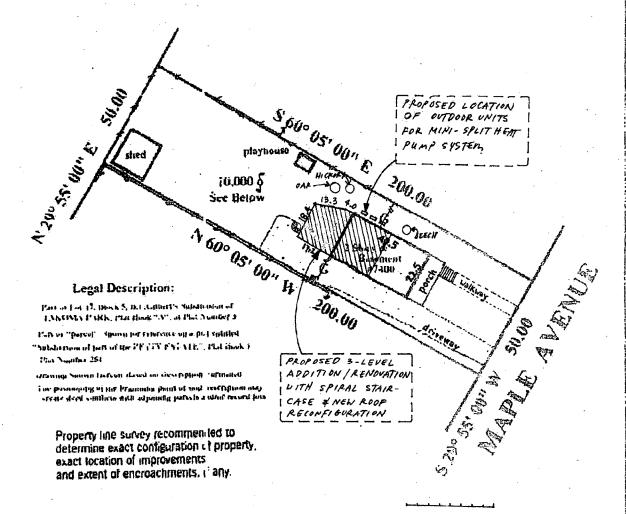

Location Drawing of: #7400 Maple Avenue Montgomery Co., MD

DATE: 6.8.01 SCALE:1"=40"


FILE NUMBER: RC 201100


the Approved site plan



NOTE THIS PROPERTY LIES IN FLOOD ZONE C, AN AREA OF MINIMAL FLOODING AS DELINEATED ON THE MAPS OF THE NATIONAL FLOOD INSURANCE PROGRAM

LITTEC

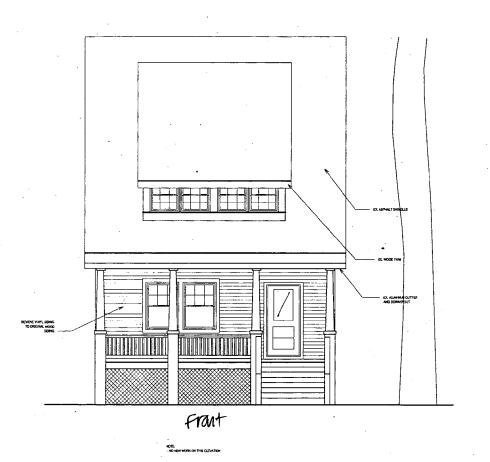

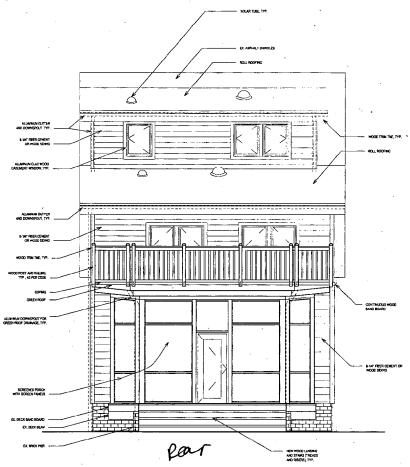

NEW PROPOSAL

ELEVATION: FRONT

SCALE: $\frac{1}{4}$ " = 1'-0"

ELEVATION: BACK (WITH TYPICAL NOTES) SCALE: $\frac{1}{4}$ " = 1'-0"

HELICON


CONSTRUCTION MANAGER

BORZEKOWSKI RESIDENCE 7400 MAPLE AVE TAKOMA PARK, ND 20912

ľ	G945				
	PERMIT	11/2906			
	PERMIT - REVISED	g7/15G7			
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ELEVATION: FRONT AND BACK


07/18/2007

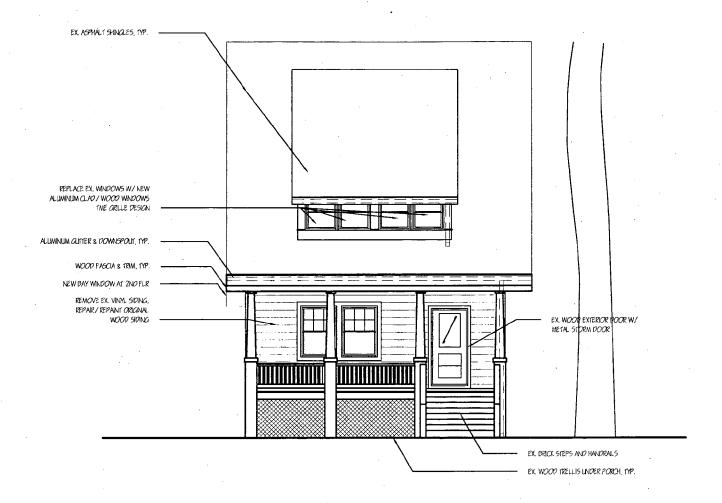

HPC APPROVED

BORZEKOWSKI RESIDENCE 7400 MAPLE AVE TAKOMA PARK, MD 20912 RON & DINA BORZEKOWSKI 301-270-4198		PR	OPOSED ELEVA	FRONT TION
HELICON WORKS 7108 HOLLY STREET TAKOMA PARK, MD 20912 W. WILLIAM HUTCHINS, AIA 301-404-5578	A. BAMBI TRAN 202-352-4563	DRAWN BY: DATE: SCALE:	ABT 16 OCT 2006 1/8" = 1'-0"	A-9



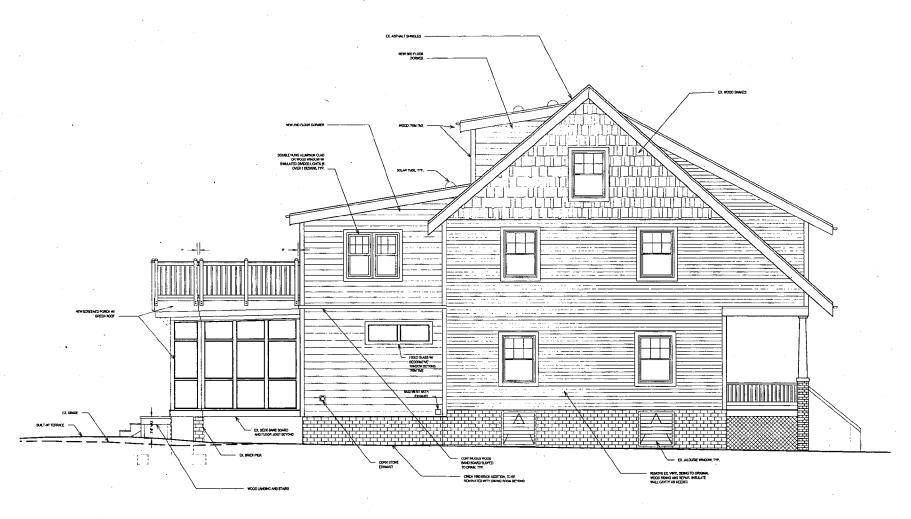

NEW PROPOSAL

ELEVATION: SIDE (SOUTHWEST) (WITH TYPICAL NOTES) SCALE: $\frac{1}{4}$ " = 1'-0"


HELICON WORKS

BORZEKOWSKI RESIDENCE 7400 MAPLE AVE TAKOWA PARK, NO 20912

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ELEVATION: SIDE (SOUTHWEST)


¼" = 1'-0"

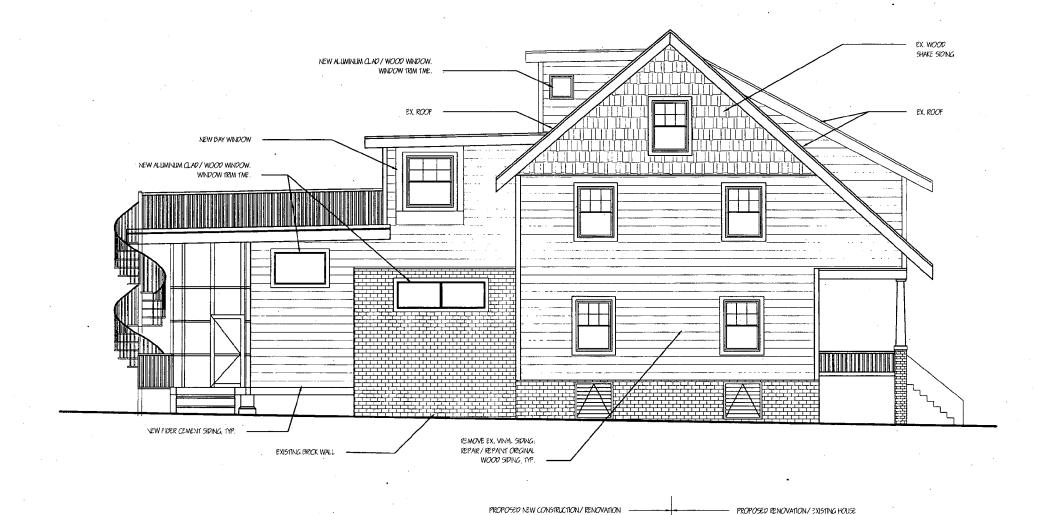

HPC APPROVED

BORZEKOWSKI RESIDENCE PROPOSED 7400 MAPLE AVE SIDE ELEVATION TAKOMA PARK, MD 20912 RON & DINA BORZEKOWSKI (SOUTHWEST) 301-270-4198 **HELICON WORKS** DRAWN BY: ABT 7108 HOLLY STREET DATE: 16 OCT 2006 TAKOMA PARK, MD 20912 W. WILLIAM HUTCHINS, AIA A. BAMBI TRAN 202-352-4563 SCALE: 1/8" = 1'-0" 301-404-5578

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NEW PROPOSAL

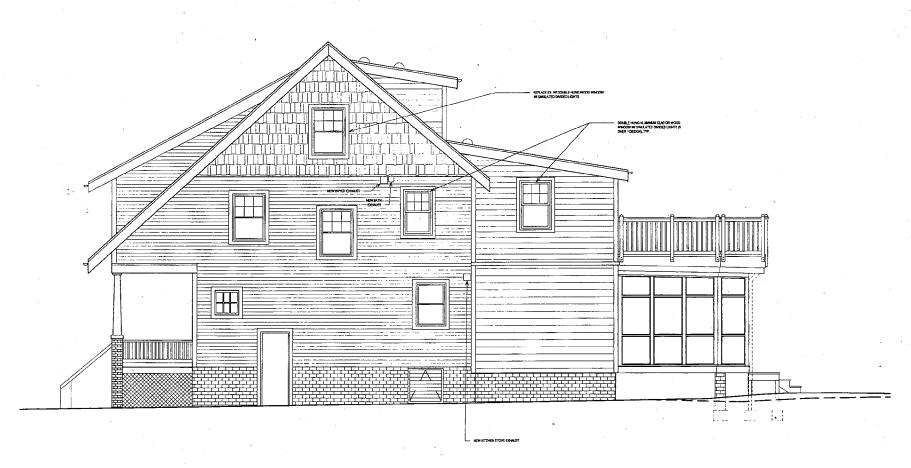ELEVATION: SIDE (NORTHEAST) SCALE: $\frac{1}{4}$ " = 1'-0"

HELICON WORKS


BORZEKOWSKI RESIDENCE 7400 MAPLE AVE TAKOKA PARK, ND 20912

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ELEVATION: SIDE (NORTHEAST)

X" = 1'-0"



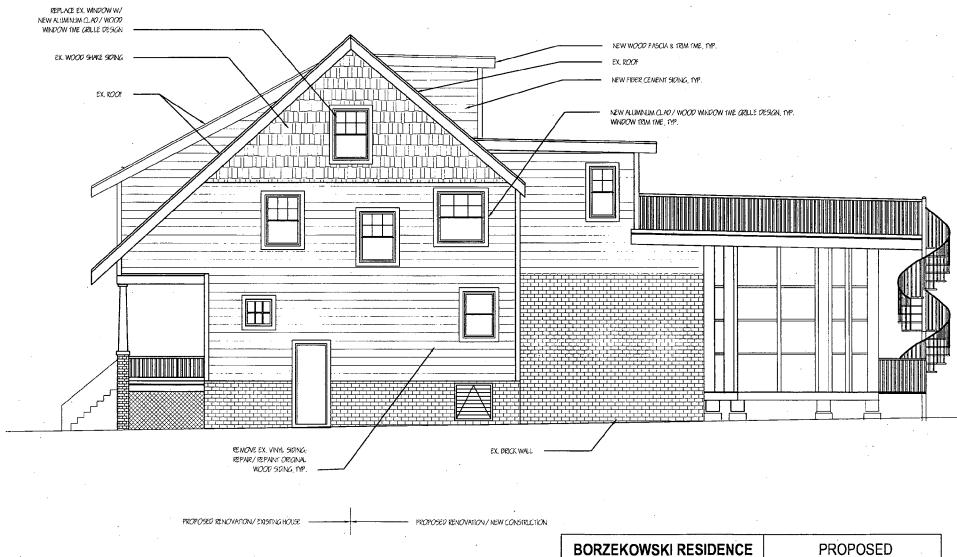

HPC APPROVED

BORZEKOWSKI RESIDENCE

7400 MAPLE AVE TAKOMA PARK, MD 20912 RON & DINA BORZEKOWSKI 301-270-4198

HELICON WORKS 7108 HOLLY STREET TAKOMA PARK, MD 20912 W. WILLIAM HUTCHINS, AIA 301-404-5578

A. BAMBI TRAN 202-352-4563 SIDE ELEVATION (NORTHEAST)


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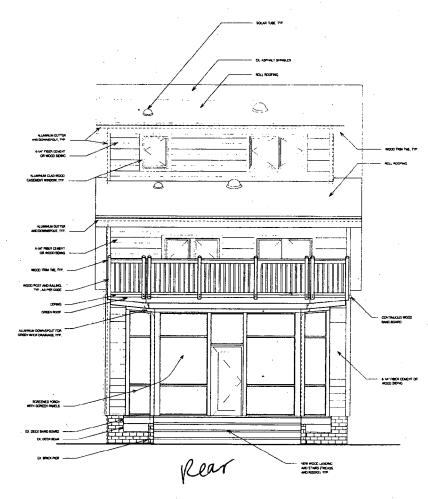
SCALE:

DATE: 16 OCT 2006

006 | A-12





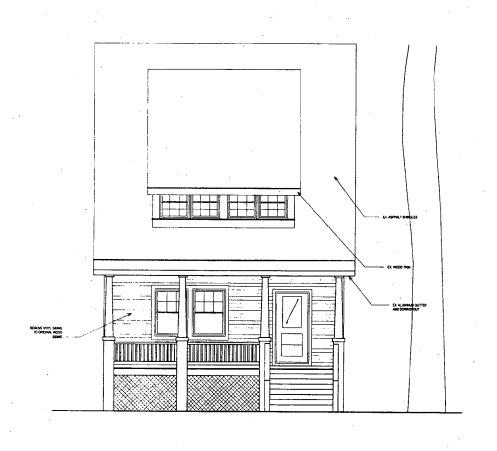

NEW PROPOSAL

ELEVATION: FRONT SCALE: $\frac{1}{4}$ " = 1'-0"

ELEVATION: BACK (WITH TYPICAL NOTES) SCALE: $\frac{1}{4}$ " = 1'-0"

HELICON **WORKS**

7108 HOLLY AVENUE TAKOMA PARK, ND 20912

A SAME TRAN, ASSOC. ALA 202.302.4003


STRUCTURAL ENGINEER: D. ANTHONY SEALE, ILC D. ANTHONY SEALE, P.C. BOSA TUTTLE ND SPRINGPILD, VA 22152 202.669-2272

CONSTRUCTION MANAGER: WILLIAW UPO ME +202 32ND ST +7, RAINER, MD 20712 202.367.06+0

BORZEKOWSKI 7400 MAPLE AVE TAKOMA PARK, NO 20912

ELEVATION: FRONT AND BACK


07/18/2007

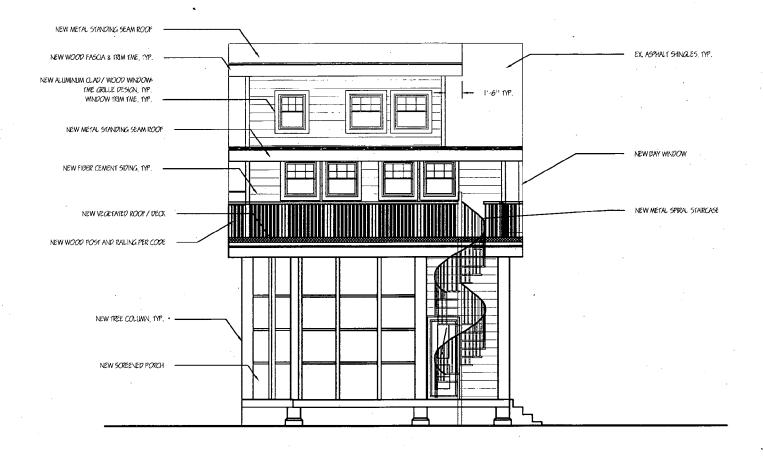

HPC APPROVED

BORZEKOWSKI RESIDENCE 7400 MAPLE AVE TAKOMA PARK, MD 20912 RON & DINA BORZEKOWSKI 301-270-4198	PROPOSED BACK ELEVATION
HELICON WORKS 7108 HOLLY STREET TAKOMA PARK, MD 20912 W. WILLIAM HUTCHINS, AIA 301-404-5578 202-352-4563	DRAWN BY: ABT DATE: 16 OCT 2006 SCALE: 1/8" = 1'-0" A-10



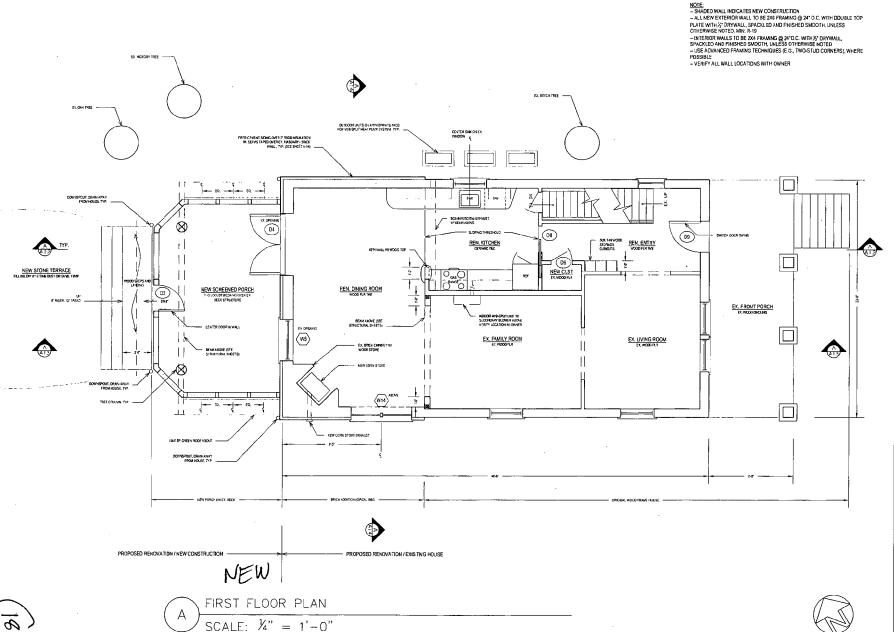

HELICON WORKS

ARCHITECTS

7108 HOLLY AVENUE TAXOMA PARK, MO 20912

W. WILLIAM HUTCHINS, AIA 301, 404, 5576 A. BAMBI TRAN, ASSOC, AIA 202, 302, 4063

STRUCTURAL ENGINEER: D. ANTHONY BEALE, LLC D. ANTHONY BEALE, P.C. 06.54 TUTTLE RD SPRINGPELG, VA. 22102 202.669.2272

CONSTRUCTION MANAGER: WILLIAM UPDIME 4202 32NO ST 4202 32NO ST MT. RANNIER, MD 20712 202 367 6646

PROJECT NAME:

BORZEKOWSKI RESIDENCE 7400 MAPLE AVE TAKOMA PARK, MD 20912

DINA BORZEKOWSKI RON BORZEHOWSKI 7400 MAPLE 4VE TAKOMA PARH, MD 20712 301,270,4195

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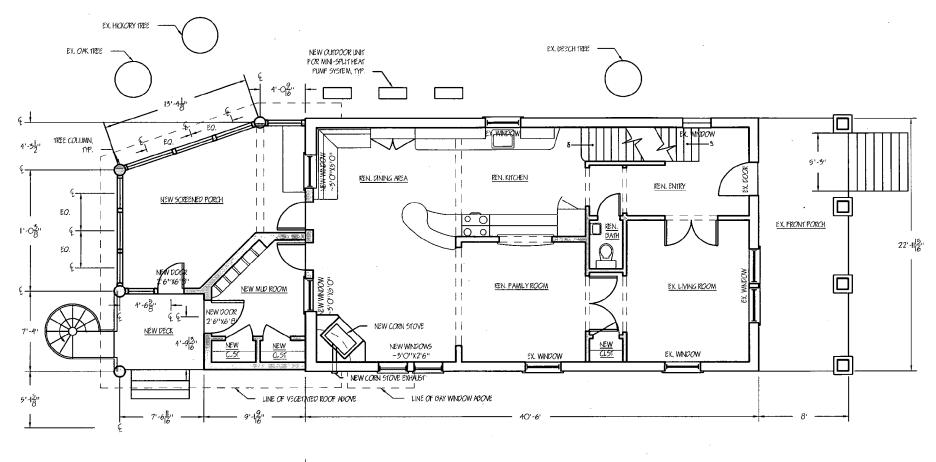
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FIRST FLOOR PLAN

TEA

/4" = 1'-(

A-4






- -- SHADED WALL INDICATES NEW CONSTRUCTION.
- -- ALL NEW EXTEROR WALLS TO BE 236 FRANING @24"O.C. WITH DOUBLE TOP PLATE WITH 1/2" DRYWAL AND ROLINDED CORNER BEAD, SPACKLED AND PINISHED SMOOTH, LINLESS OTHERWISE NOTED. MIN. R-19.
- -- INSLATE EXISTING EXPEROR WALLS WITH BLOWN-IN INSLLATION, MIN R-19,
 -- SEE TREE PROTECTION PLAN FOR PROTECTION OF EXISTING SIGNIFICANT TREES.

HPC Approved

BORZEKOWSKI RESIDENCE 7400 MAPIE AVE TAKOMA PARK ND 20912 RON & DINA BORZEKOWSKI 301-270-4198		FIRST FLOOR PLAN		OR PLAN
HELICON WORKS 7108 HOLLY STREET TAKOMA PARK, MD 20912 W. WILLIAM HUTCHINS, AIA 301-404-5578	A. BAMBI TRAN 202-352-4563	DRAWN BY: DATE: SCALE:	ABT 16 OCT 2006 1/8" = 1'-0"	A-6



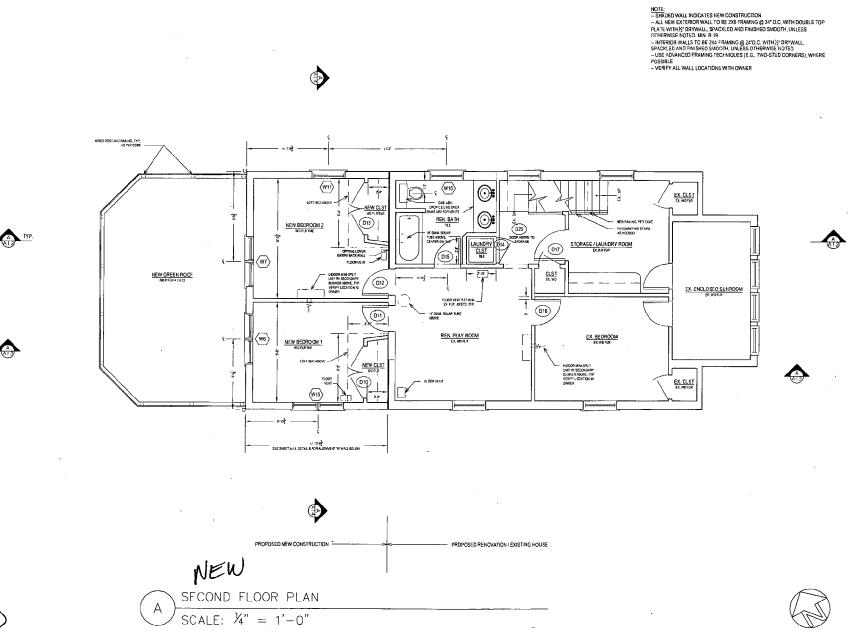

HELICON WORKS

ARCHITECTS

7108 HOLLY AVENUE TAKONA PARK, ND 20912

W. WILLIAM HUTCHINS, AIA 301, 404, 5575 A. SAMSI TRAN, ASSOC, AIA 202, 302, 4063

STRUCTURAL ENGINEER: 0. ANTHONY BEALE, P.E. 0. ANTHONY BEALE, P.E. 8634 TUTTLE RD SPRINGFELD, VA 22102 202.069.2272

CONSTRUCTION MANAGER:

BORZEKOWSKI RESIDENCE 7400 MAPLE AVE TAKONA PARK, ND 20912

OWNER:

DINA BORZEKOWSK RON BORZEKOWSK 74DD MAPLE AVE TAHOMA PARK, MD 2091 3-01.2270.4195

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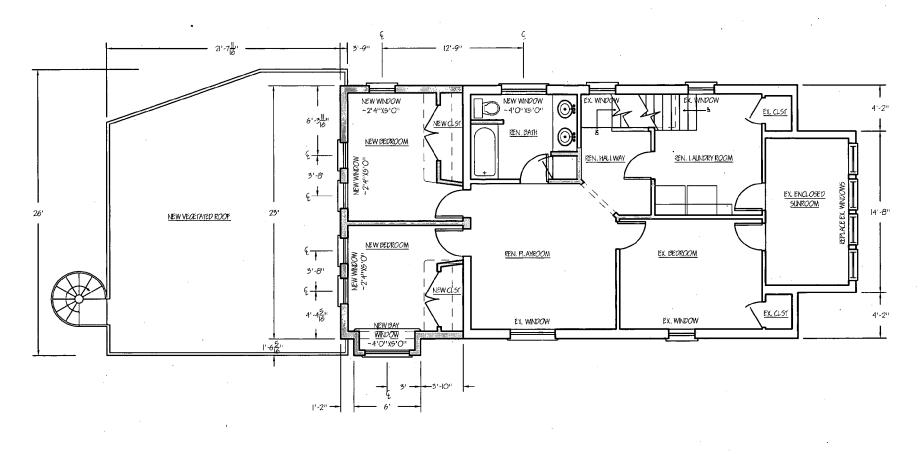
SECOND FLOOR PLAN

ABT

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A-5

02)



PROPOSED NEW CONSTRUCTION PROPOSED RENOVATION/ EXISTING HOUSE

NOTE:

- -- SHADED WAL. INDICATES NEW CONSTRUCTION.
- -- ALL NEW EXTERIOR WALLS TO BE 2X6 FRAMING @24"O.C. WITH DOUBLE TOP PLATE WITH
- 1/2" DRYWALL AND ROUNDED CORNER BEAD, SPACKLED AND FINISHED SMOOTH, UNLESS
- OTHERWISE NOTED, MIN. R-19.
- -- INSILATE EXISTING EXTERIOR WALLS WITH BLOWN-IN INSILATION, MIN, 2-19,

HPC Approve+

BORZEKOWSKI RES 7400 MAPLE AVE TAKOMA PARK, MD 20912 RON & DINA BORZEKOWSKI 301-270-4198	SIDENCE	SE	ECOND FLO	OOR PLAN
HELICON WORKS 7108 HOLLY STREET TAKOMA PARK, MD 20912 W. WILLIAM HUTCHINS, AIA: 301-404-5578	A. BAMBI TRAN 202-3524-563	DRAWN BY: DATE: SCALE:	ABT 16 OCT 2006 1/8" = 1'-0"	A-7



NOTE

- SYADEO WALL INDICATES NEW CONSTRUCTION

- ALL NEW EXTERIOR WALL TO BE 2X6 FRAMING @ 24" D.C. WITH DOUBLE TOP
PLATE WITH X'', DRYWALL, SPACKLED AND FINISHED SMOOTH, LUNLESS
DIHERWISE SHOTED, LUNL R-19

- INITERIOR WALLS TO BE 2X4 FRAMING @ 24"D.C. WITH X' DRYWALL,
SPACKLED AND FINISHED SWOOTH, UNLESS OT WHEREM'SE NOTED

- USE ADVANCED FRAMING TECHNIQUES (E.G., TWO-STUD CDRINERS)), WHERE
POSSIBLE

- VERIFY ALL WALL LOCATIONS WITH OWNER REN. CLST NEW ROLL RODFING EX. ASPHALT SHINGLES
ROOFING 2 (022) PROPOSED NEW CONSTRUCTION -- PRDPOSED RENOVATION / EXISTING HOUSE NEW THIRD FLOOR PLAN

SCALE: $\frac{1}{4}$ " = 1'-0"

HELICON WORKS

ARCHITECTS

71D8 HOLLY AVENUE TAKOMA PARK, MD 20912

W. WILLIAM HUTCHINS, AIA 301,404,8578 4. BAMBI TRAN, ASSOC. AIA 202,382,4363

STRUCTURAL ENGINEER: D. ANTHONY BEALS, P.E. BOS4 TUTTLE RD SPRINGRELD, VA. 22192 202, 609, 2272

CONSTRUCTION MANAGER:

PROJECT NAME:

BORZEKOWSKI RESIDENCE 7400 MAPLE AVE TAKOMA PARK, ND 20912

W(D):

DINA BORZEKOWSKI RON BORZEKOWSKI 74DO MAPLE AVE TAKOMA PARK, MD 20912 DO1.270.4198

PERMIT	11/20/06
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SHEET TILE


. THIRD FLOOR PLAN

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K" = 1'-0"

A-6



PROPOSED NEW CONSTRUCTION/ REVOVATION PROPOSED RENOVATION/EXISTING HOUSE

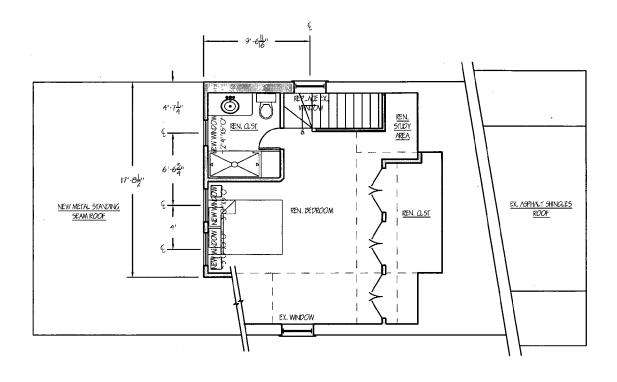
- -- SHADED WALL INDICATES NEW CONSTRUCTION.
 -- ALL NEW EXTERIOR WALLS TO BE 2X6 FRANING @24"O.C. WITH DOUBLE TOP PLATE WITH
 1/2' DRYWALL AND ROUNDED CORNER BEAD, SPACKLED AND PINISHED SMOOTH, UNLESS OTHERWISE NOTED, MIN. R-19.
- -- INSULATE EXISTING EXTERIOR WALLS WITH BLOWN-IN INSULATION, MIN. R-19.

MPC approved


BORZEKOWSKI R 7400 MAPLE AVE TAKOMA PARK, MD 20912 RON & DINA BORZEKOWSKI 301-270-4198	ESIDENCE	T	HIRD FLOO	OR PLAN
HELICON WORKS 7108 HOLLY STREET TAKOMA PARK, MD 20912 W. WILLIAM HUTCHINS, AIA 301-404-5578	A. BAMBI TRAN 202-352-4563	DRAWN BY: DATE: SCALE:	ABT 16 OCT 2006 1/8" = 1'-0"	A-8



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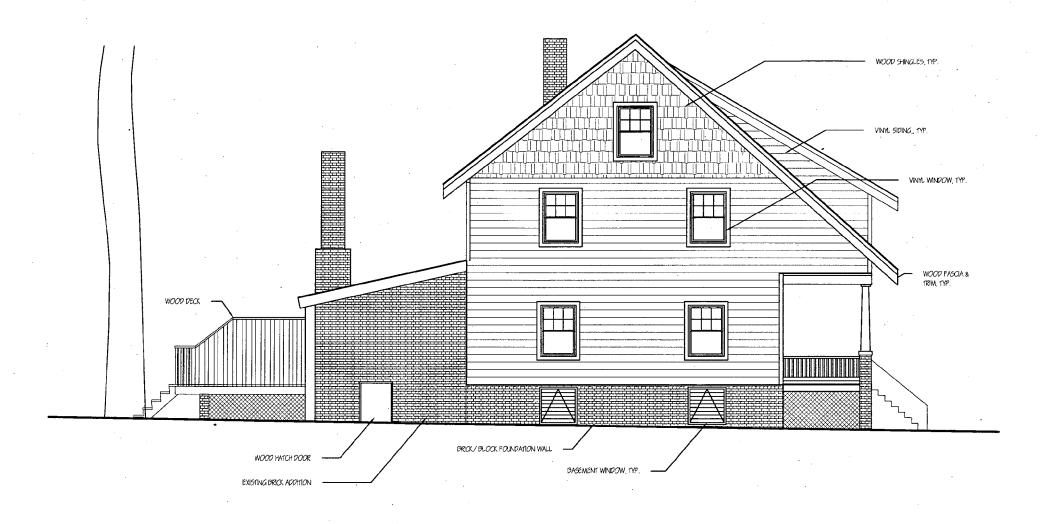


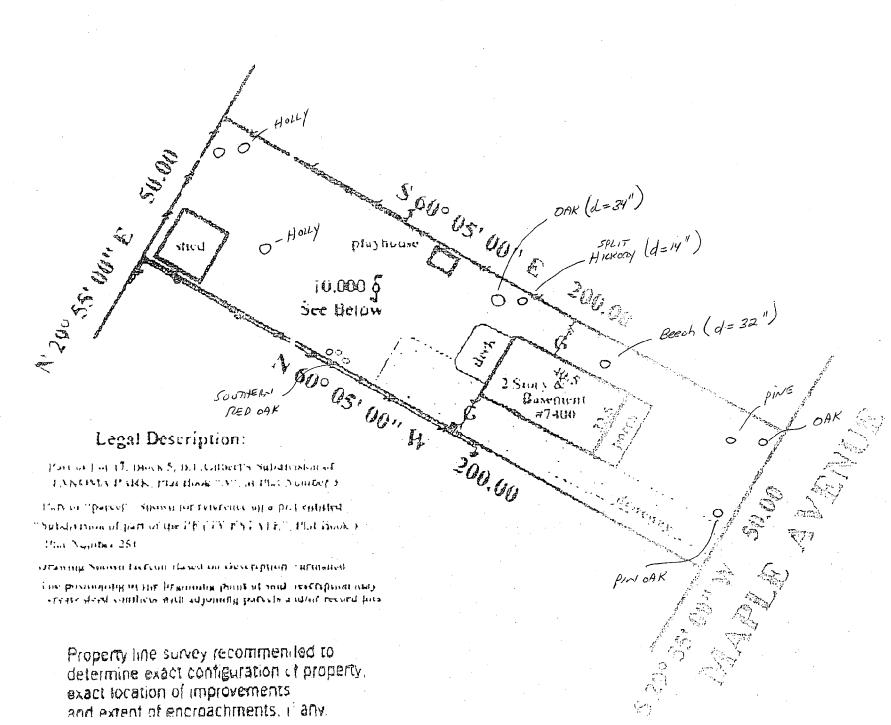

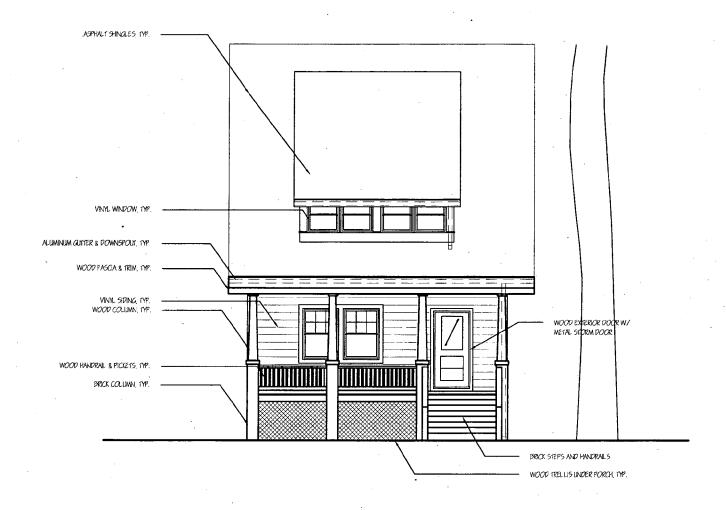

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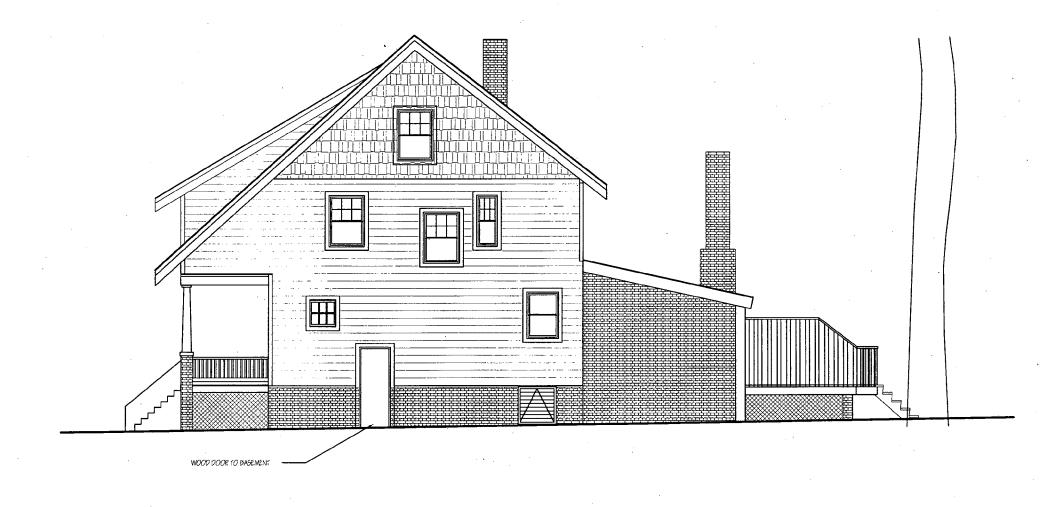
BORZEKOWSKI 7400 MAPLE AVE TAKOMA PARK, MD 20912 RON & DINA BORZEKDWSKI 301-270-4198	RESIDENCE	E	XISTING ELEVA	
HELICON WORKS 7108 HOLLY STREET TAKOMA PARK, MD 20912		DRAWN BY:	ABT 04 OCT 2006	Δ-2
W. WILLIAM HUTCHINS, AIA 301-404-5578	A. BAMBI TRAN 202-352-4563	SCALE:	1/8" = 1'-0"	/ \ _



EXISTING

BORZEKOWSKI RESIDE 7400 MAPLE AVE TAKOMA PARK, MD 20912 RON & DINA BORZEKOWSKI 301-270-4198	ENCE EXISTING SIDE ELEVATION (SOUTHWEST)
HELICON WORKS 7108 HOLLY STREET TAKOMA PARK, MD 20912 W. WILLIAM HUTCHINS, AIA 301-404-5578 A. BAMBI T 202-352-45	1111






EXISTING

BORZEKOWSKI RESIDENCE 7400 MAPLE AVE TAKOMA PARK, MD 20912 RON & DINA BORZEKOWSKI 301-270-4198	EXISTING SIDE ELEVATION (NORTHEAST)	
HELICON WORKS 7108 HOLLY STREET TAKOMA PARK, MD 20912 W. WILLIAM HUTCHINS, AIA A. BAMBI TRAN 301-404-5578 202-352-4563	DRAWN BY: ABT DATE: 04 OCT 2006 SCALE: 1/8" = 1"-0" A-5	



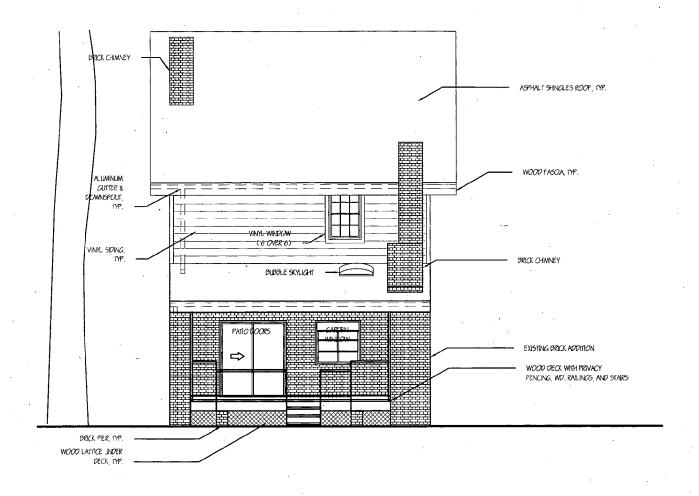

EXISTING

BORZEKOWSKI 7400 MAPLE AVE TAKOMA PARK, MD 20912 RON & DINA BORZEKOWSKI 301-270-4198	RESIDENCE	E	XISTING ELEVA	
HELICON WORKS 7108 HOLLY STREET TAKOMA PARK, MD 20912 W. WILLIAM HUTCHINS, AIA	A. 8AMBI TRAN	DRAWN BY: DATE:	ABT 04 OCT 2006	A-3
301-404-5578	202-352-4563	SCALE:	1/8" = 1'-0"	

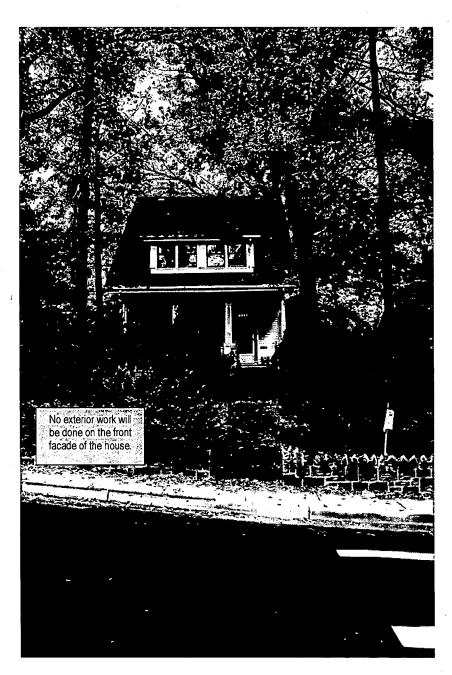


Fig. 1. 7400 Maple Avenue, Takoma Park, MD 20912 Front view - No affected areas.

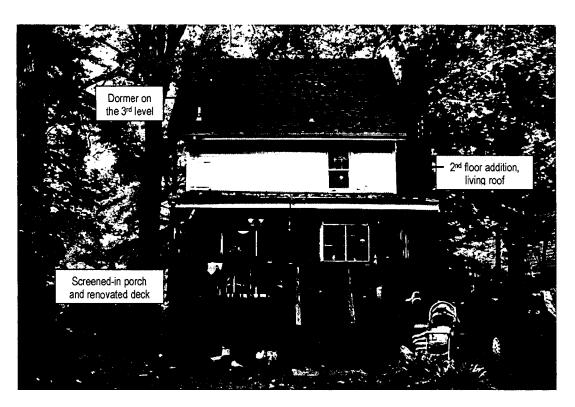


Fig. 2. 7400 Maple Avenue, Takoma Park, MD 20912 Rear View (west-facing side) with details of affected portions






Fig. 3.
7400 Maple Avenue, Takoma Park, MD 20912
Side View (south-facing side) of affected area (from the neighbor's front yard).







Fig.4.
7400 Maple Avenue, Takoma Park, MD 20912
Side View (north-facing side) of affected area (from the neighbor's driveway).




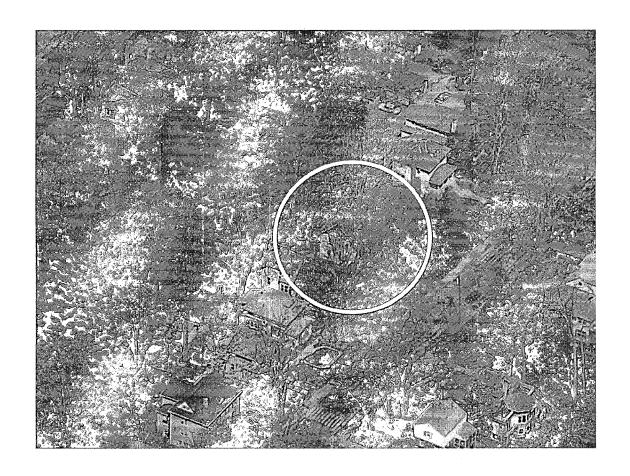

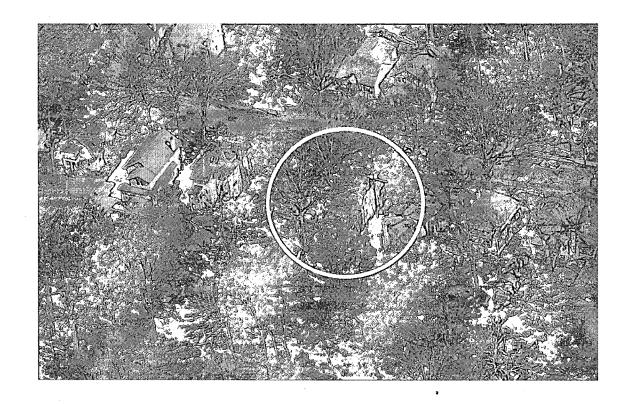





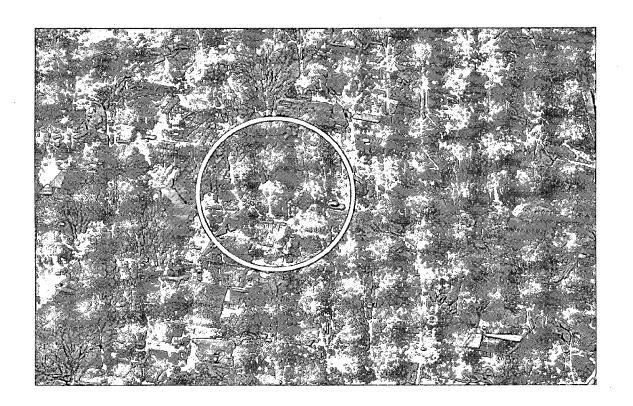


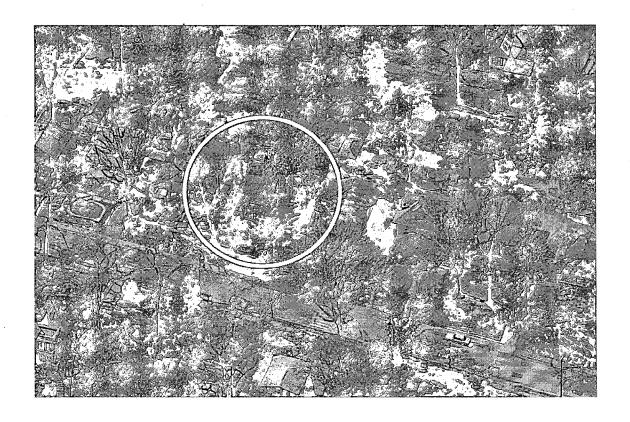



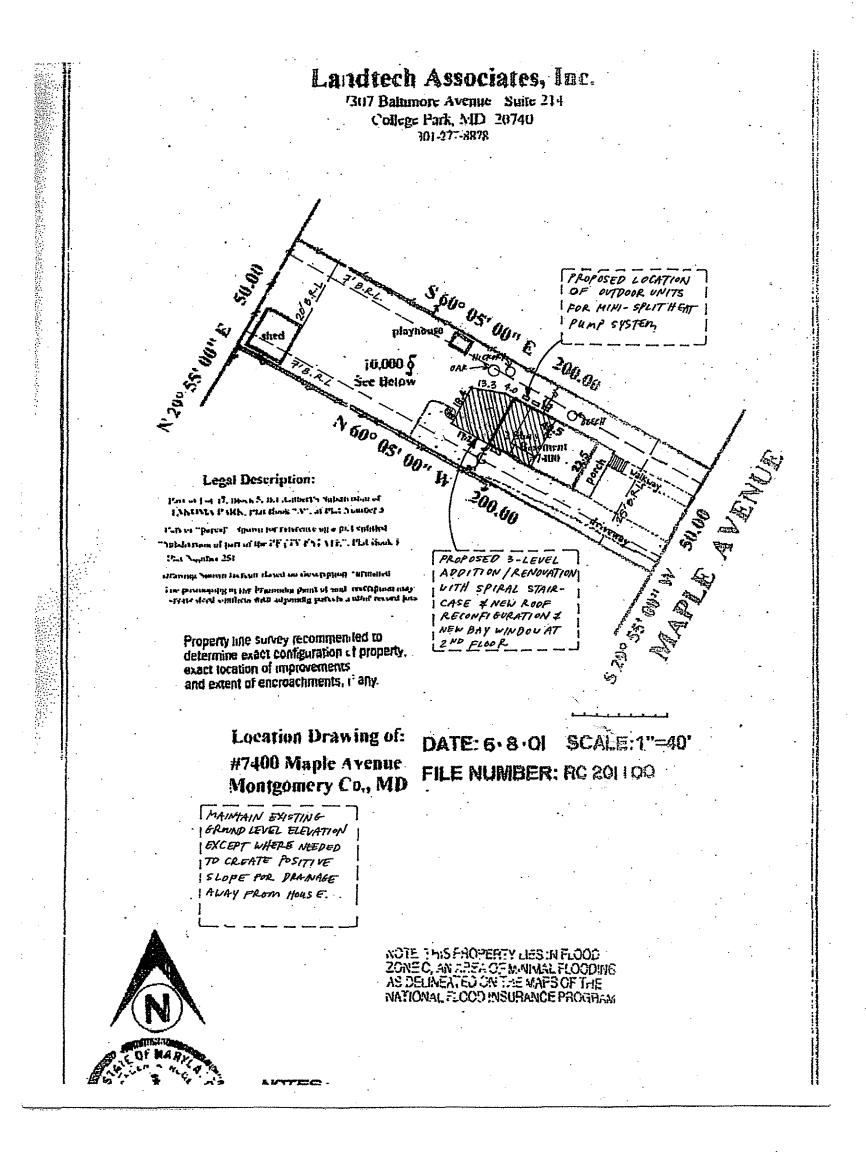

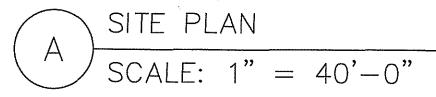

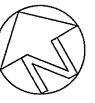

DRAWING INDEX:

- TITLE SHEET; SITE PLAN
- FIRST FLOOR DEMOLITION PLAN
- SECOND FLOOR DEMOLITION PLAN
- THIRD FLOOR DEMOLITION PLAN
- FIRST FLOOR PLAN
- SECOND FLOOR PLAN
- THIRD FLOOR PLAN
- A-7 **BASEMENT PLAN**
- **ROOF PLAN**
- FRONT AND BACK ELEVATIONS
- SIDE ELEVATION (SOUTHWEST)
- SIDE ELEVATION (NORTHEAST)
- SECTION: SCREENED PORCH KITCHEN
- SECTION: MUD ROOM DINING ROOM
- SECTION: BEDROOM; WALL DETAIL
- FOUNDATION PLAN AND COLUMN BASE DETAIL S-1
- FIRST FLOOR FRAMING PLAN
- S-3 SECOND FLOOR FRAMING PLAN
- S-4 LOWER ROOF FRAMING PLAN
- MIDDLE ROOF, BAY WINDOW ROOF, THIRD FLOOR FRAMING PLAN
- UPPER ROOF FRAMING PLAN
- FIRST FLOOR ELECTRICAL PLAN
- SECOND FLOOR ELECTRICAL PLAN
- E-3 THIRD FLOOR AND BASEMENT ELECTRICAL PLANS

DISTURBED SOIL: NEW SCREENED PORCH / MUD RODM / DECK: NEW SCREENED FORCH / MUD ROOM / DECK: NEW SECOND FLOOR BEDROOMS: NEW THIRD FLOOR MASTER BEDROOM DORMER: FIRST FLDDR RENOVATION: 635 SF 179 SF 53 SF 867 SF

GENERAL NOTES:

- FE WITH LR.C. 2003 AND ALL OTHER APPLICABLE LOCAL CODES CURRENTLY IN FORCE.
- 2. SHOULD THE GENERAL CONTRACTOR FIND ANY DISCREPANCIES BETWEEN THE DRAWINGS AND THE EXISTING CONDITIONS, SHE SHALL CONSULT WITH THE ARCHITECT SEFORE PROCEEDING WITH THE WORK.

 3. ALL DIMENSIONS NOTED ON THE DRAWINGS ARE BETWEEN FINISH COMPONENTS (I.E., DRYWALL TO DRYWALL, SIDING TO SIDING) UNLESS OTHERWISE NOTED (I.E., FRAMING TO FRAMING).
- 4. DO NOT SCALE DIMENSIONS FROM THE DRAWINGS. THE CONTRACTOR SHALL BE RESPONSIBLE FOR VERIFYING IN THE FIELD ALL NECESSARY ROUGH, FINISH, AND INSTALLATION DIMENSIONS FOR FIXTURES, EQUIPMENT, AND THE LIKE.
 5. IT IS THE INTENTION TO MINIMIZE LANOFILL WASTE FOR THE DURATION OF THIS PROJECT. OFFER ALL MATERIALS THAT CAN BE RE-USED, SUCH AS EXCESS LUMBER, FIXTURES, ETC., TO THE OWNER; SALVAGE OR DONATE ANY REMAINING MATERIALS (COMMUNITY FORKLIFT IN DC 202-544-0059, LOADING DOCK IN BALTIMORE 410-728-3625, SECOND CHANCE IN BALTIMORE 410-458-0888, UNCONTAMINATED DRYWALL WASTE MAY BE USED AS A SOIL AMENDMENT OR MAY BE CRUSHED AND ADDED TO COMPOST, AS APPROVED BY DWNER. IDENTIFY AND SEPARATE ALL RECYCLABLE WASTE GENERATED DURING CONSTRUCTION. CATEGORIES OF RECYCLABLES SHALL INCLUDE, BUT ARE NOT LIMITED TO: MIXED GLASS, METALS (INCLUDING STEEL, ALUMINUM, COPPER), PLASTIC (INCLUDING BEVERAGE CONTAINERS), UNTREATED WOOD SCRAP, AND ALL PAPER PRODUCTS (INCLUDING CARDBOARD), SEE MARYLAND RECYCLING (WWW.MDRECYCLES.ORG) FOR RE-USE AND
- RECYCLING DIRECTORIES, CLEAN WORK AREAS DAILY. THE GENERAL CONTRACTOR SHALL LEAVE THE SITE FREE AND CLEAR OF CONSTRUCTION MATERIALS AND EQUIPMENT UPON JOB COMPLETION. 6. ALL STRUCTURES AND MATERIALS SCHEDULED FOR DEMOLITION SHALL BE REMOVED FROM THE SITE IN THEIR ENTIRETY, UNLESS OTHERWISE NOTED. ANY DAMAGE CAUSED TO EXISTING MATERIALS AND/OR STRUCTURAL ELEMENTS SHALL BE REPAIRED AND/OR REPLACED IN KIND BY THE CONTRACTOR. THE GENERAL CONTRACTOR SHALL BE RESPONSIBLE FOR TEMPORARY BRACING TO SUPPORT EXISTING STRUCTURES WHERE STRUCTURAL ELEMENTS ARE SCHEDULED TO BE
- 7. THE GENERAL CONTRACTOR SHALL BE RESPONSIBLE FOR ALL SAFETY AND SECURITY PRECAUTIONS THROUGHOUT THE DURATION OF THE CONSTRUCTION. B. AFTER DEMOLITION, EXISTING WALLS AND CEILINGS SHALL BE PATCHED AND FINISHED AS NEEDED TO PROVIDE FLAT, SMOOTH SURFACES FOR FINISHING.
- 9. ALL PRESSURE TREATED LUMBER TO BE NON-ARSENIC. 10. SEAL ALL ELECTRICAL, PLUMBING, AND VENTING PENETRATIONS OF THE HOUSE'S EXTERIOR SHELL (WALLS, ROOF, BASEMENT FLOOR, CRAWLSPACE) WITH EXPANDING FOAM ANO/OR CAULK AS APPROPRIATE. 11. CAULK TOP AND BOTTOM PLATES AT ALL EXTERIOR FRAME WALLS OF HOUSE.

- 1. ALL NEW EXTERIOR WALLS SHALL BE 2.X 6 WOOD FRAMING @ 16° O.C. WITH DOUBLE TOP PLATE WITH X° DRYWALL AND ROUNDED CORNER BEAD, SPACKLED AND FINISHED SMOOTH, UNLESS OTHERWISE NOTED.

 2. ALL NEW INTERIOR BEARING WALLS SHALL BE 2.X 4 WOOD FRAMING @ 16° O.C. WITH DOUBLE TOP PLATE WITH X° DRYWALL ON EACH SIDE WITH ROUNDED CORNER BEAD, SPACKLED AND FINISHED SMOOTH, UNLESS OTHERWISE NOTED.

 3. ALL NEW INTERIOR NON-BEARING WALLS SHALL BE 2.X 4 WOOD FRAMING @ 24° O.C. WITH SINGLE TOP PLATE WITH X° DRYWALL ON EACH SIDE WITH ROUNDED CORNER BEAD, SPACKLED AND FINISHED SMOOTH, UNLESS OTHERWISE NOTED.

- 1. GENERAL CONTRACTOR SHALL PROTECT OR REPAIR ALL DISTURBED AREAS PER COUNTY REQUIREMENTS. IT IS THE INTENTION TO AVDID DESTRUCTION OF EXISTING TREES. GENERAL CONTRACTOR SHALL DEMARCATE AN AREA AROUND ALL OWNER-MARKED TREES AND PROTECT THEM FROM ALL CONSTRUCTION ACTIVITIES, AREA OF TREE PROTECTION WILL INCLUDE THE ENTIRE DRIP LINE OF THE TREE DR WITHIN A 10-FEET PERIMETER DR THE TREE, WHICHEVER IS GREATER.
- 2. REMOVE AND DISPOSE OF ALL CONSTRUCTION DEBRIS PER COUNTY AND CITY REQUIREMENTS. 3. STABILIZE SOIL TEMPORARILY AS NECESSARY FOR CONSTRUCTION, PROVIDE EROSION CONTROL MEASURES AROUND ALL DISTURBED EARTH AREAS, INCLUDING SILT FENCING AND TEMPORARY SEEDING AS APPROPRIATE.
- 4. STOCKPILE ALL DISTURBED TOPSOIL, TREE BRANCH CLIPPINGS. REPLACE MINIMUM & INCH DE TOPSOIL AT FINISH GRADE. RE-CONTOUR FINISH GRADE TO SLDPE AWAY FROM BUILDING AT A MINIMUM SLOPE OF 15 DEGREES FOR A MINIMUM DF 2
 FEET FROM THE EXTERIOR WALL AND A MINIMUM SURFACE SLOPE OF 5% WITHIN 10 FEET OF THE HOUSE FOR SURFACE DRAINAGE.
- 5. FINISH GRADE SHALL BE A MINIMUM 1B INCHES FROM ALL NON-PRESSURE TREATED WOOD. 6. VERIFY PROPERTY BOUNDARIES AND LOCATIONS OF ALL UTILITIES PRIOR TO ANY EXCAVATION.

7. SOIL COMPACTION FOR ALL FILLED AREAS SHALL HAVE A MINIMUM COMPACTION OF \$5% OF THE MAXIMUM DRY DENSITY AS DETERMINED BY ASTM 0698 (AASHTO DESIGNATION 1-99). ENERGY EFFICIENCY:

- 1. CEILING:
- 3. EXISTING EXTERIOR WALL:
- - RIGID INSULATION IN-BETWEEN DOUBLE HEADER

HELICON

ARCHITECTS 7108 HOLLY AVENUE TAKOMA PARK, MD 20912

A. BAMBI TRAN, ASSOC. AIA 202.352.4563

STRUCTURAL ENGINEER: D. ANTHONY BEALE, LLC D. ANTHONY BEALE, P.E. BE34 TUTTLE RD SPRINGFIELD VA 22152 202.669.2272

CONSTRUCTION MANAGER: WILLIAM UPDIKE 4202 32ND ST MT. RAINIER, MD 20712 202.367.5649

PROJECT NAME:

7400 MAPLE AVE TAKOMA PARK, MD 20912

PERMIT

11/20/06

TITLE SHEET; SITE PLAN

11/20/2006

 $\frac{1}{4}$ " = 1'-0"

GENERAL DEMOLITION NOTE


UNLESS NOTED, BUILDING MATERIALS (EXCEPT CONCRETE, ASPHALT SHINGLES, PLASTER, WOOD, FIBERGLASS INSULATION) SHOULD BE DENAILED / CLEANED AND STORED ON-SITE-AS DIRECTED BY HOMEOWNERS / AUTHORIZED REPRESENTATIVE-FOR REUSE.

REUSE CONCRETE AND MASONRY FOR FILL TO MAXIMUM EXTENT POSSIBLE ON SITE.

RECYCLE CONCRETE, ASPHALT SHINGLES, METAL, AND WOOD TO THE MAXIMUM EXTENT POSSIBLE.

DISPOSE PLASTER AND NON-REUSABLE FIBERGLASS INSULATION IN LANDFILL.

PROVIDE PLANT PROTECTION AS NEEDED.

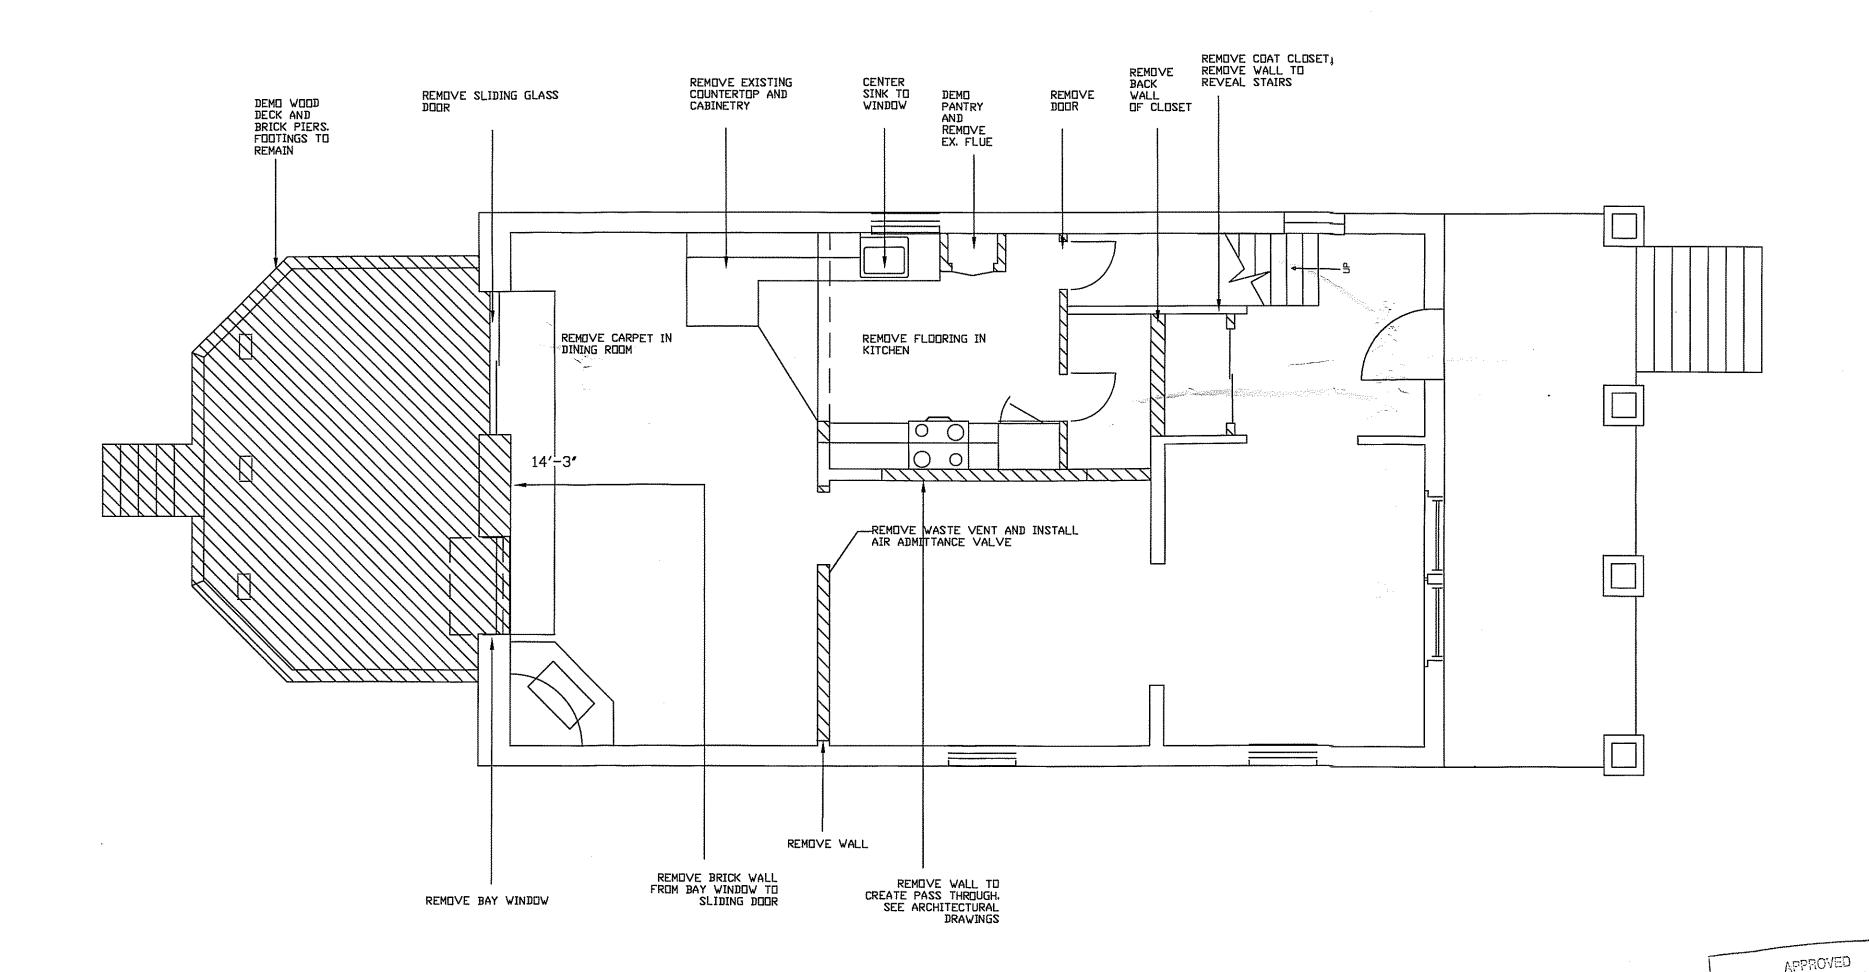



FIRST FLOOR DEMOLITION PLAN

SCALE: $\frac{1}{4}$ " = 1'-0"

HELICON WORKS

ARCHITECTS

7108 HOLLY AVENUE TAKOMA PARK, MD 20912

W. WILLIAM HUTCHINS, AIA 301.404.5578

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202.669.2272

CONSTRUCTION MANAGER:
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MT. RAINIER, MD 20712
202.367.5648

PROJECT NAME:

BORZEKOWSKI RESIDENCE 7400 MAPLE AVE TAKOMA PARK, ND 20912

OWN

DINA BORZEKOWSKI RON BORZEKOWSKI 7400 MAPLE AVE TAKOMA PARK, MD 20912 301.270.4198

ISSUES:

/06

SHEET TITLE

FIRST FLOOR DEMOLITION PLAN


,

DATE: 11/20/2006

SCALE: 1/11 43

xue ¼" = 1'-0"



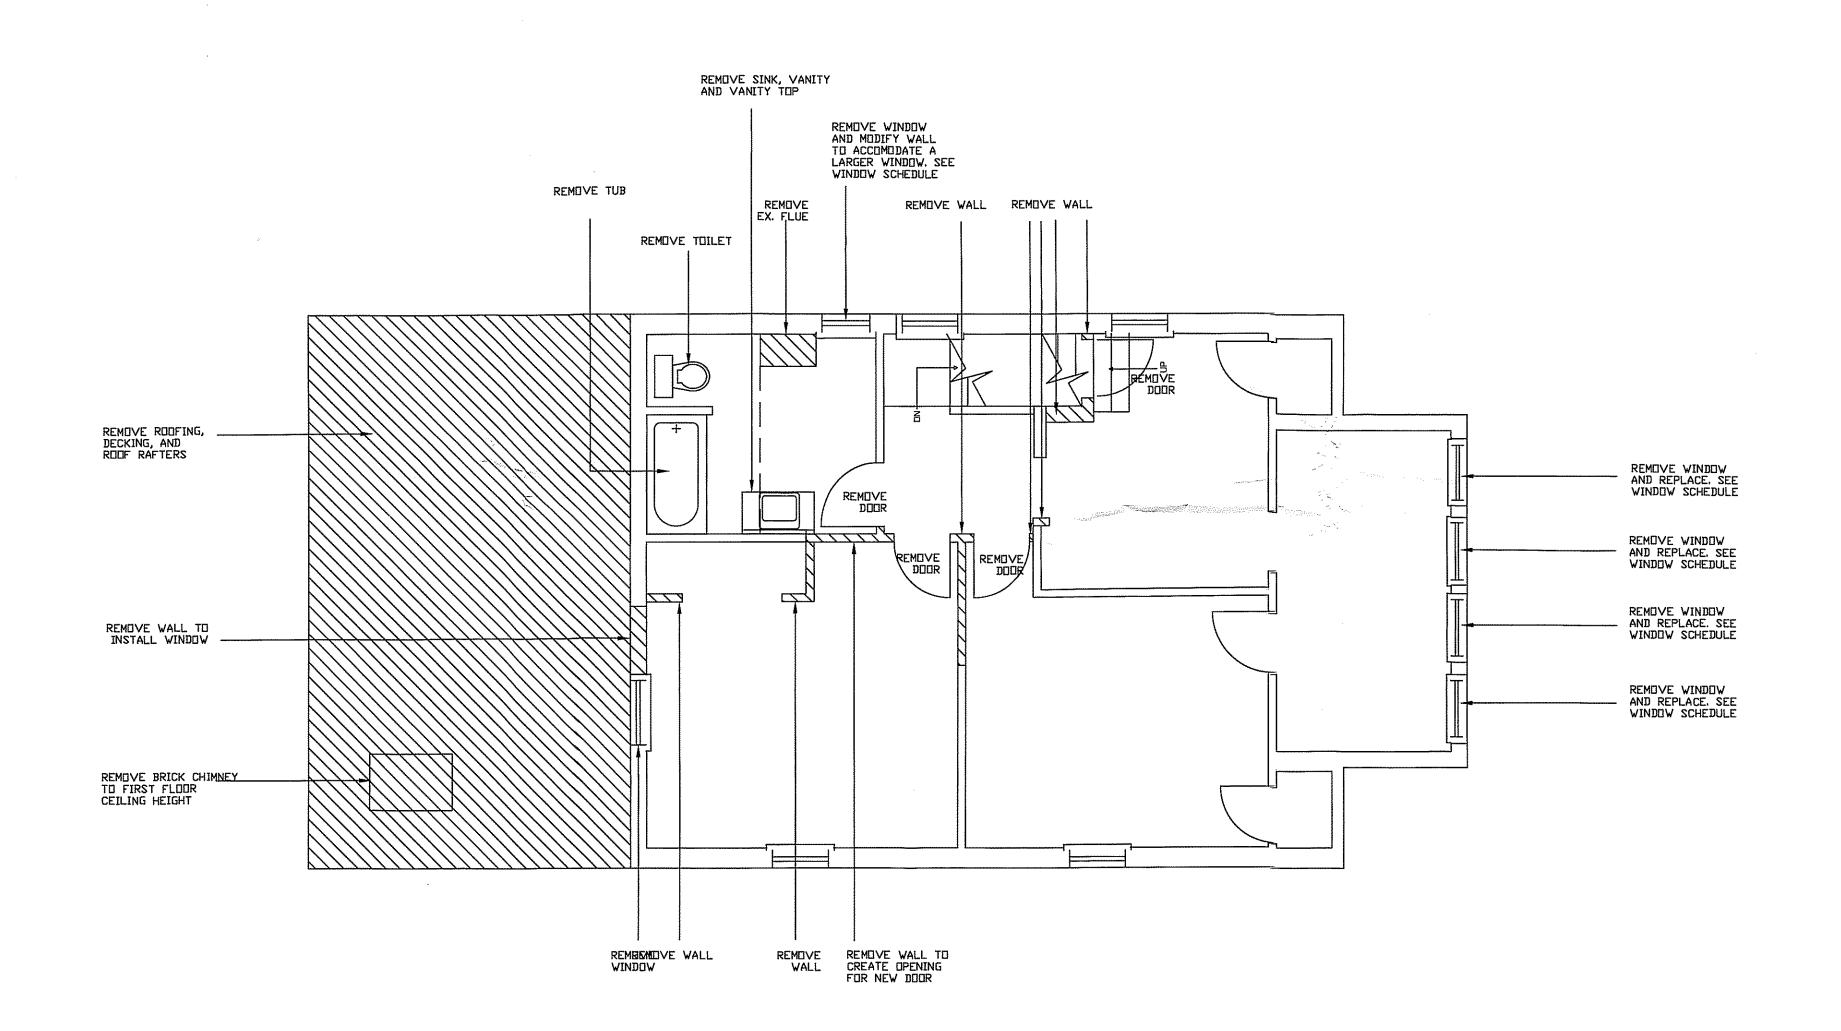

ARCHITECTS

7108 HOLLY AVENUE TAKOMA PARK, MD 20912

W. WILLIAM HUTCHINS, AIA 301.404.5578

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PROJECT NAME:

BORZEKOWSKI RESIDENCE 7400 MAPLE AVE

TAKOMA PARK, MD 20912

OWNE

DINA BORZEKOWSKI RON BORZEKDWSKI 7400 MAPLE AVE TAKOMA PARK, MD 20912 301.270.4198

ISSUES:

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SHEET TITLE:

SECOND FLOOR DEMOLITION PLAN

BY:


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CALE: 1'-0"

A-2

SECOND FLOOR DEMOLITION PLAN

SCALE: $\frac{1}{4}$ " = 1'-0"

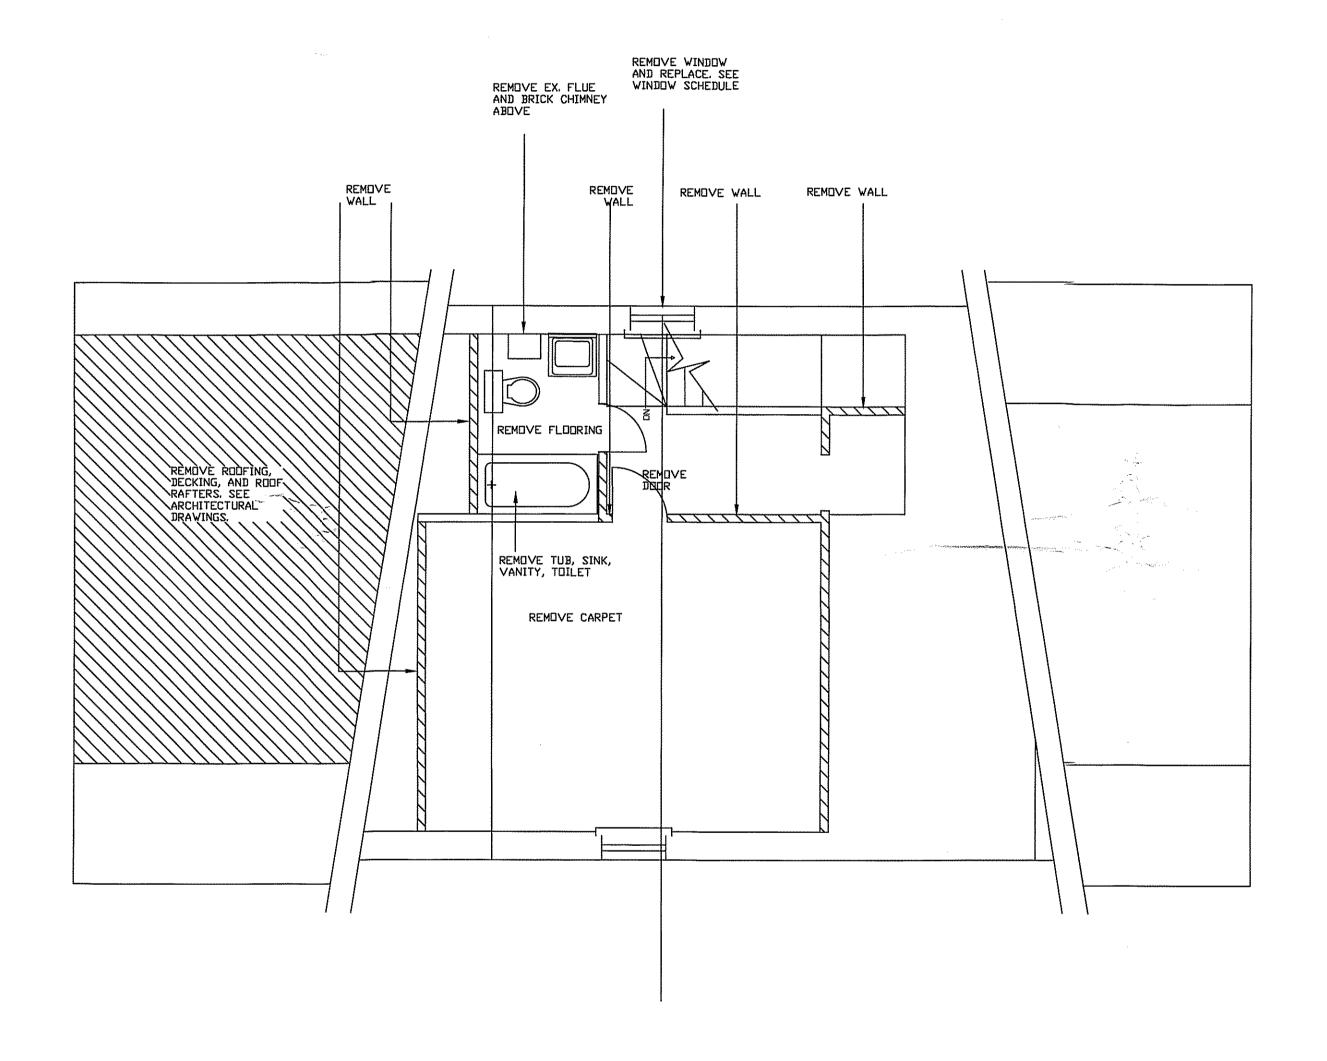

A THIRD FLOOR DEMOLITION PLAN

SCALE: $\frac{1}{4}$ " = 1'-0"

HELICON WORKS

ARCHITECTS

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ISSUES:

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SHEET TITE


THRID FLOOR DEMOLITION PLAN


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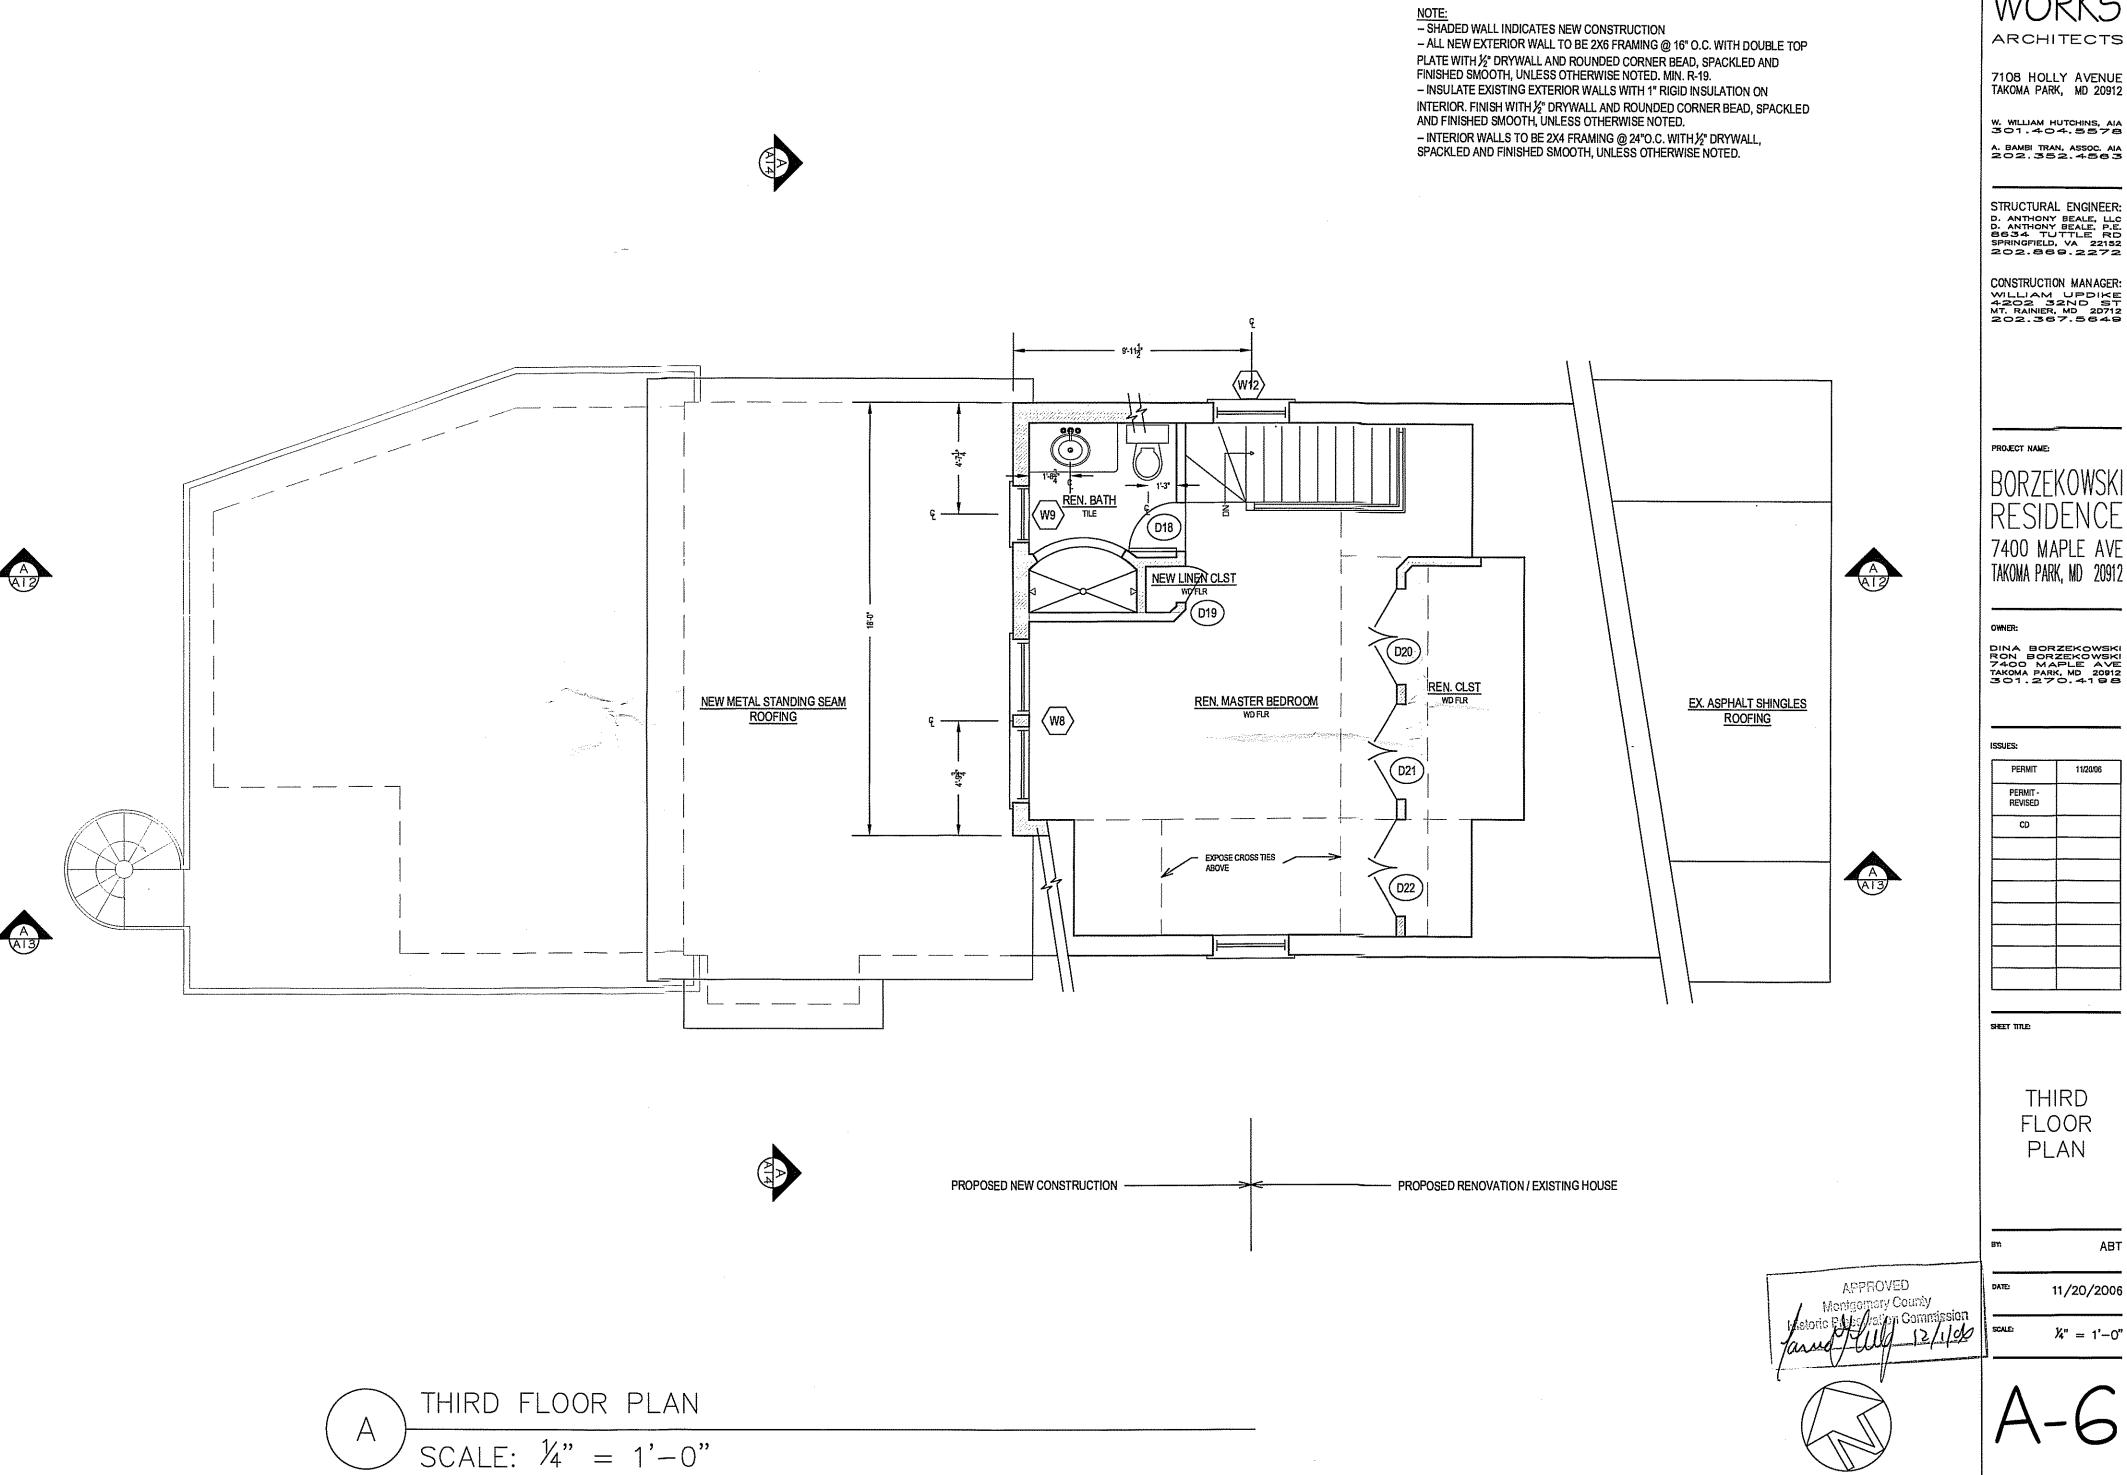
ECALE: 1'-0"

 $\Delta_{-}3$



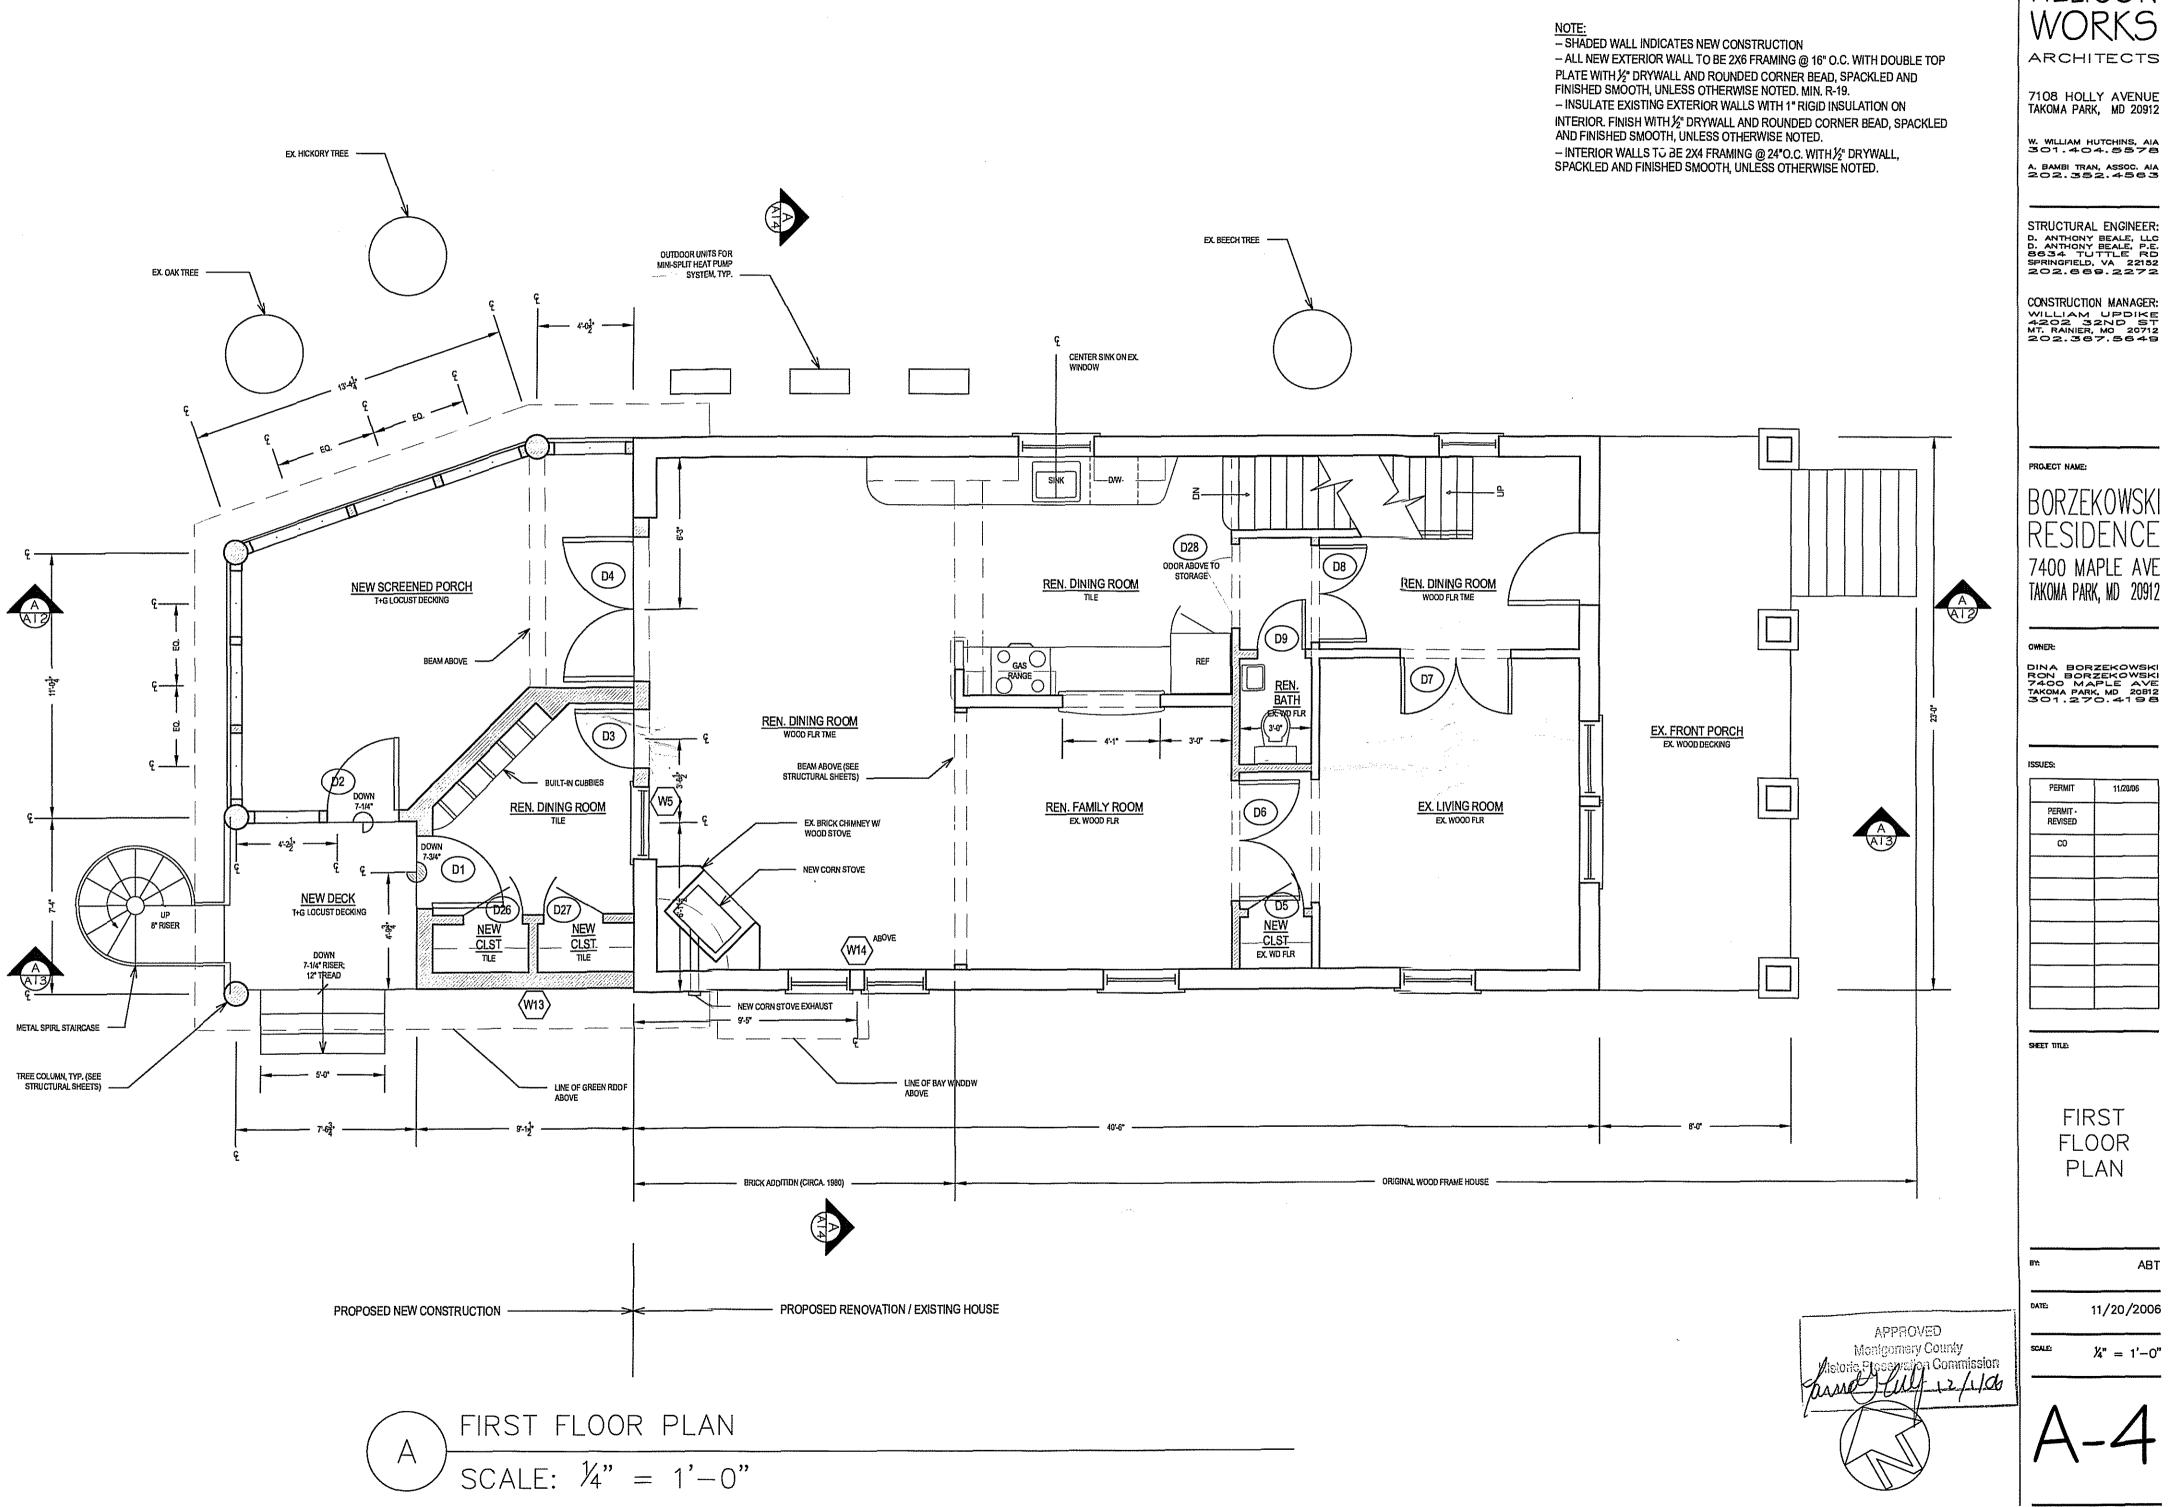

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ARCHITECTS

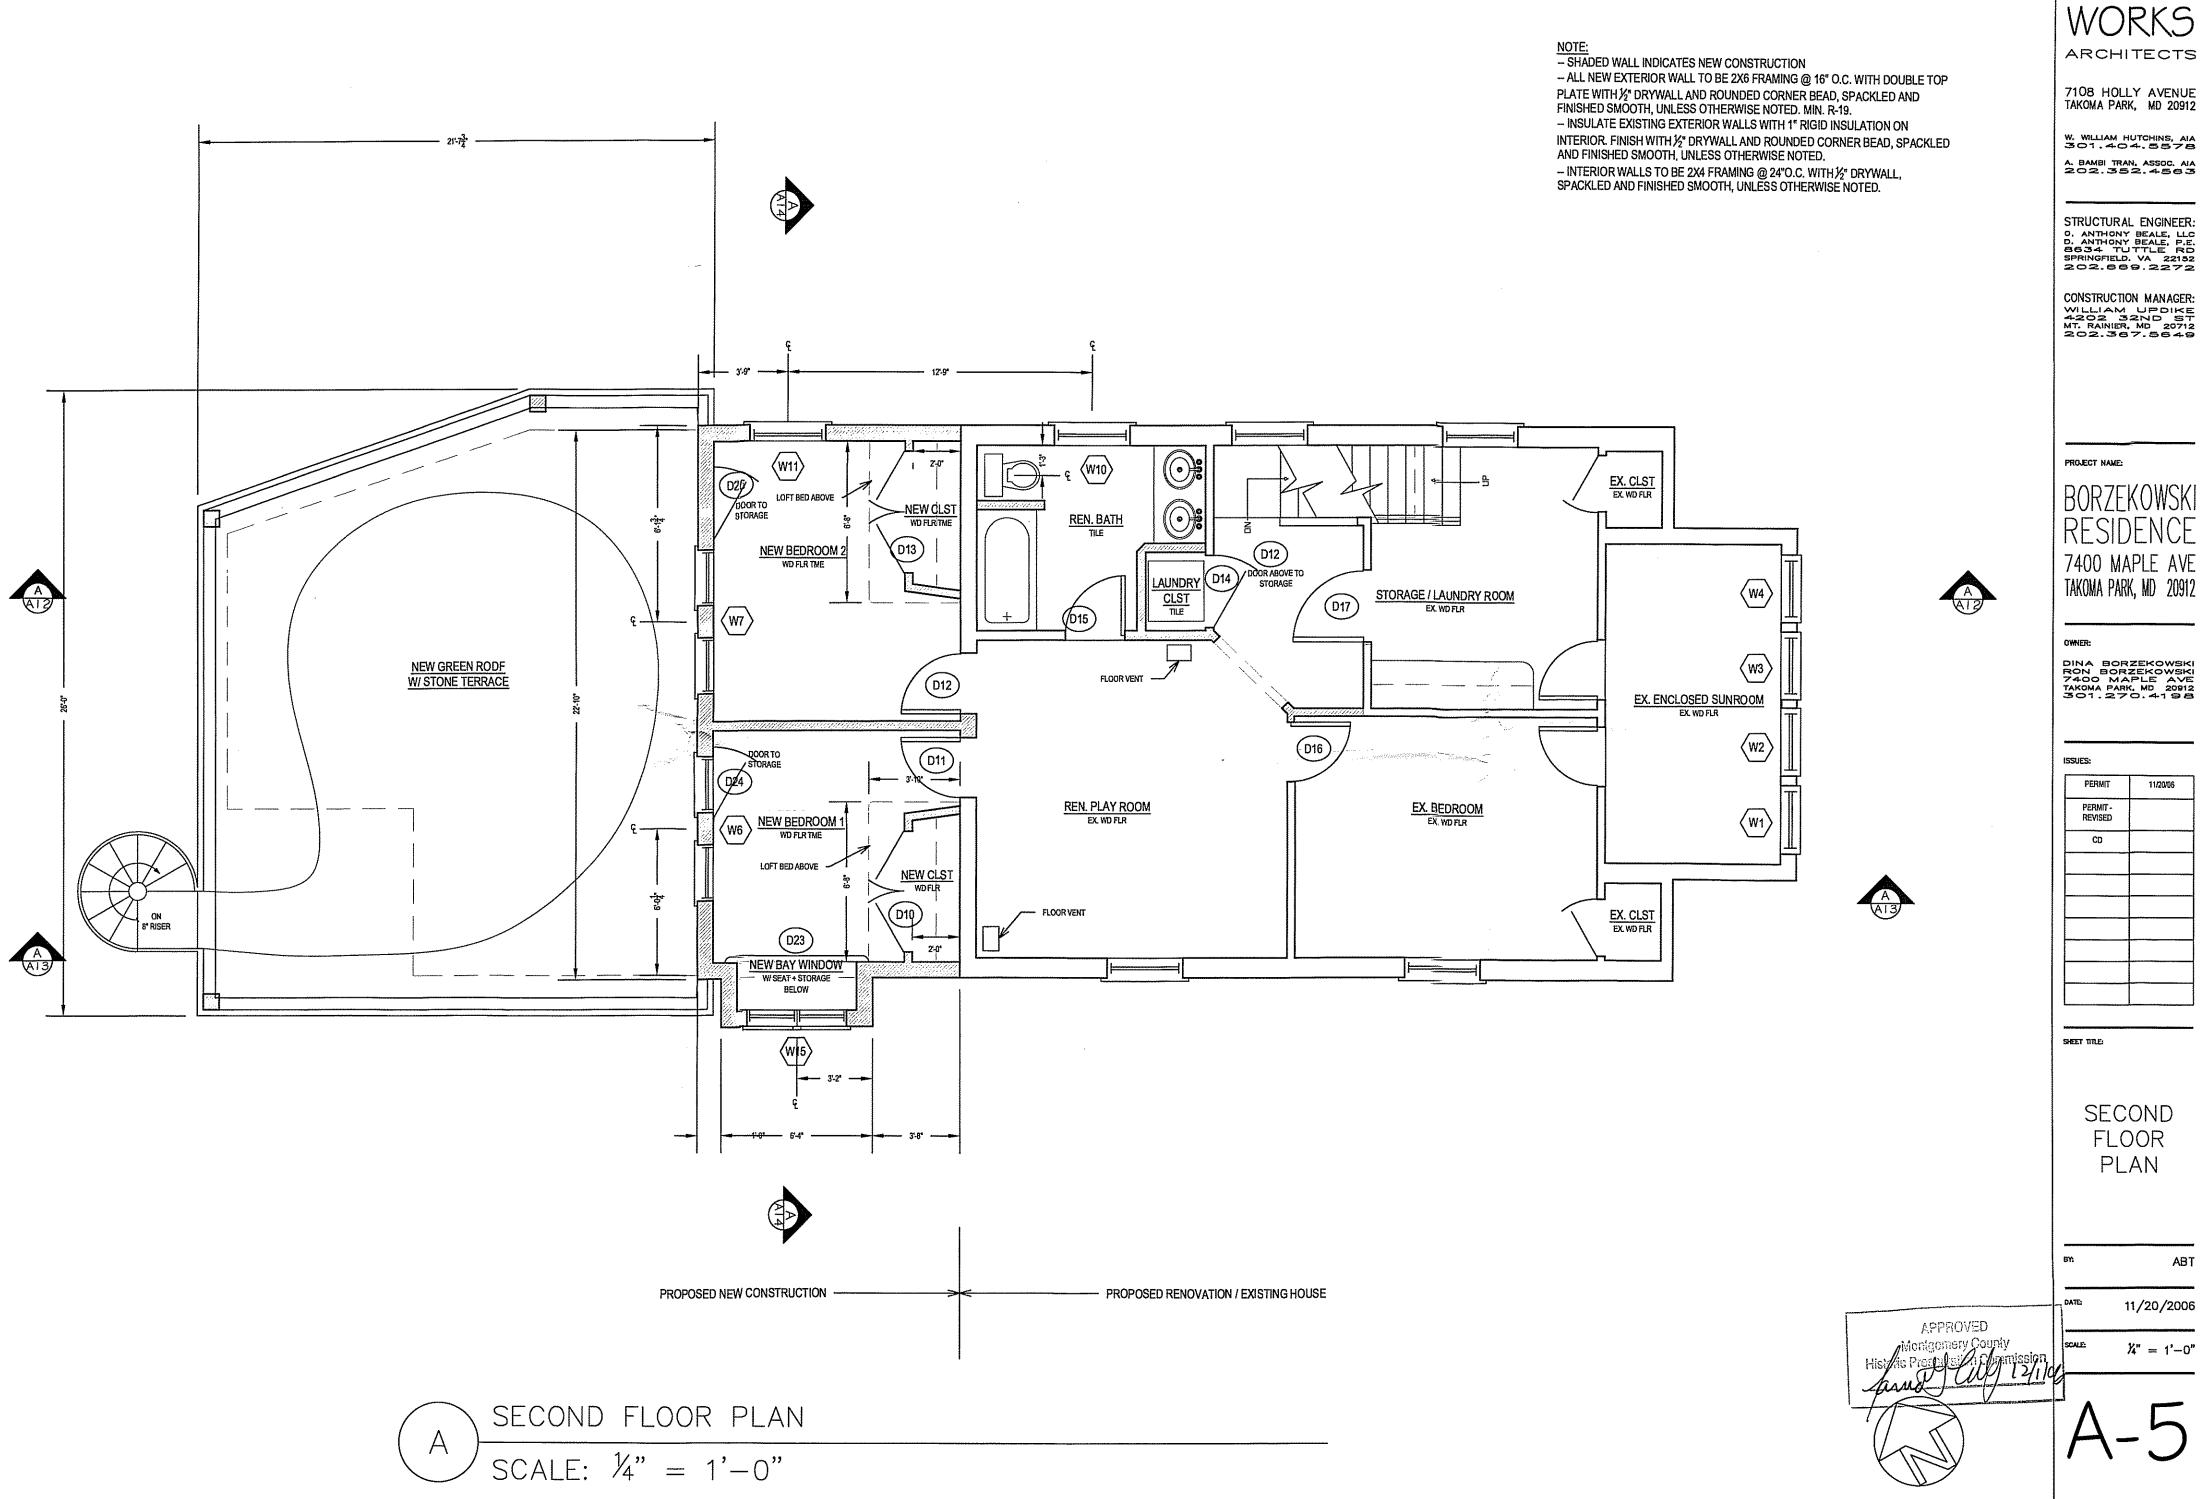7108 HOLLY AVENUE TAKOMA PARK, MD 20912

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BORZEKOWSKI RESIDENCE 7400 MAPLE AVE

DINA BORZEKOWSKI RON BORZEKOWSKI 7400 MAPLE AVE TAKOMA PARK, MD 20912 301.270.4198

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THIRD FLOOR PLAN

11/20/2006

 $\frac{1}{4}$ " = 1'-0"

MIND	OW SCHEDULE					
			UNITSI	ZE (IN.)	GLAZING	
WINDOW		SILL HEIGHT (IN.)	WIDTH	HEIGHT	AREA (SF)	NOTES
W1	2ND FLR FRONT BAY	TME	TME	TME		3,10
W2	2ND FLR FRONT BAY	TME	TME	TME		3,10
W3	2ND FLR FRONT BAY	TME	TME	TME		3,10
W4	2ND FLR FRONT BAY	TME	TME	TME		3,10
W5	DINING ROOM		37	59	11.7	3,9,10
W6	BEDROOM 1	54	58	53	16	2,7
W7	BEDROOM 2	54	58	53	16	2,7
8W	MASTER BEDROOM	49	58	47	14	2,7
Wg	MASTER BA	49	29	115.9	7	1
W10	2ND FLR BA	30	33	53	9.1	3,10
W11	BEDROOM 2	48	37	57	11.3	3,10
W12	3RD FLOOR STAIRS	TME	TME	TME		3,11
W13	MUD ROOM	SEE ELEVATION	47	29	7	4
W 14	DINING ROOM	SEE ELEVATION	70	29	10	4,13
W15	BAY WINDOW	6 ABOVE SEAT	50	47	11.4	3,10,12
W16	MASTER BEDROOM	SEE ELEVATION	25	14	2.4	5

	Windows to be double-paned, wood or aluminum clad wood, low-e, argon filled
	U-value max. 0.4; air leakage rate of less than 0.3 cfm/sf
1	casement
2	double casement
3	double hung
4	awning
5	fixed
6	safety glass
7	egress
8	match head height to other windows in room
9	align with door head
10	wood simulated divided light
11	wood replacement sash
12	double double bung

UNIT SIZE (IN.)

13 double awning

DOOR SCHEDULE

7 safety glazing 8 cabinet door

9 threshold as required for weather seal

DOOR#	LOCATION	TYPE	WIDTH	HEIGHT	GLAZING	THRESHOLD	NOT
D1	MUD ROOM	EXTERIOR	30	80		METAL OR WOOD	2
D2	SCREENED PORCH	EXTERIOR	36	80			4
D3	MUD ROOM	EXTERIOR	30	80		METAL OR WOOD	2,
D4	DINING ROOM	EXTERIOR	72	80	FULL		3,
50 D5	DINING ROOM	INTERIOR	60	80			6
D6	CLOSET	INTERIOR	28	80			
D7	LIVING ROOM	INTERIOR	TME	TME		EX?	6
D8	ENTRY HALLWAY	INTERIOR	48	80			6
D9	HALF BATH	INTERIOR	24	80		SANITARY	
D10	BEDROOM 1	INTERIOR	60	62			2
D11	BEDROOM 1	INTERIOR	30	80			9
D12	BEDROOM 2	INTERIOR	30	80			9
D13	BEDROOM 2	INTERIOR	60	62			2
D14	2ND FLR BA	INTERIOR	36	80			
D15	2ND FLR BA	INTERIOR	30	80		SANITARY	
D16	BEDROOM 3	INTERIOR	30	80			1
D17	LAUNDRY ROOM	INTERIOR	36	80			
D18	MASTER BA	INTERIOR	24	80		SANITARY	1
D19	LINEN CLOSET	INTERIOR	18	80			
D20	MASTER BEDROOM	INTERIOR	48	80			6
D21	MASTER BEDROOM	INTERIOR	48	80			6
D22	MASTER BEDROOM	INTERIOR	48	80			6
D23	BAY WINDOW	INTERIOR	TBDIF	TBDIF			8
D24	BEDROOM 1	INTERIOR	TBDIF	TBDIF			8
D25	BEDROOM 2	INTERIOR	TBDIF	TBDIF			8
D26	MUD ROOM	INTERIOR	30	80			
D27	MUD ROOM	INTERIOR	30	80	<u> </u>		
D28	KITCHEN	INTERIOR	TBDIF	TBDIF			8
D29	2ND ELD HALLWAY	INTERIOR	TRDIE	TROIL	 		8


D9 HALF BATH INTERIOR 24 80 SANITARY D10 BEDROOM 1 INTERIOR 60 62 2 D11 BEDROOM 1 INTERIOR 30 80 9 D12 BEDROOM 2 INTERIOR 30 80 9 D13 BEDROOM 2 INTERIOR 60 62 2
D11 BEDROOM 1 INTERIOR 30 80 9 D12 BEDROOM 2 INTERIOR 30 80 9
D12 BEDROOM 2 INTERIOR 30 80 9
327.707.1
D13 BEDROOM 2 INTERIOR 60 62 2
D14 2ND FLR BA INTERIOR 36 80
D15 2ND FLR BA INTERIOR 30 80 SANITARY
D16 BEDROOM 3 INTERIOR 30 80 1
D17 LAUNDRY ROOM INTERIOR 36 80
D18 MASTER BA INTERIOR 24 80 SANITARY 1
D19 LINEN CLOSET INTERIOR 18 80
D20 MASTER BEDROOM INTERIOR 48 80 6
D21 MASTER BEDROOM INTERIOR 48 80 6
D22 MASTER BEDROOM INTERIOR 48 80 6
D23 BAY WINDOW INTERIOR TBDIF TBDIF 8
D24 BEDROOM 1 INTERIOR TBDIF TBDIF 8
D25 BEDROOM 2 INTERIOR TBDIF TBDIF 8
D26 MUD ROOM INTERIOR 30 80
D27 MUD ROOM INTERIOR 30 80
D28 KITCHEN INTERIOR TBDIF TBDIF 8
D29 2ND FLR HALLWAY INTERIOR TBDIF TBDIF 8
NOTES:
Exterior doors to be solid wood with insulated, low-e glazing. All exterior doors shall be keyed alike. Interior doors to be solid wood, style to be approved by Owner.
Interior doors to be solid wood, style to be approved by Owner. Interior door hardware shall be selected by Owner and provided and installed by Contractor.
1 existing unit in new location
1 existing unit in new location 2 extenor door glazing to be double glazed
3 french door
4 screened door
5 threshold as required for finish floor transition

- SHADED WALL INDICATES NEW CONSTRUCTION - ALL NEW EXTERIOR WALL TO BE 2X6 FRAMING @ 16" O.C. WITH DOUBLE TOP PLATE WITH 1/2" DRYWALL AND ROUNDED CORNER BEAD, SPACKLED AND FINISHED SMOOTH, UNLESS OTHERWISE NOTED. MIN. R-19.

- INSULATE EXISTING EXTERIOR WALLS WITH 1" RIGID INSULATION ON INTERIOR. FINISH WITH ½" DRYWALL AND ROUNDED CORNER BEAD, SPACKLED AND FINISHED SMOOTH, UNLESS OTHERWISE NOTED.

- INTERIOR WALLS TO BE 2X4 FRAMING @ 24"O.C. WITH ½" DRYWALL, SPACKLED AND FINISHED SMOOTH, UNLESS OTHERWISE NOTED.

- HEAT PROVIDED VIA EXISTING BOILER IN BASEMENT.

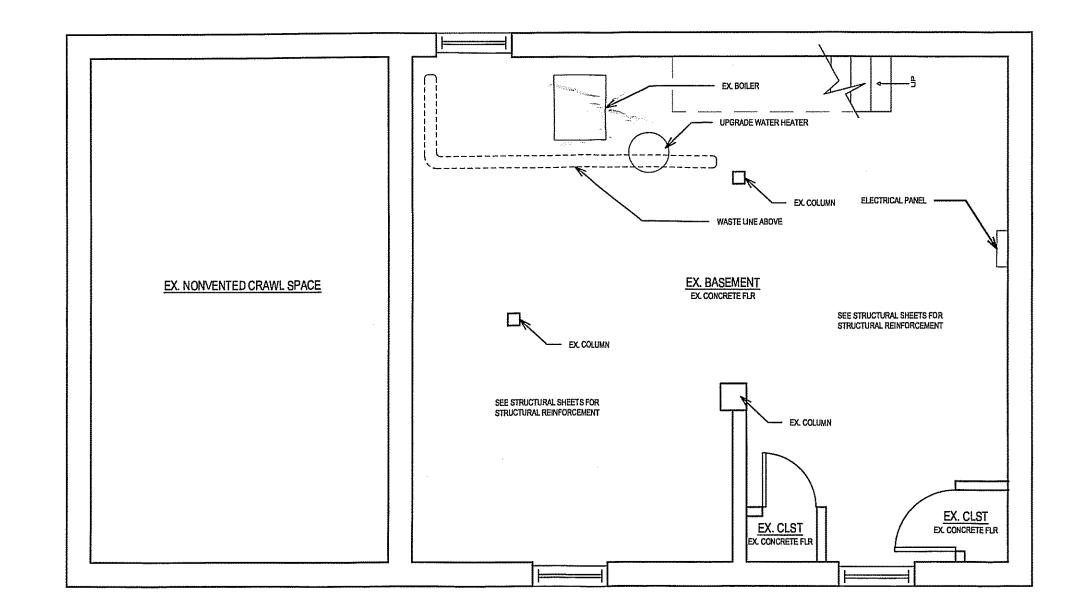



BASEMENT PLAN SCALE: $\frac{1}{4}$ " = 1'-0"

11/20/2006 $\frac{1}{4}$ " = 1'-0"

ARCHITECTS

7108 HOLLY AVENUE TAKOMA PARK, MD 20912

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7400 MAPLE AVE

TAKOMA PARK, MD 20912

DINA BORZEKOWSKI RON BORZEKOWSKI 7400 MAPLE AVE TAKOMA PARK, MD 20912 301.270.4198

11/20/06

ISSUES:

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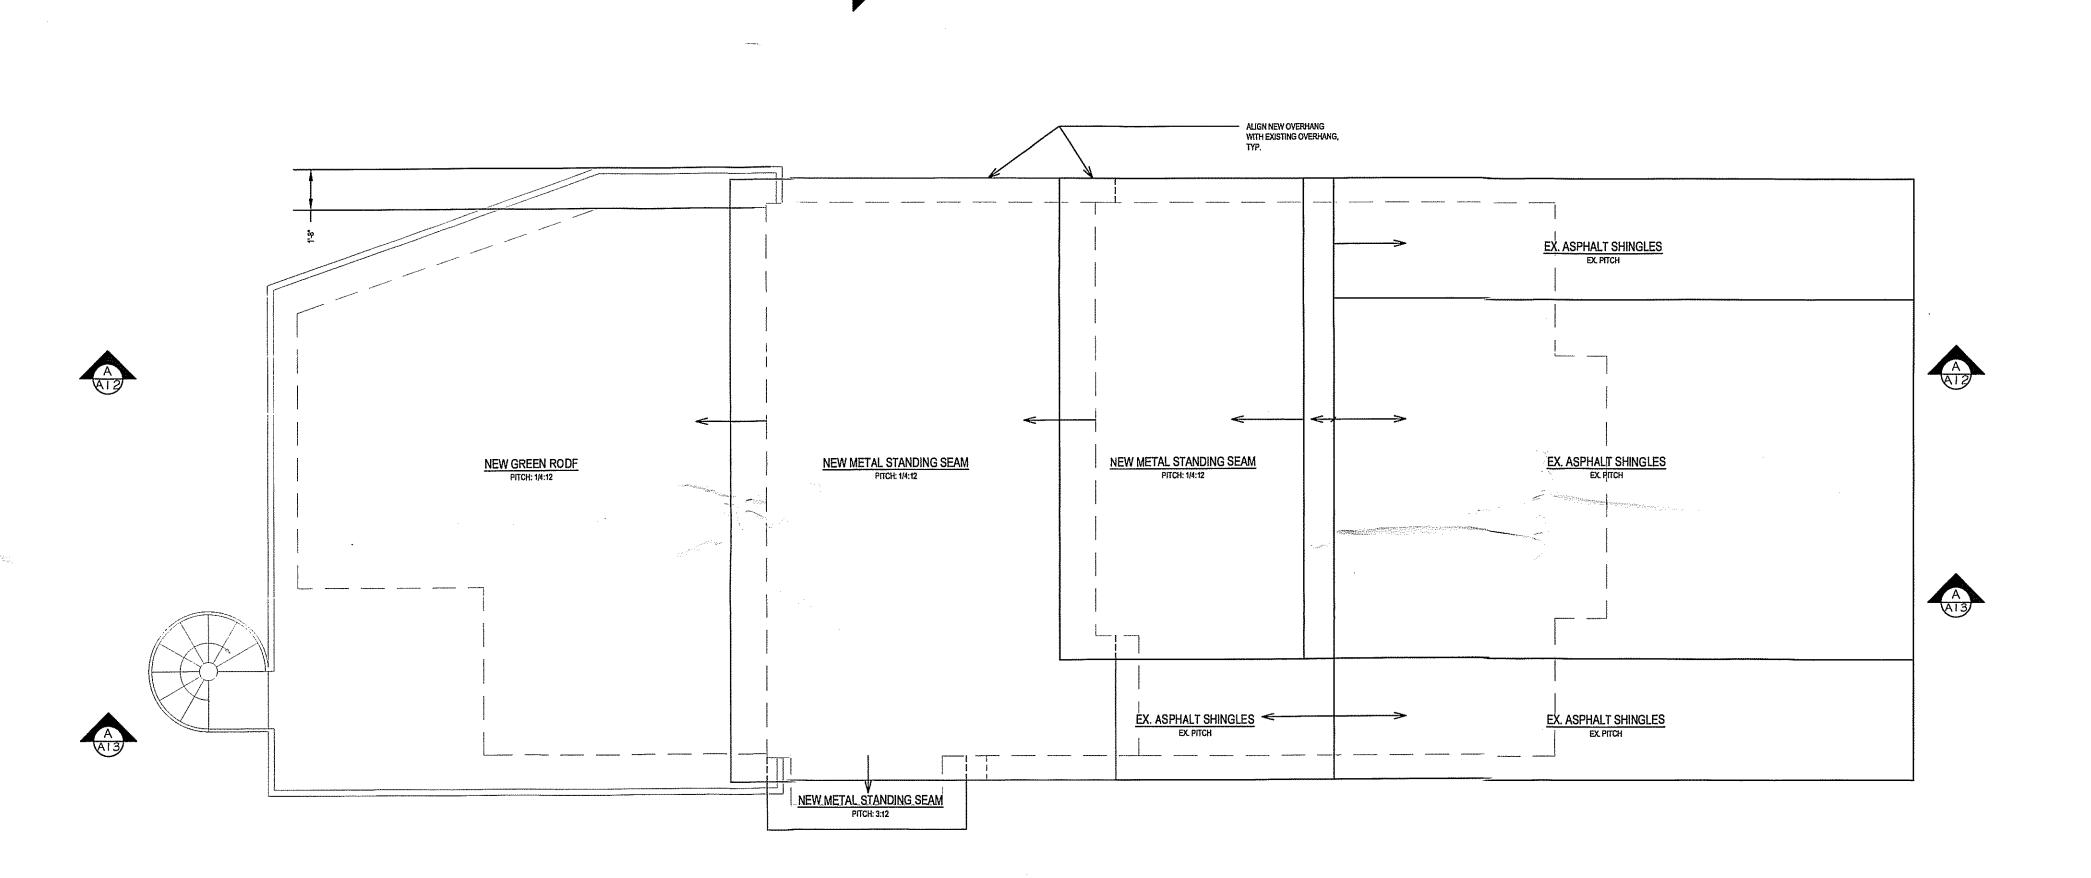
BASEMENT

PLAN

ABT

PROJECT NAME:





ROOF PLAN

SCALE: $\frac{1}{4}$ " = 1'-0"

HELICON WORKS

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PROJECT NAME:

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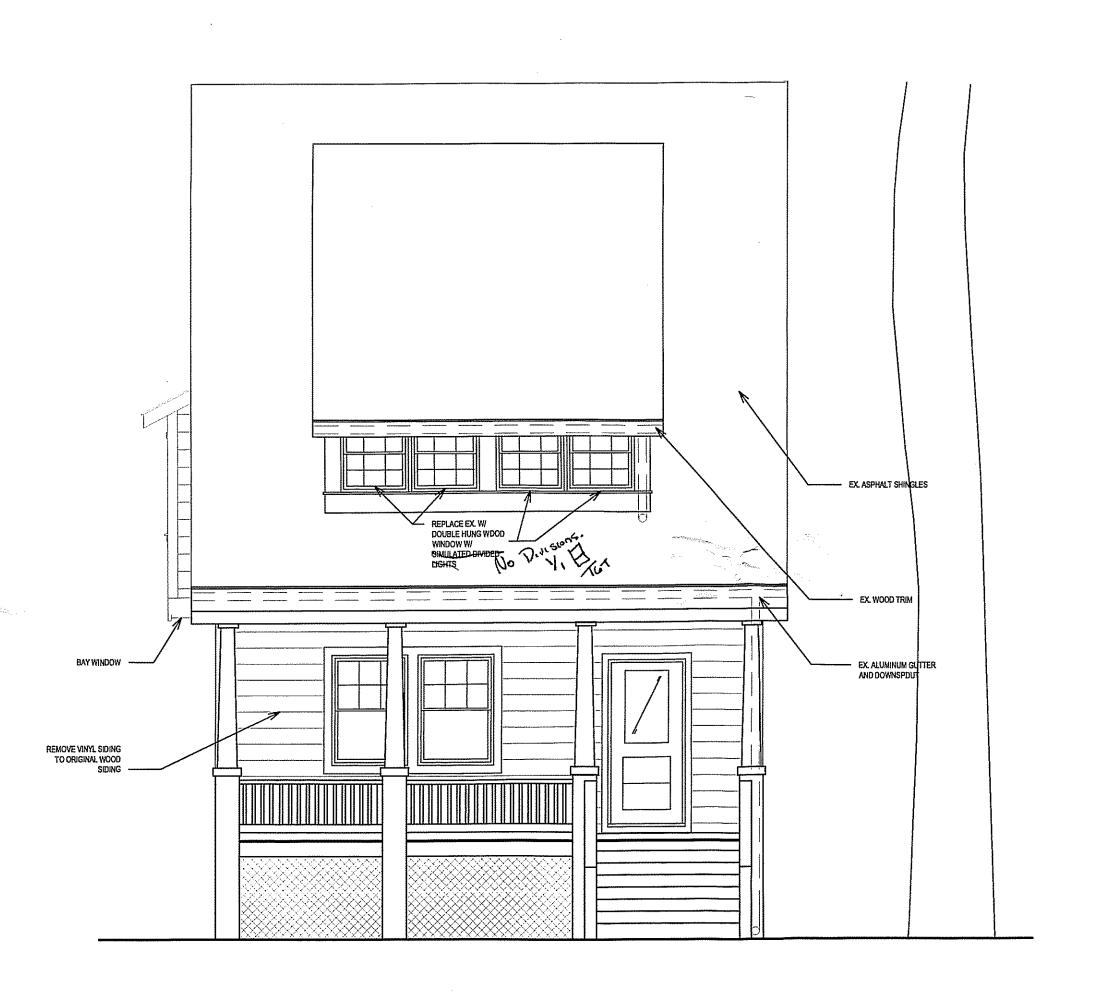
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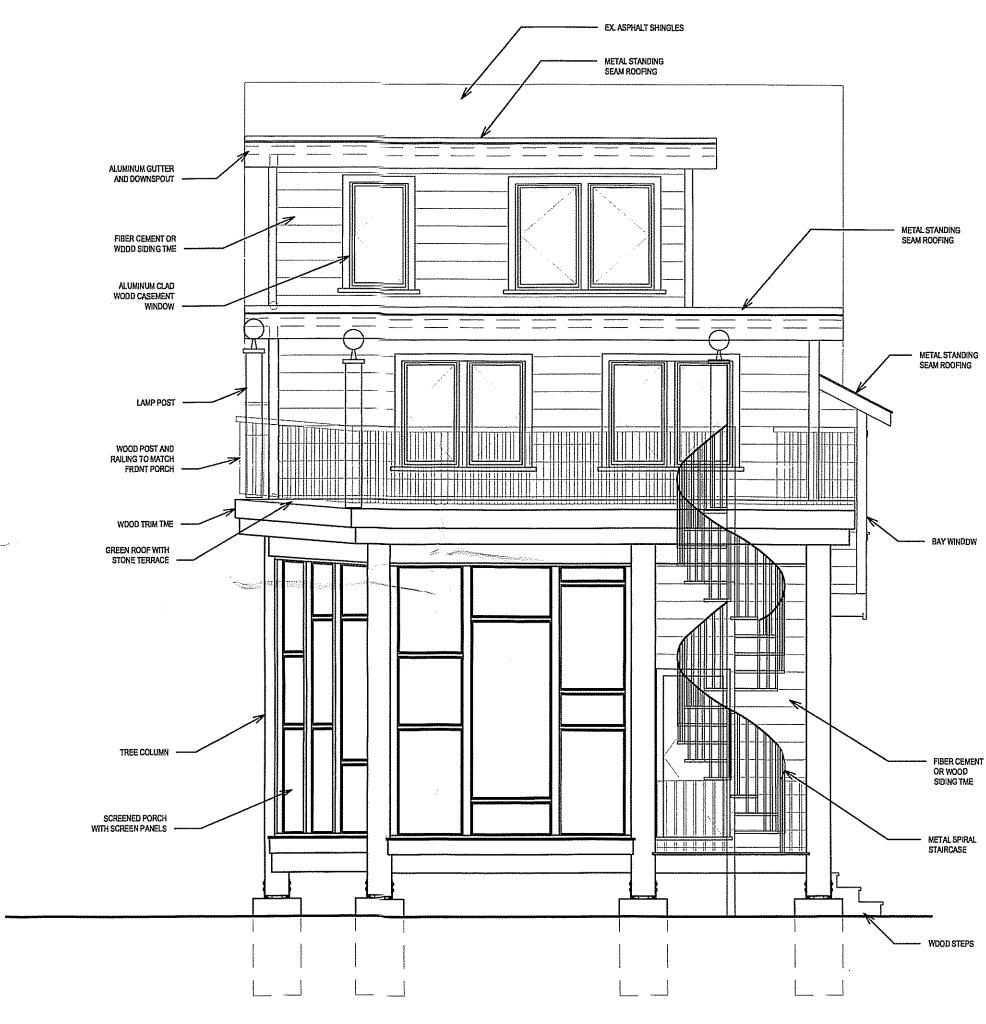
ROOF PLAN

11/20/2006

¼" = 1'-0"

A-8





ELEVATION: FRONT

SCALE: $\frac{1}{4}$ " = 1'-0"

ELEVATION: BACK (WITH TYPICAL NOTES)

SCALE: $\frac{1}{4}$ " = 1'-0"

ARCHITECTS

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PROJECT NAME:

7400 MAPLE AVE

TAKOMA PARK, MD 20912

DINA BORZEKOWSKI RON BORZEKOWSKI 7400 MAPLE AVE TAKOMA PARK, MD 20912 301.270.4198


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SHEET TITLE:

ELEVATION: FRONT AND BACK

11/20/2006

 $\frac{1}{4}$ " = 1'-0"

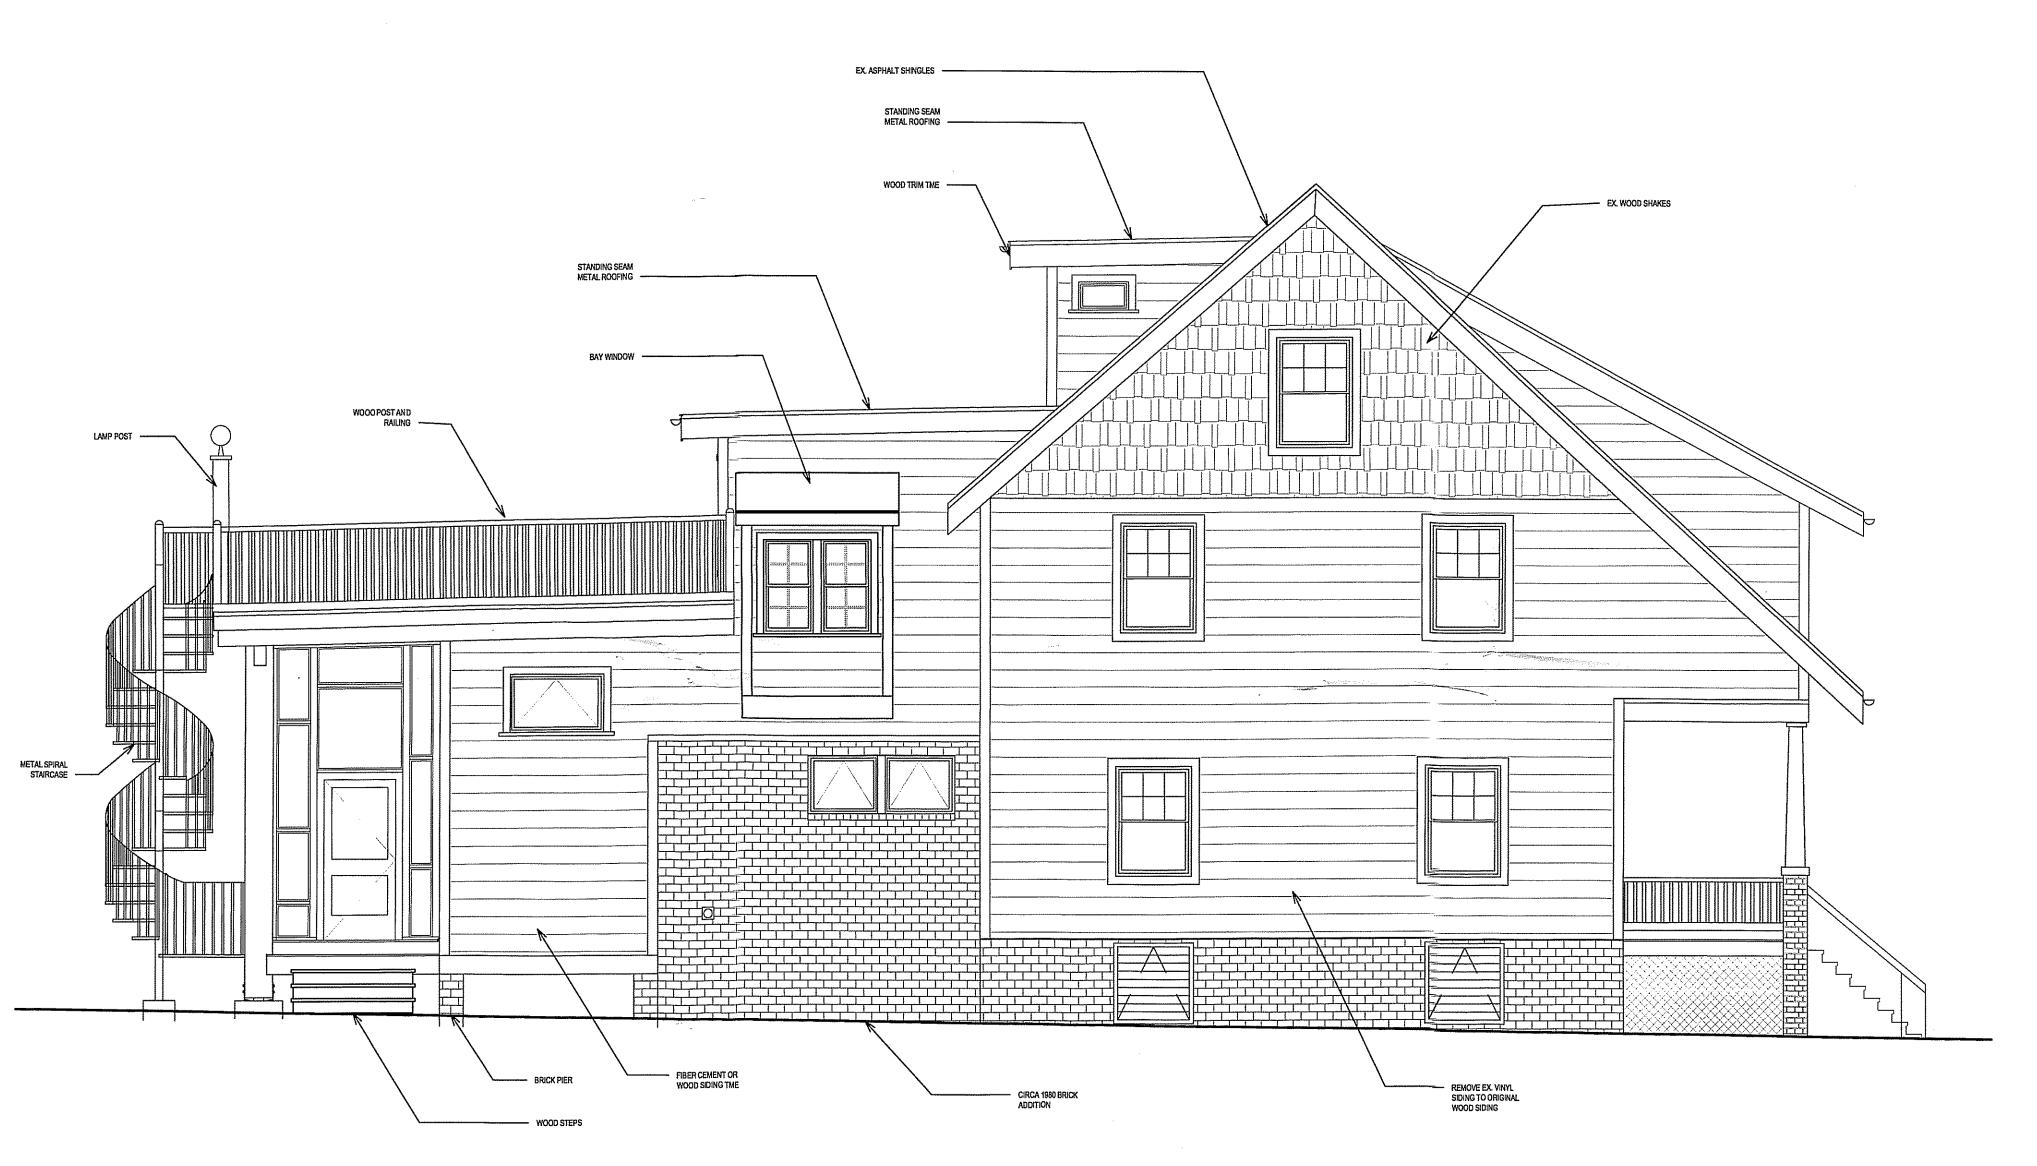

ELEVATION: SIDE (SOUTHWEST) (WITH TYPICAL NOTES)

SCALE: $\frac{1}{4}$ " = 1'-0"

HELICON WORKS

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202.367.5649

PROJECT NAME:

BORZEKOWSKI RESIDENCE 7400 MAPLE AVE

TAKOMA PARK, MD 20912

OWNE

DINA BORZEKOWSKI RON BORZEKOWSKI 7400 MAPLE AVE TAKOMA PARK, MO 20912 301.270.4198

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SHEET III


ELEVATION: SIDE (SOUTHWEST)

AE

DATE: 11/20/2006

scale: ¼" = 1'-0"

A-10

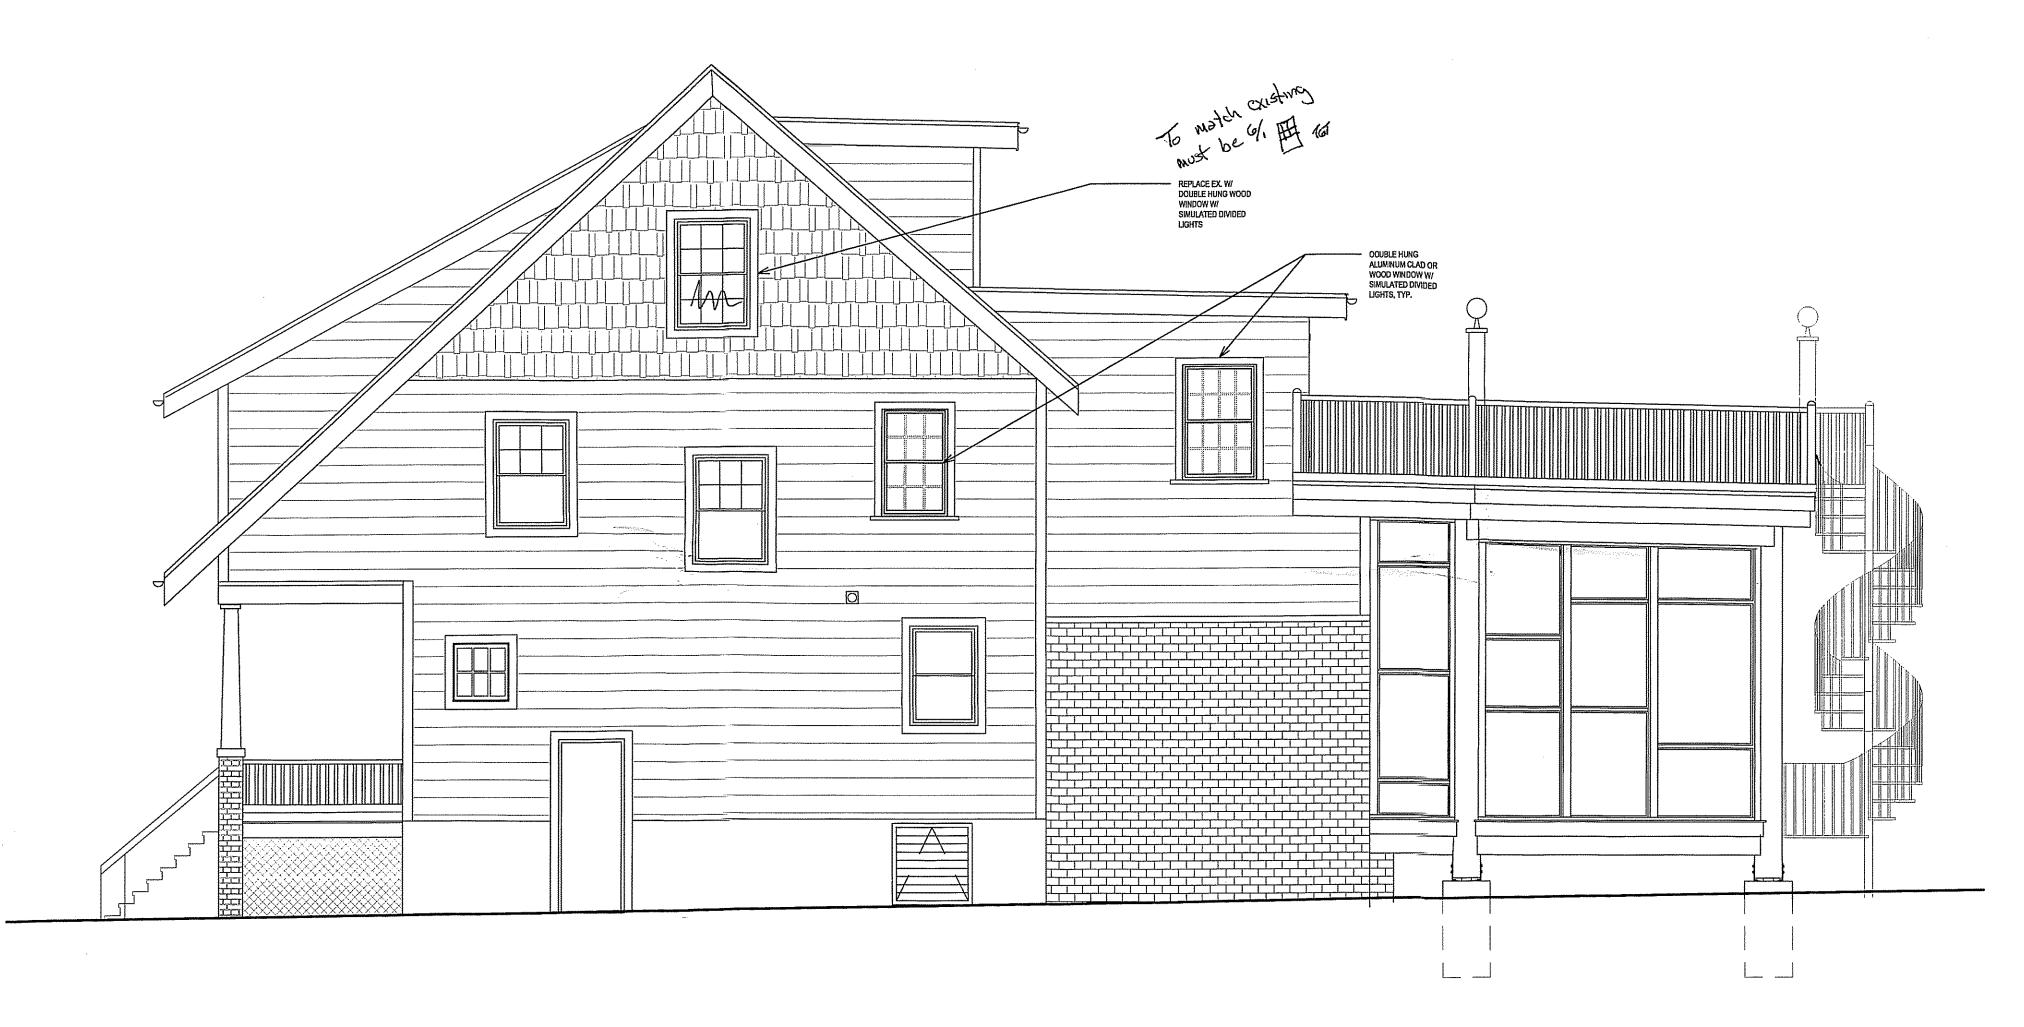

A ELEVATION: SIDE (NORTHEAST)

 $^{\prime}$ SCALE: $\frac{1}{4}$ " = 1'-0"

HELICON WORKS ARCHITECTS

7108 HOLLY AVENUE TAKOMA PARK, MD 20912

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PROJECT NAME:

BORZEKOWSKI RESIDENCE 7400 MAPLE AVE TAKOMA PARK, MD 20912

TANUMA PARK, MU ZU

DINA BORZEKOWSKI RON BORZEKOWSKI 7400 MAPLE AVE TAKOMA PARK, MD 20812 301.270.4198

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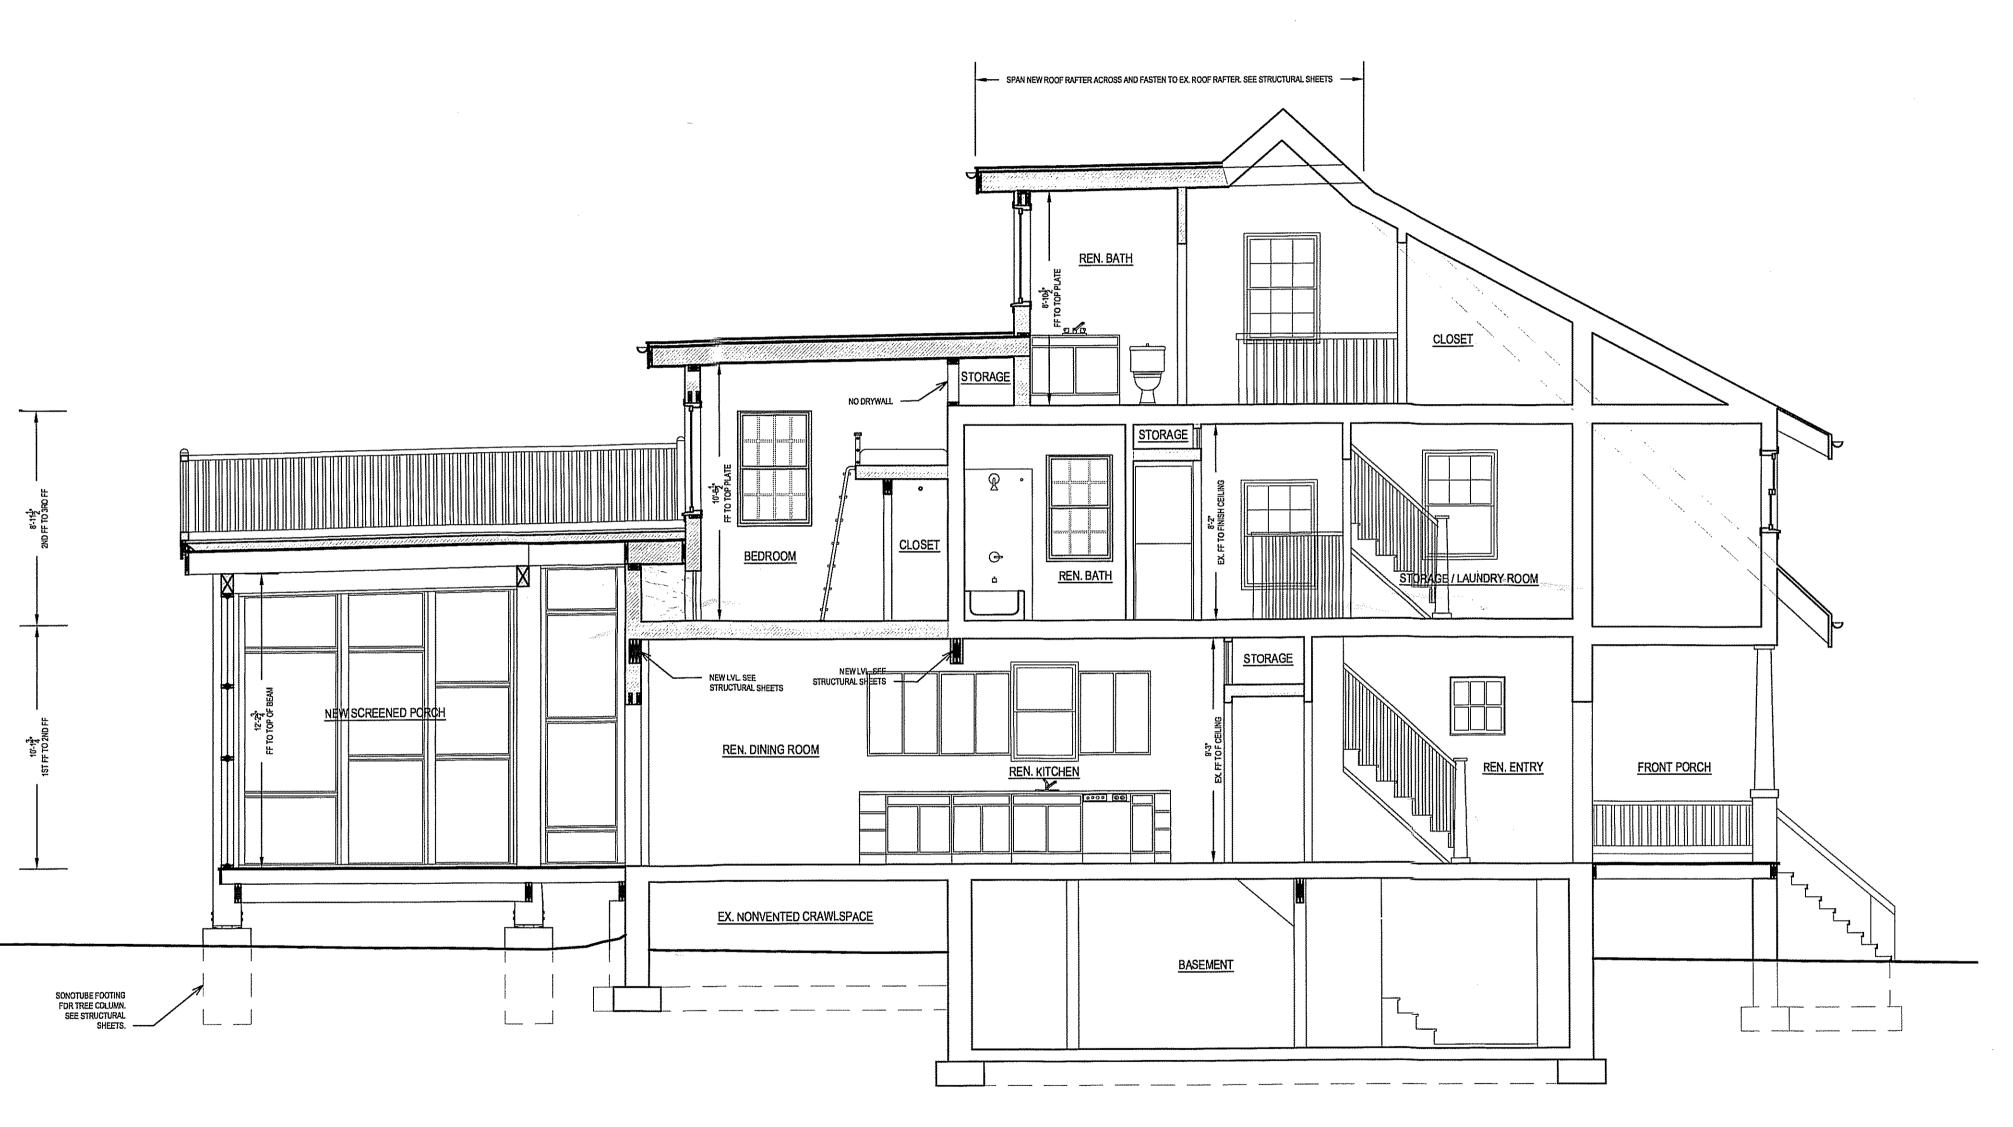
ELEVATION: SIDE (NORTHEAST)

Yr.

11/20/2006

%E: ¼" = 1'-0"

A-11



ARCHITECTS

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PROJECT NAME:

BORZEKOWSKI RESIDENCE 7400 MAPLE AVE

TAKOMA PARK, MD 20912

AMARIED.

DINA BORZEKOWSKI RON BORZEKOWSKI 7400 MAPLE AVE TAKOMA PARK, MD 20912 301,270.4198

ISSUES:

PERMIT	11/20/06
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CD	

SHEET TITLE:

SECTION: SCREENED PORCH -KITCHEN

,

11/20/2006

 $\chi'' = 1' - 0''$

APPROVED

Montgomery Gounty

Historio (Tester) Life Commission

August 12/1/06

SECTION: SCREENED PORCH - KITCHEN (WITH TYPICAL SOLE) 1/4" = 1'-0"



SECTION: MUD ROOM - DINING ROOM

SCALE: $\frac{1}{4}$ " = 1'-0"

HELICON WORKS

ARCHITECTS

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202.367.5649

PROJECT NAME:

BORZEKOWSKI RESIDENCE

7400 MAPLE AVE TAKOMA PARK, MD 20912

OWNER

DINA BORZEKOWSKI RON BORZEKOWSKI 7400 MAPLE AVE TAKOMA PARK, MD 20912 301.270.4198

ISSU

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PERMIT - REVISED	
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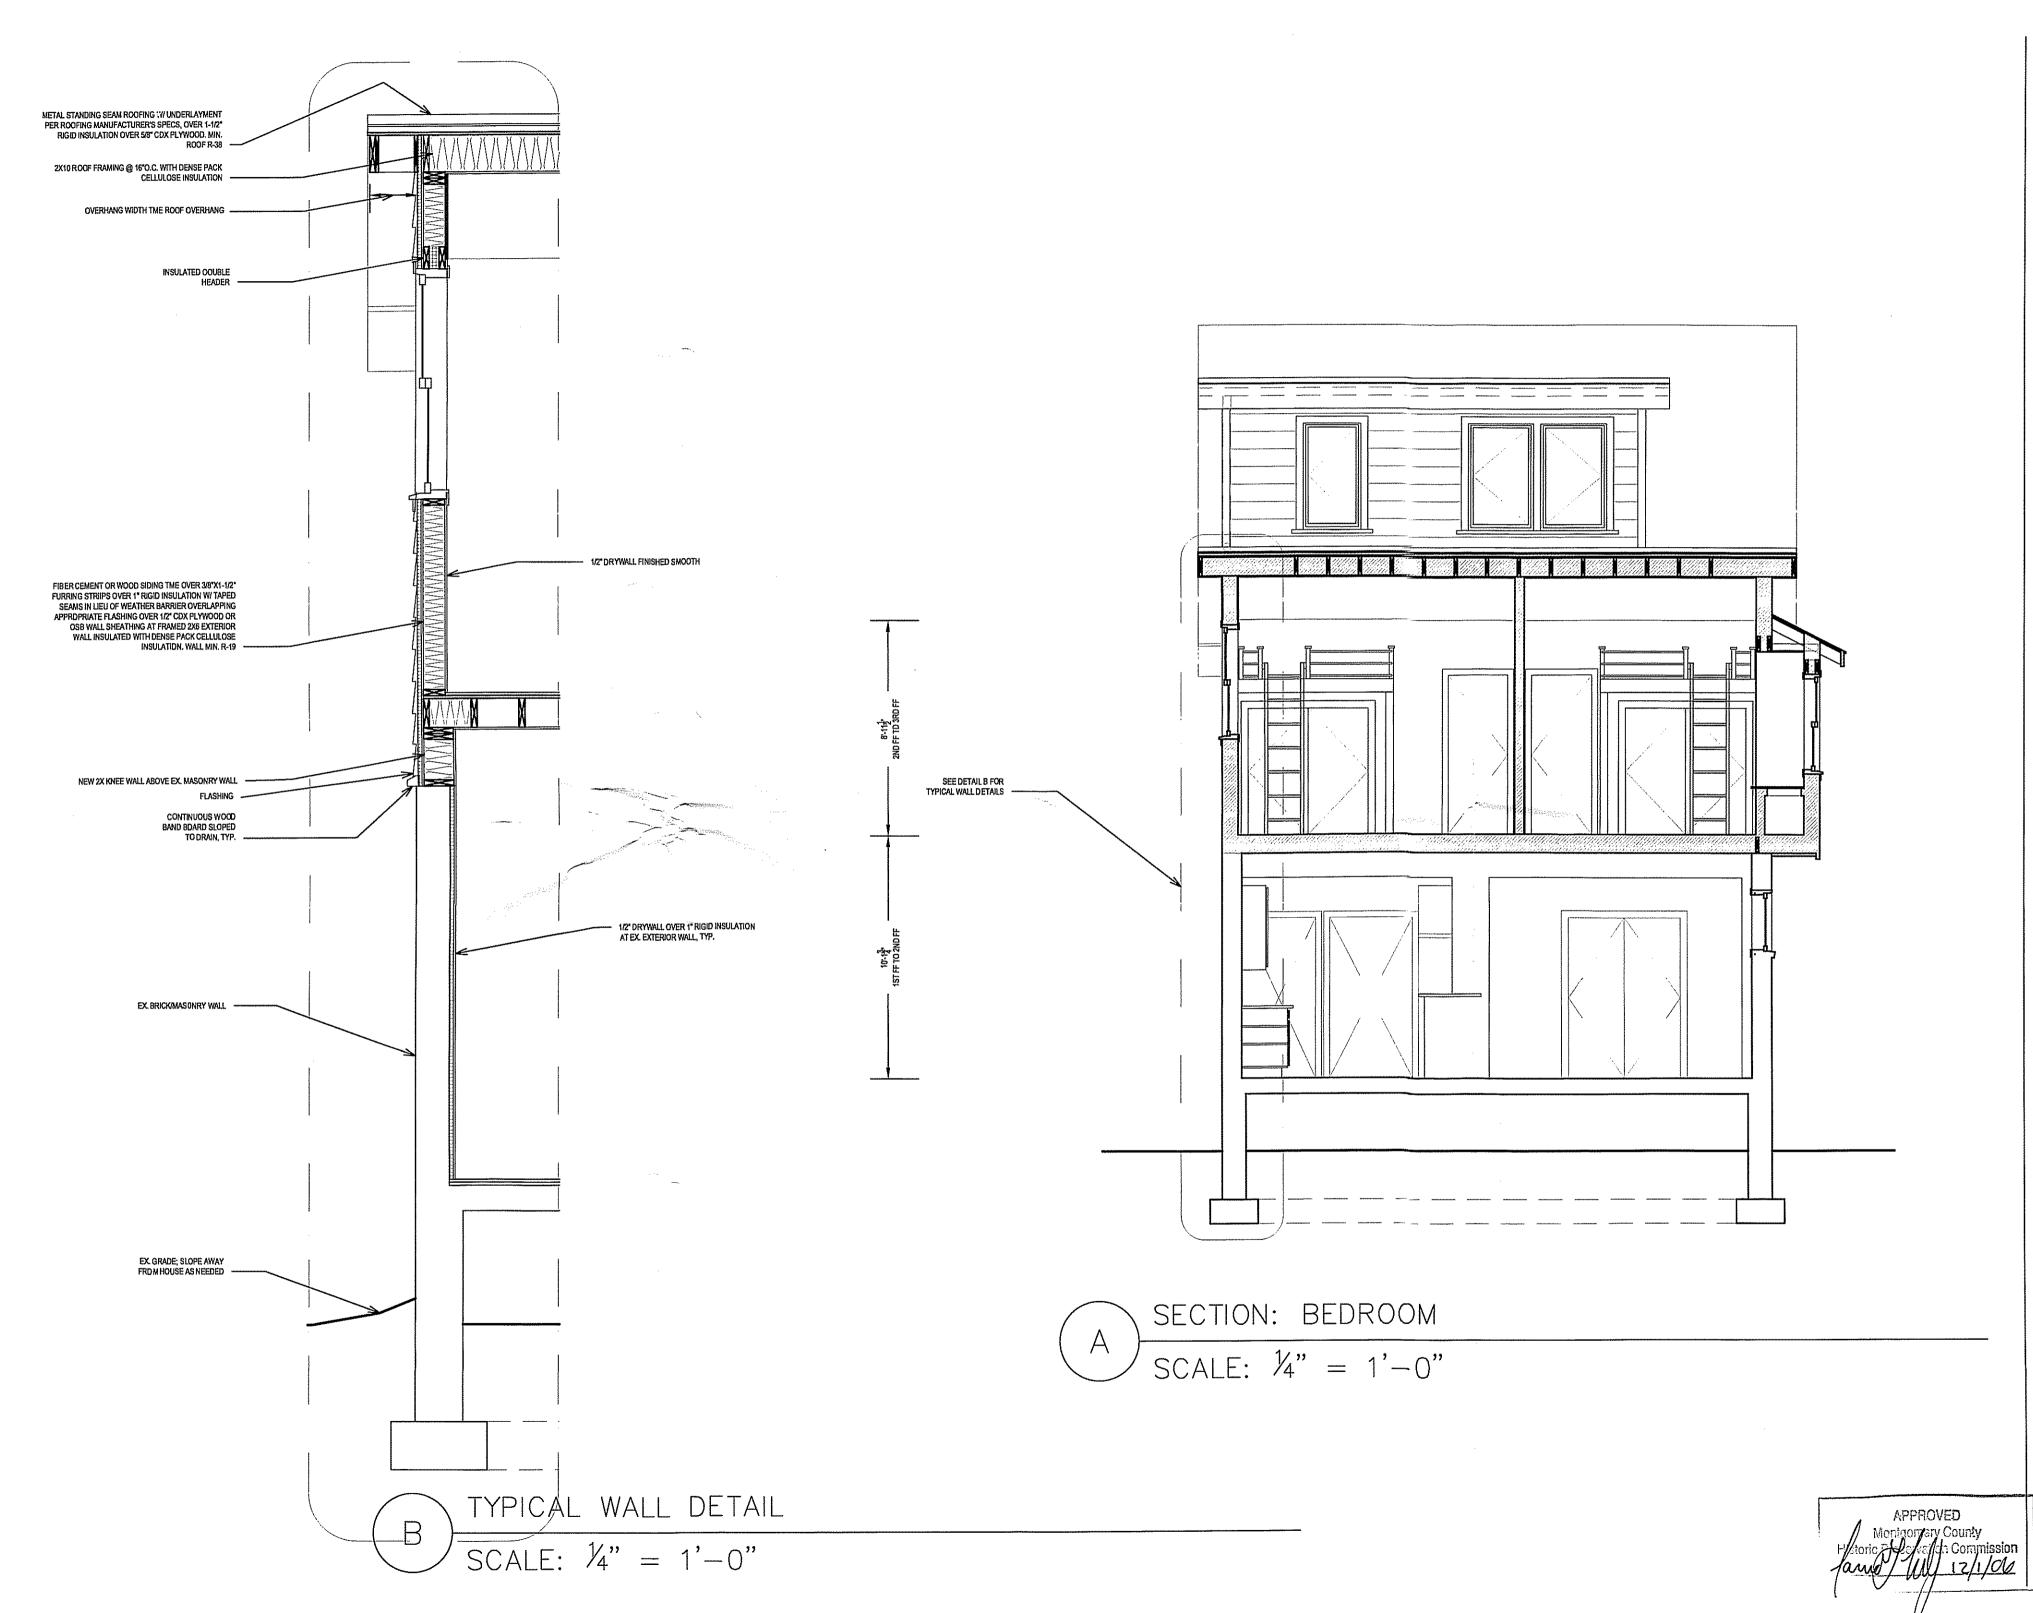
SECTION: MUD ROOM - DINING ROOM

АВ

11/20/2006

 $\frac{1}{4}$ " = 1'-0"

A-13



ARCHITECTS

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202.367.5649

PROJECT NAME:

BORZEKOWSK RESIDENCE 7400 MAPLE AVE

TAKOMA PARK, MD 20912

OWNER:

DINA BORZEKOWSKI RON BORZEKOWSKI 74DO MAPLE AVE TAKOMA PARK, MD 20912 301.270.4198

ISSUES:

PERMIT	11/20/06
PERMIT - REVISED	
со	

SHEET TITLE:

SECTION: BEDROOM; TYP. WALL DETAIL

A

ATE: 11/20/2006

SCALE: 1'-0"

A14



HISTORIC PRESERVATION COMMISSION

Douglas M. Duncan County Executive

Julia O'Malley Chairperson

Date: October 26, 2006

MEMORANDUM

TO:

Robert Hubbard, Director

Department of Permitting Services

FROM:

Tania Tully, Senior Planner

Historic Preservation Section

Maryland-National Capital Park & Planning Commission

SUBJECT:

Historic Area Work Permit #435081, rear addition

The Montgomery County Historic Preservation Commission (HPC) has reviewed the attached application for a Historic Area Work Permit (HAWP). This application was **Approved with Conditions** at the October 25, 2006 meeting.

- 1. The applicants will work with the Takoma Park arborist to determine if a tree protection plan is needed for this project. If required, the plan will be implemented prior to any work beginning on the property.
- 2. All new window units and sashes with multiple lights must be wood simulated divided light, which contain muntins that are permanently bonded to the interior and exterior of the insulating glass simulating a divided light appearance.
- 3. All new windows must be wood or aluminum clad wood except for the north elevation gable-end replacement sashes, which may not be clad.
- 4. The applicants will work with, and obtain staff approval for minor design changes including redesigning windows so that they have the same proportions as those in the historic house.
- -5. The specifications for the windows will be included in the permit sets of drawings submitted to staff at the time of stamping.

The HPC staff has reviewed and stamped the attached construction drawings.

THE BUILDING PERMIT FOR THIS PROJECT SHALL BE ISSUED AND CONDITIONAL UPON ADHERENCE TO THE ABOVE APPROVED HISTORIC AREA WORK PERMIT (HAWP) CONDITIONS AND MAY REQUIRE APPROVAL BY DPS OR ANOTHER TOWN GOVERNMENT AGENCY BEFORE WORK CAN COMMENCE.

Applicant:

Ron & Dina Borzekowski

Address:

7400 Maple Ave, Takoma Park

This HAWP approval is subject to the general condition that the applicant will obtain all other applicable Montgomery County or local government agency permits. After the issuance of these permits the applicant must contact this Historic Preservation Office if any changes to the approved plan are made.

Applicants will obtain windows through Community Takliff. They will contact staff for approval and as each window is) is schooted.



Edit 6/21/99 '

HISTORIC PRESERVATION COMMISSION 301/563-3400

APPLICATION FOR HISTORIC AREA WORK PERMIT

				Contact Person: D	ina Borzekowski	
				Daytime Phone No.:	301-523-2386	
Tax Account No.:	Ø105	7090				
		d Dina Borzekowski		Daytime Phone No.:	301-523-2386	
			oma Park	MD		20912
Address: 7400 Ma	Street Number		City	Staet		Zip Code
Contractor: TBD				Phone No.:		·
Contractor Registratio	on No.:				•	
Agent for Owner:			· .	Daytime Phone No.:		
LOCATION OF BUI	LDING/PREM	ISE				
House Number: 740	00		Street:	Maple Ave		
	na Park		Nearest Cross Street:	Philadelphia Ave		
		Subdivision:				
		Parcel:				
Liber.	10110.	, aroa.				
PART ONE: TYPE	OF PERMIT A	CTION AND USE				
1A. CHECK ALL APP	LICABLE:		CHECK ALI	APPLICABLE:		
☑ Construct		. Alter/Renovate	☑ A/C	□ Slab ☑ Room	Addition 🖸 Porch	☑ Deck ☐ Shedi
☐ Move	✓ Install	✓ Wreck/Raze	☐ Solar	☐ Fireplace ☐ Wood	burning Stove	✓ Single Family
☐ Revision	☐ Repair	☐ Revocable	☐ Fence/	Wall (complete Section 4)	□ Other:	
1B. Construction cos	st estimate: \$					
		ly approved active permit, s				
PART TWO: COM	PLETE FOR N	EW CONSTRUCTION AN	ID EXTEND/ADDIT	IONS		
2A. Type of sewage	e disposal:	01 🗹 WSSC	02 🗆 Septic	03 🗌 Other:		
2B. Type of water s	supply:	01 🗹 WSSC	02 🗆 Well	03 🗌 Other:		
PART THREE: COI	MPLETE ONLY	FOR FENCE/RETAINING	GWALL			
3A. Height	feet	inches				
3B. Indicate wheth	er the fence or	retaining wall is to be cons	tructed on one of the	following locations:		
☐ On party lin	e/property line	☐ Entirely on l	and of owner	☐ Dn public right o	f way/easement	
I hereby certify that approved by all ager	I have the auth ncies listed and	ority to make the foregoing I hereby acknowledge and	application, that the daccept this to be a	application is correct, ar condition for the issuanc	nd that the construction to this permit.	will comply with plans
	2	2		_	10/4/06	Dodo.
	signature of ov	vner or euthorized egent				ole
Approved:	WITH	CONDITION Signature:	S For Chair	person, Historic Preserv	ation Commission	125/01
	43	5081	RM_ Date	10.4.0 Ce	Date Issued:	+ /
Application/Permit N	10 1 / 1	01 400	Date .	nou. 10 1 0 4	<u>்</u> நவக கைய்	

SEE REVERSE SIDE FOR INSTRUCTIONS

THE FOLLOWING ITEMS MUST BE COMPLETED AND THE REQUIRED DOCUMENTS MUST ACCOMPANY THIS APPLICATION.

a. Description of existing structure(s) and environmental setting, including their historical features and significance: Three-story wood framed craftsman cottage with single story brick extension located on heavily wooded lot. House is located in Takoma Park historic district. b. General description of project and its effect on the historic resource(s), the environmental setting, and, where applicable, the historic district Project involves replacing deck in rear of house with new screened porch and mudroom, the addition of two rooms above the current home addition, and the construction of a third-floor dormer. All work is being done at the rear of the house and will not impact any of the historic resources of the house nor the district. Planned construction is environmentally focused and new construction is specifically designed to integrate with environmental setting.

2. SITE PLAN

Site and environmental setting, drawn to scale. You may use your plat. Your site plan must include:

- a. the scale, north arrow, and date;
- b. dimensions of all existing and proposed structures; and
- c. site features such as walkways, driveways, fences, ponds, streams, trash dumpsters, mechanical equipment, and landscaping.

3. PLANS AND ELEVATIONS

You must submit 2 copies of plans and elevations in a format no larger than 11" x 17". Plans on 8 1/2" x 11" paper are preferred.

- a. Schematic construction plans, with marked dimensions, indicating location, size and general type of walls, window and door openings, and other fixed features of both the existing resource(s) and the proposed work.
- b. Elevations (facades), with marked dimensions, clearly indicating proposed work in relation to existing construction and, when appropriate, context. All materials and fixtures proposed for the exterior must be noted on the elevations drawings. An existing and a proposed elevation drawing of each facade affected by the proposed work is required.

4. MATERIALS SPECIFICATIONS

General description of materials and manufactured items proposed for incorporation in the work of the project. This information may be included on your design drawings.

5. PHOTOGRAPHS

- Clearly labeled photographic prints of each facade of existing resource, including details of the affected portions. All labels should be placed on the front of photographs.
- b. Clearly label photographic prints of the resource as viewed from the public right-of-way and of the adjoining properties. All labels should be placed on the front of photographs.

6. TREE SURVEY

If you are proposing construction adjacent to or within the dripline of any tree 6° or larger in diameter (at approximately 4 feet above the ground), you must file an accurate tree survey identifying the size, location, and species of each tree of at least that dimension.

7. ADDRESSES OF ADJACENT AND CONFRONTING PROPERTY OWNERS

For ALL projects, provide an accurate list of adjacent and confronting property owners (not tenants), including names, addresses, and zip codes. This list should include the owners of all lots or parcels which adjoin the parcel in question, as well as the owner(s) of lot(s) or parcel(s) which lie directly across the street/highway from the parcel in question. You can obtain this information from the Department of Assessments and Taxation, 51 Monroe Street, Rockville. (301/279-1355).

HISTORIC PRESERVATION COMMISSION STAFF REPORT

Address:

7400 Maple Ave, Takoma Park

Takoma Park Historic District

Meeting Date:

10/25/2006

Resource:

Contributing Resource

Report Date:

10/18/2006

Applicant:

Ron & Dina Borzekowski

Public Notice:

10/11/2006

Review:

HAWP

Tax Credit:

Partial

Case Number:

37/03-06EEE

Staff:

Tania Tully

PROPOSAL:

rear addition

RECOMMENDATION: Approve with Conditions

STAFF RECOMMENDATION:

Staff is recommending that the HPC approve this HAWP application with the following conditions:

- 1. The applicants will work with the Takoma Park arborist to determine if a tree protection plan is needed for this project. If required, the plan will be implemented prior to any work beginning on the property.
- 2. All new window units and sashes with multiple lights must be wood simulated divided light, which contain muntins that are permanently bonded to the interior and exterior of the insulating glass simulating a divided light appearance.
- 3. All new windows must be wood or aluminum clad wood except for the north elevation gable-end replacement sashes, which may not be clad.
- 4. The applicants will work with, and obtain staff approval for minor design changes including redesigning windows so that they have the same proportions as those in the historic house.
- 5. The specifications for the windows will be included in the permit sets of drawings submitted to staff at the time of stamping.

ARCHITECTURAL DESCRIPTION

SIGNIFICANCE:

Contributing Resource within the Takoma Park Historic District

STYLE:

Bungalow

DATE:

c1910-20

HISTORIC CONTEXT

The following are excerpts from Places from the Past: The Tradition of Gardez Bien in Montgomery County, Maryland.

"Takoma Park is historically significant as both an early railroad suburb and a streetcar community. It was the second railroad suburb of Washington, platted ten years after Linden. The opening of streetcar lines led to the development of new subdivisions, expanding the Takoma Park community in the early 20th century.

"Takoma Park was platted in 1883. Developer Benjamin Franklin Gilbert promoted the property for its natural environment and healthy setting. The site offered fresh water, trees, and a high elevation to escape the malaria-ridden District of Columbia. In 1883, Gilbert purchased a 90-acre farm and platted a subdivision with picturesque, winding streets named for native trees, including Sycamore, Chestnut, Hickory, and Oak. Equally reflective of Gilbert's promotion of the natural setting is the use of the Native American "Takoma", meaning "exalted" or "near heaven." Later he added the "Park" appellation to draw attention to its healthy environment."

PROPOSAL:

- Remove existing deck (Circle 20).
- Construct a screened porch and mudroom at deck location. These rooms will have a living roof.
- Add a second level to the existing non-contributing addition. (10-15)
- Add a rear dormer.
- Replace the four 1970s windows in the front dormer with wood 1/1 windows (Circle 8).
- Replace the rotted and unrepairable 3rd floor window in the north gable (Circle 14)
- Remove the vinyl siding.

APPLICABLE GUIDELINES:

When reviewing alterations and new construction within the Takoma Park Historic District several documents are to be utilized as guidelines to assist the Commission in developing their decision. These documents include the historic preservation review guidelines in the approved and adopted amendment for the Takoma Park Historic District (Guidelines), Montgomery County Code Chapter 24A (Chapter 24A), and the Secretary of the Interior's Standards for Rehabilitation (Standards). The pertinent information in these documents is outlined below.

Takoma Park Historic District Guidelines

There are two very general, broad planning and design concepts which apply to all categories. These are:

The design review emphasis will be restricted to changes that are at all visible from the public right-of-way, irrespective of landscaping or vegetation (it is expected that the majority of new additions will be reviewed for their impact on the overall district), and,

The importance of assuring that additions and other changes to existing structures act to reinforce and continue existing streetscape, landscape, and building patterns rather than to impair the character of the district.

Contributing Resources should receive a more lenient review than those structures that have been classified as Outstanding. This design review should emphasize the importance of the resource to the overall streetscape and its compatibility with existing patterns rather than focusing on a close scrutiny of architectural detailing. In general, however, changes to Contributing Resources should respect the predominant architectural style of the resource. As stated above, the design review emphasis will be restricted to changes that are *at all visible from the public right-of-way*, irrespective of landscaping or vegetation.

Some of the factors to be considered in reviewing HAWPs on Contributing Resources include:

- All exterior alterations, including those to architectural features and details, should be generally consistent with the predominant architectural style and period of the resource and should preserve the predominant architectural features of the resource; exact replication of existing details and features is, however, not required
- Major additions should, where feasible, be placed to the rear of existing structures so that they are
 less visible from the public right-of-way; additions and alterations to the first floor at the front of a
 structure are discouraged, but not automatically prohibited
- While additions should be compatible, they are not required to be replicative of earlier architectural styles
- Some non-original building materials may be acceptable on a case-by-case basis; artificial siding
 on areas visible to the public right-of-way is discouraged where such materials would replace or
 damage original building materials that are in good condition
- Alterations to features that are not visible from the public right-of-way should be allowed a sa matter of course
- All changes and additions should respect existing environmental settings, landscaping, and patterns of open space.

Montgomery County Code; Chapter 24A

- A HAWP permit should be issued if the Commission finds that:
 - 1. The proposal will not substantially alter the exterior features of a historic site or historic resource within a historic district.
 - 2. The proposal is compatible in character and nature with the historical archaeological, architectural or cultural features of the historic site or the historic district in which a historic resource is located and would not be detrimental thereto of to the achievement of the purposes of this chapter.

STAFF DISCUSSION

This proposal meets all applicable *Standards* and *Guidelines*. The addition, while adding space on three levels is still quite small and adds minimally to the lot coverage. The new dormer is appropriate in size, scale, and sits below the ridgeline of the historic house and the 2nd level addition sits on an existing non-historic brick addition. The proposed design has clean lines and utilizes "green" features such as tree columns on the screened porch and the living roof, which will be accessible via a spiral stair at the rear. The horizontal siding and 6/1 windows draw from the design of the house while the "green" elements make the transition to the back yard. The addition will be minimally visible from the public-right-of way and will not negatively affect the streetscape of the historic district.

Other proposed changes, including removing the vinyl siding and replacing the 1970s windows, will improve the character of the house and are tax credit eligible expenses. Staff examined the 3rd floor window proposed for replacement, agrees that the sash is beyond repair, and recommends approving its replacement. On the north-side elevation at the rear of the house, there is another proposed window change. A narrow second level window is proposed to be replaced by a wider window. This window is minimally visible from the public right-of-way, but is not a major character-defining feature of the house. Because of its location and because of the leniency afforded Contributing Resources in the Takoma Park Historic District, staff is recommending approval of this change. However, the proportions of this window are inconsistent with the historic house. Either the window should be resized to match the other two windows on the north elevation or it should be changed to a pair of compatible casement windows.

Because of the location, massing and scale, the proposed addition is compatible with the historic house; however, staff is recommending a few minor design changes that should help enhance compatibility with the historic house. Currently the addition contains a mix of contemporary and traditional window designs. Because the intent of the addition is to use features from the historic house, the Staff suggests that the dimensions and proportions of the windows be evaluated for proportionality. For example, the bay window on the south elevation is too squat for a 6/1 light pattern. A pair of windows with the same proportions of those in the historic house would be more compatible. Although the addition will not have much visibility from the public right-of-way, these minor changes will increase the compatibility of the addition.

Staff is recommending approval with conditions.


STAFF RECOMMENDATION:

Staff recommends that the Commission approve the HAWP application with the conditions specified on Circle 1 as being consistent with Chapter 24A-8(b)(1) & (2);

and with the Secretary of the Interior's Standards for Rehabilitation:


and with the general condition that the applicant shall present the 3 permit sets of drawings, if applicable, to Historic Preservation Commission (HPC) staff for review and stamping prior to submission for the Montgomery County Department of Permitting Services (DPS) building permits;

and with the general condition that the applicant shall notify the Historic Preservation Staff if they propose to make any alterations to the approved plans.

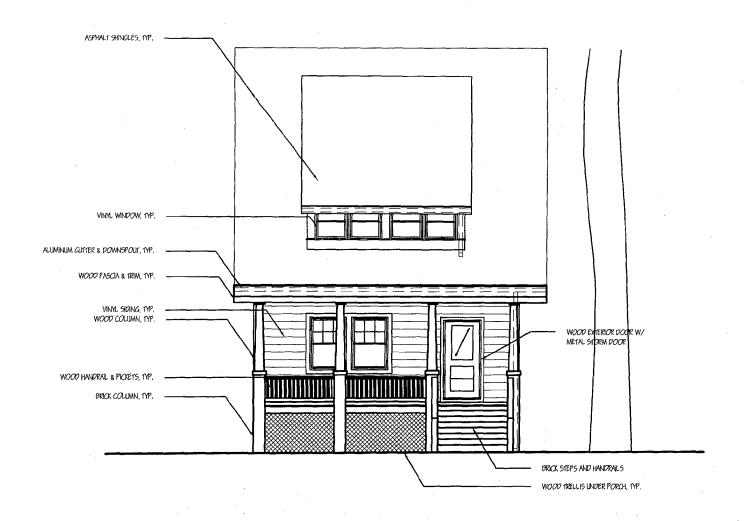


BORZEKOWSKI R 7400 MAPLE AVE TAKOMA PARK, MD 20912 RON & DINA BORZEKOWSKI 301-270-4198	ESIDENCE	. E)	KISTING ELEVA	
HELICON WORKS 7108 HOLLY STREET TAKOMA PARK, MD 20912	A DAMPI TOAN	DRAWN BY: DATE:	ABT 04 OCT 2006	A-2
W. WILLIAM HUTCHINS, AIA 301-404-5578	A. BAMBI TRAN 202-352-4563	SCALE:	1/8" = 1'-0"	




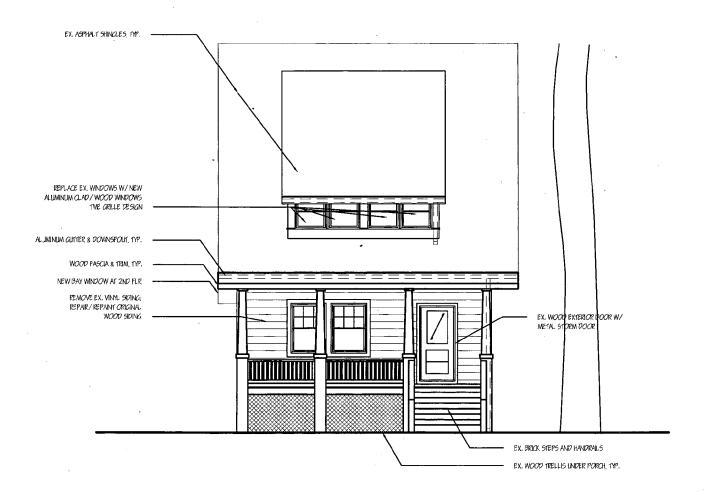


BORZEKOWSKI RESIDENCE 7400 MAPLE AVE TAKOMA PARK, MD 20912 RON & DINA BORZEKOWSKI 301-270-4198	PROPOSED FRONT ELEVATION
HELICON WORKS 7108 HOLLY STREET TAKOMA PARK, MD 20912 W. WILLIAM HUTCHINS, AIA 301-404-5578 A. BAMBI TRAN 202-352-4563	DRAWN BY: ABT DATE: 16 OCT 2006 SCALE: 1/8" = 1'-0" A-9



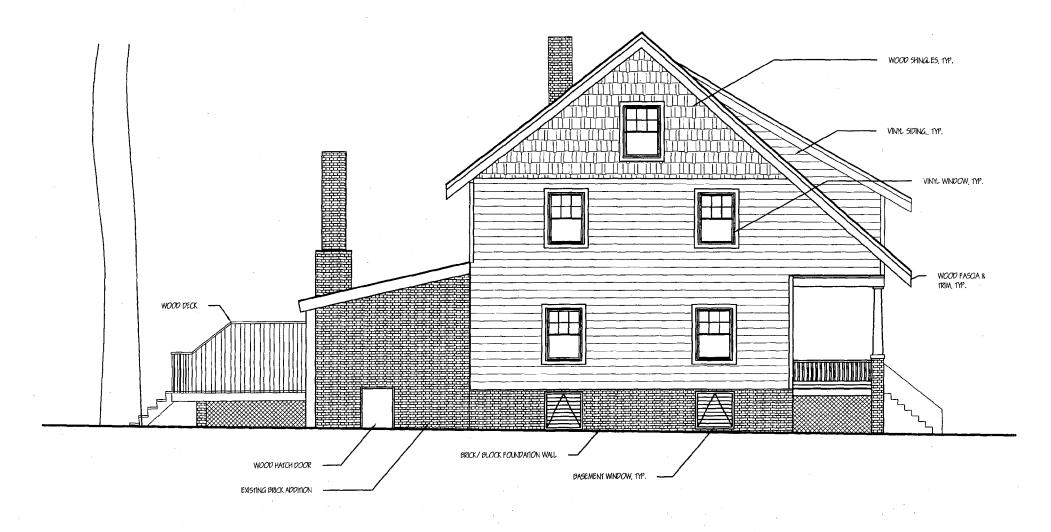

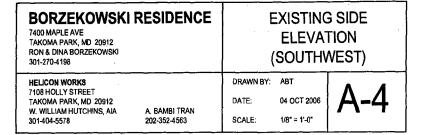




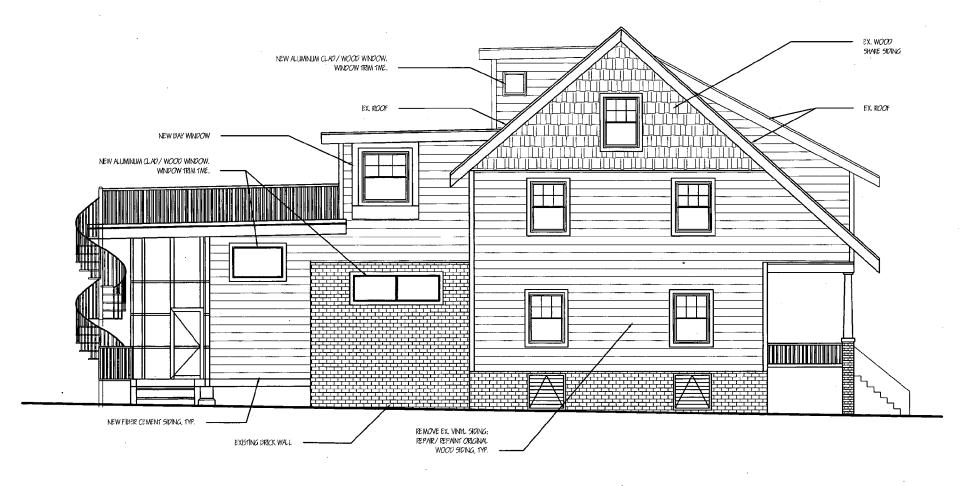




BORZEKOWSKI RESIDENCE 7400 MAPLE AVE TAKOMA PARK, MD 20912 RON & DINA BORZEKOWSKI 301-270-4198	PROPOSED SIDE ELEVATION (SOUTHWEST)	
HELICON WORKS 7108 HOLLY STREET TAKOMA PARK, MD 20912 W. WILLIAM HUTCHINS, AIA A. BAMBI TRAN 301-404-5578 202-352-4563	DRAWN BY: ABT DATE: 16 OCT 2006 SCALE: 1/8* = 1'-0*	



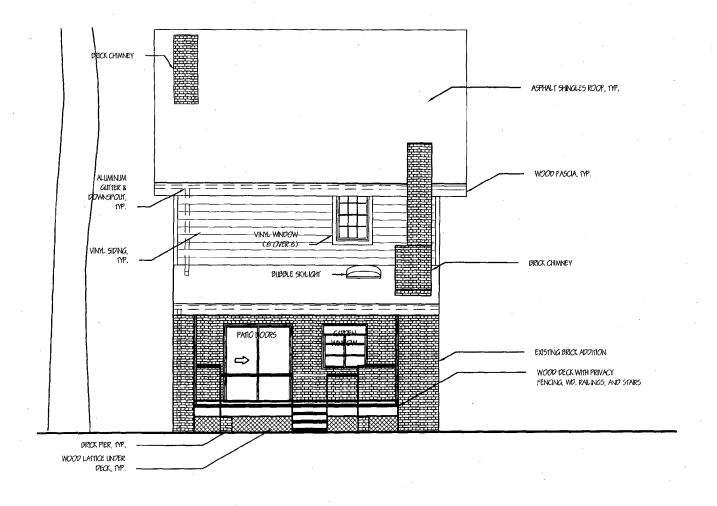


BORZEKOWSKI RESIDENCE EXISTING BACK 7400 MAPLE AVE TAKOMA PARK, MD 20912 RON & DINA BORZEKOWSKI **ELEVATION** 301-270-4198 DRAWN BY: ABT **HELICON WORKS** 7108 HOLLY STREET TAKOMA PARK, MD 20912 DATE: 04 OCT 2006 W. WILLIAM HUTCHINS, AIA A. BAMBI TRAN 202-352-4563 301-404-5578 SCALE: 1/8" = 1'-0"



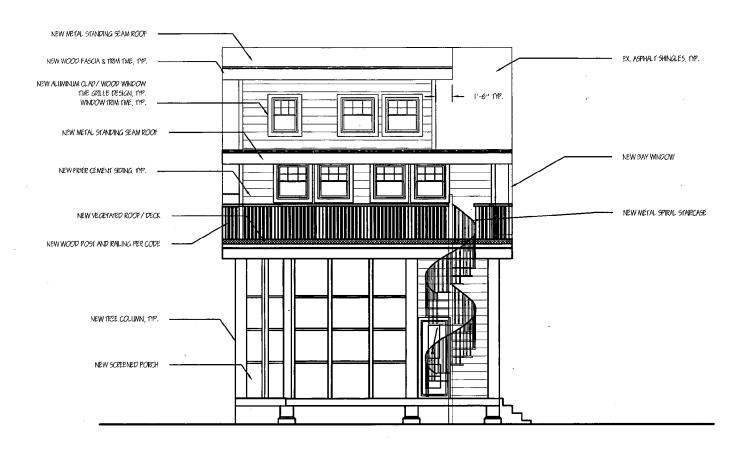

BORZEKOWSKI RESIDENCE 7400 MAPLE AVE TAKOMA PARK, MD 20912 RON & DINA BORZEKOWSKI 301-270-4198		PROPOSED BACK ELEVATION		
HELICON WORKS 7108 HOLLY STREET TAKOMA PARK, MO 20912 W. WILLIAM HUTCHINS, AIA 301-404-5578	A. BAMBI TRAN 202-352-4563	DRAWN 8Y: DATE: SCALE:	ABT 16 OCT 2006 1/8" = 1'-0"	A-10



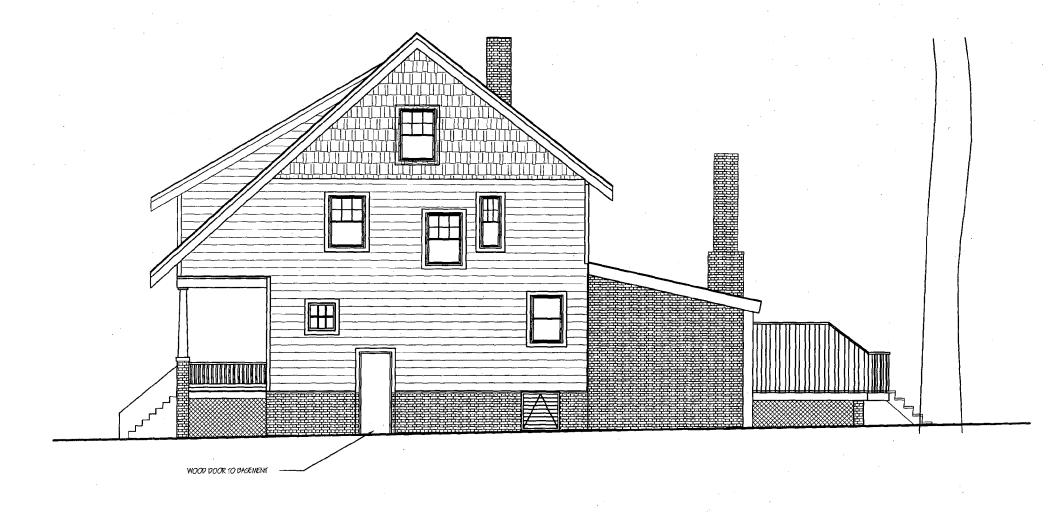

BORZEKOWSKI RESIDENCE

7400 MAPLE AVE TAKOMA PARK, MD 20912 RON & DINA BORZEKOWSKI 301-270-4198

HELICON WORKS 7108 HOLLY STREET TAKOMA PARK, MD 20912 W. WILLIAM HUTCHINS, AIA 301-404-5578

A. BAMBI TRAN 202-352-4563

EXISTING SIDE ELEVATION (NORTHEAST)


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SCALE:

DATE: 04 OCT 2006

1/8" = 1'-0"



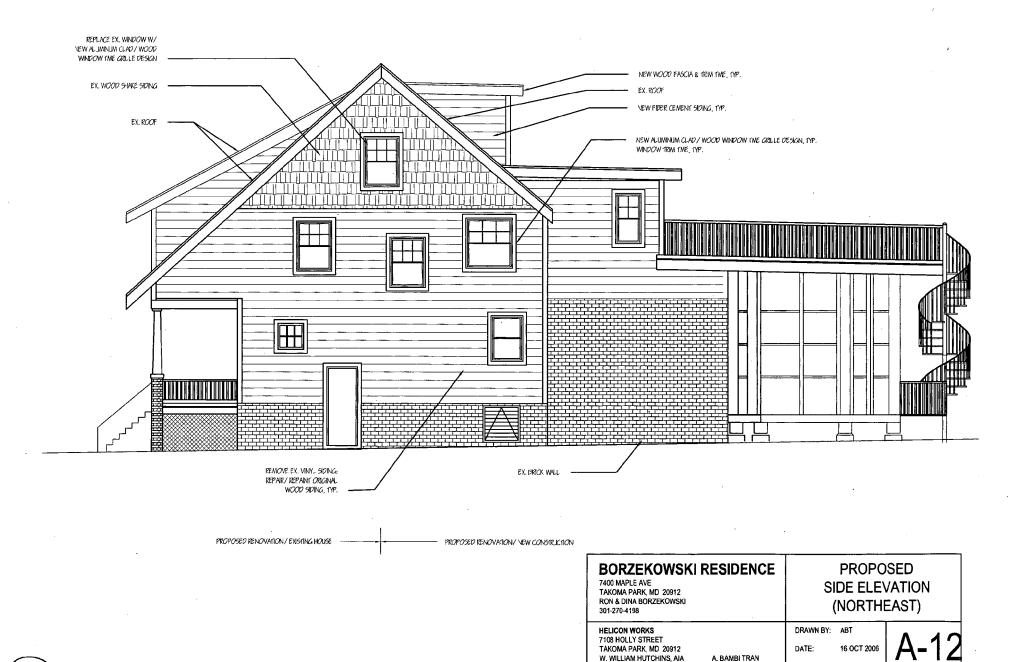

301-404-5578

202-352-4563

SCALE:

1/8" = 1'-0"